ANN ARBOR HISTORIC DISTRICT COMMISSION

Staff Report

ADDRESS: 1117 W Washington Street, Application Number HDC21-157

DISTRICT: Old West Side Historic District

REPORT DATE: May 13, 2021

Address:

REPORT PREPARED BY: Jill Thacher, Historic Preservation Coordinator

REVIEW COMMITTEE DATE: Monday, May 10, 2021

> OWNER **APPLICANT**

Name: Allison Darland & John Sherbeck Forward Design Build

> 6087 Jackson Ave S-100 1117 W Washington Ann Arbor, MI 48103

Ann Arbor, MI 48103

(248) 761-0101 Phone: (734) 761-8403

BACKGROUND: Physician Dr. Thomas Blair was the first occupant of this house in 1927, and Blairs lived there until at least 1940, per the Polk City Directory. It is characterized by a steeply pitched offset roof with swooping eaves, a round-topped front door, and casement windows in groups of two to four.

In 2015, HDC15-060 received a certificate of appropriateness from the HDC to construct a second-floor addition on the east side of the house, install a door with a fixed canopy, and move a metal chimney. In 2017, HDC17-064 was approved, to install a large patio in the sideyard and rework several paved paths.

LOCATION: The site is located on the southeast corner of West Washington and Buena Vista Streets.

APPLICATION: The applicant seeks HDC approval to enlarge a basement window opening and install a basement egress window and well with an acrylic cap.

APPLICABLE REGULATIONS:

From the Secretary of the Interior's Standards for Rehabilitation:

- (1) A property will be used as it was historically or be given a new use that requires minimal change to its distinctive materials, features, spaces, and spatial relationships.
- (2) The historic character of a property shall be retained and preserved. The removal of historic materials or alteration of features and spaces that characterize a property shall be avoided.
- (9) New additions, exterior alterations, or related new construction shall not destroy historic

- materials that characterize the property. The new work shall be differentiated from the old and shall be compatible with the massing, size, scale, and architectural features to protect the historic integrity of the property and its environment.
- (10) New additions and adjacent or related new construction shall be undertaken in such a manner that if removed in the future, the essential form and integrity of the historic property and its environment would be unimpaired.

From the Secretary of the Interior's Guidelines for Rehabilitating Historic Buildings (other SOI Guidelines may also apply):

Windows

<u>Recommended:</u> Designing and installing additional windows on rear or other non-character-defining elevations if required by the new use. New window openings may also be cut into exposed party walls. Such design should be compatible with the overall design of the building, but not duplicate the fenestration pattern and detailing of a character-defining elevation.

<u>Not Recommended:</u> Introducing a new design that is incompatible with the historic character of the building.

Changing the historic appearance of windows through the use of inappropriate designs, materials, finishes, or colors which noticeably change the sash, depth of reveal, and muntin configuration; the reflectivity and color of the glazing, or the appearance of the frame.

Installing new windows, including frames, sash, and muntin configuration that are incompatible with the building's historic appearance or obscure, damage, or destroy character-defining features.

District or Neighborhood Setting

<u>Not Recommended</u>: Introducing new construction into historic districts that is visually incompatible or that destroys historic relationships within the setting.

Health and Safety

<u>Recommended</u>: Identifying the historic building's character-defining spaces, features, and finishes so that code-required work will not result in their damage or loss.

Complying with health and safety codes, including seismic code requirements, in such a manner that character-defining spaces, features, and finishes are preserved.

<u>Not Recommended</u>: Altering, damaging, or destroying character-defining spaces, features, and finishes while making modifications to a building or site to comply with safety codes.

From the City of Ann Arbor Design Guidelines:

Windows

<u>Appropriate:</u> Retaining and maintaining windows in good condition. Normal maintenance will include cleaning, sash cord replacement, limited paint removal, re-caulking where necessary, and new paint to make windows fully operable.

<u>Not Appropriate</u>: Changing the number, location, and size or glazing pattern of windows by cutting new openings, blocking-in, or installing replacement sash which does not fit the historic opening.

Safety Codes

<u>Not Appropriate</u>: Altering, damaging or destroying character-defining spaces, features, and finishes.

STAFF FINDINGS:

- 1. This egress window is proposed in a basement rec room and would replace an existing glass block window. The current window opening is 30" wide by 22" tall. The new opening would be enlarged to 30" wide by 48" tall, with an Andersen fiberglass casement window. The fiberglass well would be 54" wide, 62" deep, and extend 51" from the house. An acrylic cover extends 10 1/4" above the well.
- 2. The existing glass block window has a shallow well and appears to have been enlarged at some point. This is an appropriate location for an egress window since it utilizes an existing opening and is pushed back from the street as far as is practical given the interior configuration of the basement.
- 3. Staff believes this work is appropriate and recommends approval.

POSSIBLE MOTIONS: (Note that the motion is only a suggestion. The Review Committee, consisting of staff and at least two Commissioners, will meet with the applicant on site and then make a recommendation at the meeting.)

I move that the Commission issue a certificate of appropriateness for the application at 1117 W Washington Street, a contributing property in the Old West Side Historic District, to enlarge a basement window opening and install a basement egress window and well with an acrylic cap, as proposed. The work is compatible in exterior design, arrangement, texture, material and relationship to the rest of the building and the surrounding area and meets the *Ann Arbor Historic District Design Guidelines*, especially those for windows and safety codes, and the *Secretary of the Interior's Standards for Rehabilitation* and *Guidelines for Rehabilitating Historic Buildings*, in particular standards 1, 2, 9 and 10 and the guidelines for windows, neighborhood setting, and health and safety.


ATTACHMENTS: application, photos, window information, drawings

1117 West Washington Street (November 2020, ©Google streetview)





415 and 419 N Ingalls Street (July 2019, ©Google streetview)

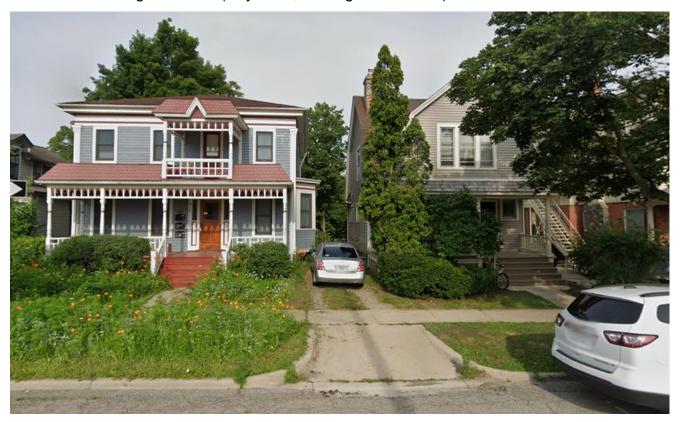

2020 Aerial Photo, City of Ann Arbor





HISTORIC DISTRICT COMMISSION

PLANNING AND DEVELOPMENT SERVICES

City Hall: 301 E. Huron St. Ann Arbor, MI 48104-6120 *Mailing:* P.O. Box 8647, Ann Arbor, MI 48107-8647

Phone: 734.794.6265 ext. 42608

Fax: 734.994.8460

jthacher@a2gov.org

Permit Number HDC# BLDG#_			
Permit Number	HDC#		
	BLDG#		
	DATE STAMP		

APPLICATION MUST BE FILLED OUT COMPLETELY

PROPERTY LOCATION/OWNER INFORMATION		
NAME OF PROPERTY OWNER	HISTORIC DISTRICT	
ALLISON DARLAND JOHN SHERBE		
PROPERTY ADDRESS		CITY
1117 W. WASHINGTON		ANN ARBOR
21PCODE DAYTIME PHONE NUMBER EMAIL ADDRESS john sherk 48103 (248) 761-001 daylanda@umic	beck@gmail	· Com
PROPERTY OWNER'S ADDRESS (IF DIFFERENT FROM ABOVE)	CITY	STATE, ZIP
PROPERTY OWNER'S SIGNATURE DocuSigned by: DocuSigned by:	يرخيب العليدالا	4/20/2021
SIGN HERE Allison Daviand In Tel M PRINT NAME Allison Darl	antbhn Sherbeck	DATE 4/20/2021
9603F4B67ADB4FC FF30FFBCB442495 APPLICANT INFORMATION		
NAME OF APPLICANT (IF DIFFERENT FROM ABOVE)		
FORWARD DESIGN BUILD		
6087 JACKSON AVE 5-100		ANN ARBOR
STATE ZIPCODE PHONE / CELL #	FAX No	
MI 48103 (734)761-	8403 1734	17/01-8419
EMAIL ADDRESS		11001
catherine (a planforward net		
APPLICANT'S SIGNOTURE éjudifferent from Property Owner	s consideration to the	
SIGN HERE PRINT NAME X Jef Forwar	d	DATE 4/20/2021
BUILDING USE - CHECK ALL THAT APPLY		
SA SINGLE FAMILY ☐ DUPLEX ☐ RENTAL ☐ MULTIPLE FAMILY	□ COMMERCIAL □] INSTITUTIONAL
PROPOSED WORK		
Describe in detail each proposed exterior alteration, improvement and/or repair (use addition	nal paper, if necessary).	
CONVERTING		
ADDING AN EXISTING WINDOW TO A	tn EGRES	SWINDOW
NEW WINDOW IS THE SAME HID	TH BUT W	ILL GO
DEEPER. ONLY ABOVE GRADE VI	SIBILITY L	IILL BE
AN ACRYLIC CAP	Y 24 - 7	
DESCRIBE CONDITIONS THAT JUSTIFY THE PROPOSED CHANGES:		10 11
BASEMENT TO BE FINISHED & W	ILL BE W	TILISED
AS A FAMILY ROOM		
For Further Assistance With Required Attachments, please visit <u>www.a2gov.org/hdc</u>		



HISTORIC DISTRICT COMMISSION APPLICATION

FEE CHART									
DESCRIPTION									
STAFF REVIEW FEES	FEE								
Application for Staff Approval	\$35.00								
Work started without approvals	Additional \$50.00								
HISTORIC DISTRICT COMMISSION FEES									
All other proposed work not listed below	\$100.00								
Work started without approvals	Additional \$250.00								
RESIDENTIAL – Single and 2-story Structure									
Addition: single story	\$300.00								
Addition: taller than single story	\$550.00								
New Structure - Accessory	\$100.00								
New Structure – Principal	\$850.00								
Replacement of single and 2-family window(s)	\$100 + \$25/window								
COMMERCIAL – includes multi-family (3 or more unit)									
structures									
Additions	\$700.00								
Replacement of multi-family and commercial window (s)	\$100 + \$50/window								
Replacement of commercial storefront	\$250.00								
DEMOLITION and RELOCATION									
Demolition of a contributing structure	\$1000.0								
Demolition of a non-contributing structure	\$250.00								
Relocation of a contributing structure	\$750.00								
Relocation of a non-contributing structure	\$250.00								


FOR COMMISSION REVIEWS:

- Application withdrawals made before public notice is published will qualify for a 50% refund of the application fee.
- Application withdrawals made after public notice is sent but before the public hearing will qualify for a 25% refund of the application fee.

INSTRUCTIONS FOR SUBMITTING APPLICATIONS All HDC applications must be signed by the property owner and the applicant, if different, with the exception of staff approvals, which may be signed by only the applicant. All completed HDC applications and their attachments may be submitted to Planning and Development Services by mail, in person (paper or digital), faxed, or via email to building@a2gov.org. We accept CASH, CHECK, and all major credit cards. Checks should be made payable to "City of Ann Arbor" HDC applications that are incomplete or not submitted with the required documentation or payment will not be processed or approved. **APPLICATION EXPIRATION** HDC applications expire three (3) years after the date of approval. OFFICE USE ONLY Date of Hearing: ☐ HDC COA ☐ HDC Denial Action ☐ Staff COA ☐ HDC NTP Staff Signature Comments Fee: Check: # **Payment Type** Cash Credit Card



BUENA VISTA AVE

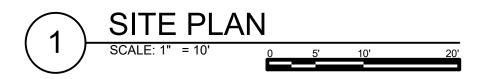



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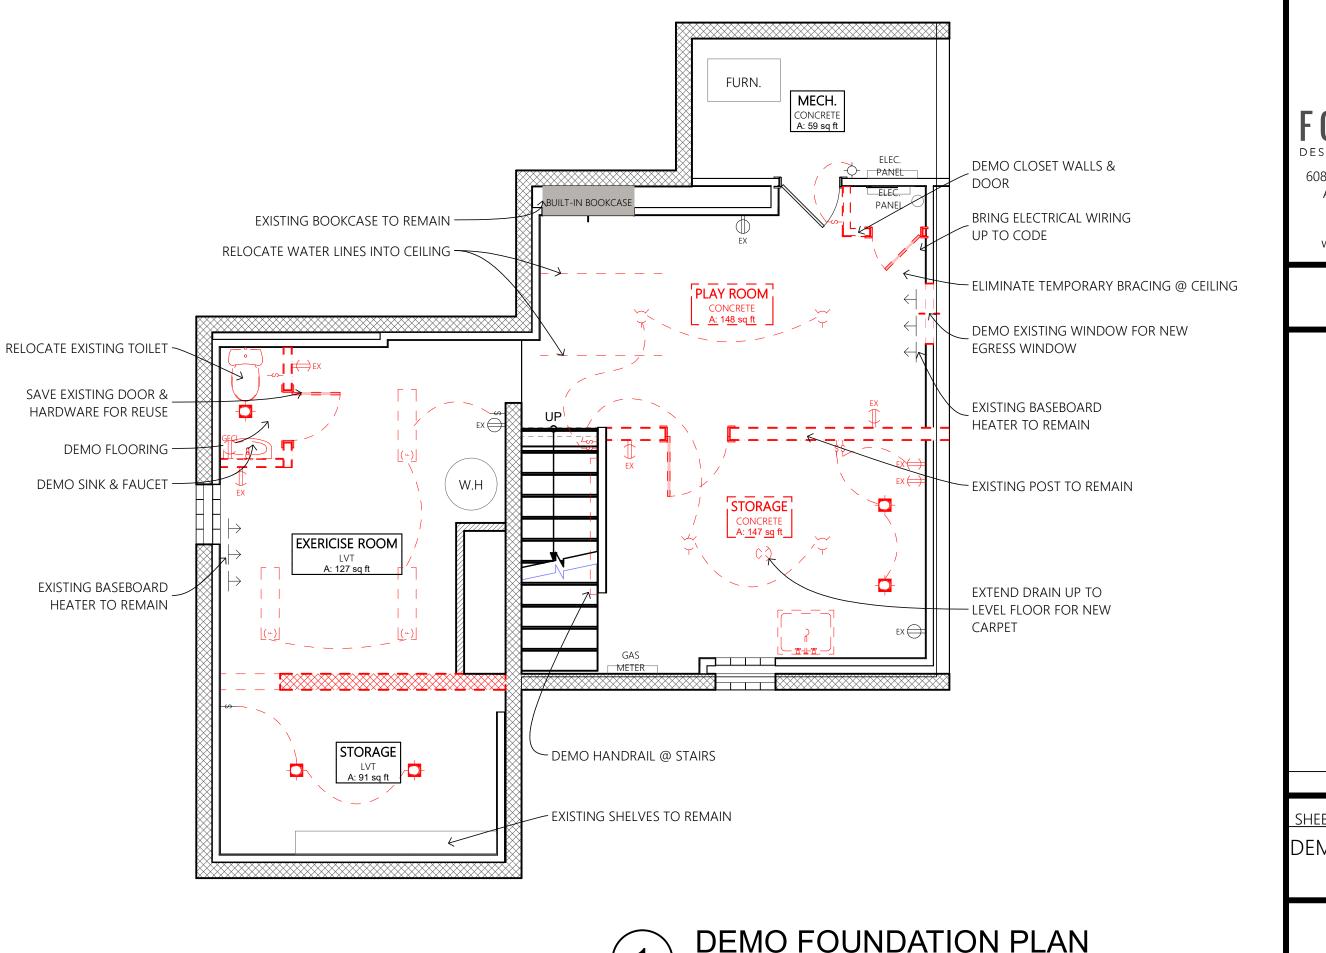
CONSTRUCTION DOCUMENTS

DARLAND.SHERBECK
Allison Darland & John Sherbeck
1117 W Washington St
Ann Arbor, MI 48103

4/21/2021

SHEET TITLE

SITE PLAN



CONSTRUCTION DOCUMENTS


Allison Darland & John Sherbeck 1117 W Washington St Ann Arbor, MI 48103 DARLAND.SHERBECK

4/21/2021

SHEET TITLE

DEMO FLOOR PLAN

DEMO FOUNDATION PLAN SCALE: 1/4" = 1'-0"

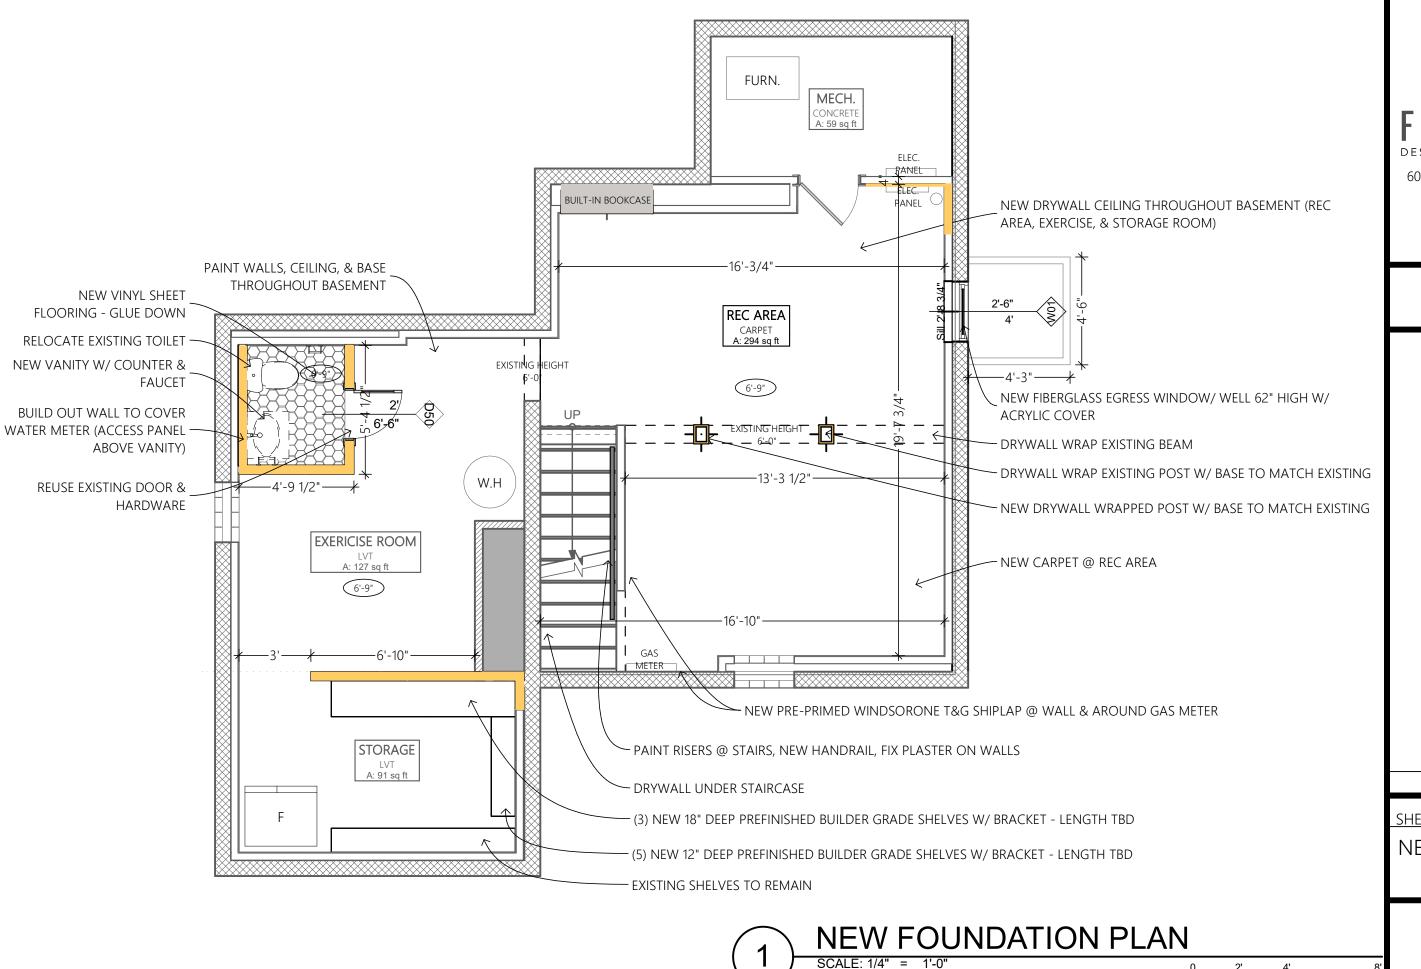




CONSTRUCTION DOCUMENTS

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SHEET TITLE

NEW FLOOR PLAN





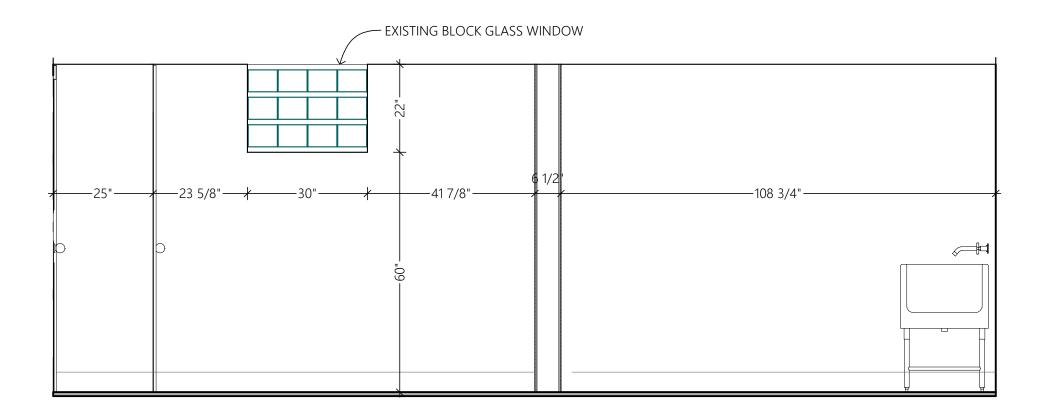

CONSTRUCTION DOCUMENTS


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SHEET TITLE

EXISTING INTERIOR ELEVATION

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FORWARD DESIGN BUILD REMODEL

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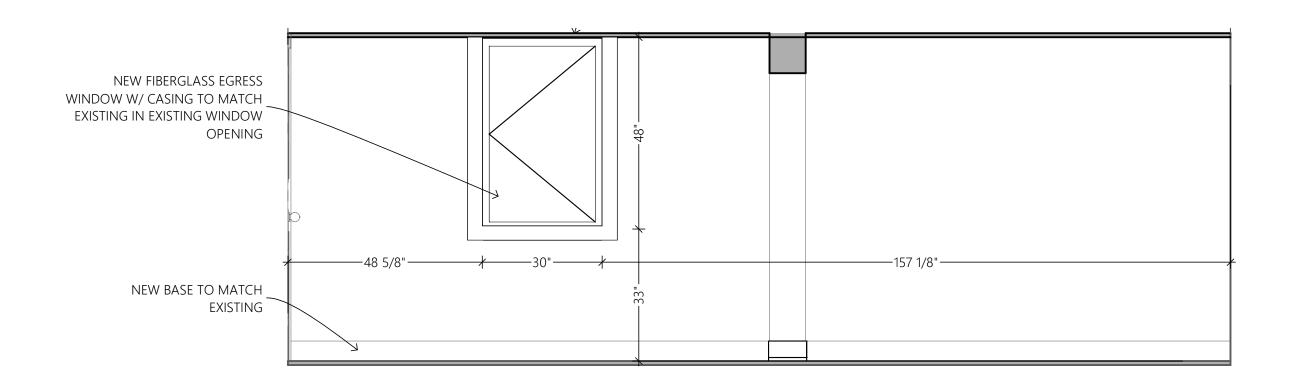
CONSTRUCTION DOCUMENTS

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SHEET TITLE

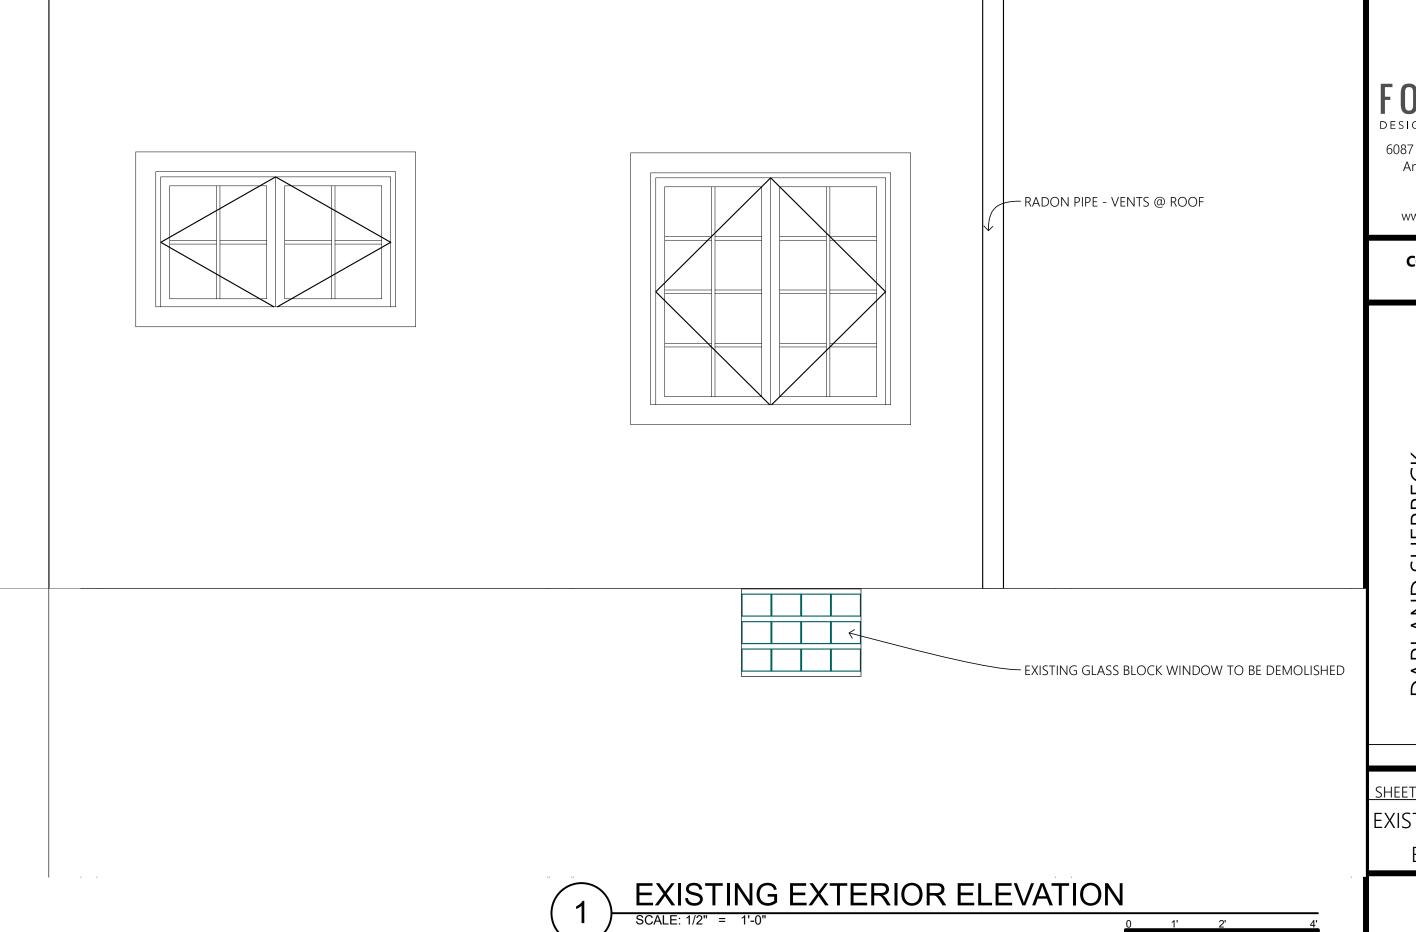EXISTING EXTERIOR ELEVATION



EGRESS WINDOW ELEVATION

SCALE: 1/2" = 1'-0"



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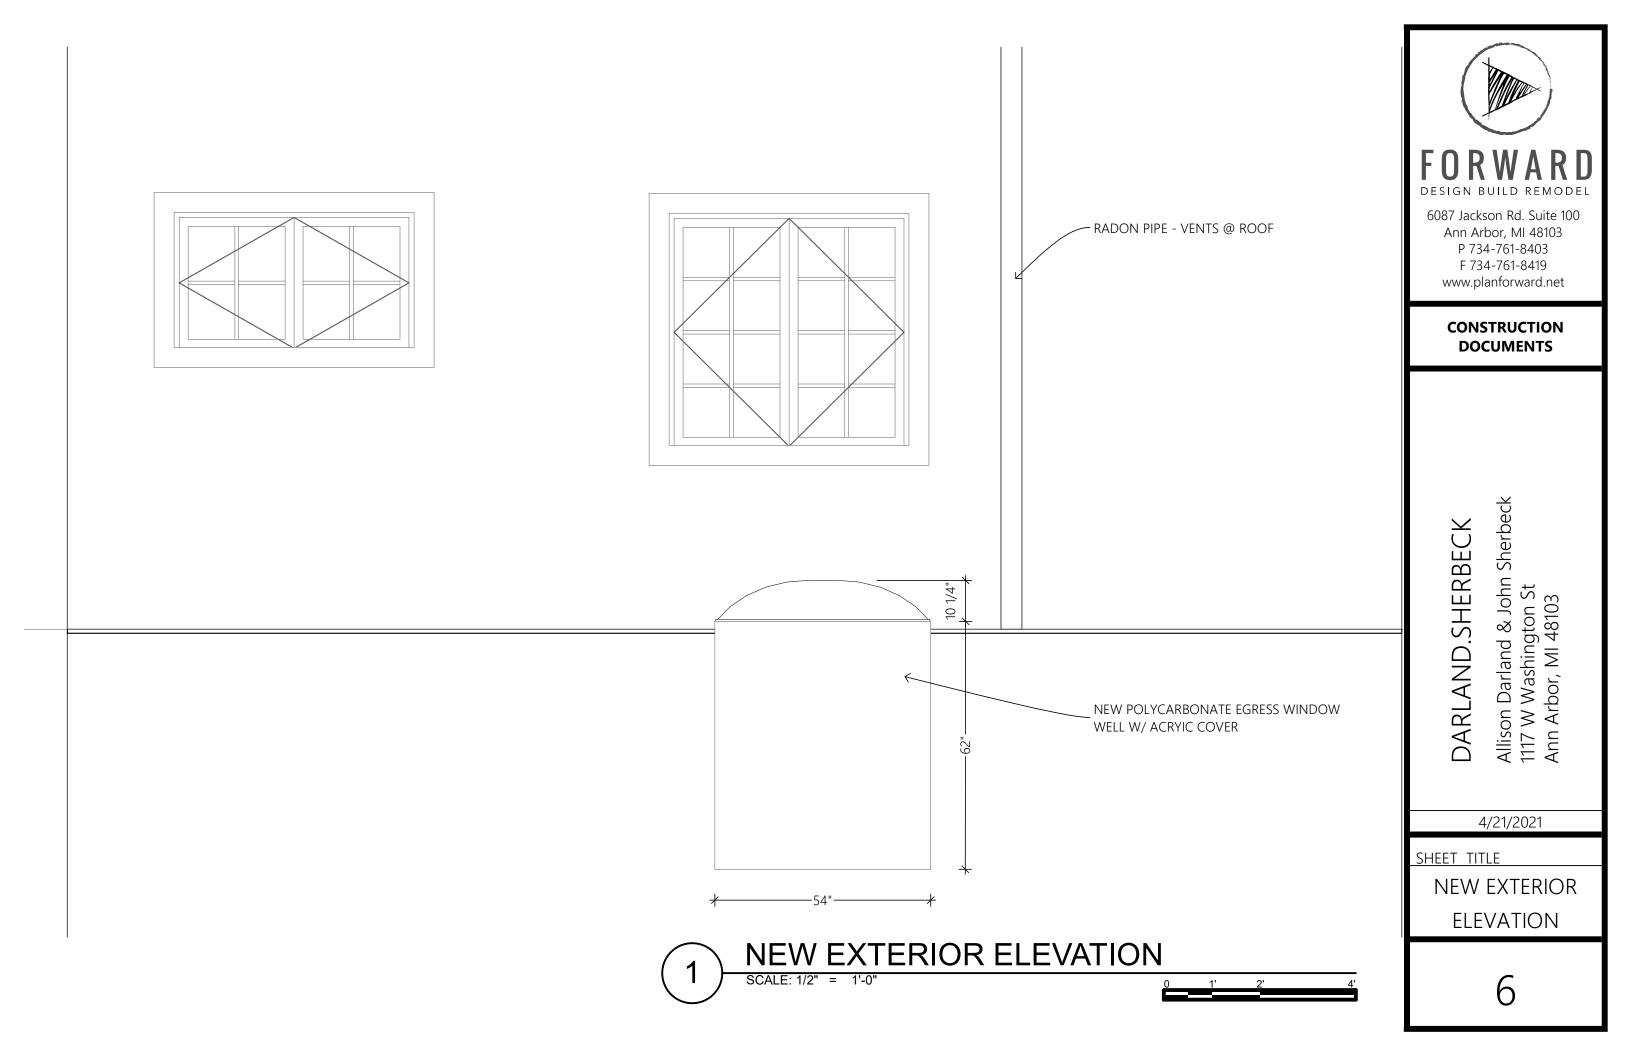
CONSTRUCTION DOCUMENTS

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SHEET TITLE

NEW INTERIOR ELEVATION









NEW WINDOW WELL IN EXISTING GLASS BLOCK WINDOW LOCATION



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CONSTRUCTION DOCUMENTS

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SHEET TITLE

NEW 3D VIEWS









CONSTRUCTION DOCUMENTS

DARLAND.SHERBECK

Allison Darland & John Sherbeck 1117 W Washington St Ann Arbor, MI 48103

4/21/2021

SHEET TITLE

EXISTING PHOTOS



	WINDOW SCHEDULE											
ID Room	Poom	View from Opening Side	Quantity	R.O. DIMENSIONS	UNIT DIMENSIONS		Head Height	Sill Height	Brand/ Madal	Window Type	Exterior Finish	Interior Finish
	Koom	View Ironi Opening Side	Quantity		WIDTH	HEIGHT	r lead r leight	Sili Height	Dianu, Model	vviildow rype	LAGIOI FIIISII	IIILEITOI FIIIISII
W01	REC AREA		1	2'-6"×4'	2'-5 1/2"	3'-11 1/2"	6'-8 1/4"	2'-8 3/4"	ANDERSEN	CASEMENT	WHITE	WHITE

WINDOWS

FEATURES CASEMENT & AWNING

Frame

A Frame constructed with Fibrex® composite material. This construction produces a rigid frame.

 Durable, low-maintenance finish won't fade, flake, blister or peel."

Concealed receiving brackets mounted on the hinge side of the frame keep the sash tightly secured within the window frame when closed.

• Four frame options available, see below.

Sash

 Fibrex material construction provides long-lasting performance. The sash, finished with a durable capping, provides maximum protection and a matte, low-maintenance finish.

 The dual weatherstrip system combines both an exterior watershed design and a bulb weatherstrip seal between the sash and frame. The result is a long-lasting, energy-efficient barrier against wind, water and dust.

Glass

 A glazing bead and silicone provides superior weathertightness and durability.

G See below for details.

Hardware

Sash operator provides almost effortless opening and closing, regardless of unit size.



Long-lasting stainless steel hinge channels are used at the head and sill to provide easy operation.

Single-Action Casement Lock

Single-action lock easily releases all concealed locking points on casement sash. The lock and folding handle match the window's interior color.

Awning Sash Locks





Awning sash locks provide an added measure of security and weathertightness. Awning hardware style and color options are compatible with 100 Series casement windows to ensure a consistent appearance when used in combination designs.

Andersen.

Casement Window Details - New Construction

Scale $1^{1}/2^{n}$ (38) = $1'-0^{n}$ (305) - 1:8

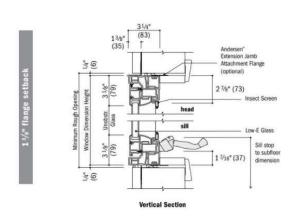

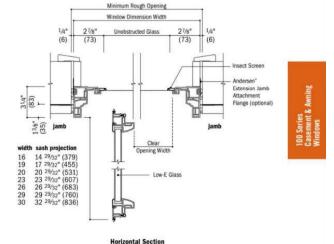

COMMON FEATURES

Frame

Four frame options include:

- 1 3/8" (35) flange setback for siding applications. An integral rigid vinyl flange helps seal the unit to the structure
- . 1" (25) flange setback with stucco key. An integral rigid vinyl flange helps seal the unit to the structure.
- . No-flange option for window replacement in an existing framed opening.

* Visit andersenwindows.com/warranty for details.

. Insert option for window replacement in an existing window frame.

Glass

Glazing bead and silicone provide superior weathertightness and durability.

High-Performance glass options include:

- Low-E SmartSun[™] glass
- Low-E SmartSun HeatLock[®] glass
- · Low-E glass
- Low-E HeatLock glass
 - Low-E Sun™ glass
 - · Clear dual-pane glass Tempered glass and other glass options are

available. Contact your Andersen supplier. A removable translucent film helps shield

the glass from damage during delivery and construction and simplifies finishing at the jobsite.

Patterned Glass

Patterned glass options are available. See page 12 for more details.

Performance Grade Upgrades

Optional performance grade upgrades are now available for select sizes allowing units to achieve PG50. Performance Grade (PG) Ratings are more comprehensive than Design Pressure (DP) Ratings for measuring product performance. Choosing the PG50 Upgrade does not change the appearance of the unit.

EXTERIOR COLORS

100 SERIES



INTERIOR COLORS

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SHEET TITLE WINDOW SPECS

** Products with dark bronze, black and Sandtone interiors have matching exteriors. Printing limitations prevent exact duplications of colors. See your Andersen supplier for actual color samples

Dimensions in parentheses are in millimeters.

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CONSTRUCTION

DOCUMENTS

& John Sherbeck

ion Darland & John W Washington St Arbor, MI 48103

1117 W N

Ann

Allison

4/21/2021


SHERBECK

DARLAND.



SCAPEWEL ® Window Well Standard Sizes and Dimensions

ScapeWEL is supplied for wall mount installation and can be modified in the field for buck mount installation.

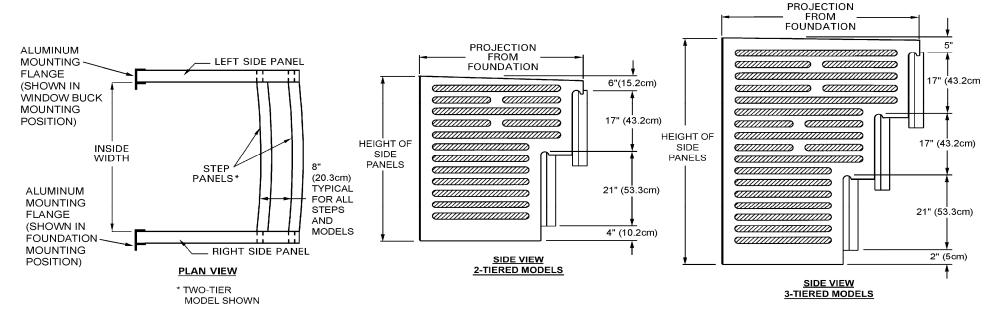

	Number	er Inside		Projection from		He	ight* of S	Side Pane	els	Extension	Maxium Width of Opening			
Model	of	Wie	dth	Found	dation	Standard		with Extension		Model	Wall I	Mount	Buck Mount	
	Tiers	inches	cm	inches	cm	inches	cm	inches	cm	Number	inches	cm	inches	cm
4048-42	2	42	106.7	41	104.1	48	121.9	Χ	Χ	Χ	42	106.7	38	96.5
4048-54	2	54	137.2	41	104.1	48	121.9	Χ	Х	X	54	137.2	50	127
4048-66	2	66	167.6	41	104.1	48	121.9	Χ	Χ	Χ	66	167.6	62	157.5
4862-42	3	42	106.7	49	124.5	62	157.5	81	205.7	3019-42	42	106.7	38	96.5
4862-54	3	54	137.2	49	124.5	62	157.5	81	205.7	3019-54	54	137.2	50	127
4862-66	3	66	167.6	49	124.5	62	157.5	81	205.7	3019-66	66	167.6	62	157.5

^{*}Side panels must extend 4" (10.2cm) above grade level and 3-1/2" (8.9cm) below the window sill.

Note: The distance from the outside of the foundation wall to the inside face of the first step is 30" (76.2cm) as shown in the detail above