THE CITY OF ANN ARBOR

NOTES:

THE PROPOSED IMPROVEMENTS ARE BASED ON THE 17TH EDITION OF AASHTO STANDARD SPECIFICATIONS FOR HIGHWAY BRIDGES.

EXCEPT WHERE OTHERWISE INDICATED ON THESE PLANS OR IN THE CONTRACT DOCUMENTS, ALL MATERIALS AND WORKMANSHIP SHALL BE PERFORMED ACCORDING TO THE CITY OF ANN ARBOR'S PUBLIC SERVICES DEPARTMENT STANDARD SPECIFICATIONS AND THE MICHIGAN DEPARTMENT OF TRANSPORTATION STANDARD SPECIFICATIONS FOR CONSTRUCTION 2012 EDITION. ALL WORK UNDER THIS CONTRACT THAT IS NOT INCLUDED IN THE CITY OR MDOT STANDARD SPECIFICATIONS SHALL BE PERFORMED IN ACCORDANCE WITH THE DETAILED SPECIFICATIONS INCLUDED IN THE CONTRACT DOCUMENTS.

IN CASE OF DISCREPANCY, THE CITY OF ANN ARBOR PUBLIC SERVICES DEPARTMENT STANDARD SPECIFICATIONS FOR CONSTRUCTION SHALL GOVERN OVER THE MICHIGAN DEPARTMENT OF TRANSPORTATION STANDARD SPECIFICATIONS FOR CONSTRUCTION.

THE DESIGN OF THE STRUCTURAL MEMBERS IS BASED ON MATERIAL OF THE FOLLOWING GRADES AND STRESSES:

AASHTO M270
GRADE 36
GRADE 50 AND 50W
STRUCTURAL STEEL TUBING (HSS):
ASTM A847
FV = 50,000 psi

ALL EXPOSED CONCRETE CORNERS SHOWN SQUARE ON THE PLANS SHALL BE BEVELED WITH 3" TRIANGULAR MOLDINGS EXCEPT AS OTHERWISE NOTED

NORTH BARTON PARK PEDESTRIAN STRUCTURE OVER HURON RIVER

SOUTH BARTON PARK PEDESTRIAN STRUCTURE OVER HURON RIVER

BANDEMER PARK

PEDESTRIAN AND

ARGO DAM-

VEHICLE STRUCTURES OVER HURON RIVER

PEDESTRIAN STRUCTURE


OVER ARGO CANOE LIVERY

UNLESS OTHERWISE SHOWN ON THE PLANS PROVIDE MINIMUM CONCRETE CLEAR COVER FOR REINFORCEMENT ACCORDING TO THE FOLLOWING:

CONCRETE CAST AGAINST EARTH: 3 IN.

ALL OTHER UNLESS SHOWN ON PLANS: 2 IN.

PARKS & RECREATION SERVICES 2019 PARK BRIDGE REPAIRS AND RENOVATIONS OCTOBER 2019 ITB NO. 4597

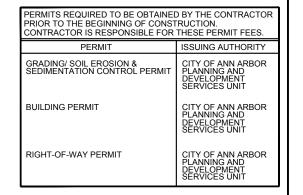

DECTER HURON ANN ARREN DECTER HURON ANN ARREN GOSS GLAZIER GOSS STADIUM

SHEET INDEX

SHEET NO.	DESCRIPTION
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2	NOTE AND QUANTITY SHEET
3-4	NORTH BARTON PEDESTRIAN STRUCTURE
5 - 7	SOUTH BARTON PEDESTRIAN STRUCTURE
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13-14	ARGO PARK PEDESTRIAN STRUCTURE
15-19	MITCHELL FIELD PEDESTRIAN STRUCTURES
20-22	GALLUP PARK VEHICLE STRUCTURE

MITCHELL FIELD
PEDESTRIAN STRUCTURE
OVER HURON RIVER

- GALLUP PARK VEHICLE STRUCTURE OVER HURON RIVER

3 WORKING DAYS I BEFORE YOU DIG CALL MISS DIG 800-482-7171 I

FOR PROTECTION OF UNDERGROUND UTILITIES AND IN CONFORMANCE WITH PUBLIC ACT 53, THE CONTRACTOR SHALL DIAL 1-800-482-7171 A MINIMUM OF THREE FULL WORKING DAYS, EXCLUDING SATURDAYS, SUNDAYS, AND HOLIDAYS PRIOR TO BEGINNING EACH EXCAVATION IN AREAS WHERE PUBLIC UTILITIES HAVE NOT BEEN PREVIOUSLY LOCATED. MEMBERS WILL THUS BE ROUTINELY NOTHERD. THIS DOES NOT RELIEVE THE CONTRACTOR OF THE RESPONSIBILITY OF NOTIFYING UTILITY OWNERS WHO MAY NOT BE A PART OF THE "MISS DIG" ALERT SYSTEM.

THE OMISSION OF ANY CURRENT STANDARD DETAIL DOES NOT RELIEVE THE CONTRACTOR FROM THIS REQUIREMENT. THE WORK SHALL BE PERFORMED IN COMPLETE CONFORMANCE WITH THE CURRENT PUBLIC SERVICES STANDARD SPECIFICATIONS AND DETAILS.

MARK T. LESSENS, P.E., MICHIGAN NO. 36092 DATE

SHEET 1 OF 22

GENERAL NOTES

UTILITIES

MISS DIG/UNDERGROUND UTILITY NOTIFICATION

For the protection of underground utilities and in conformance with MCL 460.171 et seg, the Contractor shall contact MISS DIG System, Inc. by phone at 811 or 800-482-7171 or via the web at either elocate missdig.org for single All signs on the plans or in the log that do not have a recommendation are to be address or rte.missdig.org, a minimum of 3 work days prior to excavating, excluding weekends and holidays.

OLD PLANS

OLD ROAD PLANS

The following old road plans were referred to in the design of this project.

91105 N Barton Pedestrian Continental Plans 91106 S Barton Pedestrian Continental Plans 94453 Bandemer Pedestrian Continental Plans 94454 Bandemer Vehicular Continental Plans Mitchell Field Bridge Construction Plans Gallup Park Bridge Existing Drawings 446931-2 Argo Pedestrian Continental Drawings

These plans may be obtained by contacting Hillary Hanzel at (734) 794-6230, ext. 42548.

EARTHWORK

EARTHWORK

Earthwork quantities are computed based upon limited survey information These quantities are for bidding purposes only and will be adjusted by the Engineer based upon actual field measurements.

Slope Restoration, Type B, shall be constructed on this project, where indicated.

EARTH DISTURBANCE LIMITS

Contractor shall remedy any disturbance to any construction staging area, material storage locations, work areas, and the like with topsoil, seed, and mulch as approved by the Engineer. The Contractor shall fill in any ruts or depressions caused by the work. Depending upon the level of disturbance caused by the work, the Contractor may elect to make the existing topsoil friable by scarifying and raking, and re-seed with approved seeding mixtures, and place mulch as needed to re-establish the disturbed turf areas. This work shall not be paid for separately, but shall be included in the item of work "General Conditions, Max. \$50,000."

SOIL EROSION MEASURES

Appropriate soil erosion and sedimentation control measures shall be in place prior to earth-disturbing activities. The Engineer will not determine the precise Soil Erosion and Sedimentation Control measures to employ on this project. It is the responsibility of the Contractor to prevent and remedy any erosion. siltation, or slope disturbances by providing appropriate control measures. This work shall not be paid for separately, but shall be included in the item of work "General Conditions, Max, \$50,000."

TREE AND BRUSH CLEARING

If the Contractor determines that tree and/or brush removal is required adjacent to any structure to provide access or complete the work of this project, they shall contact Hillary Hanzel at (734) 794-6230, ext. 42548, and provide the location(s) and extent of clearing requested. The Owner will review the locations and extent of the requested removal(s) and will complete the removal(s) to the extent determined feasible and acceptable to the Owner. Allow three (3) working days after request for the Owner to complete clearing at any one structure.

SIGNS

GENERAL

All signs shall be installed, removed and/or salvaged according to the current edition of "Michigan Manual on Uniform Traffic Control Devices" and the current edition of Michigan Department of Transportation (MDOT) "Standard Specifications for Construction."

retained.

EXISTING SIGN RELOCATION

Any permanent signs requiring relocation due to Contractor operations shall be salvaged and reset by the Contractor at locations designated by the Engineer. Signs and posts damaged during the removal and storage operations shall be replaced with new signs and posts. The cost of this work shall be borne by the Contractor.

PLAN SCALE

The final plans have scales, as indicated on the drawings. Where proposed on plan sheets, the signs and structures shall be fabricated in accordance to Typical Plans, Standards, and/or Details at locations described.

Sign layouts shall be performed according to the current English edition of "Standard Highway Signs" manual or as detailed in plans. Legend length shall be determined using the "SignCAD" software.

SHEETING

Handling and installation of all signs shall conform to the sheeting manufacturer's specifications and guidelines.

Splice sheeting used for Type I signs with a 3" overlap.

Signs that have wrinkled or twisted sheeting may be rejected.

SIGN INSTALLATION

When attaching signs to supports, tighten the nut, not the bolt head.

Nylon washers shall be placed between the steel washer and the sign face sheeting. The nylon washers are to be considered part of the attaching devices and hardware. Nylon washers shall have a 3/8-inch inner diameter, a 7/8-inch outer diameter and a 1/16-inch thickness.

NOTES APPLYING TO MDOT STANDARD PLANS

Where the following items are called for on plans, they are to be constructed according to the MDOT standard plan given below opposite each item unless otherwise indicated.

Title	Plan No.			
ROAD				
SOIL EROSION & SEDIMENTATION CONTROL MEASURES	R-96-E			
SEEDING AND TREE PLANTING	R-100-H			
BRIDGE				
MOLDING, BEVEL, LIGHT STANDARD ANCHOR BOLT ASSEMBLY AND NAME PLATE DETAILS	B-103-E			
WORK ZONE DEVICES				
GROUND DRIVEN SIGN SUPPORTS FOR TEMP SIGNS	WZD-100-A*			
TEMPORARY TRAFFIC CONTROL DEVICES	WZD-125-E*			
*Denotes Special Detail				

ITB 4597 Category 0000 – General Conditions	Unit	Quantity
General Conditions, Max, \$50,000	LSUM	1
Certified Payroll Compliance and Reporting	LSUM	1
Fence, Protective	Ft	1300
Barricade, Type III, High Intensity, Lighted, Furn	Ea	28
Barricade, Type III, High Intensity, Lighted, Oper	Ea	28
Plastic Drum, High Intensity, Furn	Ea	20
Plastic Drum, High Intensity, Oper	Ea	20
Sign, Type B, Temp, Prismatic, Furn	Sft	299
Sign, Type B, Temp, Prismatic, Oper	Sft	299
Sign, Type B, Temp, Prismatic, Special, Furn	Sft	52
Sign, Type B, Temp, Prismatic, Special, Oper	Sft	52
ITB 4597 Category 0001 – North Barton Pedestrian Structure	Unit	Quantity
Reinforcement, Steel, Epoxy Coated	Lb	20
Water Repellent Treatment, Penetrating	Syd	1
Hand Chipping, Other Than Deck	Cft	1
Patch, Forming	Sft	3
Patching Conc, C-L	Cyd	0.1
Embedded Galvanic Anode	Ea	6
ITB 4597 Category 0002 – South Barton Pedestrian Structure	Unit	Quantity
_Structures, Rem Portions, Special (South Barton)	LSUM	1
Excavation, Fdn	Cyd	15
Erosion Control, Silt Fence	Ft	100
Conc, Grade S2	Cyd	3
_Timber Decking, 3 inch by 12 inch	Sft	260
_Structure, Timber, Boardwalk (South Barton)	LSUM	1
Topsoil Surface, 4 inch	Syd	40
Hydroseeding	Syd	40
ITB 4597 Category 0003 – Bandemer Park Pedestrian Structure	Unit	Quantity
_Structures, Rem Portions, Special (South Barton)	LSUM	1
Structural Steel, Rolled Shape, Erect	Lb	4710
Structural Steel, Rolled Shape, Furn and Fab	Lb	4710
_Composite Railing, 2 inch by 8 inch	Ft	292
_Timber Decking, 3 inch by 12 inch	Sft	1040
		

ITB 4597 Category 0003 – Bandemer Park Pedestrian Structure (Con't)	Unit	Quantity
_Steel Structure, Coating, Partial, Special (Bandemer Ped)	LSUM	1
_Steel Structure, Cleaning, Partial, Special (Bandemer Ped)	LSUM	1
ITB 4597 Category 0004 – Bandemer Park Vehicle Structure		
_Structures, Rem Portions, Special (Bandemer Veh)	LSUM	1
Structural Steel, Mixed, Erect	Lb	20260
Structural Steel, Mixed, Furn and Fab	Lb	20260
_Timber Decking, 4 inch by 12 inch	Sft	1550
_Composite Railing, 2 inch by 8 inch	Ft	300
_Steel Structure, Cleaning, Partial, Special (Bandemer Veh)	LSUM	1
_Steel Structure, Coating, Partial, Special (Bandemer Veh)	LSUM	1
_Guardrail, Type B, Modified	Ft	292
ITB 4597 Category 0005 – Argo Park Pedestrian Structure		
_Timber Decking, Salv and Reinstall, 3 inch by 12 inch	Sft	360
_Steel Structure, Cleaning, Partial, Special (Argo)	LSUM	1
_Steel Structure, Coating, Partial, Special (Argo)	LSUM	1
ITB 4597 Category 0006 – Mitchell Field Pedestrian Structure		
_Structures, Rem Portions, Special (Mitchell Truss)	LSUM	1
_Structures, Rem Portions, Special (Mitchell Boardwalk)	LSUM	1
Structural Steel, Rolled Shape, Erect	Lb	2800
Structural Steel, Rolled Shape, Furn and Fab	Lb	2800
_Composite Railing, 2 inch by 4 inch	Ft	1276
_Composite Railing, 2 inch by 8 inch	Ft	393
_Timber Decking, 2 inch by 10 inch	Sft	1070
_Structure, Timber, Boardwalk (Mitchell Boardwalk)	LSUM	1
_Steel Structure, Cleaning, Partial, Special (Mitchell Truss)	LSUM	1
_Steel Structure, Coating, Partial, Special (Mitchell Truss)	LSUM	1
ITB 4597 Category 0007 – Gallup Park Vehicle Structure		·
_Structures, Rem Portions, Special (Gallup)	LSUM	1
Structural Steel, Plate, Erect	Lb	3550
Structural Steel, Plate, Furn and Fab	Lb	3550


ORIGINAL ISSUE 10/01/19 DESCRIPTION DR.BY DATE

THE CITY OF ANN ARBOR - PARKS AND RECREATION SERVICES

2019 PARK BRIDGE REPAIRS AND RENOVATIONS **NOTE AND QUANTITY SHEET**

SCALE	
NONE	
DRAWING NO).

SHEET NO. _2_ OF _22_

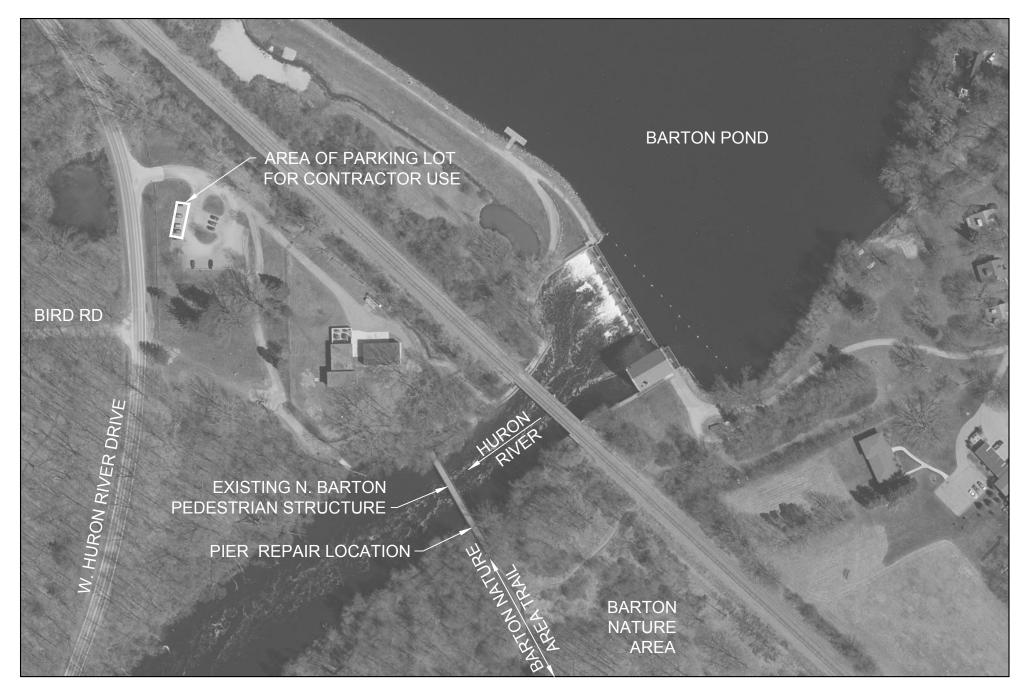


PLAN OF N. BARTON PEDESTRIAN STRUCTURE



NOTES:


- THE STRUCTURE IS LOCATED IN BARTON PARK, ON THE EAST SIDE OF W. HURON RIVER DRIVE, JUST SOUTH OF THE INTERSECTION WITH BIRD ROAD. THE BARTON POND DAM IS LOCATED APPROXIMATELY 400 FEET UPSTREAM OF THE STRUCTURE.
- 2. THE EXISTING STRUCTURE IS A TWO-SPAN, WEATHERING STEEL TRUSS STRUCTURE, A TOTAL OF 190'-10" IN LENGTH, WITH A CONCRETE WALL PIER AND CONCRETE ABUTMENTS. THE BRIDGE HAS A CLEAR WIDTH OF 10'-0". THE EXISTING STRUCTURE WAS DESIGNED FOR 85 PSF UNIFORM LIVE LOADING OR, 20 PSF PEDESTRIAN UNIFORM LIVE LOAD PLUS ONE 6,000 LB VEHICLE LOAD.
- 3. THE WORK CONSISTS OF: CHIPPING AND PATCHING THE WEST END OF THE PIER, LOCATED ON THE SOUTHEAST SIDE OF THE RIVER AND PLACING WASHERS AND NUTS ON THE ANCHOR BOLTS ON THE TRUSS BEARINGS AT THE SAME PIER.
- 4. ACCESS TO THE AREA SHALL BE FROM THE PARKING LOT LOCATED APPROXIMATELY 700 FEET NORTHWEST OF THE STRUCTURE. THE CONTRACTOR MAY USE AN AREA OF THE GRAVEL SURFACE PARKING LOT FOR EQUIPMENT, MATERIAL STORAGE, AND EMPLOYEE PARKING. THE AREA USED SHALL NOT EXCEED 40 FEET IN LENGTH BY APPROXIMATELY 20 FEET IN WIDTH, AND SHALL BE LOCATED ALONG THE WEST EDGE OF THE PARKING LOT. THE USE OF ANY TRAILS OR GRASS AREAS FOR THESE PURPOSES IS STRICTLY FORBIDDEN. THE CONTRACTOR SHALL NOT BLOCK THE USE OF ANY TRAIL WITHIN THE PARK, ADJACENT TO THIS STRUCTURE. THE TRAIL AND STRUCTURE SHALL REMAIN OPEN AT ALL TIMES. PEDESTRIAN USAGE OF THE TRAIL AND STRUCTURE SHALL BE MAINTAINED AT ALL TIMES.

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					2019 PARK BRIDGE REPAIRS	SCALE	
					AND RENOVATIONS	NONE	
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					NORTH BARTON PEDESTRIAN STRUCTURE		
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CONCRETE PATCHING DETAIL

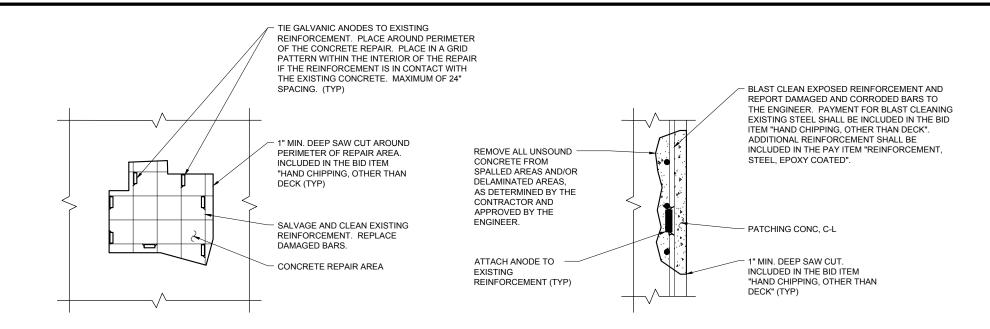NOTE: LIMITS OF REPAIR TO BE DETERMINED BY THE CONTRACTOR AND APPROVED BY THE ENGINEER. TO BE USED FOR SUBSTRUCTURE REPAIRS AS DIRECTED BY THE ENGINEER. SEE NOTE 1 FOR MORE DETAILS.




SECTION AT SUBSTRUCTURE PATCHING

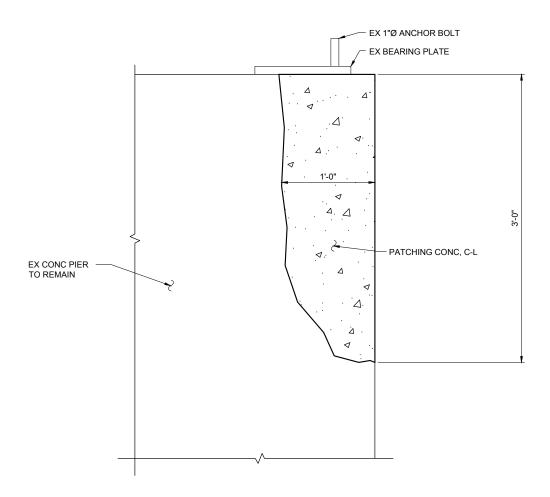NO MORE THAN ONE BAR SHALL BE REPLACED AT A TIME, AS DIRECTED BY THE ENGINEER.

NOTES:

- 1. CONTRACTOR TO PREPARE AREAS FOR CONCRETE REPAIRS, FOR REVIEW BY THE ENGINEER, PRIOR TO FORMING AND PLACING PATCHING MATERIAL. PREPARATION OF REPAIR AREAS PRIOR TO FORMING AND PATCHING SHALL INCLUDE, BUT NOT BE LIMITED TO: COMPLETING THE SPECIFIED SAW CUTTING; REMOVING UNSOUND CONCRETE; BLAST CLEANING EXPOSED REINFORCING STEEL; FLUSHING AREA WITH CLEAN WATER UNDER PRESSURE AND BLOWING OUT AREA WITH OIL-FREE COMPRESSED AIR; PLACING GALVANIC ANODES; AND, REPLACING DETERIORATED REINFORCING BARS, AS REQUIRED.
- 2. THE CONTRACTOR SHALL PLACE TEMPORARY SUPPORT(S) AT THE TRUSS BEARING DURING CHIPPING OPERATIONS IF THE BEARING PLATE IS UNDERMINED OR UNSUPPORTED FOR OVER 50% OF ITS INTENDED BEARING AREA. THIS WORK WILL NOT BE PAID FOR SEPARATELY, BUT SHALL BE INCLUDED IN THE ITEM OF WORK "HAND CHIPPING, OTHER THAN DECK."
- 3. ALL TRUSS BEARINGS SHALL BE RESTORED TO THE ORIGINAL CONDITION OF DOUBLE NUTS AND DOUBLE WASHERS AND IS NOT PAID FOR SEPARATELY BUT SHALL BE INCLUDED IN OTHER ITEMS OF WORK.
- 4. PENETRATING WATER REPELLENT TREATMENT SHALL BE APPLIED TO THE ENTIRE EXPOSED SURFACE OF THE PATCHED AREA AND 6" BEYOND.
- 5. FORMS FOR LARGE PATCHES SHALL BE INSTALLED IN 2'-0" TO 4'-0" HIGH SECTIONS WITH THE TOP OF FORM NO MARE THAN 4'-0" ABOVE THE LEVEL OF CONCRETE AS THE POUR PROGRESSES.

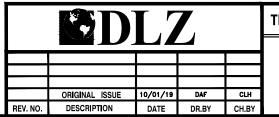

THE CITY OF ANN ARBOR - PARKS AND RECREATION SERVICES

2019 PARK BRIDGE REPAIRS AND RENOVATIONS


NORTH BARTON PEDESTRIAN STRUCTURE SUBSTRUCTURE DETAILS

NONE

DRAWING NO.

SHEET NO. ______ OF _______

CONCRETE PIER ELEVATION

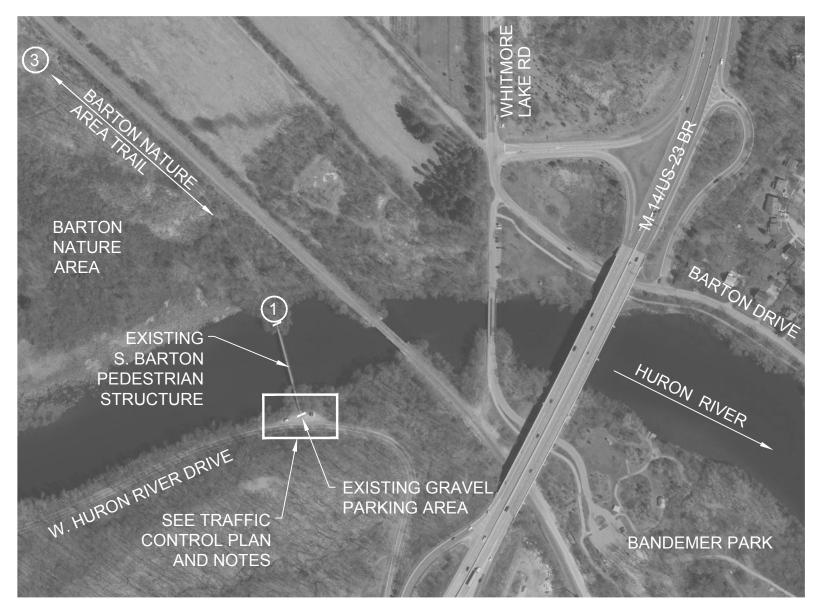

PLAN OF S. BARTON PEDESTRIAN STRUCTURE



LEGEND TRAFFIC CONTROL NOTES:



PLACE TWO (2) TYPE III BARRICADES ON THE BARTON AREA NATURE TRAIL AND IN THE GRAVEL PARKING AREA, WITH ONE (1) "BRIDGE CLOSED" (R11-2) SIGN ON SEPARATE SUPPORTS, AT EACH END OF STRUCTURE. PLACE PROTECTIVE FENCING AROUND PROJECT SITE IN ACCORDANCE WITH THE DETAILED SPECIFICATION FOR MAINTENANCE OF TRAFFIC AND CONSTRUCTION SEQUENCING.




PLACE DRUMS ALONG THE NORTH EDGE OF W. HURON RIVER DRIVE AT 15' SPACING IN ADDITION TO PROTECTIVE FENCING.



PLACE "TRAIL CLOSED - $\frac{1}{2}$ MILE AHEAD" (SF-2) SIGN AT SOUTH END OF THE NORTH BARTON TRAIL STRUCTURE OVER THE HURON RIVER WHEN THE SOUTH BARTON TRAIL STRUCTURE OVER THE HURON RIVER IS CLOSED.

ESTIMATED QUANTITIES OF TRAFFIC CONTROL DEVICES FOR S. BARTON PARK:

PAY ITEM	UNIT	QUANTITY
BARRICADE, TYPE III, HIGH INTENSITY, LIGHTED, FURN	EACH	4
BARRICADE, TYPE III, HIGH INTENSITY, LIGHTED, OPER	EACH	4
SIGN, TYPE B, TEMP, PRISMATIC, FURN	SFT	20
SIGN, TYPE B, TEMP, PRISMATIC, OPER	SFT	20
SIGN, TYPE B, TEMP, PRISMATIC, SPECIAL, FURN	SFT	14
SIGN, TYPE B, TEMP, PRISMATIC, SPECIAL, OPER	SFT	14
PLASTIC DRUM, HIGH INTENSITY, FURN	EA	20
PLASTIC DRUM, HIGH INTENSITY, OPER	EA	20
FENCE, PROTECTIVE	FT	300

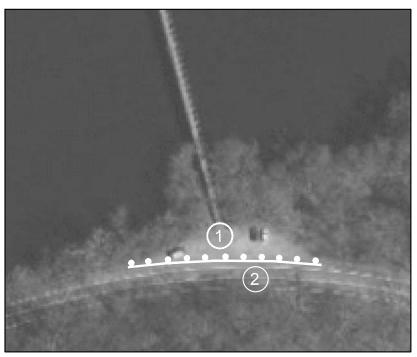

TRAFFIC CONTROL PLAN



SEE TRAFFIC CONTROL QUANTITIES AND DETAILED SPECIFICATION FOR MAINTENANCE OF TRAFFIC AND CONSTRUCTION SEQUENCING FOR ADDITIONAL INFORMATION.

NOTES:

- 1. THE STRUCTURE IS LOCATED IN BARTON PARK, APPROXIMATELY 40 FEET NORTH OF W. HURON RIVER DRIVE AND 0.20 MILES WEST OF M-14/US-23.
- 2. THE EXISTING STRUCTURE IS A THREE-SPAN WEATHERING STEEL TRUSS STRUCTURE, 304'-10 $\frac{1}{2}$ " IN LENGTH, WITH CONCRETE PIERS AND ABUTMENTS. THE SOUTH SPAN IS 84'-2 $\frac{1}{2}$ " IN LENGTH. THE CLEAR WIDTH IS 8'-0".
- 3. THE WORK CONSISTS OF: REMOVAL OF THE EXISTING TIMBER, GROUND-SUPPORTED STRUCTURE AT THE SOUTH END OF THE SOUTH TRUSS SPAN; REMOVAL OF TIMBER DECKING; EXCAVATION AND GRADING BELOW THE SOUTH TRUSS SPAN; PLACEMENT OF A TIMBER, GROUND-SUPPORTED STRUCTURE AT THE SOUTH END OF THE SOUTH TRUSS SPAN; PLACEMENT OF TIMBER DECK; PLACEMENT OF SLOPE RESTORATION; AND CLOSING STRUCTURE TO PEDESTRIAN USAGE AND THE GRAVEL PARKING LOT TO VEHICLE/PEDESTRIAN USAGE DURING CONSTRUCTION.
- 4. THE CONTRACTOR MAY USE THE ENTIRE GRAVEL SURFACE PARKING LOT IMMEDIATELY SOUTH OF THE SOUTH END OF THE STRUCTURE FOR EQUIPMENT, MATERIAL STORAGE, AND EMPLOYEE PARKING. THE CONTRACTOR SHALL PLACE DRUMS AND TEMPORARY CONSTRUCTION FENCING ALONG THE EDGE OF W. HURON RIVER DRIVE TO BLOCK ALL ACCESS TO THE PARKING LOT DURING CONSTRUCTION. THE USE OF ANY TRAILS OR GRASS AREAS FOR THESE PURPOSES IS STRICTLY FORBIDDEN. THE CONTRACTOR SHALL NOT BLOCK THE USE OF ANY TRAIL WITHIN THE PARK, EXCEPT FOR THE STRUCTURE PORTION.
- 5. THE CONTRACTOR SHALL FIELD VERIFY ALL EXISTING AND PROPOSED DIMENSIONS PRIOR TO FABRICATION AND INSTALLATION OF PROPOSED WORK.

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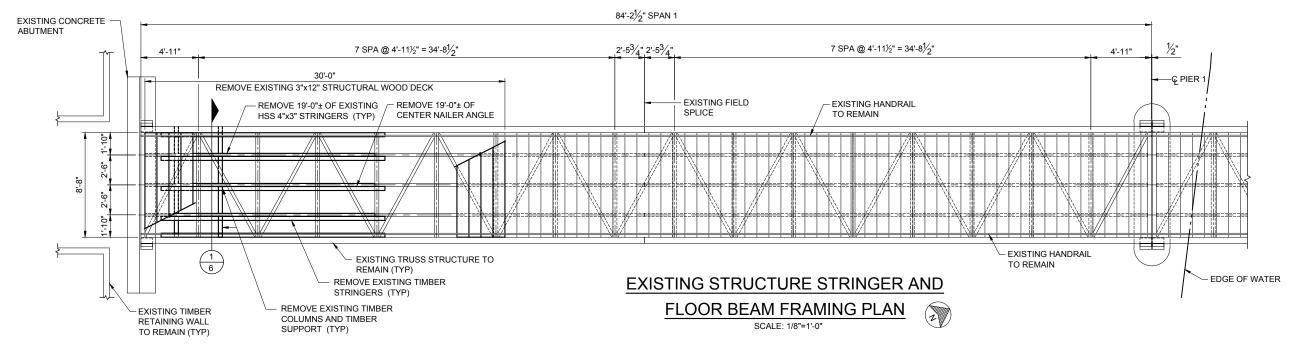
THE CITY OF ANN ARBOR - PARKS AND RECREATION SERVICES


2019 PARK BRIDGE REPAIRS AND RENOVATIONS

OUTH BARTON PEDESTRIAN STRUCTURE
GENERAL PLAN OF SITE


SCALE
NONE
DRAWING NO.

SHEET NO. <u>5</u> OF <u>22</u>



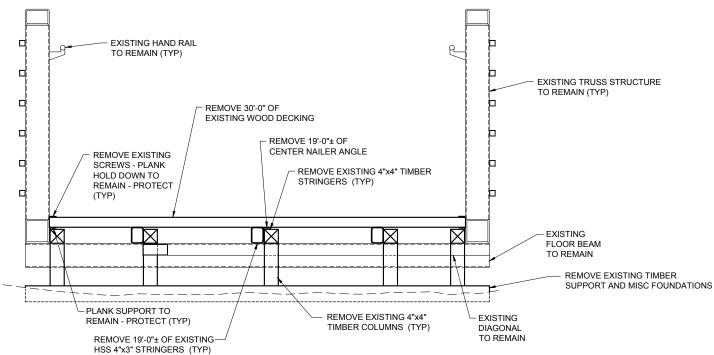



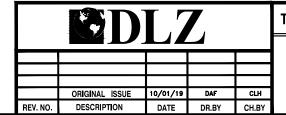

THE CITY OF ANN ARBOR - PARKS AND RECREATION SERVICES


2019 PARK BRIDGE REPAIRS AND RENOVATIONS


SOUTH BARTON PEDESTRIAN STRUCTURE EXISTING TRUSS CONDITIONS AND REMOVALS

AS SHOWN DRAWING NO.

SHEET NO. <u>6</u> OF <u>22</u>

SCALE

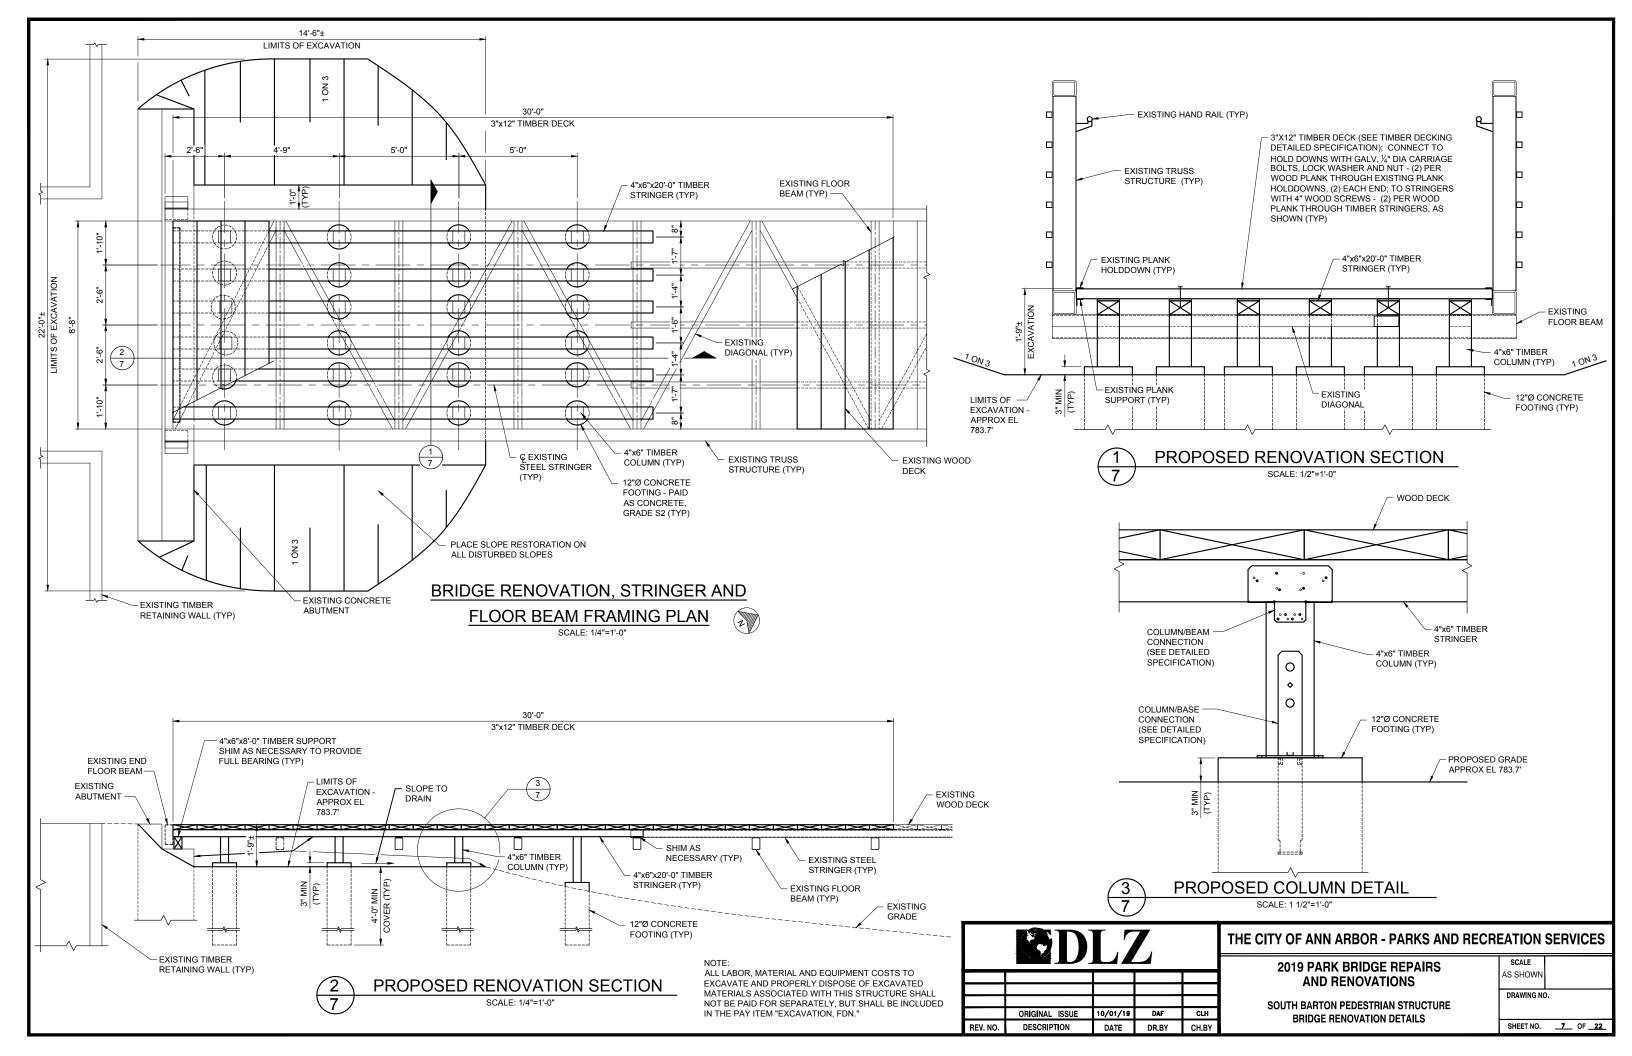

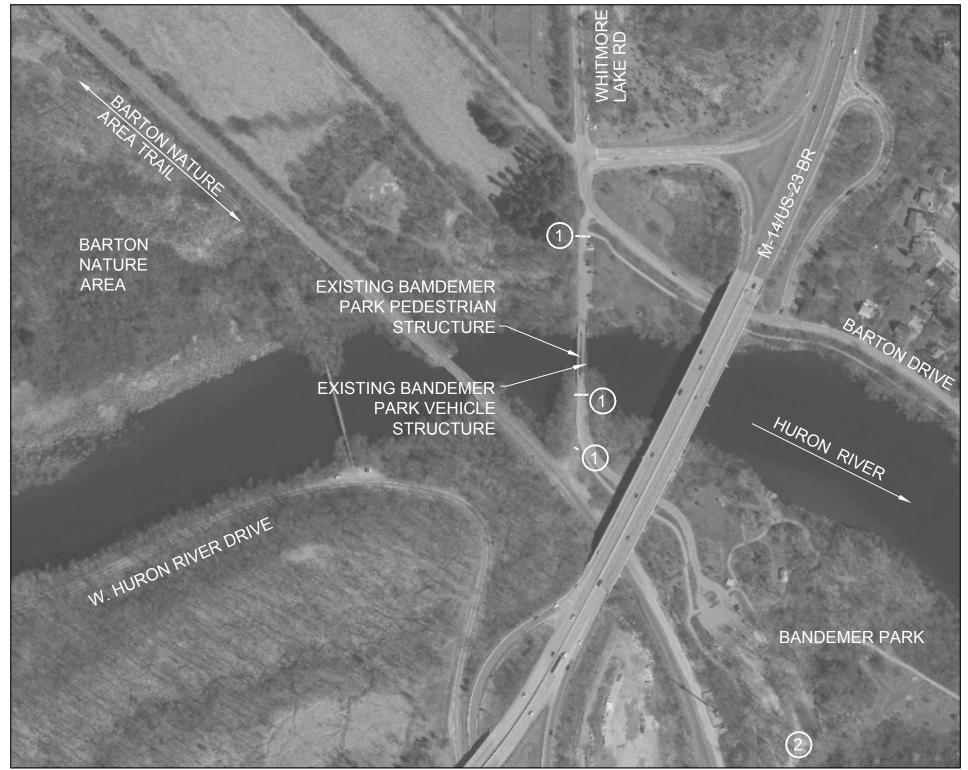

PLAN OF BANDEMER PARK PEDESTRIAN AND VEHICLE STRUCTURES



NOTES:

- 1. THE STRUCTURES ARE LOCATED IN BANDEMER PARK, WHICH IS SOUTH OF THE BARTON DRIVE EXIT FROM SB M-14/US-23 BUSINESS. THE INTERSECTION OF BARTON DRIVE/BARTON SHORE DRIVE/WHITMORE LAKE ROAD IS LOCATED 0.10 MILES NORTH OF THE STRUCTURE. THE ENTRANCE TO THE PARK IS LOCATED ON BARTON DRIVE, APPROXIMATELY 0.10 MILES WEST OF M-14/US-23 BUSINESS. THE PEDESTRIAN STRUCTURE AND VEHICLE STRUCTURE ARE ADJACENT TO EACH OTHER.
- 2. THE EXISTING STRUCTURES ARE SINGLE-SPAN WEATHERING STEEL TRUSS SUPERSTRUCTURES, 118'-6" IN LENGTH, WITH CONCRETE ABUTMENTS. THE PEDESTRIAN STRUCTURE IS DESIGNED FOR 85 PSF UNIFORM LIVE LOADING OR ONE 9,000 LB VEHICLE. THE CLEAR WIDTH IS 8'-0". THE VEHICLE STRUCTURE IS DESIGNED FOR HS-20 VEHICLE LOAD. THE CLEAR ROADWAY WIDTH IS 12'-0".
- 3. THE WORK FOR THE PEDESTRIAN STRUCTURE CONSISTS OF: REMOVAL OF THE EXISTING WOOD DECKING; REMOVAL OF PORTIONS OF THE EXISTING STRINGERS; CLEANING AND COATING THE EXISTING FLOOR BEAMS; REMOVAL OF THE EXISTING WOOD HAND RAILS; PLACEMENT OF WOOD DECKING; PLACEMENT OF GALVANIZED STRINGERS; PLACEMENT OF COMPOSITE HANDRAILS; AND, CLOSING THE STRUCTURE TO PEDESTRIAN USAGE DURING CONSTRUCTION.
- 4. THE WORK FOR THE VEHICLE STRUCTURE CONSISTS OF: REMOVAL OF THE EXISTING WOOD DECKING; REMOVAL OF PORTIONS OF THE EXISTING STRINGERS, END STOPS AND JOINT COVER PLATE; CLEANING AND COATING THE EXISTING FLOOR BEAMS; REMOVAL OF THE EXISTING WOOD HAND RAILS; REMOVAL OF THE EXISTING GUARDRAILS AND BACKUP RAILS; PLACEMENT OF WOOD DECKING; PLACEMENT OF GALVANIZED STRINGERS, END STOPS AND JOINT COVER PLATES; PLACEMENT OF GUARDRAILS AND BACKUP RAILS; PLACEMENT OF COMPOSITE HANDRAILS; AND, CLOSING THE STRUCTURE TO VEHICLE TRAFFIC DURING CONSTRUCTION
- 5. THE CONTRACTOR MAY USE AN AREA OF THE PAVED SURFACE PARKING LOT IMMEDIATELY NORTH OF THE NORTH END OF THE STRUCTURES FOR EQUIPMENT, MATERIAL STORAGE, AND EMPLOYEE PARKING. THE AREA USED SHALL NOT EXCEED 100 FEET IN LENGTH ALONG THE ROADWAY BY APPROXIMATELY 15 FEET. THE USE OF ANY TRAILS OR GRASS AREAS FOR THESE PURPOSES IS STRICTLY FORBIDDEN. THE CONTRACTOR SHALL NOT BLOCK THE USE OF ANY TRAIL WITHIN THE PARK, EXCEPT FOR THE STRUCTURE PORTION.
- 6. THE CONTRACTOR SHALL FIELD VERIFY ALL EXISTING AND PROPOSED DIMENSIONS PRIOR TO FABRICATION AND INSTALLATION OF PROPOSED WORK.
- 7. THE ESTIMATED AREA OF STRUCTURAL STEEL TO BE CLEANED AND COATED ON THE PEDESTRIAN STRUCTURE IS 340 SFT. THE ESTIMATED AREA OF STRUCTURAL STEEL TO BE CLEANED AND COATED ON THE VEHICLE STRUCTURE IS 1020 SFT. THIS INCLUDES THE FLOOR BEAMS OF THE TRUSS SUPERSTRUCTURES.
- 8. THE CONTRACTOR SHALL TAKE NECESSARY MEASURES TO AVOID OVERSPRAY ON ADJACENT SUBSTRUCTURE AND SUPERSTRUCTURE CONCRETE SURFACES AND ON ADJACENT STEEL AREAS NOT TO BE CLEANED AND COATED. (INCLUDED IN THE BID ITEM "STEEL STRUCTURE, COATING, PARTIAL, SPECIAL (BANDEMER PED)" AND "STEEL STRUCTURE, COATING, PARTIAL, SPECIAL (BANDEMER VEH)."
- 9. MEASURES SHALL BE TAKEN TO PREVENT DEBRIS FROM FALLING FROM THE STRUCTURE. IF DEBRIS FALLS INTO THE WATERWAY, IT SHALL BE REMOVED IMMEDIATELY. SINCE DISTURBANCE OF THE WATERWAY BOTTOM MAY BE AS HARMFUL AS THE DEBRIS ITSELF, THE PREVENTIVE MEASURES MUST BE EFFECTIVE.

LEGEND TRAFFIC CONTROL NOTES:




PLACE THREE (3) TYPE III BARRICADES ON BANDEMER PARK ROADWAY AND PEDESTRIAN PATH WITH ONE (1) "BRIDGE CLOSED" (R11-2) SIGN, ON SEPARATE SUPPORTS. ONE (1) SET OF BARRICADES SHALL BE PLACED AT BARTON DRIVE (PARK ENTRANCE) AND ONE (1) SET SOUTH OF STRUCTURE ACROSS THE BANDEMER PARK ROADWAY AND PATH. PLACE ONE (1) TYPE III BARRICADE ACROSS GRAVEL PATH TO DETER ILLEGAL CROSSING OF RAILROAD TRACKS. PLACE PROTECTIVE FENCING AROUND PROJECT SITE IN ACCORDANCE WITH THE DETAILED SPECIFICATION FOR MAINTENANCE OF TRAFFIC AND CONSTRUCTION SEQUENCING.



PLACE "BRIDGE CLOSED" (R11-2) SIGN AND "TRAIL CLOSED - 1/2 MILE AHEAD" (SF-2) SIGN WHEN THE STRUCTURES AT BANDEMER PARK ARE CLOSED FOR CONSTRUCTION.

ESTIMATED QUANTITIES OF TRAFFIC CONTROL DEVICES FOR BANDEMER PARK STRUCTURES:

PAY ITEM	UNIT	QUANTITY
BARRICADE, TYPE III, HIGH INTENSITY, LIGHTED, FURN	EACH	7
BARRICADE, TYPE III, HIGH INTENSITY, LIGHTED, OPER	EACH	7
SIGN, TYPE B, TEMP, PRISMATIC, FURN	SFT	20
SIGN, TYPE B, TEMP, PRISMATIC, OPER	SFT	20
SIGN, TYPE B, TEMP, PRISMATIC, SPECIAL, FURN	SFT	14
SIGN, TYPE B, TEMP, PRISMATIC, SPECIAL, OPER	SFT	14
FENCE, PROTECTIVE	FT	300

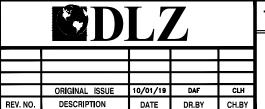



THE CITY OF ANN ARBOR - PARKS AND RECREATION SERVICES


2019 PARK BRIDGE REPAIRS
AND RENOVATIONS
BANDEMER PARK PEDESTRIAN
AND VEHICLE STRUCTURES


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DRAWING NO.


ND VEHICLE STRUCTURES
GENERAL PLAN OF SITE SHEET NO. ____8_ OF ___22_

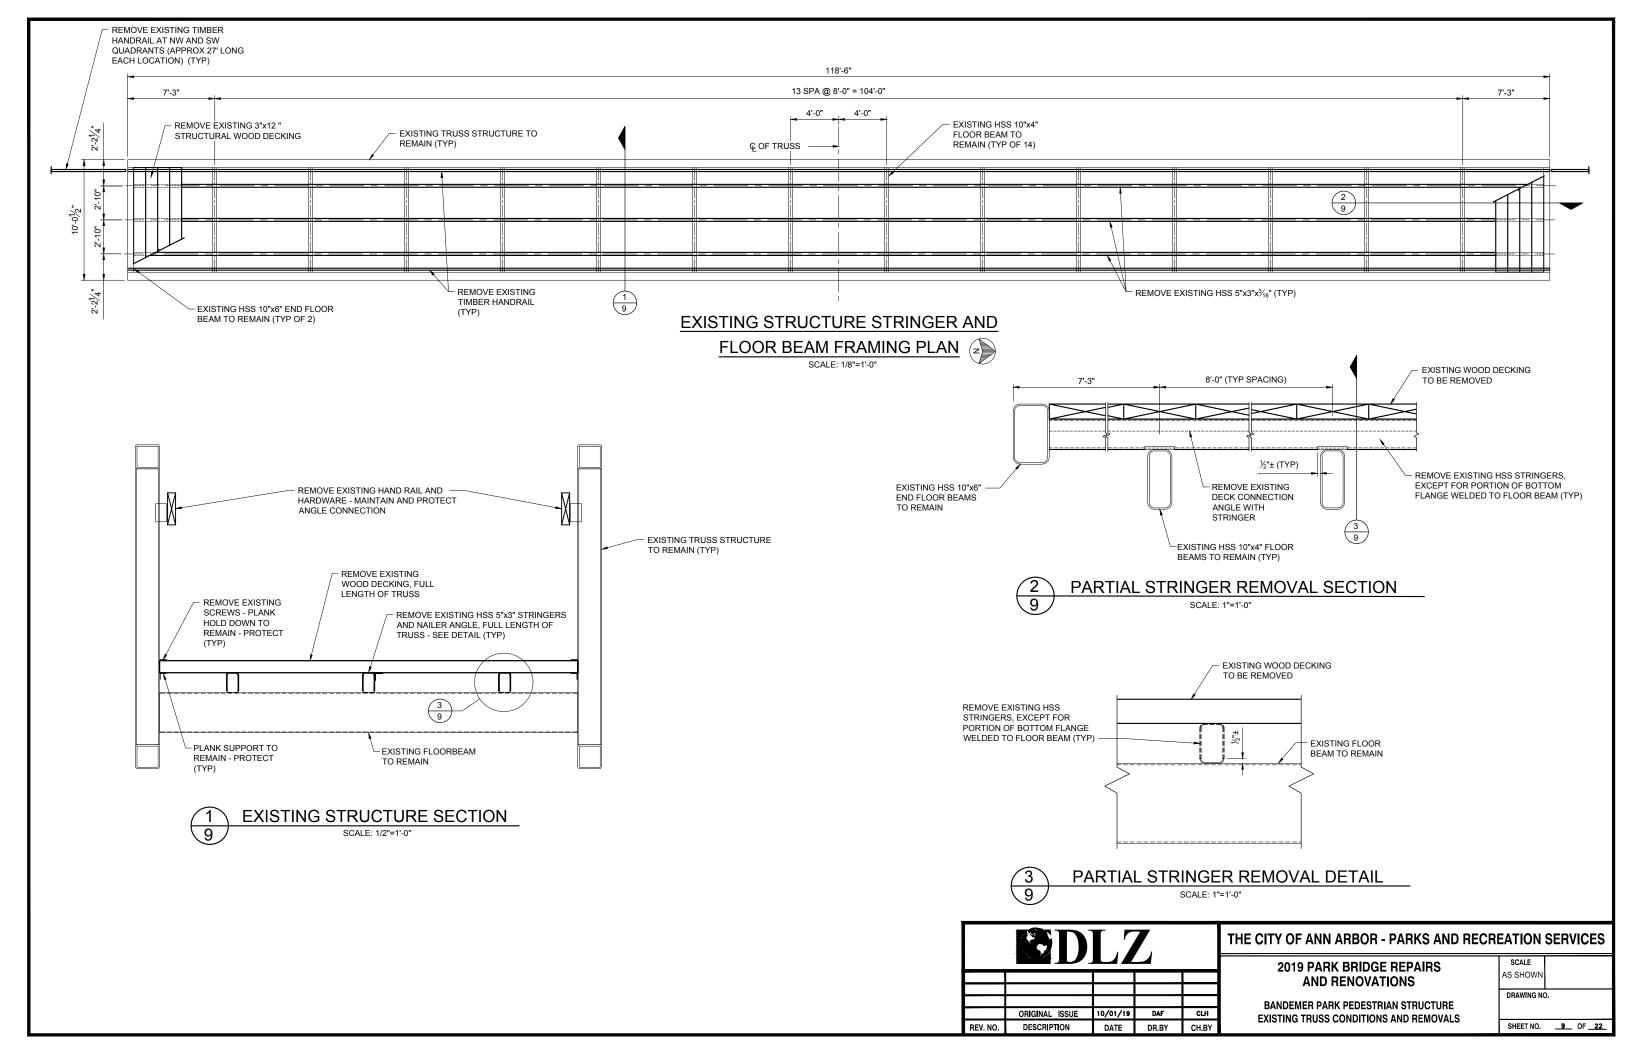

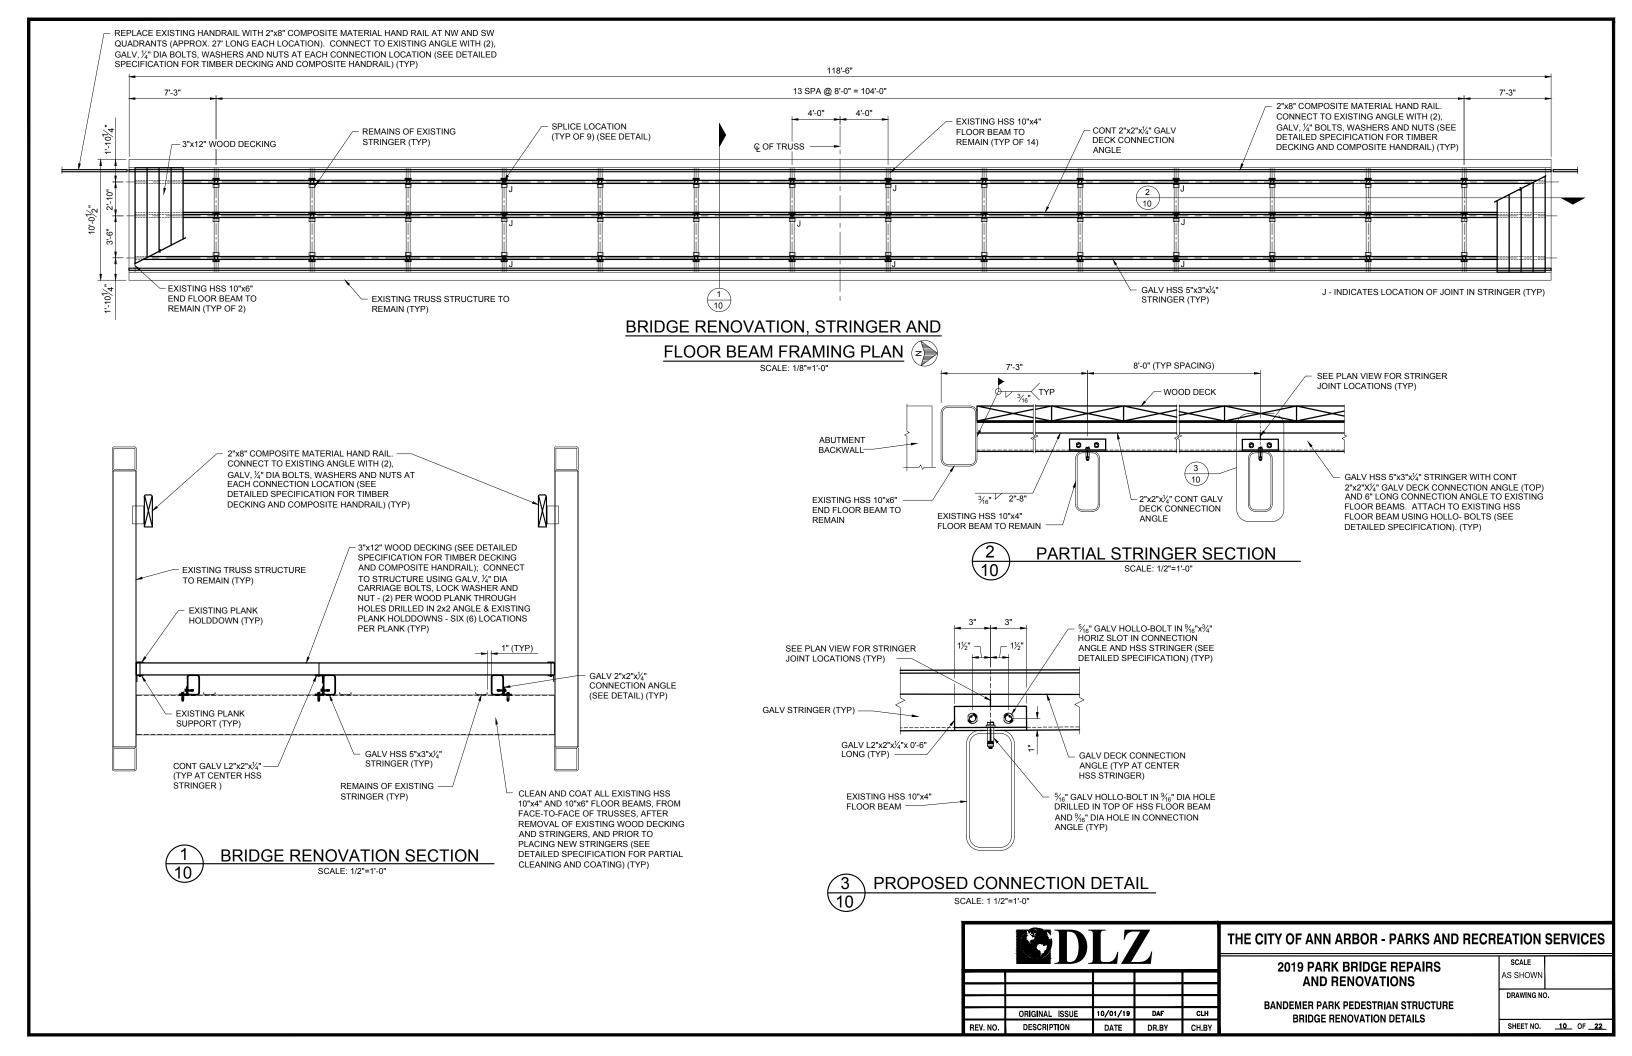

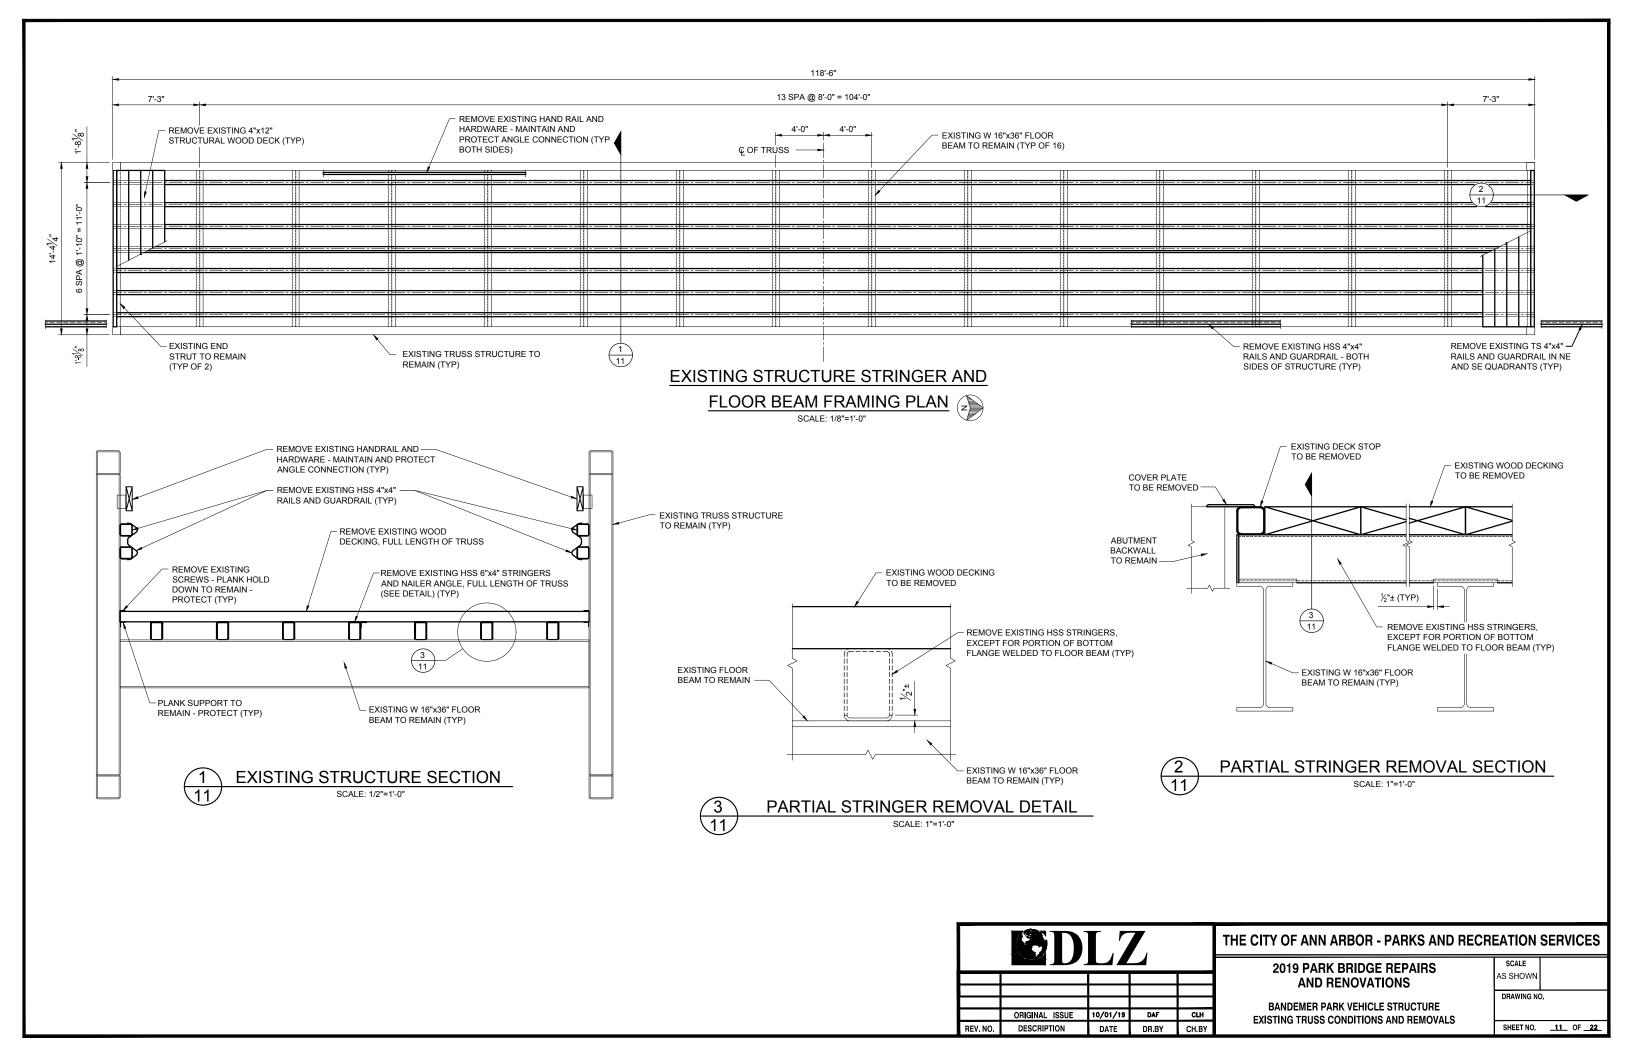

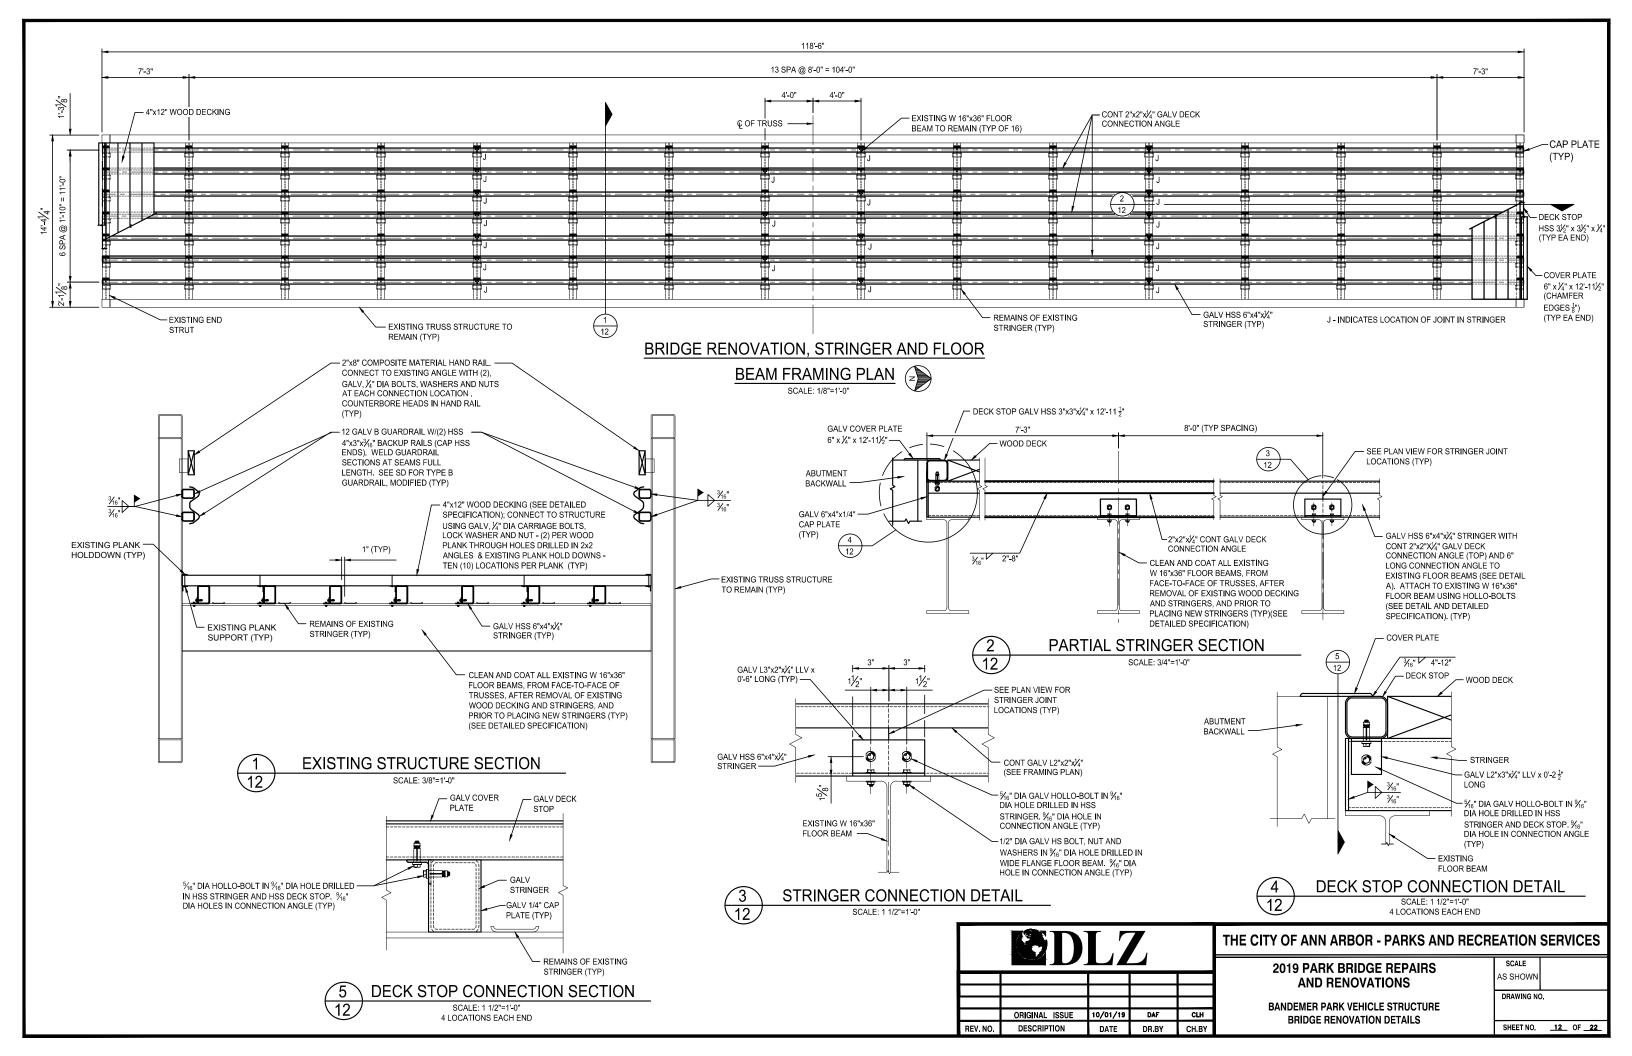

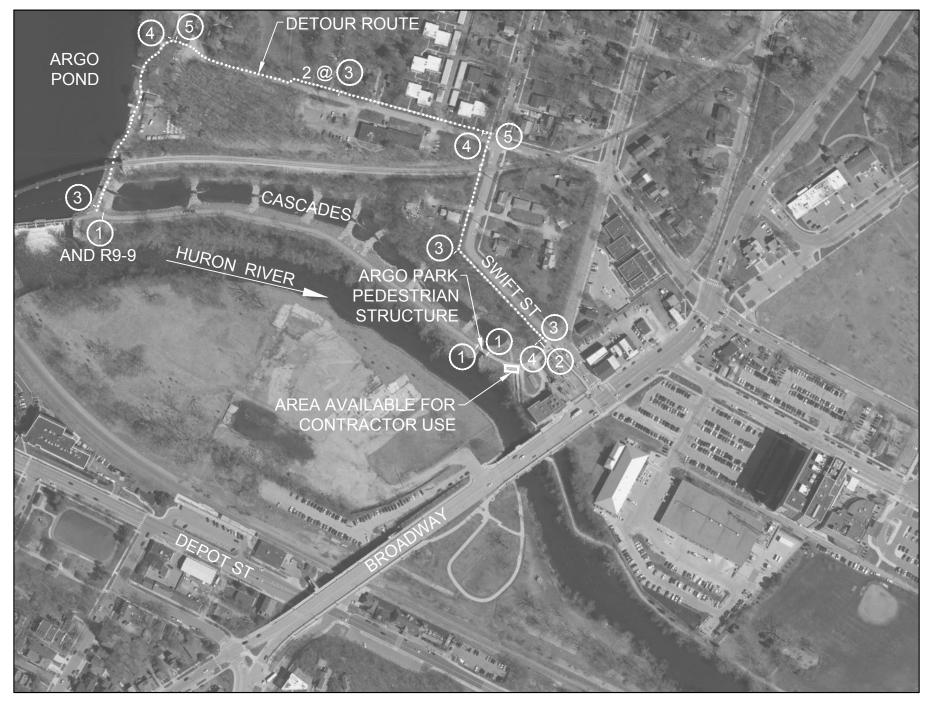

PLAN OF ARGO PARK PEDESTRIAN STRUCTURE



NOTES:

- 1. THE STRUCTURE IS LOCATED AT THE SOUTHEAST CORNER OF ARGO PARK, WEST OF THE INTERSECTION OF BROADWAY STREET AND SWIFT STREET. THE ENTRANCE TO THE PATH IS LOCATED ON SWIFT STREET, APPROXIMATELY 0.04 MILES NORTHWEST OF BROADWAY STREET
- 2. THE EXISTING STRUCTURE IS A SINGLE-SPAN STEEL TRUSS STRUCTURE, 30'-0" IN LENGTH, WITH CONCRETE ABUTMENTS. THE DESIGN LOAD IS 85 PSF UNIFORM LIVE LOADING OR ONE 20,000 POUND VEHICLE LOAD. THE CLEAR BRIDGE WIDTH IS 12'-0".
- THE WORK CONSISTS OF: REMOVAL AND SALVAGING THE EXISTING TIMBER DECKING; CLEANING AND COATING OF THE EXISTING FLOOR BEAMS, STRINGERS AND BRACE DIAGONALS; PLACEMENT OF SALVAGED TIMBER DECKING; AND PEDESTRIAN TRAFFIC CONTROL.
- 4. THE CONTRACTOR MAY USE AN AREA OF THE PAVED SURFACE DRIVE IMMEDIATELY SOUTHEAST OF THE STRUCTURE FOR EQUIPMENT, MATERIAL STORAGE, AND EMPLOYEE PARKING. THE AREA USED SHALL NOT EXCEED 40 FEET IN LENGTH BY APPROXIMATELY 15 FEET. THE USE OF ANY TRAILS OR GRASS AREAS FOR THESE PURPOSES IS STRICTLY FOREIDDEN.
- 5. THE ESTIMATED AREA OF STRUCTURAL STEEL TO BE CLEANED AND COATED IS 470 SFT. THIS INCLUDES THE STRINGERS, FLOOR BEAMS AND BRACING DIAGONALS OF THE TRUSS SUPERSTRUCTURE.
- 6. THE CONTRACTOR SHALL TAKE NECESSARY MEASURES TO AVOID OVERSPRAY ON ADJACENT SUBSTRUCTURE AND SUPERSTRUCTURE CONCRETE SURFACES AND ON ADJACENT STEEL AREAS NOT TO BE CLEANED AND COATED. (INCLUDED IN THE BID ITEM "STEEL STRUCTURE, COATING, PARTIAL, SPECIAL (ARGO)."
- MEASURES SHALL BE TAKEN TO PREVENT DEBRIS FROM FALLING FROM THE STRUCTURE. IF DEBRIS FALLS INTO THE WATERWAY, IT SHALL BE REMOVED IMMEDIATELY. SINCE DISTURBANCE OF THE WATERWAY BOTTOM MAY BE AS HARMFUL AS THE DEBRIS ITSELF, THE PREVENTIVE MEASURES MUST BE EFFECTIVE.

LEGEND TRAFFIC CONTROL NOTES:



PLACE TWO (2) TYPE III BARRICADES ON ARGO PARK PATH WITH ONE (1) "BRIDGE CLOSED" (R11-2) SIGN ON SEPARATE SUPPORTS, AT EACH END OF STRUCTURE. PLACE PROTECTIVE FENCING AROUND PROJECT SITE. SEE THE DETAILED SPECIFICATION FOR MAINTENANCE OF TRAFFIC AND CONSTRUCTION SEQUENCING FOR ADDITIONAL INFORMATION.



PLACE "BRIDGE CLOSED" (R11-2) AND "SIDEWALK CLOSED (R9-9). SEE DETAILED SPECIFICATION FOR MAINTENANCE OF TRAFFIC AND CONSTRUCTION SEQUENCING.

ALL SIGN LOCATIONS TO BE APPROVED BY ENGINEER/OWNER.



M4-9a (STRAIGHT)




M4-9a (RIGHT)



M4-9a (LEFT)

ESTIMATED QUANTITIES OF TRAFFIC CONTROL DEVICES FOR ARGO PARK:

PAY ITEM	UNIT	QUANTITY
BARRICADE, TYPE III, HIGH INTENSITY, LIGHTED, FURN	EACH	6
BARRICADE, TYPE III, HIGH INTENSITY, LIGHTED, OPER	EACH	6
SIGN, TYPE B, TEMP, PRISMATIC, FURN	SFT	101
SIGN, TYPE B, TEMP, PRISMATIC, OPER	SFT	101
FENCE, PROTECTIVE	FT	200

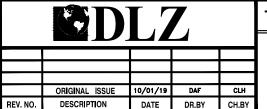



THE CITY OF ANN ARBOR - PARKS AND RECREATION SERVICES

2019 PARK BRIDGE REPAIRS AND RENOVATIONS

ARGO PARK PEDESTRIAN STRUCTURE GENERAL PLAN OF SITE SCALE
NONE
DRAWING NO.

SHEET NO. <u>13</u> OF <u>22</u>

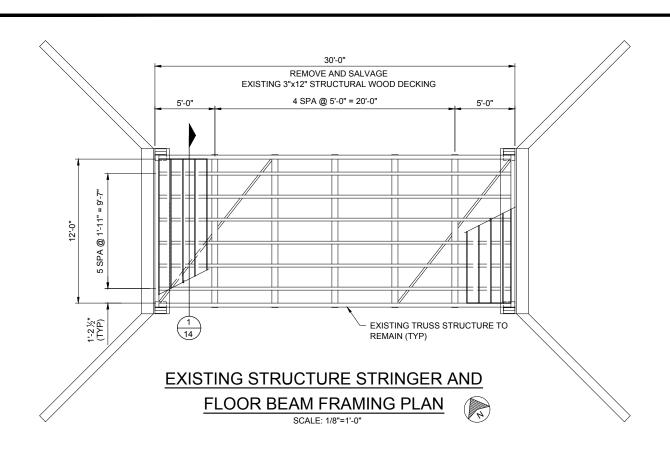

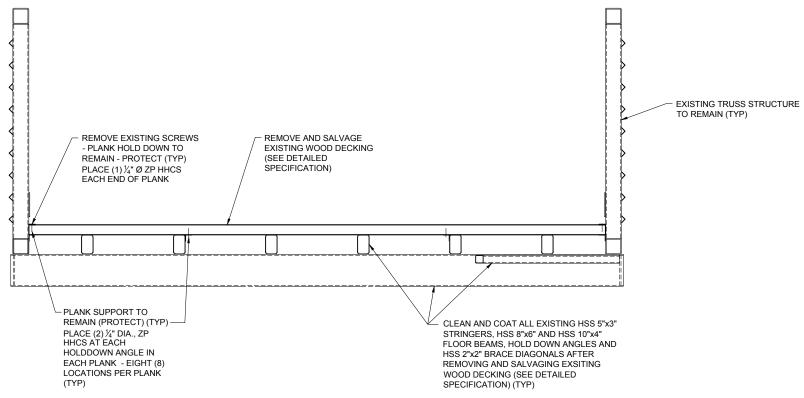

1 EXISTING STRUCTURE SECTION
SCALE: 1/2"=1'-0"

ORIGINAL ISSUE 10/01/19 DAF CLH
REV. NO. DESCRIPTION DATE DR.BY CH.BY

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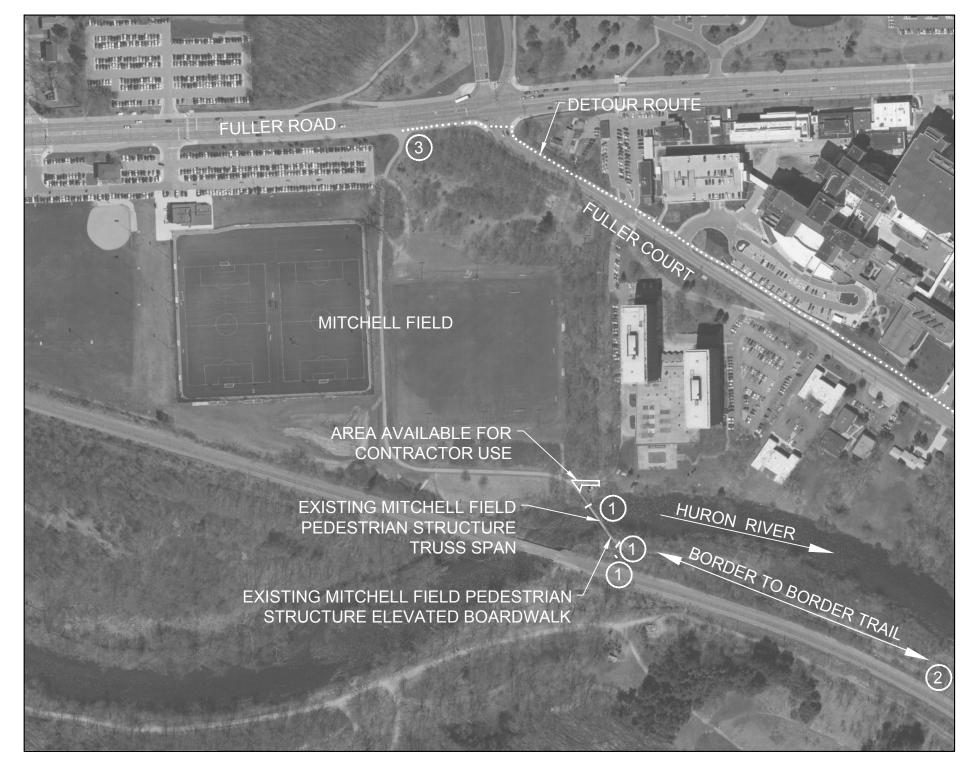
2019 PARK BRIDGE REPAIRS AND RENOVATIONS

ARGO PARK PEDESTRIAN STRUCTURE REMOVAL AND CONSTRUCTION DETAILS

AS SHOWN DRAWING NO.

SHEET NO. <u>14</u> OF <u>22</u>

SCALE



PLAN OF MITCHELL FIELD PEDESTRIAN STRUCTURES



NOTES:

- 1. THE STRUCTURE IS LOCATED AT THE SOUTHEAST CORNER OF MITCHELL FIELD, SOUTH OF FULLER COURT AND FULLER ROAD
- 2. THE EXISTING STRUCTURE IS SINGLE-SPAN WEATHERING STEEL TRUSS SUPERSTRUCTURE, 133'-6" IN LENGTH, WITH ONE CONCRETE ABUTMENT AND ONE CONCRETE WALL PIER. THE DESIGN LOAD IS UNKNOWN. THE CLEAR WIDTH BETWEEN THE HANDRAILS IS 7'-6". THE EXISTING ELEVATED TIMBER BOARDWALK STRUCTURE IS LOCATED AT THE SOUTHEAST END OF THE ABOVE TRUSS STRUCTURE AND PROVIDES A TRANSITION FROM THE PIER AT THE SOUTHEAST END OF THE TRUSS STRUCTURE TO THE GROUND. THE TIMBER BOARDWALK STRUCTURE IS APPROXIMATELY 23'-6" IN LENGTH, AND CONSISTS OF TWO SPANS SUPPORTED BY A CONCRETE PIER (SHARED WITH THE TRUSS STRUCTURE), A STEEL PILE AND TIMBER PIER, AND A STEEL PILE AND TIMBER ABUTMENT.
- 3. THE WORK ON THE TRUSS SUPERSTRUCTURE CONSISTS OF: REMOVAL OF THE EXISTING TIMBER DECKING; REMOVAL OF PORTIONS OF THE EXISTING STRINGERS; CLEANING AND COATING THE EXISTING FLOOR BEAMS AND FASCIA STRINGERS; REMOVAL OF THE EXISTING TIMBER HAND RAILS AND ALL HORIZONTAL TIMBER RAILS; REMOVAL AND PLACEMENT OF HANDRAILS AND HORIZONTAL RAILS ON THE APPROACH RAILINGS NORTH OF THE TRUSS SUPERSTRUCTURE; PLACEMENT OF TIMBER DECKING; PLACEMENT OF GALVANIZED STRINGERS; PLACEMENT OF COMPOSITE HANDRAILS AND ALL TIMBER RAILS
- 4. THE WORK ON THE ELEVATED TIMBER BOARDWALK CONSISTS OF: REMOVAL OF THE TIMBER DECKING; REMOVAL OF THE HANDRAILS (ALL COMPONENTS); REMOVAL OF THE TIMBER STRINGERS; REMOVAL OF THE TIMBER FLOOR BEAMS/PIER HEADER BEAMS; REMOVAL OF THE TIMBER BEARING BEAM AND HEADER AT THE SHARED PIER; PLACEMENT OF TIMBER FLOOR BEAMS/PIER HEADER BEAMS; PLACEMENT OF TIMBER BEARING BEAM AND HEADER AT THE SHARED PIER; PLACEMENT OF SUPPORT ANGLES AT PIER; PLACEMENT OF TIMBER STRINGERS; PLACEMENT OF TIMBER DECKING; PLACEMENT OF RAILINGS; PLACEMENT OF HANDRAILS AND HORIZONTAL RAILS ON THE APPROACH RAILINGS SOUTH OF THE ELEVATED TIMBER BOARDWALK STRUCTURE. PAYMENT FOR THE HORIZONTAL RAILS IS INCLUDED IN THE PAY ITEM "COMPOSITE RAILING, 2 INCH BY 8 INCH." ALL OTHER ITEMS OF WORK ARE INCLUDED IN THE PAY ITEM "STRUCTURE, TIMBER, BOARDWALK (MITCHELL BOARDWALK)."
- 5. THE CONTRACTOR MAY USE AN AREA THE AREA SHOWN AT LEFT AND/OR AN AREA SOUTH OF THE STRUCTURE FOR EQUIPMENT, MATERIAL STORAGE, AND EMPLOYEE PARKING. THE AREA SOUTH OF THE STRUCTURE, IF USED, SHALL NOT EXCEED 100 FEET IN LENGTH ALONG THE TRAIL BY WIDTH OF THE TRAIL. ACCESS TO THIS STRUCTURE CAN BE FROM MITCHELL FIELD/FULLER ROAD, USING THE BORDER TO BORDER TRAIL. ANY DAMAGE TO THE TRAIL OR ADJACENT GROUND SHALL BE REPAIRED BY THE CONTRACTOR AT NO COST TO THE CITY. THE USE OF ANY OTHER TRAILS OR GRASS AREAS FOR THESE PURPOSES IS STRICTLY FORBIDDEN. THE CONTRACTOR SHALL NOT BLOCK THE USE OF ANY TRAIL WITHIN THE PARK OTHER THAN THE AREA DESCRIBED ABOVE.
- 6. THE CONTRACTOR SHALL FIELD VERIFY ALL EXISTING AND PROPOSED DIMENSIONS PRIOR TO FABRICATION AND INSTALLATION OF PROPOSED WORK.
- 7. THE ESTIMATED AREA OF STRUCTURAL STEEL TO BE CLEANED AND COATED IS 780 SFT. THIS INCLUDES THE FASCIA STRINGERS AND FLOOR BEAMS OF THE TRUSS SUPERSTRUCTURE.
- 8. THE CONTRACTOR SHALL TAKE NECESSARY MEASURES TO AVOID OVERSPRAY ON ADJACENT SUBSTRUCTURE AND SUPERSTRUCTURE CONCRETE SURFACES AND ON ADJACENT STEEL AREAS NOT TO BE CLEANED AND COATED. (INCLUDED IN THE BID ITEM "STEEL STRUCTURE, COATING, PARTIAL, SPECIAL (MITCHELL TRUSS)."

LEGEND TRAFFIC CONTROL NOTES:



PLACE TWO (2) TYPE III BARRICADES ON PATH WITH ONE (1) "BRIDGE CLOSED" (R11-2) SIGN ON SEPARATE SUPPORTS, AT EACH END OF STRUCTURE. PLACE ONE (1) TYPE III BARRICADE ADJACENT TO PATH AT SOUTH END OF STRUCTURE TO DETER ILLEGAL CROSSING OF THE RAILROAD TRACKS. PLACE PROTECTIVE FENCING AROUND PROJECT SITE IN ACCORDANCE WITH THE DETAILED SPECIFICATION FOR MAINTENANCE OF TRAFFIC AND CONSTRUCTION SEQUENCING.



SEE PLANS FOR GALLUP PARK FOR AN ADDITIONAL SIGN AND BARRICADES REQUIRED TO BE PLACED ON THE BORDER-TO-BORDER TRIAL IN GALLUP PARK DURING CONSTRUCTION OF THE MITCHELL FIELD STRUCTURES.



PLACE "BRIDGE CLOSED" (R11-2) SIGN.

PLACE PEDESTRIAN/BIKE DETOUR SIGNS (M4-9a, STRAIGHT, LEFT AND RIGHT) ALONG A ROUTE, WITH SIGNS IN BOTH DIRECTIONS, FROM GALLUP PARK ENTRANCE ON FULLER ROAD, ALONG FULLER ROAD AND FULLER COURT, TO THE BORDER-TO-BORDER CROSSING TRAIL CROSSING AT FULLER ROAD, APPROXIMATELY 250 FEET WEST OF THE FULLER ROAD/FULLER COURT INTERSECTION. CONTRACTOR SHALL PREPARE AND SUBMIT FOR APPROVAL THE SIGN LAYOUT THE PLAN QUANTITIES FOR THIS WORK ARE AS FOLLOWS:

M4-9a (STRAIGHT): 12 M4-9a (LEFT): 4

ESTIMATED QUANTITIES OF TRAFFIC CONTROL DEVICES FOR MITCHELL FIELD:

PAY ITEM	UNIT	QUANTIT
BARRICADE, TYPE III, HIGH INTENSITY, LIGHTED, FURN	EACH	5
BARRICADE, TYPE III, HIGH INTENSITY, LIGHTED, OPER	EACH	5
SIGN. TYPE B. TEMP. PRISMATIC. FURN	SFT	130
SIGN. TYPE B. TEMP. PRISMATIC. OPER	SFT	130
ENCE. PROTECTIVE	FT	100

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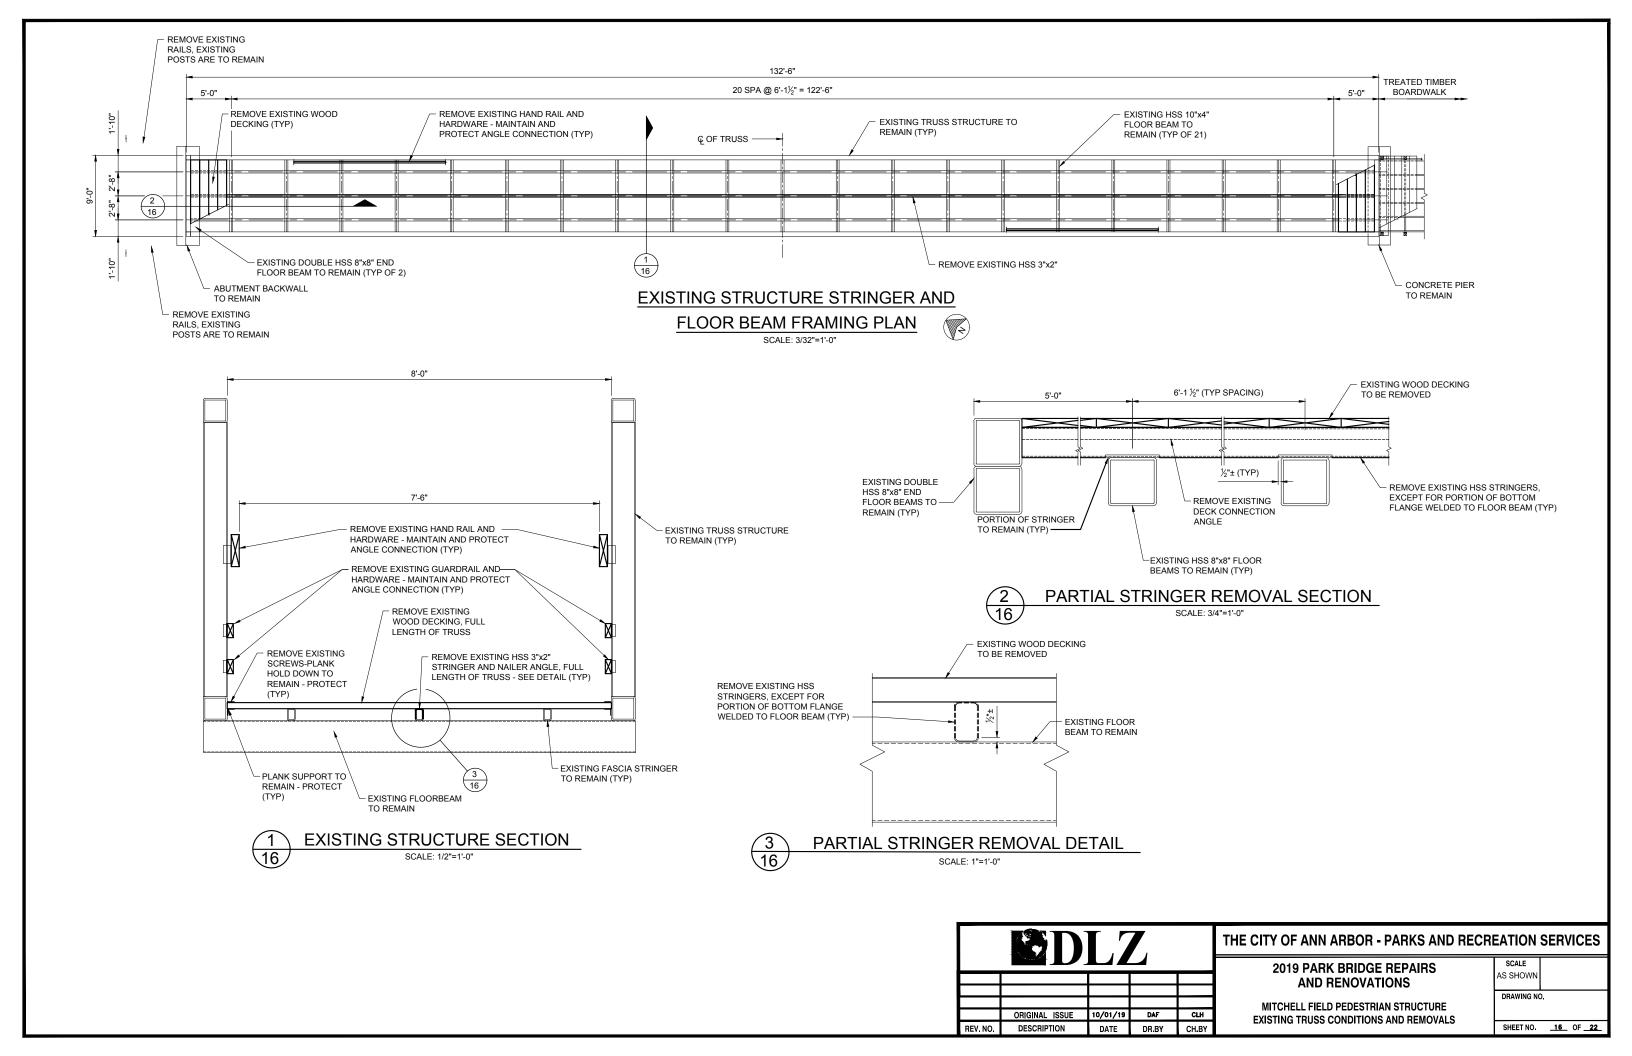
THE CITY OF ANN ARBOR - PARKS AND RECREATION SERVICES


2019 PARK BRIDGE REPAIRS AND RENOVATIONS


MITCHELL FIELD PEDESTRIAN STRUCTURES
GENERAL PLAN OF SITE


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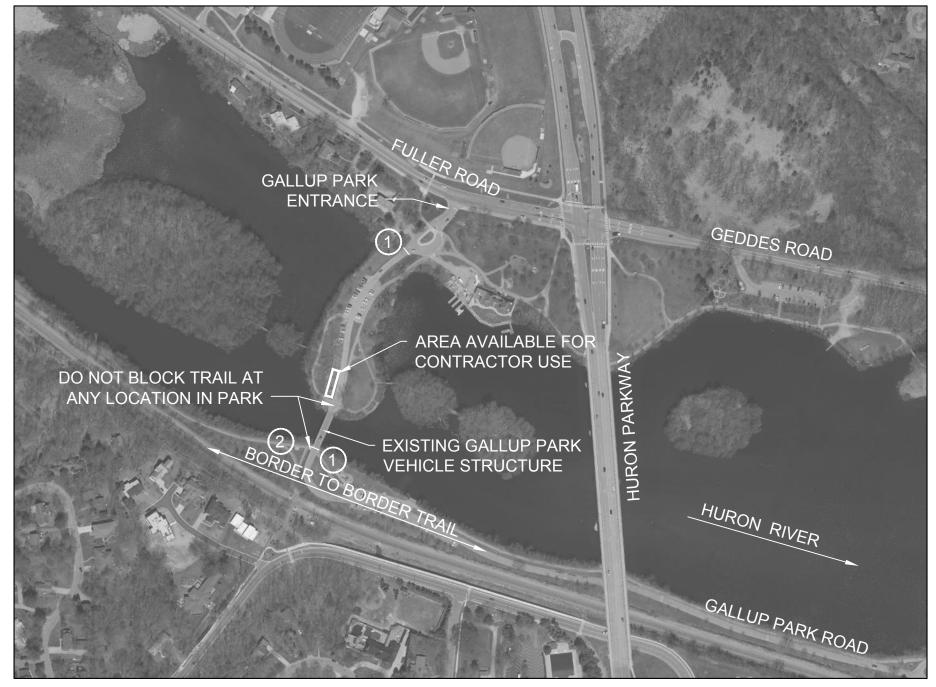
SHEET NO. <u>15</u> OF <u>22</u>





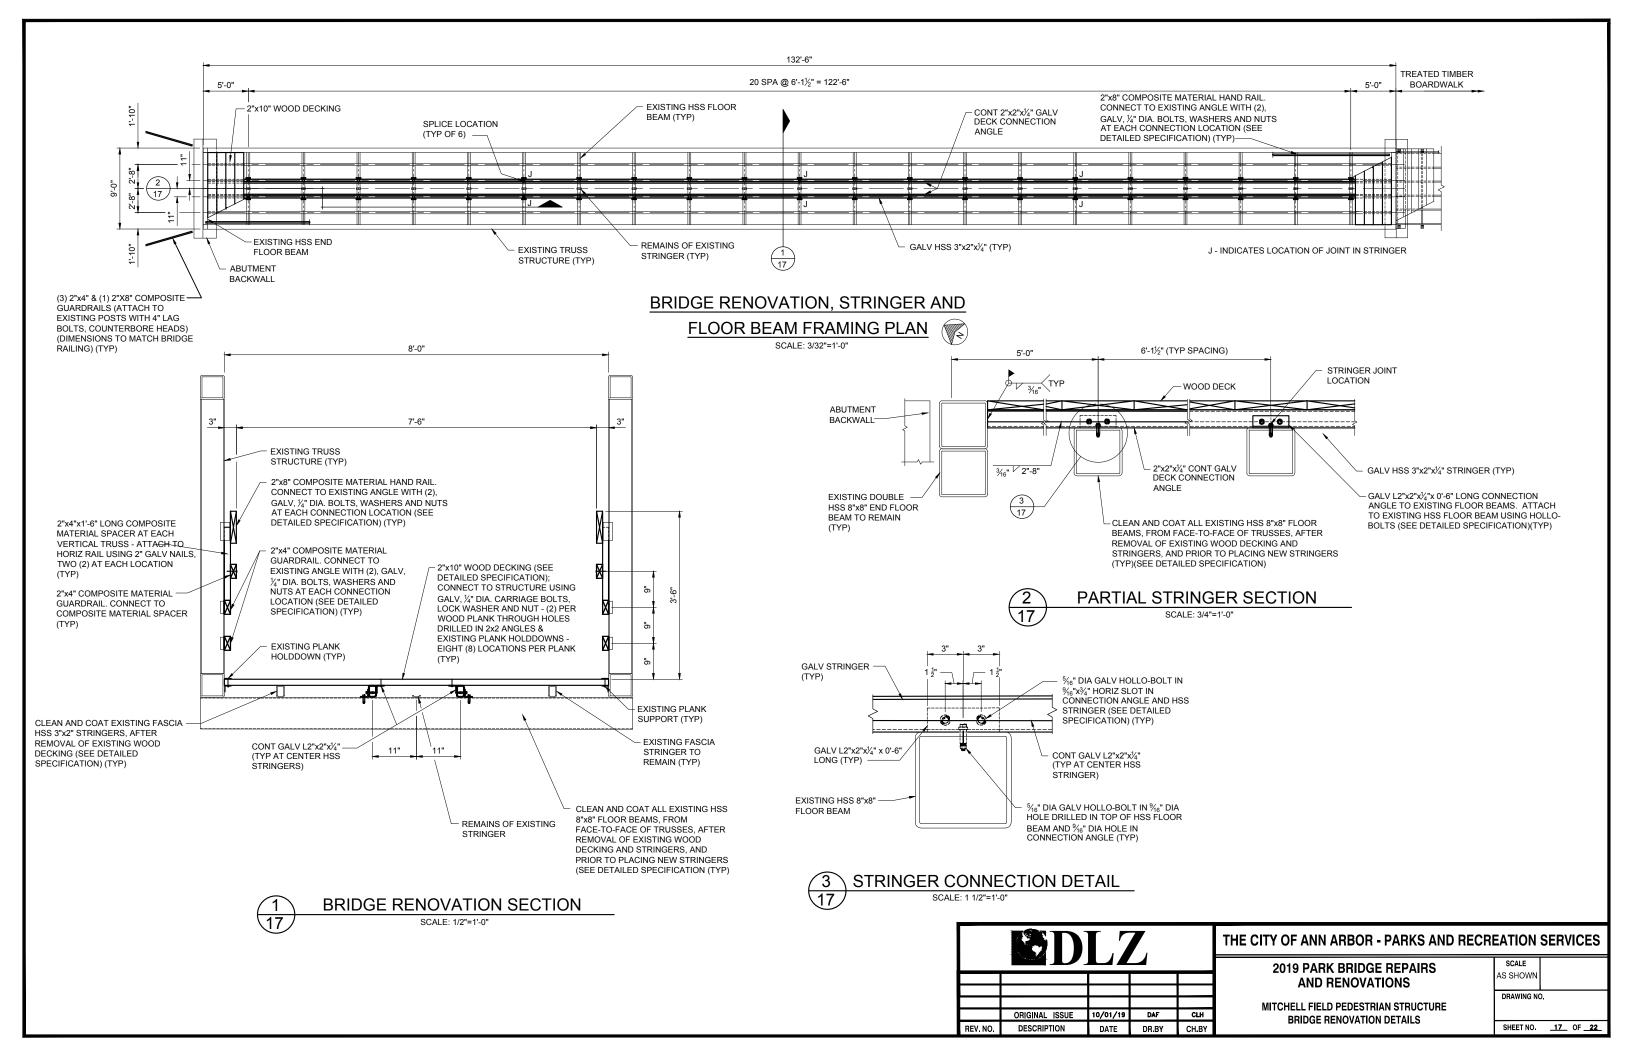

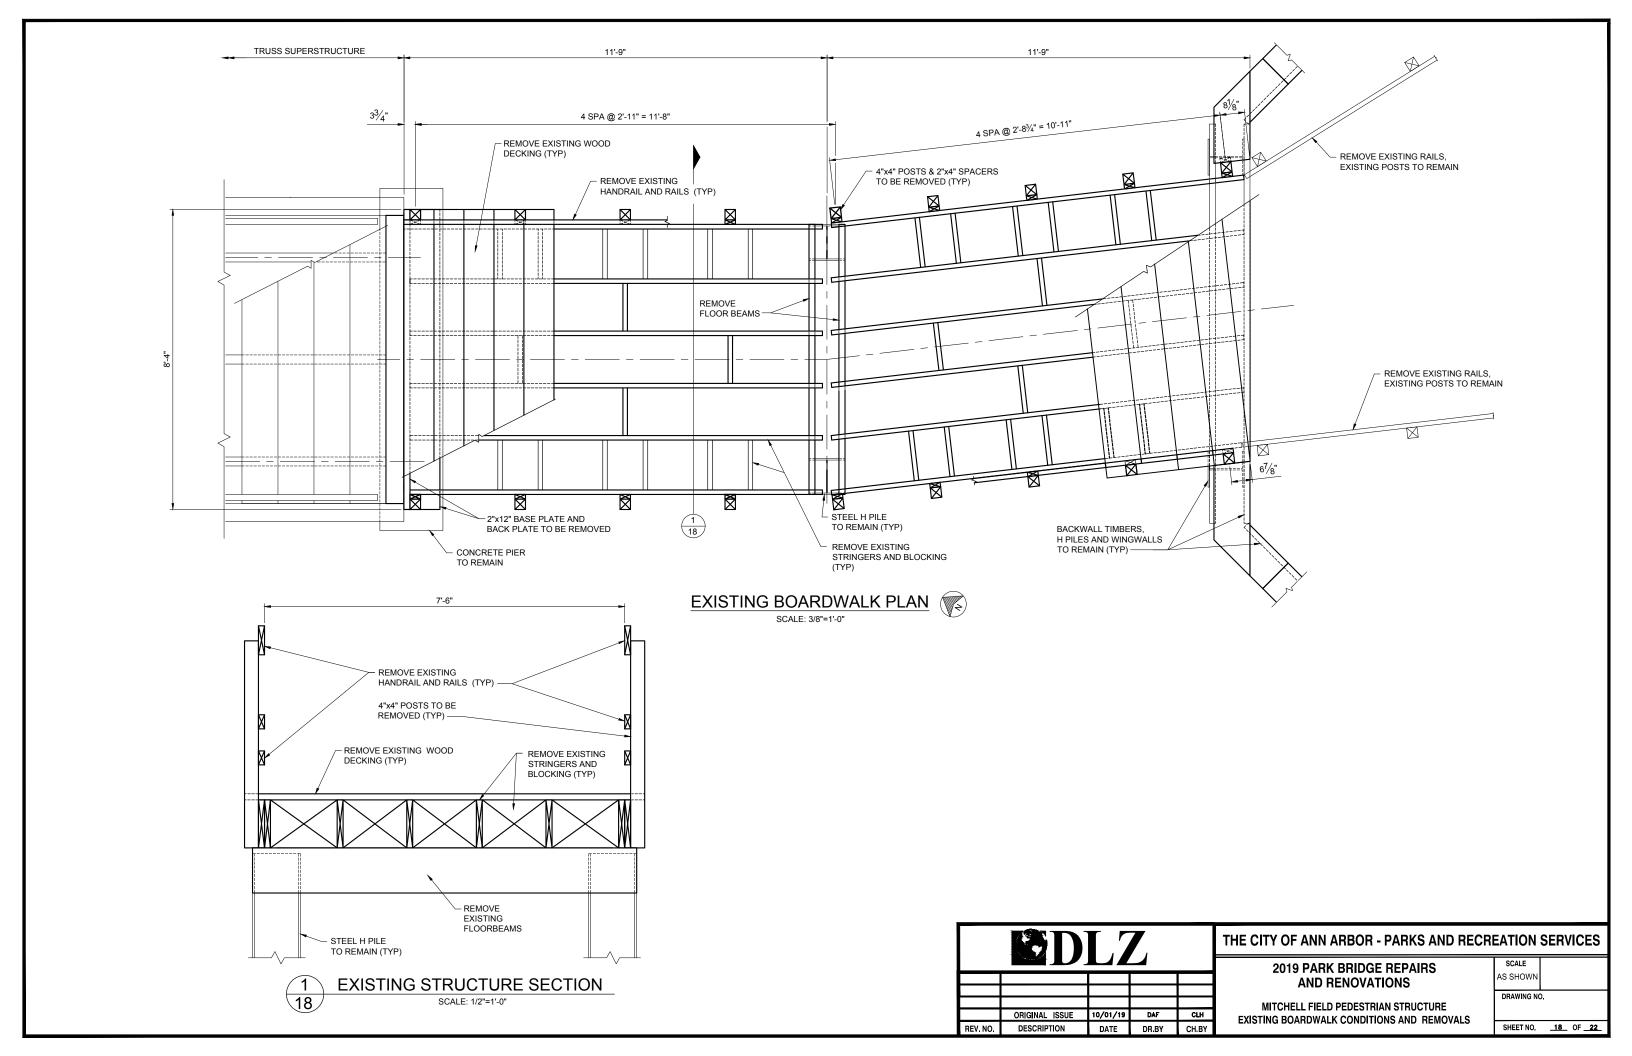

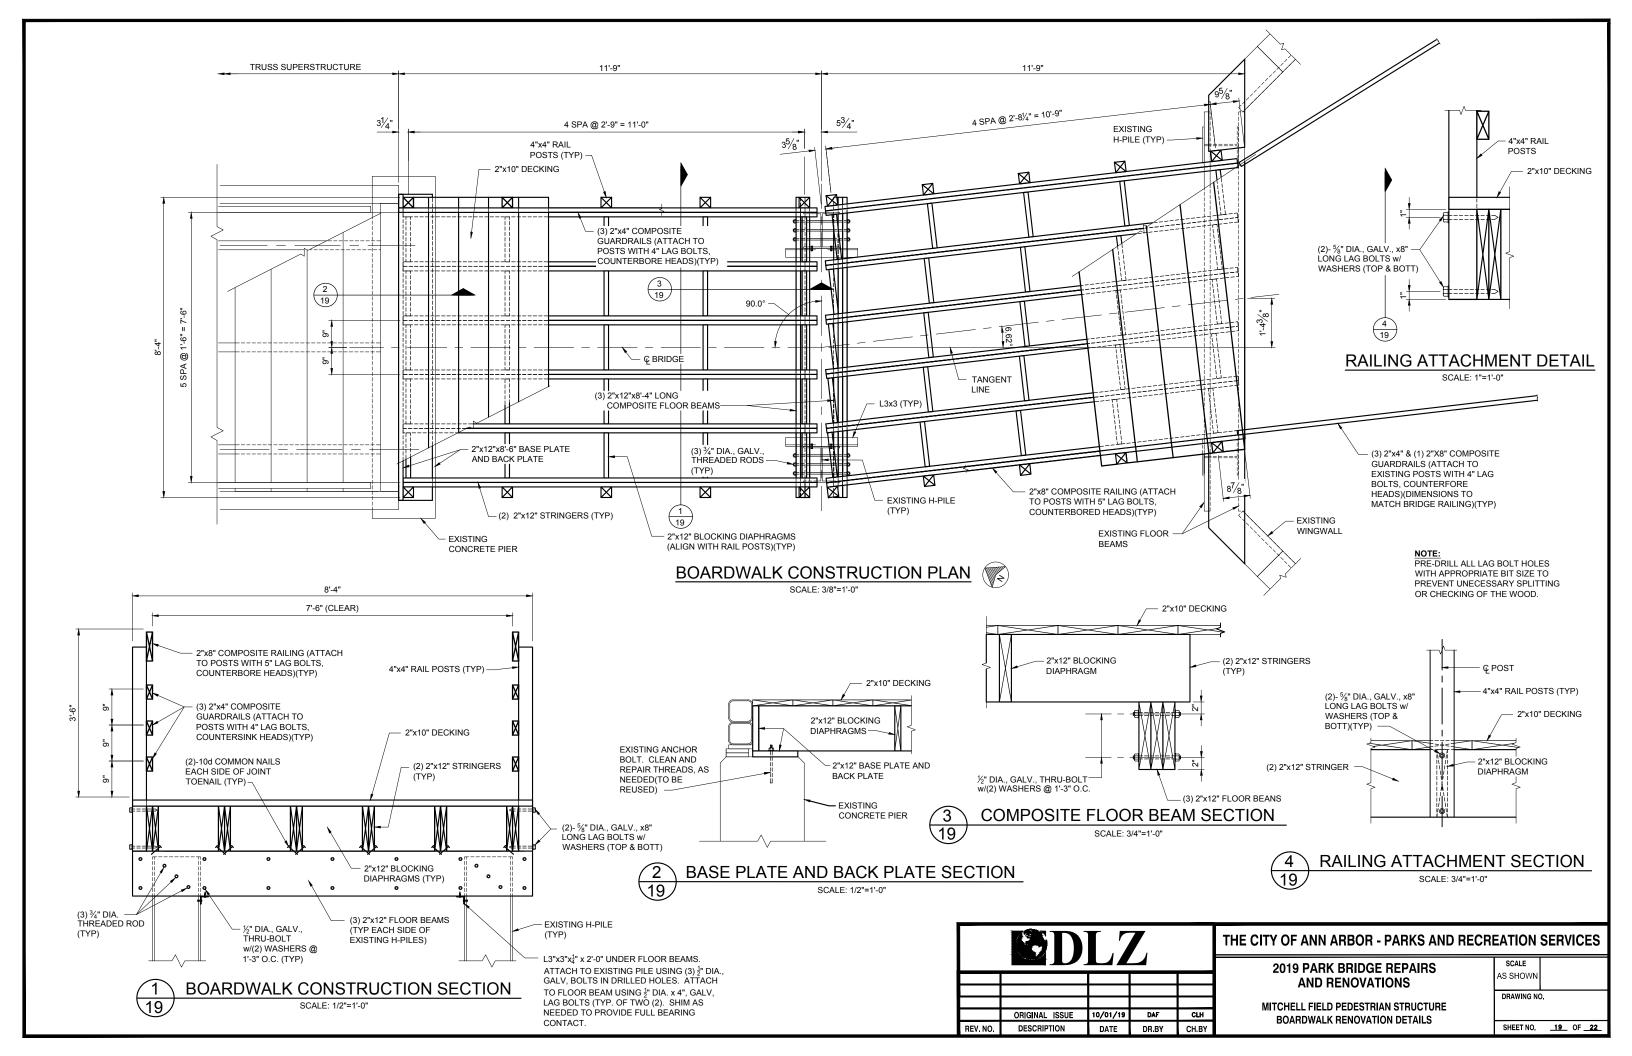

PLAN OF GALLUP PARK STRUCTURE



NOTES:

- 1. THE STRUCTURE IS LOCATED IN GALLUP PARK, WHICH IS SOUTHWEST OF THE INTERSECTION OF FULLER/GEDDES ROAD AND HURON PARKWAY. THE ENTRANCE TO THE PARK IS LOCATED ON FULLER ROAD, APPROXIMATELY 0.08 MILES WEST OF HURON PARKWAY. THE STRUCTURE IS LOCATED APPROXIMATELY 0.17 MILES SOUTH OF FULLER ROAD.
- 2. THE EXISTING STRUCTURE IS A THREE-SPAN GLUE-LAMINATED STRUCTURE, 123'-0" IN LENGTH, WITH TIMBER PILE PIERS AND GLUE-LAMINATED ABUTMENTS. THE BRIDGE IS POSTED FOR 33 TONS. THE CLEAR ROADWAY WIDTH IS 12'-0" AND THE CLEAR SIDEWALK WIDTHS ARE 5'-0".
- 3. THE WORK CONSISTS OF: REMOVAL OF THE EXISTING CONNECTION BRACKETS BETWEEN THE DECK PANELS AND SIDEWALK PANELS AND THE FLOOR BEAMS AND SPREADER BEAMS; PLACEMENT OF NEW GALVANIZED CONNECTION BRACKETS AT SIMILAR LOCATIONS; CLOSING THE STRUCTURE TO VEHICLE TRAFFIC; AND, PROVIDING A SAFE PASSAGE AREA FOR RIVER USERS AT LEAST 20-FEET IN WIDTH BELOW THE STRUCTURE AT ALL TIMES DURING CONSTRUCTION. PEDESTRIAN PASSAGE ACROSS THE STRUCTURE SHALL BE MAINTAINED ON AT LEAST ONE SIDEWALK AT ALL TIMES. THE CONTRACTOR SHALL APPLY SUFFICIENT DOWNWARD FORCE ON THE DECK AND SIDEWALK PANELS DURING PLACEMENT OF THE NEW CONNECTION BRACKETS TO PROVIDE FULL CONTACT BETWEEN THE DECK PANELS AND THE SPREADER BEAMS AND FLOOR BEAMS.
- 4. THE CONTRACTOR MAY USE AN AREA OF THE GRAVEL SURFACE PARKING LOT IMMEDIATELY NORTHWEST OF THE NORTH END OF THE STRUCTURE FOR EQUIPMENT, MATERIAL STORAGE, AND EMPLOYEE PARKING. THE AREA USED SHALL NOT EXCEED 60 FEET IN LENGTH ALONG THE PAVED ROADWAY BY APPROXIMATELY 25 FEET. THE USE OF ANY TRAILS OR GRASS AREAS FOR THESE PURPOSES IS STRICTLY FORBIDDEN. THE CONTRACTOR SHALL NOT BLOCK THE USE OF ANY TRAIL WITHIN THE PARK, EXCEPT FOR ONE SIDEWALK AT A TIME ON THE STRUCTURE.
- 5. THE CONTRACTOR SHALL FIELD VERIFY ALL EXISTING AND PROPOSED DIMENSIONS PRIOR TO FABRICATION AND INSTALLATION OF PROPOSED WORK.
- 6. MEASURES SHALL BE TAKEN TO PREVENT DEBRIS FROM FALLING FROM THE STRUCTURE. IF DEBRIS FALLS INTO THE WATERWAY, IT SHALL BE REMOVED WITHIN 24 HOURS. SINCE DISTURBANCE OF THE WATERWAY BOTTOM MAY BE AS HARMFUL AS THE DEBRIS ITSELF, THE PREVENTIVE MEASURES MUST BE EFFECTIVE.

LEGEND TRAFFIC CONTROL NOTES:



PLACE THREE (3) TYPE III BARRICADES ON GALLUP PARK ROAD WITH ONE (1) "BRIDGE CLOSED" (R11-2) SIGN AND ONE (1) "TRAIL OPEN" (SF-3) SIGN ON SEPARATE SUPPORTS, AT EACH END OF THE STRUCTURE, AS NOTED ON PLAN. PLACE PROTECTIVE FENCING AROUND PROJECT SITE. ONE SIDEWALK ACROSS STRUCTURE SHALL REMAIN OPEN AT ALL TIMES IN ACCORDANCE WITH THE DETAILED SPECIFICATION FOR MAINTENANCE OF TRAFFIC AND CONSTRUCTION SEQUENCING.



PLACE "BRIDGE CLOSED" (R11-2) SIGN AND "TRAIL CLOSED - 1 MILE AHEAD" (SF-1) SIGN WHEN THE STRUCTURE AT MITCHELL FIELD IS CLOSED FOR CONSTRUCTION.

ESTIMATED QUANTITIES OF TRAFFIC CONTROL DEVICES FOR GALLUP PARK:

PAY ITEM	UNIT	QUANTITY
BARRICADE, TYPE III, HIGH INTENSITY, LIGHTED, FURN	EACH	6
BARRICADE, TYPE III, HIGH INTENSITY, LIGHTED, OPER	EACH	6
SIGN, TYPE B, TEMP, PRISMATIC, FURN	SFT	30
SIGN, TYPE B, TEMP, PRISMATIC, OPER	SFT	30
SIGN, TYPE B, TEMP, PRISMATIC, SPECIAL, FURN	SFT	24
SIGN, TYPE B, TEMP, PRISMATIC, SPECIAL, OPER	SFT	24
FENCE, PROTECTIVE	FT	400




THE CITY OF ANN ARBOR - PARKS AND RECREATION SERVICES


2019 PARK BRIDGE REPAIRS AND RENOVATIONS


GALLUP PARK VEHICLE STRUCTURE
GENERAL PLAN OF SITE


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SHEET NO. <u>20</u> OF <u>22</u>



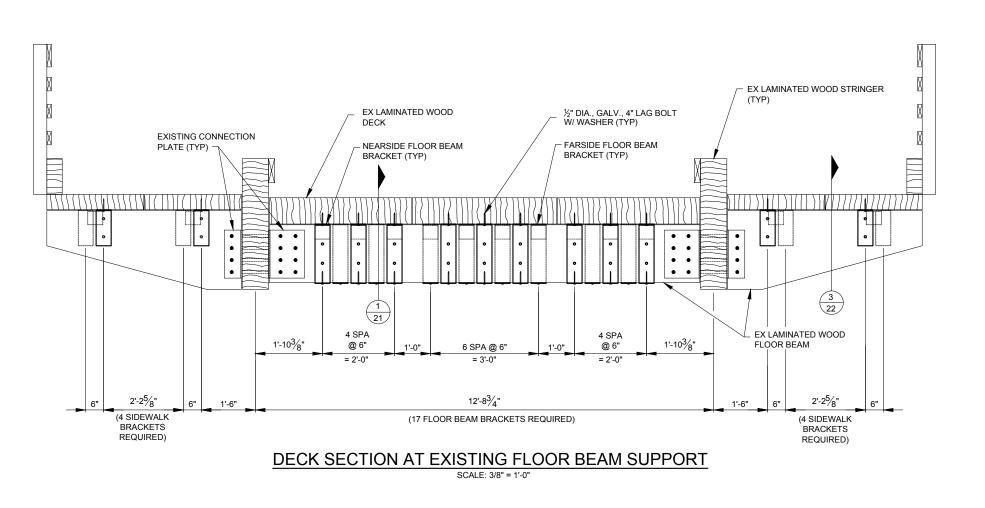

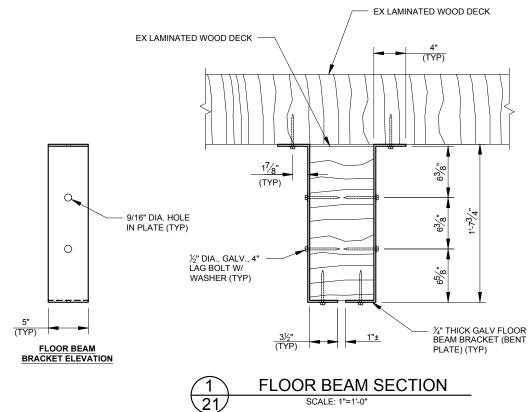

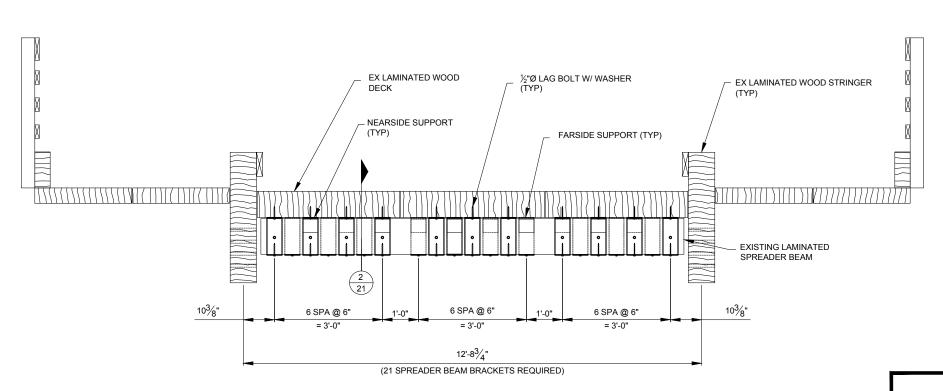

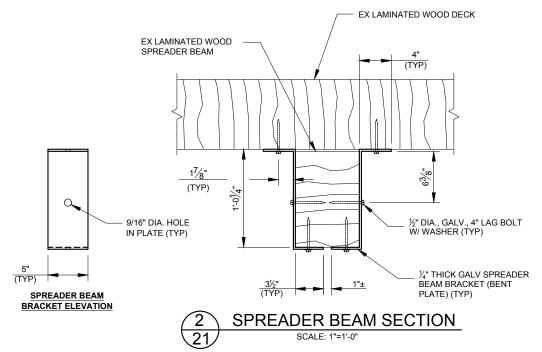ORIGINAL ISSUE

10/01/19

DATE

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DECK SECTION AT EXISTING SPREADER BEAM SUPPORT

SCALE: 3/8" = 1'-0"

THE CITY OF ANN ARBOR - PARKS AND RECREATION SERVICES


2019 PARK BRIDGE REPAIRS AND RENOVATIONS


GALLUP PARK VEHICLE STRUCTURE SUPERSTRUCTURE DETAILS

SCALE
AS SHOWN

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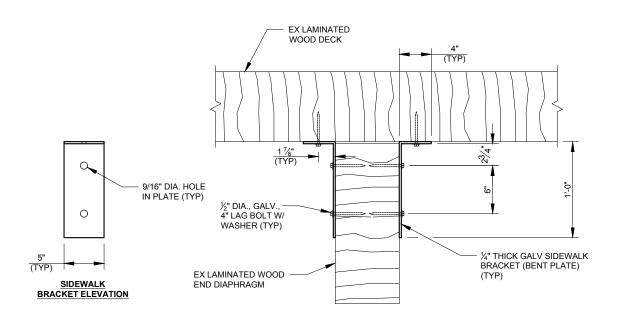
SHEET NO. 21 OF 22



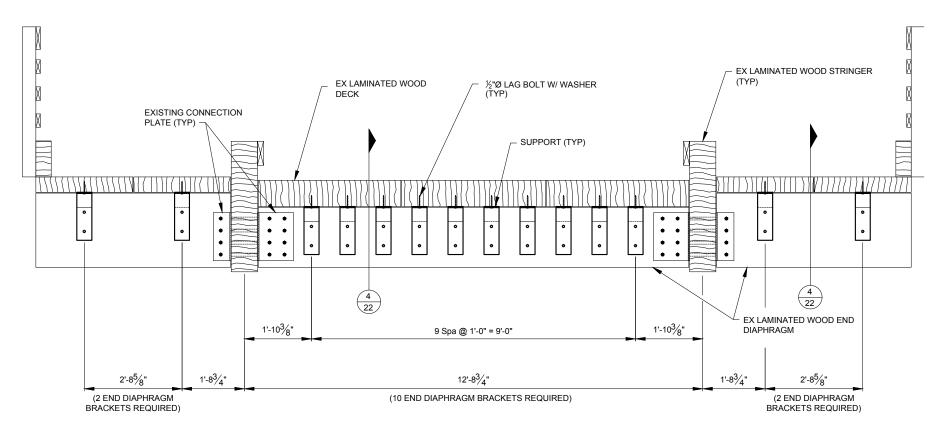

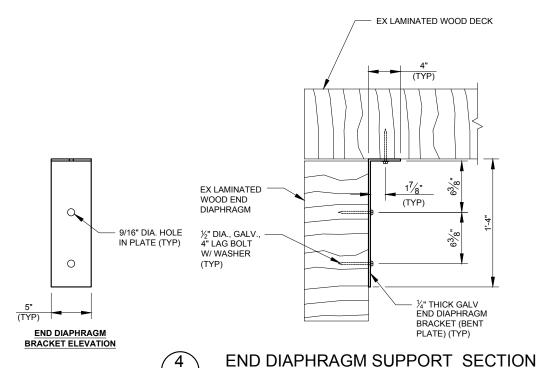DECK SECTION AT EXISTING END DIAPHRAGM SUPPORT

SCALE: 3/8" = 1'-0"



3 SIDEWALK BEAM SUPPORT SECTION
SCALE: 1"=1'-0"

ORIGINAL ISSUE 10/01/19 DAF CLH
REV. NO. DESCRIPTION DATE DR.BY CH.BY

THE CITY OF ANN ARBOR - PARKS AND RECREATION SERVICES

2019 PARK BRIDGE REPAIRS AND RENOVATIONS

GALLUP PARK VEHICLE STRUCTURE SUPERSTRUCTURE DETAILS

SCALE
AS SHOWN

DRAWING NO.

SHEET NO. 22 OF 22