#### ANN ARBOR HISTORIC DISTRICT COMMISSION

#### Staff Report

**ADDRESS:** 603 West Washington Street, Application Number HDC19-133

**DISTRICT:** Old West Side Historic District

**REPORT DATE:** August 15, 2019

**REPORT PREPARED BY:** Jill Thacher, Historic Preservation Coordinator

**REVIEW COMMITTEE DATE:** Monday, August 12, 2019

OWNER APPLICANT

Name:Andy BlylerForward DesignAddress:603 W Washington St6087 Jackson Rd

Ann Arbor, MI 48103 Ann Arbor, MI 48103

**Phone:** (717) 443-7708 (734) 761-8403

**BACKGROUND:** This 1 ¾ story gable-fronter features a cut stone foundation and a half-width pedimented front porch. Its first occupant was William Murray of Murray and Storms attorneys in 1904. Mr.Murray was married to Julia Allmendinger. Two years earlier, the Murrays were the first occupants of the house next door at 601, which is a similar design; and in 1910 they built the much grander tudor at 711 W Washington, next door to the Allmendinger house at 719.

**LOCATION:** The property is located on the south side of West Washington, between Murray Avenue and 3<sup>rd</sup> Street.

**APPLICATION:** The applicant seeks HDC approval to construct a two-story rear addition and add a skylight near the rear of the historic home's roof.

#### **APPLICABLE REGULATIONS:**

#### From the Secretary of the Interior's Standards for Rehabilitation:

- (2) The historic character of a property will be retained and preserved. The removal of distinctive materials or alteration of features, spaces, and spatial relationships that characterize a property will be avoided.
- (9) New additions, exterior alterations, or related new construction shall not destroy historic materials that characterize the property. The new work shall be differentiated from the old and shall be compatible with the massing, size, scale, and architectural features to protect the historic integrity of the property and its environment.

(10) New additions and adjacent or related new construction shall be undertaken in such a manner that if removed in the future, the essential form and integrity of the historic property and its environment would be unimpaired.

### From the Secretary of the Interior's Guidelines for Rehabilitating Historic Buildings (other SOI Guidelines may also apply):

#### **New Additions**

<u>Recommended</u>: Constructing a new addition so that there is the least possible loss of historic materials and so that character-defining features are not obscured, damaged, or destroyed.

Designing new additions in a manner that makes clear what is historic and what is new.

Locating the attached exterior addition at the rear or on an in-conspicuous side of a historic building; and limiting its size and scale in relationship to the historic building.

Considering the attached exterior addition both in terms of the new use and the appearance of other buildings in the historic district or neighborhood. Design for the new work may be contemporary or may reference design motifs from the historic building. In either case, it should always be clearly differentiated from the historic building and be compatible in terms of mass, materials, relationship of solids to voids, and color.

*Not Recommended:* Attaching a new addition so that the character-defining features of the historic building are obscured, damaged, or destroyed.

Designing a new addition so that its size and scale in relation to the historic building are out of proportion, thus diminishing the historic character.

#### **District or Neighborhood Setting**

<u>Not Recommended:</u> Introducing new construction into historic districts that is visually incompatible or that destroys historic relationships within the setting.

#### From the City of Ann Arbor Design Guidelines:

#### **Guidelines for All Additions**

<u>Appropriate:</u> Limiting the size and scale of the addition in relationship to the historic building so that it does not diminish or visually overpower the building or the district. The addition should exceed neither half of the original building's footprint nor half of the original building's total floor area.

#### **STAFF FINDINGS:**

1. The proposed addition has a footprint of 13'5" x 18'6". The side walls are inset by 8 3/4" on the east and 10" on the west. The roof ridge of the addition is 6 1/4" below the current ridge. The west elevation features a low shed dormer with an awning window, the rear has an inset back porch with simple stairs and guardrails, and the east elevation has no

openings. Cladding is hardie board lap siding with 4" exposure, and trim is boral. Windows are clad wood, and the back door is fiberglass. A large rear deck, small backdoor porch roof, rear door, and three windows would be replaced by the addition.

- 2. A low-profile Velux skylight is proposed on the historic house near the back of the west roof plane.
- 3. Most of this lot is in the floodway, and Allen Creek runs unground just to the south. The addition must be elevated to be a foot above the base flood elevation, with adequate flow-through for stormwater. The addition is therefore built on concrete pier footings, and the addition's sill is 2'9" above grade. The space beneath the addition is open.
- 4. The addition has a 204 square foot footprint, which is a 30% increase over the existing 681 square feet. The current floor area is 1236 square feet (all pre-1945) and the addition would add 369 square feet, or 30%.
- 5. The design, materials, and massing of the addition are all appropriate and compatible with the historic home. The work does not destroy historic materials features, spaces, or spatial relationships that characterize the property. It is differentiated adequately while remaining complementary to the historic house and district.

#### **MOTION**

(Note that the motion is only a suggestion. The Review Committee, consisting of staff and at least two Commissioners, will meet with the applicant on site and then make a report of their findings at the meeting.)

I move that the Commission issue a certificate of appropriateness for the application at 603 West Washington Street, a contributing property in the Old West Side Historic District, to construct a rear two-story addition and skylight, as proposed. The work is compatible in exterior design, arrangement, materials, and relationship to the house and the surrounding area and meets the *City of Ann Arbor Historic District Design Guidelines* for All Additions, and *The Secretary of the Interior's Standards for Rehabilitation* and *Guidelines for Rehabilitating Historic Buildings*, in particular standards 2, 9 and 10 and the guidelines for District or Neighborhood Setting and New Additions.

#### **MOTION WORKSHEET**

I move that the Commission issue a Certificate of Appropriateness for the work at 603 West Washington Street\_in the Old West Side Historic District

\_\_\_\_\_ Provided the following condition(S) is (ARE) met: 1) STATE CONDITION(s)

The work is generally compatible with the size, scale, massing, and materials and meets the Secretary of the Interior's Standards for Rehabilitation, standard(S) number(S) (circle all that apply): 1, 2, 3, 4, 5, 6, 7, 8, 9, 10

ATTACHMENTS: application, photos, drawings, materials details

#### 603 W Washington Street (2008 Survey Photos)





#### HISTORIC DISTRICT COMMISSION

#### PLANNING AND DEVELOPMENT SERVICES

City Hall: 301 E. Huron St. Ann Arbor, MI 48104-6120
Mailing: P.O. Box 8647, Ann Arbor, MI 48107-8647

Phone: 734.794.6265 ext. 42608 ithacher

Fax: 734.994.8460

jthacher@a2gov.org

## Permit Number HDC#\_19-133 BLDG# GIT PAYESTAMP ARBOR RECEIVED JUL 2 3 2019 PLANNING AND PLANNING AND PLANNING AND PLANNING AND

#### APPLICATION MUST BE FILLED OUT COMPLETELY

DEVEL	OPMENT SERVICES
PROPERTY LOCATION/OWNER INFORMATION	
NAME OF PROPERTY OWNER BLYLER HISTORIC DISTRICT	
PROBERTY ADDRESS	CITY
ZIPCODE DAYTIME PHONE NUMBER EMAIL ADDRESS	ANN ARBOR
48/03 17171443-7708 ANDRE BLYLER. CC	
PROPERTY OWNER'S ADDRESS (IF DIFFERENT FROM ABOVÉ)	STATE, ZIP
PROPERTY OWNER'S SIGNATURE	and the second differences the second
SIGN HERE Andrew J Blyler PRINT NAME Andrew J Blyler	DATE 7/23/2019
APPLICANT INPORTMATION:55A4403.	
NAME OF APPLICANT (IF DIFFERENT FROM ABOVE) FORWARD DESIGN	
GO87 JACKSON RD.	ANN ARBOR
STATE ZIPCODE 48103 PHONE/CELL# 761-8403 17	34,761-8419
EMAIL ADDRESS	
APPLICANT'S SIGNATURE HIS DIFFERENT FOR PROPERTY OWNER)	
SIGN HERE X JEF FORWAND	DATE 7 19 19
BUILDING USE - CHECK ALL THAT APPLY	
DI SINGLE FAMILY D DUPLEX D RENTAL D MULTIPLE FAMILY D COMMERCIAL	I INSTITUTIONAL
PROPOSED WORK	
Describe in detail each proposed exterior alteration, improvement and/or repair (use additional paper, if necessar	y).
0 (5-0) 0 0 0	
2-STORY REAR ADDITION	
DESCRIBE CONDITIONS THAT JUSTIFY THE PROPOSED CHANGES:	and a second
SINGLE FAMILY OCCUPANCY - GROV	NING
FAMILY.	
For Further Assistance With Required Attachments, please visit www.aZgov.ose/hdc	



#### HISTORIC DISTRICT COMMISSION APPLICATION

FEE CHART	
DESCRIPTION	
STAFF REVIEW FEES	FEE
Application for Staff Approval	\$35.00
Work started without approvals	Additional \$50.00
HISTORIC DISTRICT COMMISSION FEES	
All other proposed work not listed below	\$100.00
Work started without approvals	Additional \$250,00
RESIDENTIAL - Single and 2-story Structure	
Addition: single story	\$300.00
Addition: taller than single story	\$550.00 💥
New Structure - Accessory	\$100.00
New Structure — Principal	\$850.00
Replacement of single and 2-family window(s)	\$100 + \$25/window
COMMERCIAL – includes multi-family (3 or i structures	more unit)
Additions	\$700.00
Replacement of multi-family and commercial window (s)	\$100 + \$50/window
Replacement of commercial storefront	\$250.00
DEMOLITION and RELOCATION	
Demolition of a contributing structure	\$1000.0
Demolition of a non-contributing structure	\$250.00
Relocation of a contributing structure	\$750.00
Relocation of a non-contributing structure	\$250.00

#### FOR COMMISSION REVIEWS:

- Application withdrawals made before public notice is published will qualify for a 50% refund of the application fee.
- Application withdrawals made after public notice is sent but before the public hearing will qualify for a 25% refund of the application fee.

#### INSTRUCTIONS FOR SUBMITTING APPLICATIONS

All HDC applications must be signed by the property owner and the applicant, if different, with the exception of staff approvals, which may be signed by only the applicant.

All completed HDC applications and their attachments may be submitted to Planning and Development Services by mail, in person (paper or digital), faxed, or via email to building@a2gov.org.


We accept CASH, CHECK, and all major credit cards. Checks should be made payable to "City of Ann Arbor"

HDC applications that are incomplete or not submitted with the required documentation or payment will not be processed or approved.

#### **APPLICATION EXPIRATION**

HDC applications expire three (3) years after the date of approval.

#### OFFICE USE ONLY Date of Hearing: ☐ HDC COA ☐ HDC Denial Action ☐ HDC NTP □ Staff COA Staff Signature Comments Fee: 乜 Check: # Payment Type Cash **Credit Card**

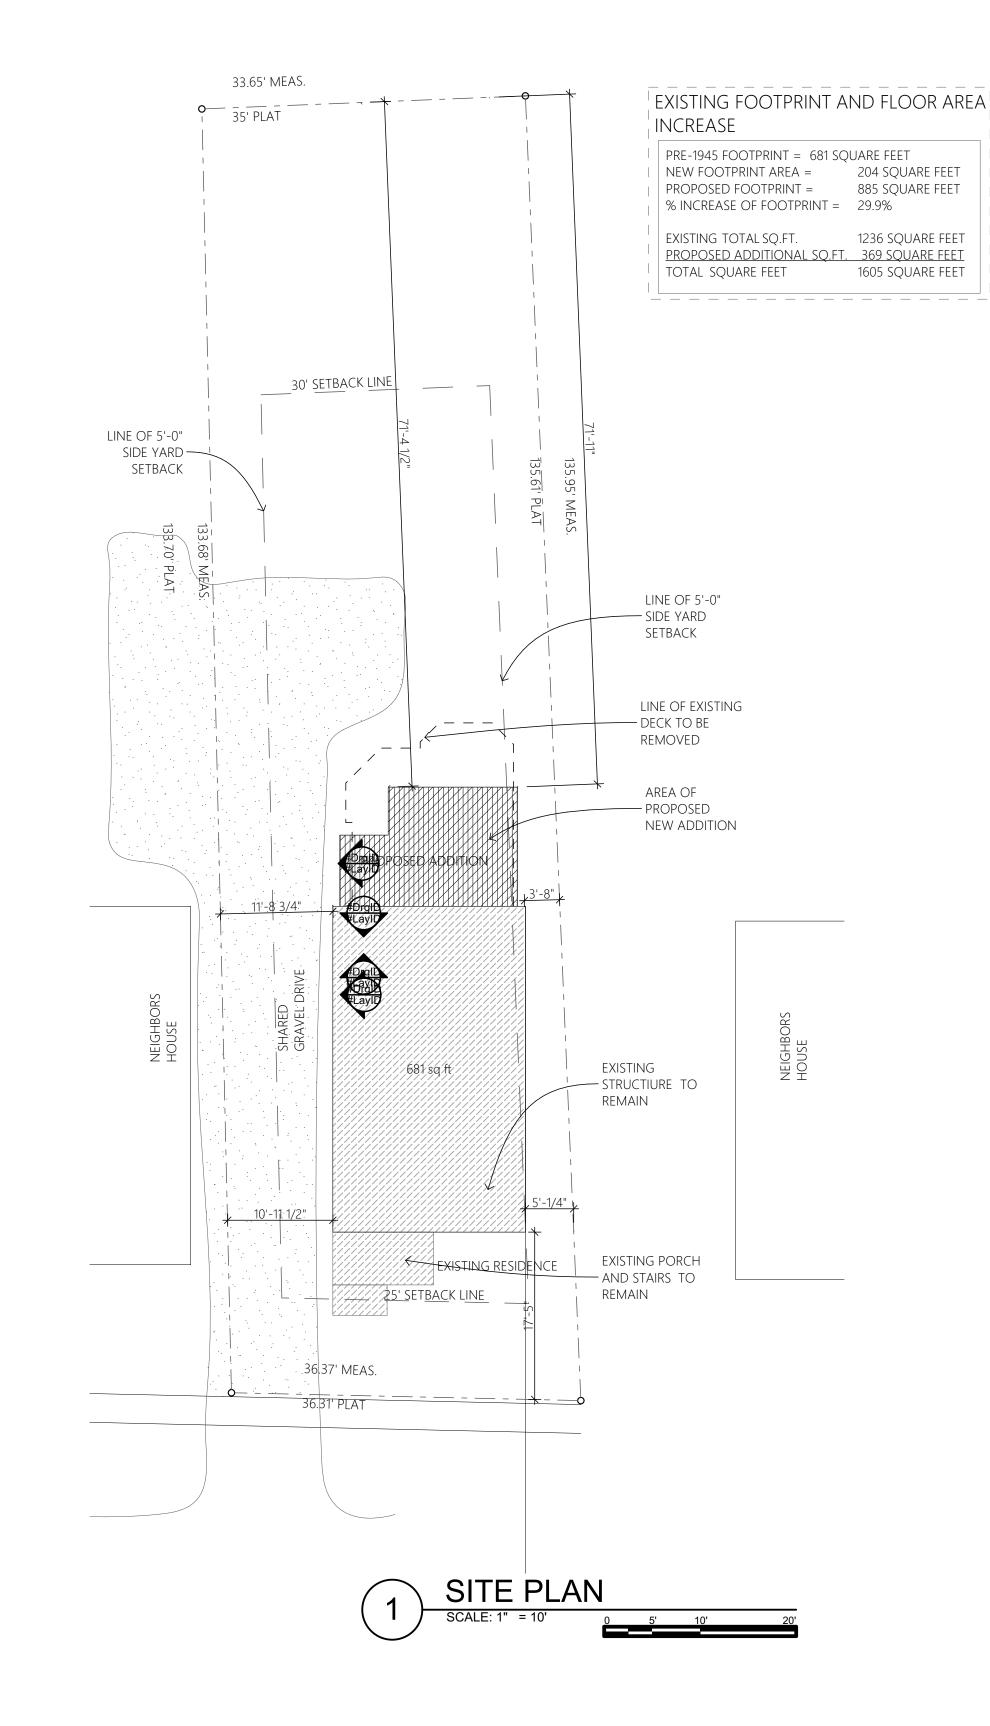



CONSTRUCTION DOCUMENTS

REAR ADDITION
Alex and Andy Blyler
603 WEST WASHINGTON
Ann Arbor, MI 48103

	SHEET INDEX
ID	Name
A000	COVER SHEET/ SITE PLAN
SP1	SCOPE
SP2	SCOPE
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A101	DEMO FIRST FLOOR PLAN
A102	DEMO SECOND FLOOR PLAN
A103	NEW FOUNDATION PLAN
A104	NEW FIRST FLOOR PLAN
A105	NEW SECOND FLOOR PLAN
A106	NEW ROOF PLAN
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A501	DETAILS
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A900	3D VIEWS
S100	STRUCTURAL PLAN
S101	STRUCTURAL PLAN
ME100	FOUNDATION ELECTRICAL PLAN
ME101	FIRST FLOOR ELECTRICAL PLAN
ME102	SECOND FLOOR ELECTRICAL PLAN

8/7/2019

SHEET TITLE

COVER SHEET/ SITE PLAN

## **EAST ELEVATION**





## REAR (SOUTH) ELEVATION





## **WEST ELEVATION**






## **NORTH ELEVATION**







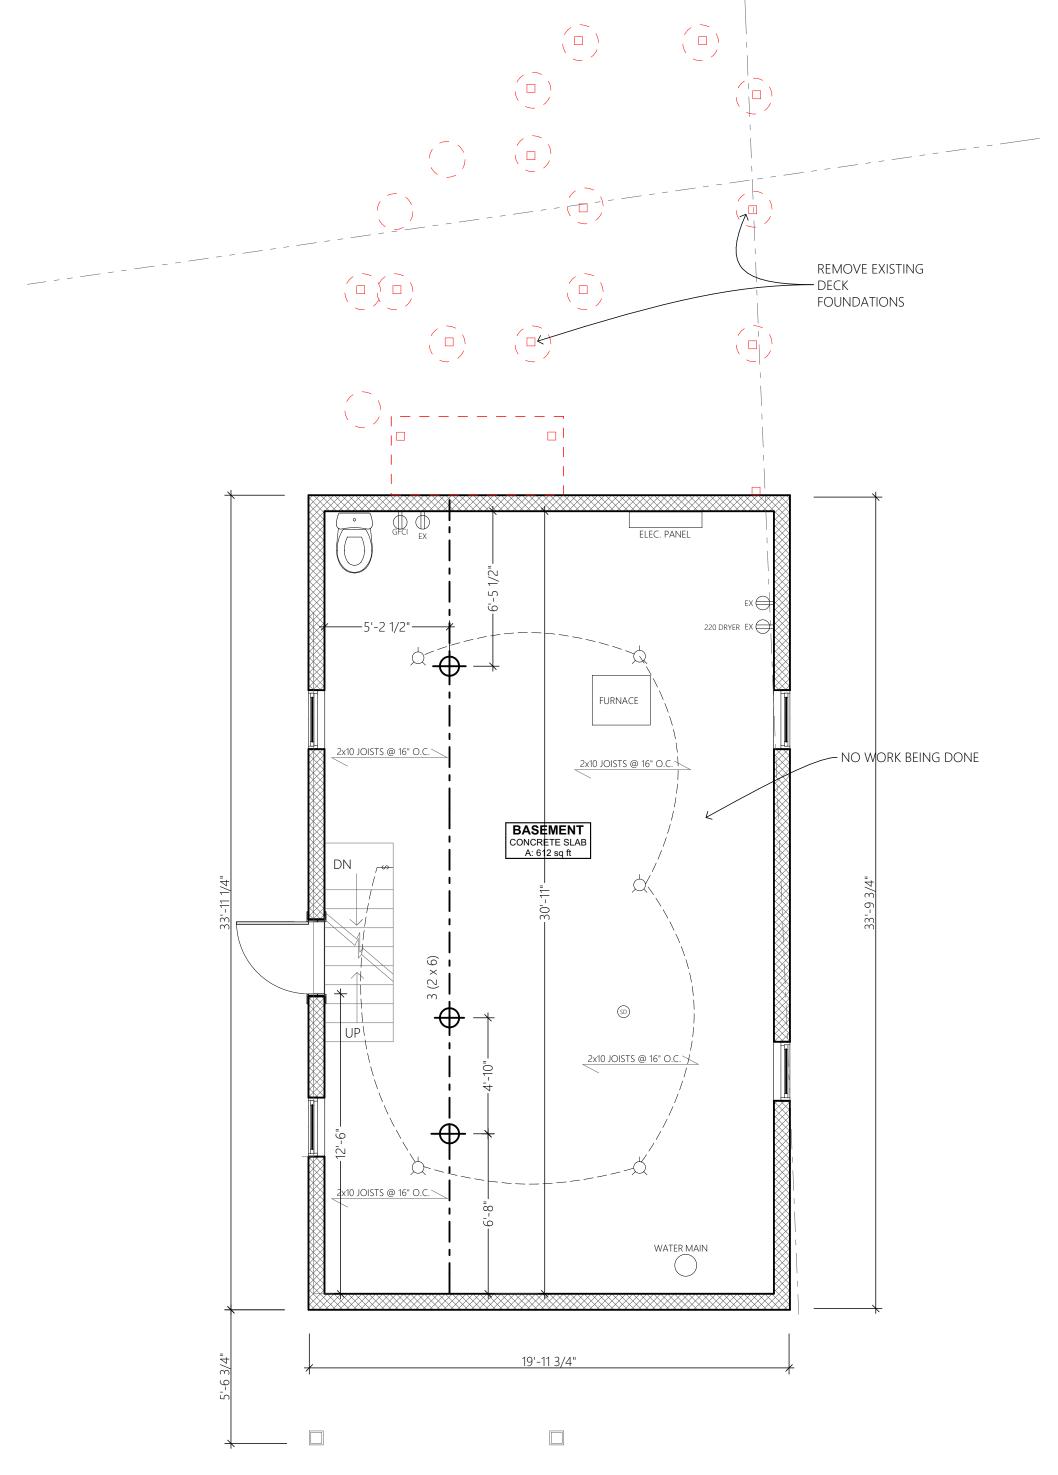







CONSTRUCTION DOCUMENTS


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Ann Arbor, MI 48103

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ME102	SECOND FLOOR ELECTRICAL PLAN

7/19/2019

SHEET TITLE

DEMO FOUNDATION PLAN

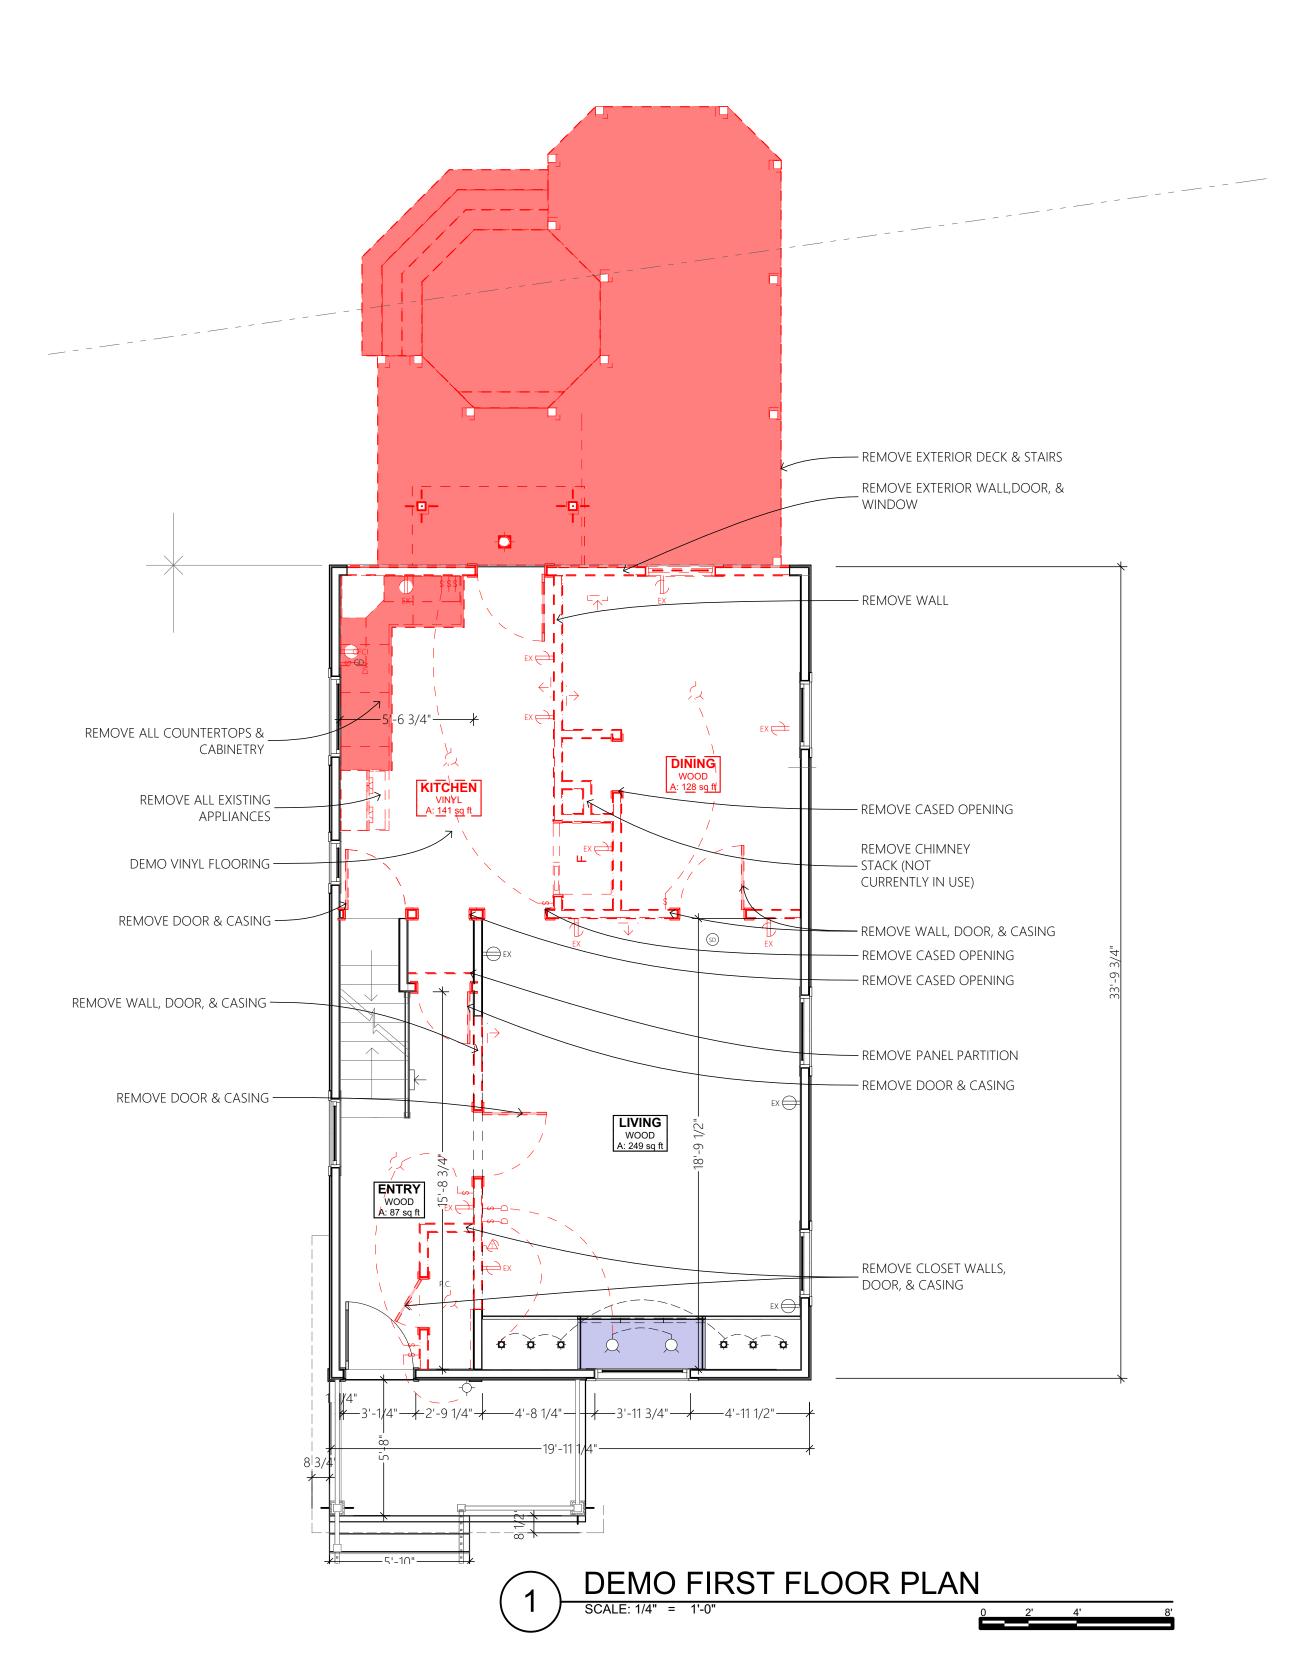



CONSTRUCTION DOCUMENTS


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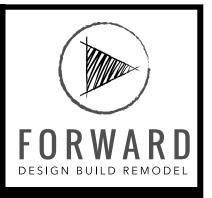
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SHEET TITLE

DEMO FIRST FLOOR
PLAN





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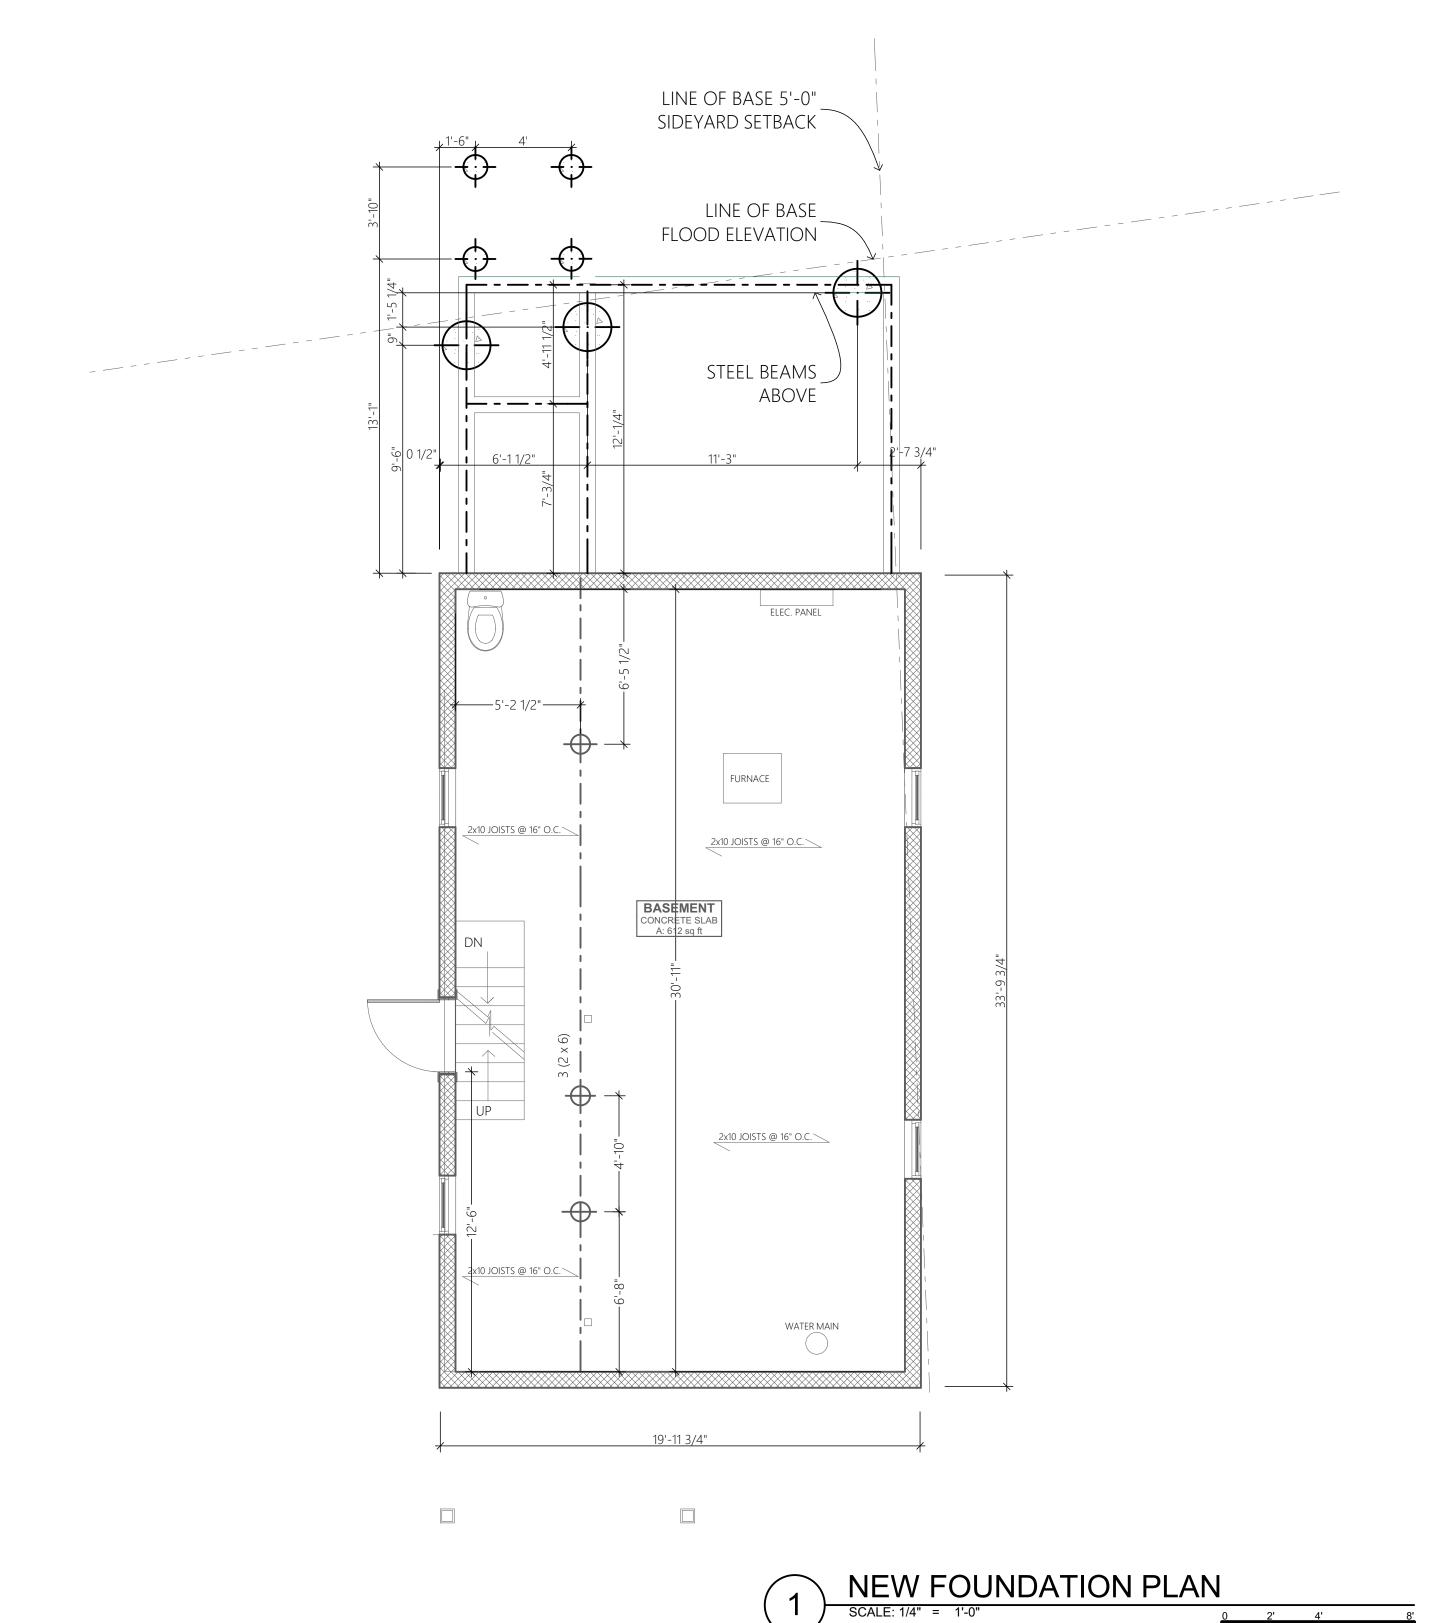
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SHEET TITLE

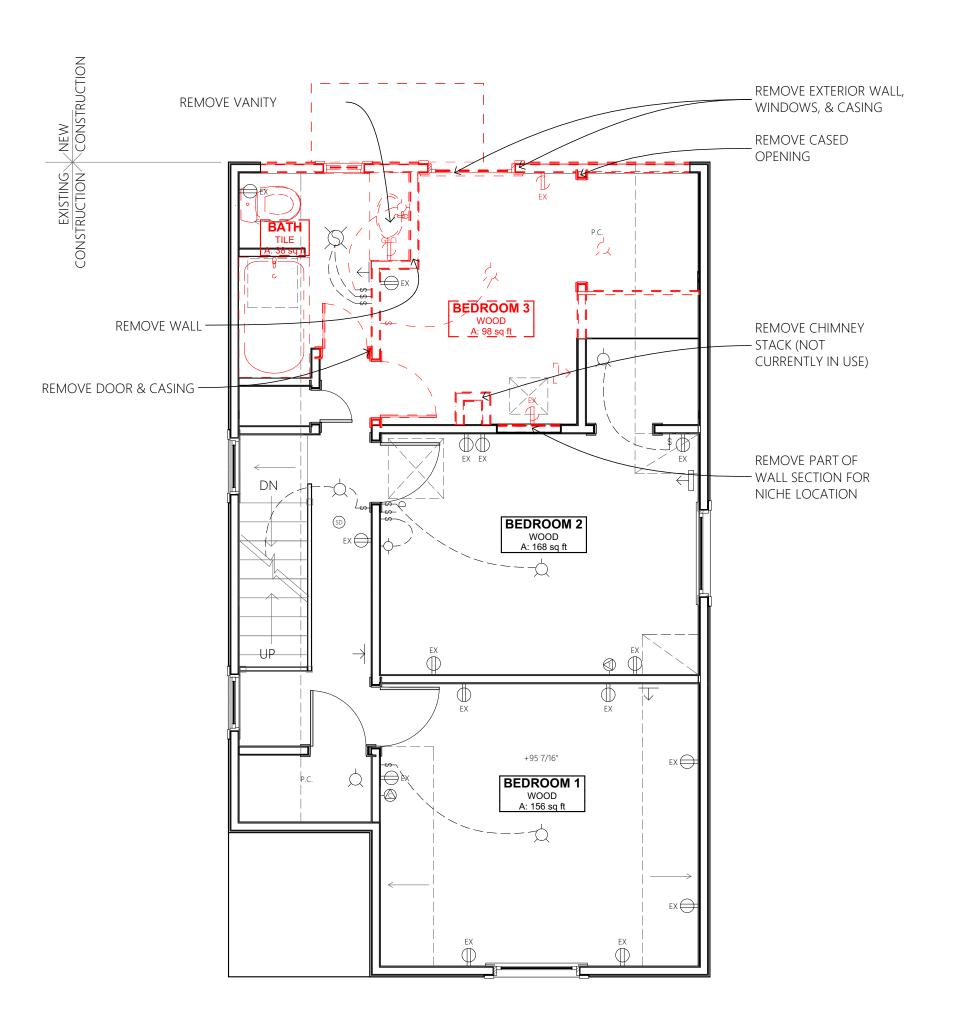DEMO SECOND FLOOR PLAN







CONSTRUCTION DOCUMENTS


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<b>4101</b>	DEMO FIRST FLOOR PLAN
<b>4102</b>	DEMO SECOND FLOOR PLAN
<b>A</b> 103	NEW FOUNDATION PLAN
<b>4104</b>	NEW FIRST FLOOR PLAN
<b>A</b> 105	NEW SECOND FLOOR PLAN
<b>4106</b>	NEW ROOF PLAN
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A201	LEFT ELEVATION
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<b>A</b> 301	BUILDING SECTIONS
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4401	INTERIOR ELEVATIONS
<b>4500</b>	DETAILS
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5100	STRUCTURAL PLAN
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NEW FOUNDATION PLAN





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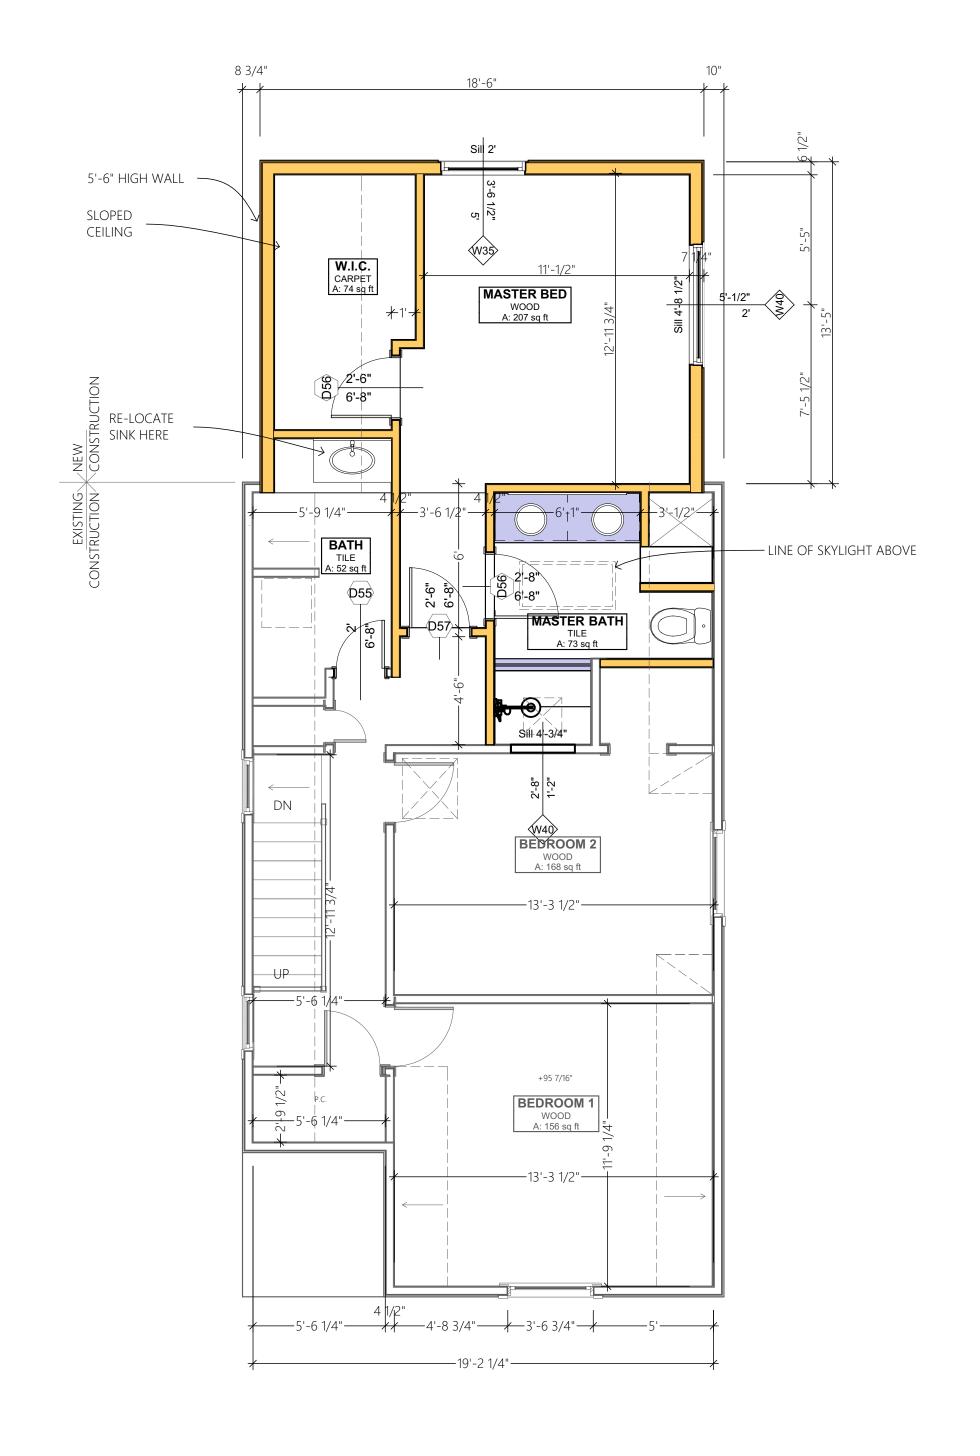
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SHEET TITLE

NEW FIRST FLOOR PLAN

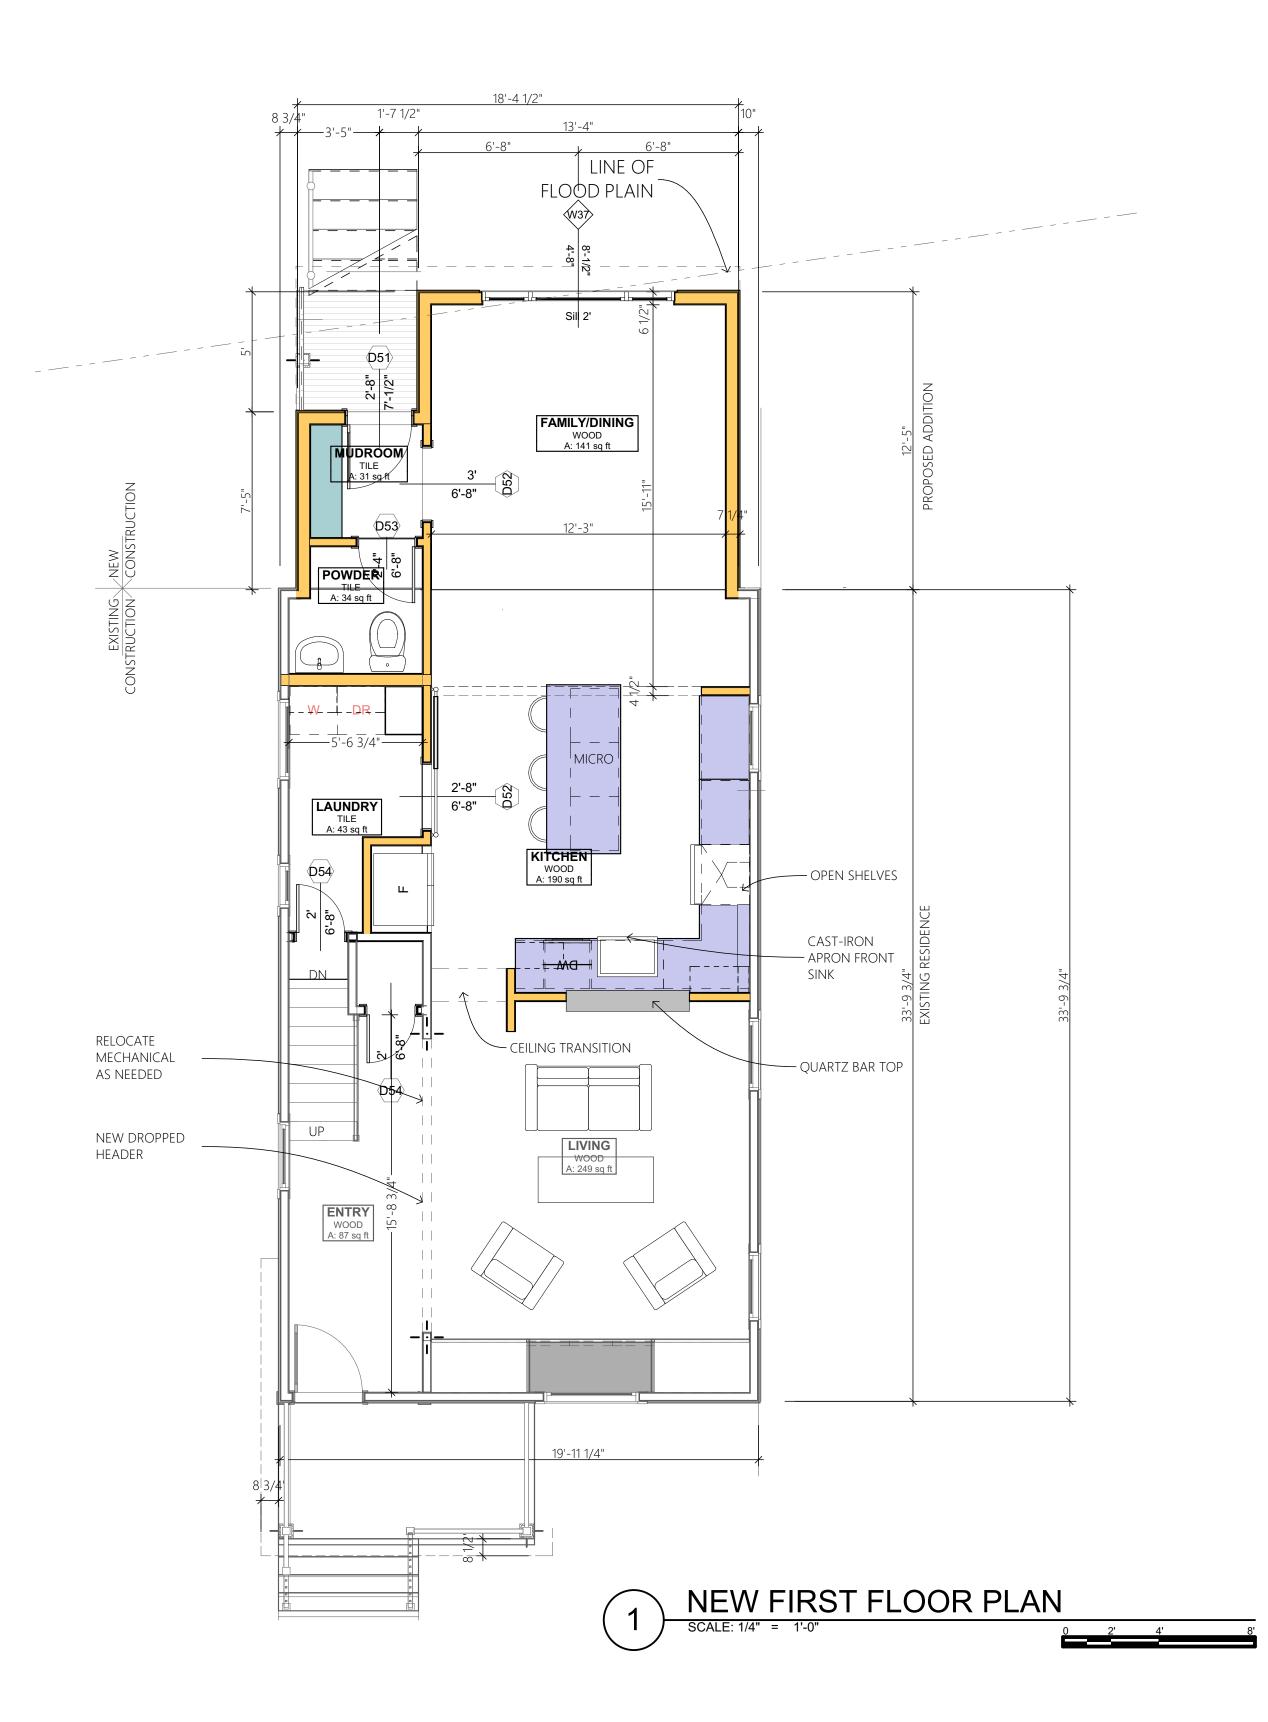







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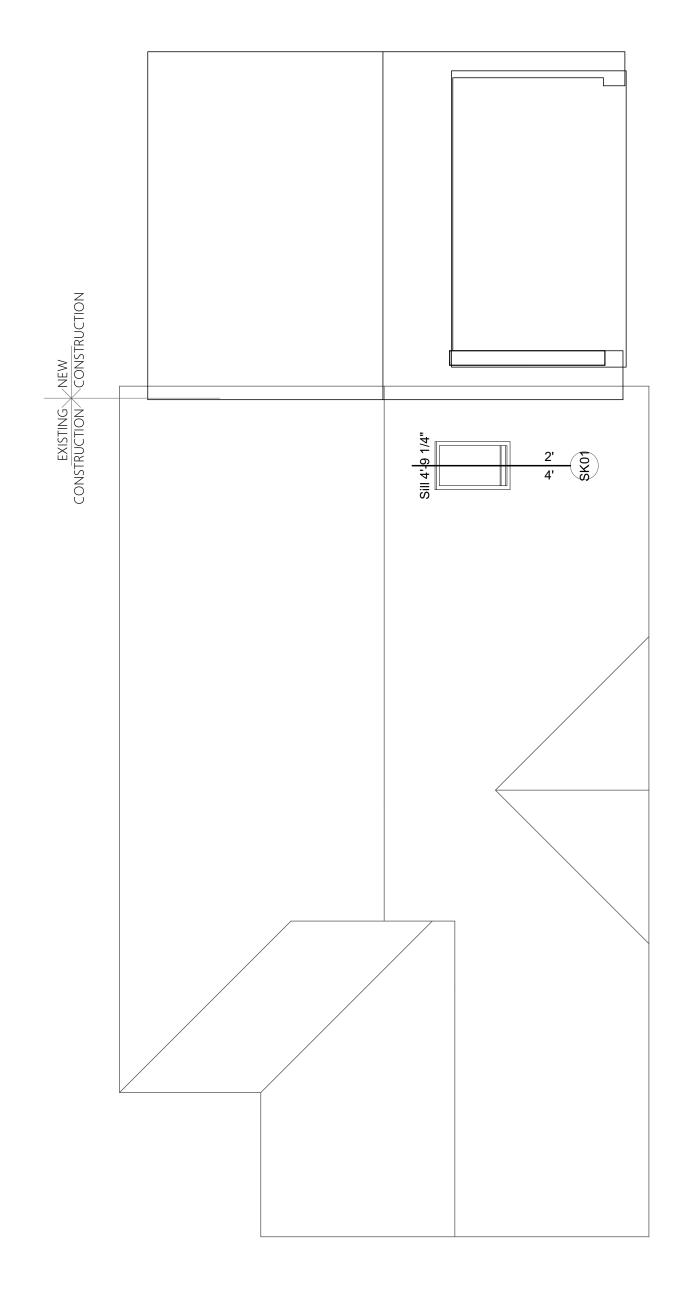
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SHEET TITLE

NEW SECOND FLOOR PLAN





CONSTRUCTION **DOCUMENTS** 


Alex and Andy Blyler 603 WEST WASHINGTON Ann Arbor, MI 48103 REAR ADDITION


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SHEET TITLE

NEW ROOF PLAN



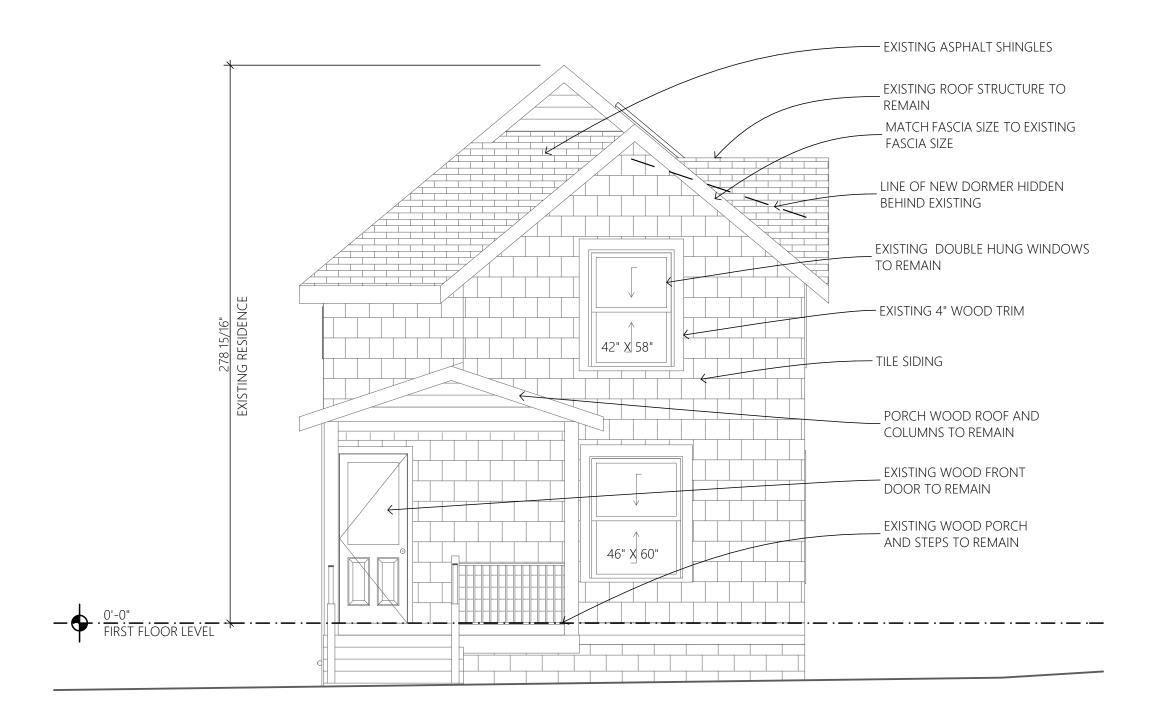

EXISTING FRONT ELEVATION

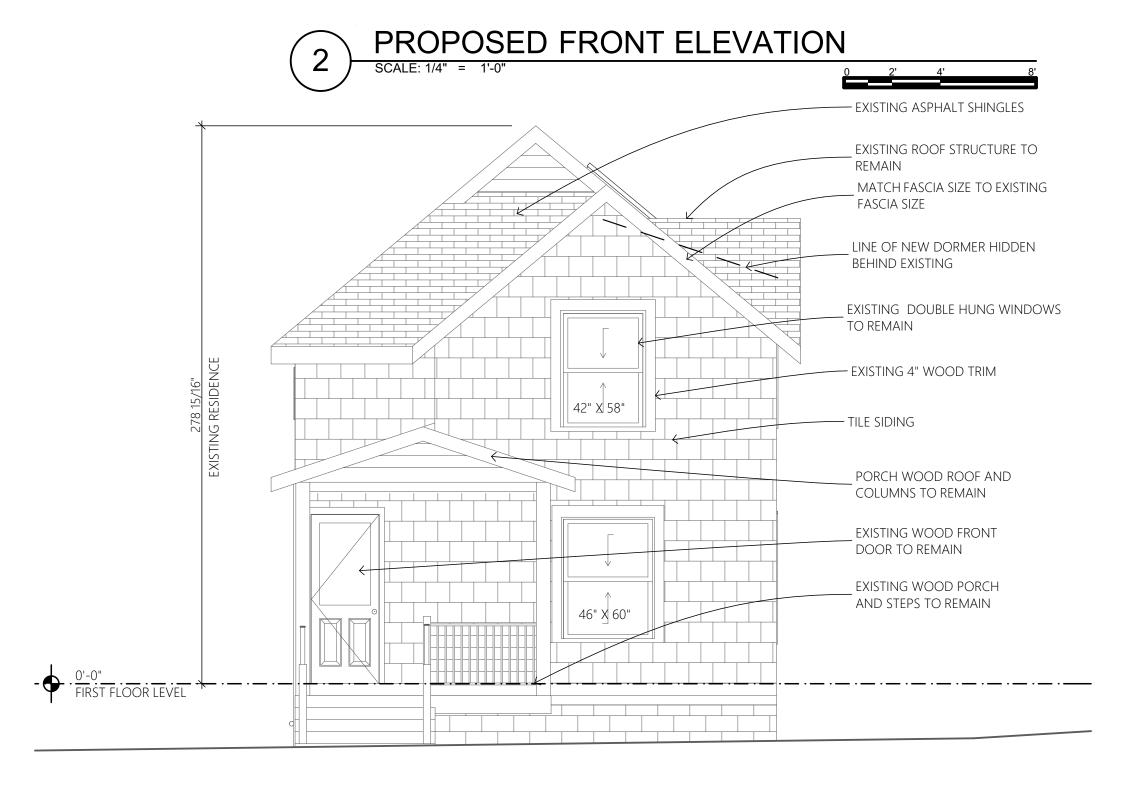SCALE: 1/4" = 1'-0"



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### CONSTRUCTION DOCUMENTS


# REAR ADDITION Alex and Andy Blyler 603 WEST WASHINGTON Ann Arbor, MI 48103


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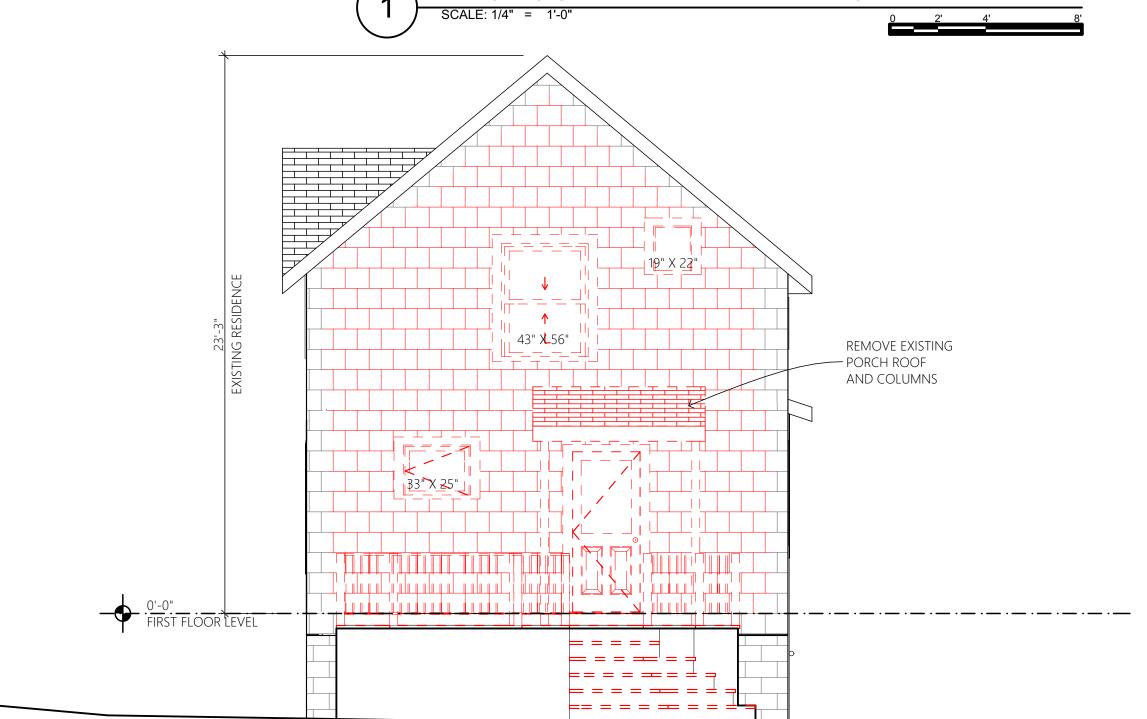
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SHEET TITLE

FRONT ELEVATIONS





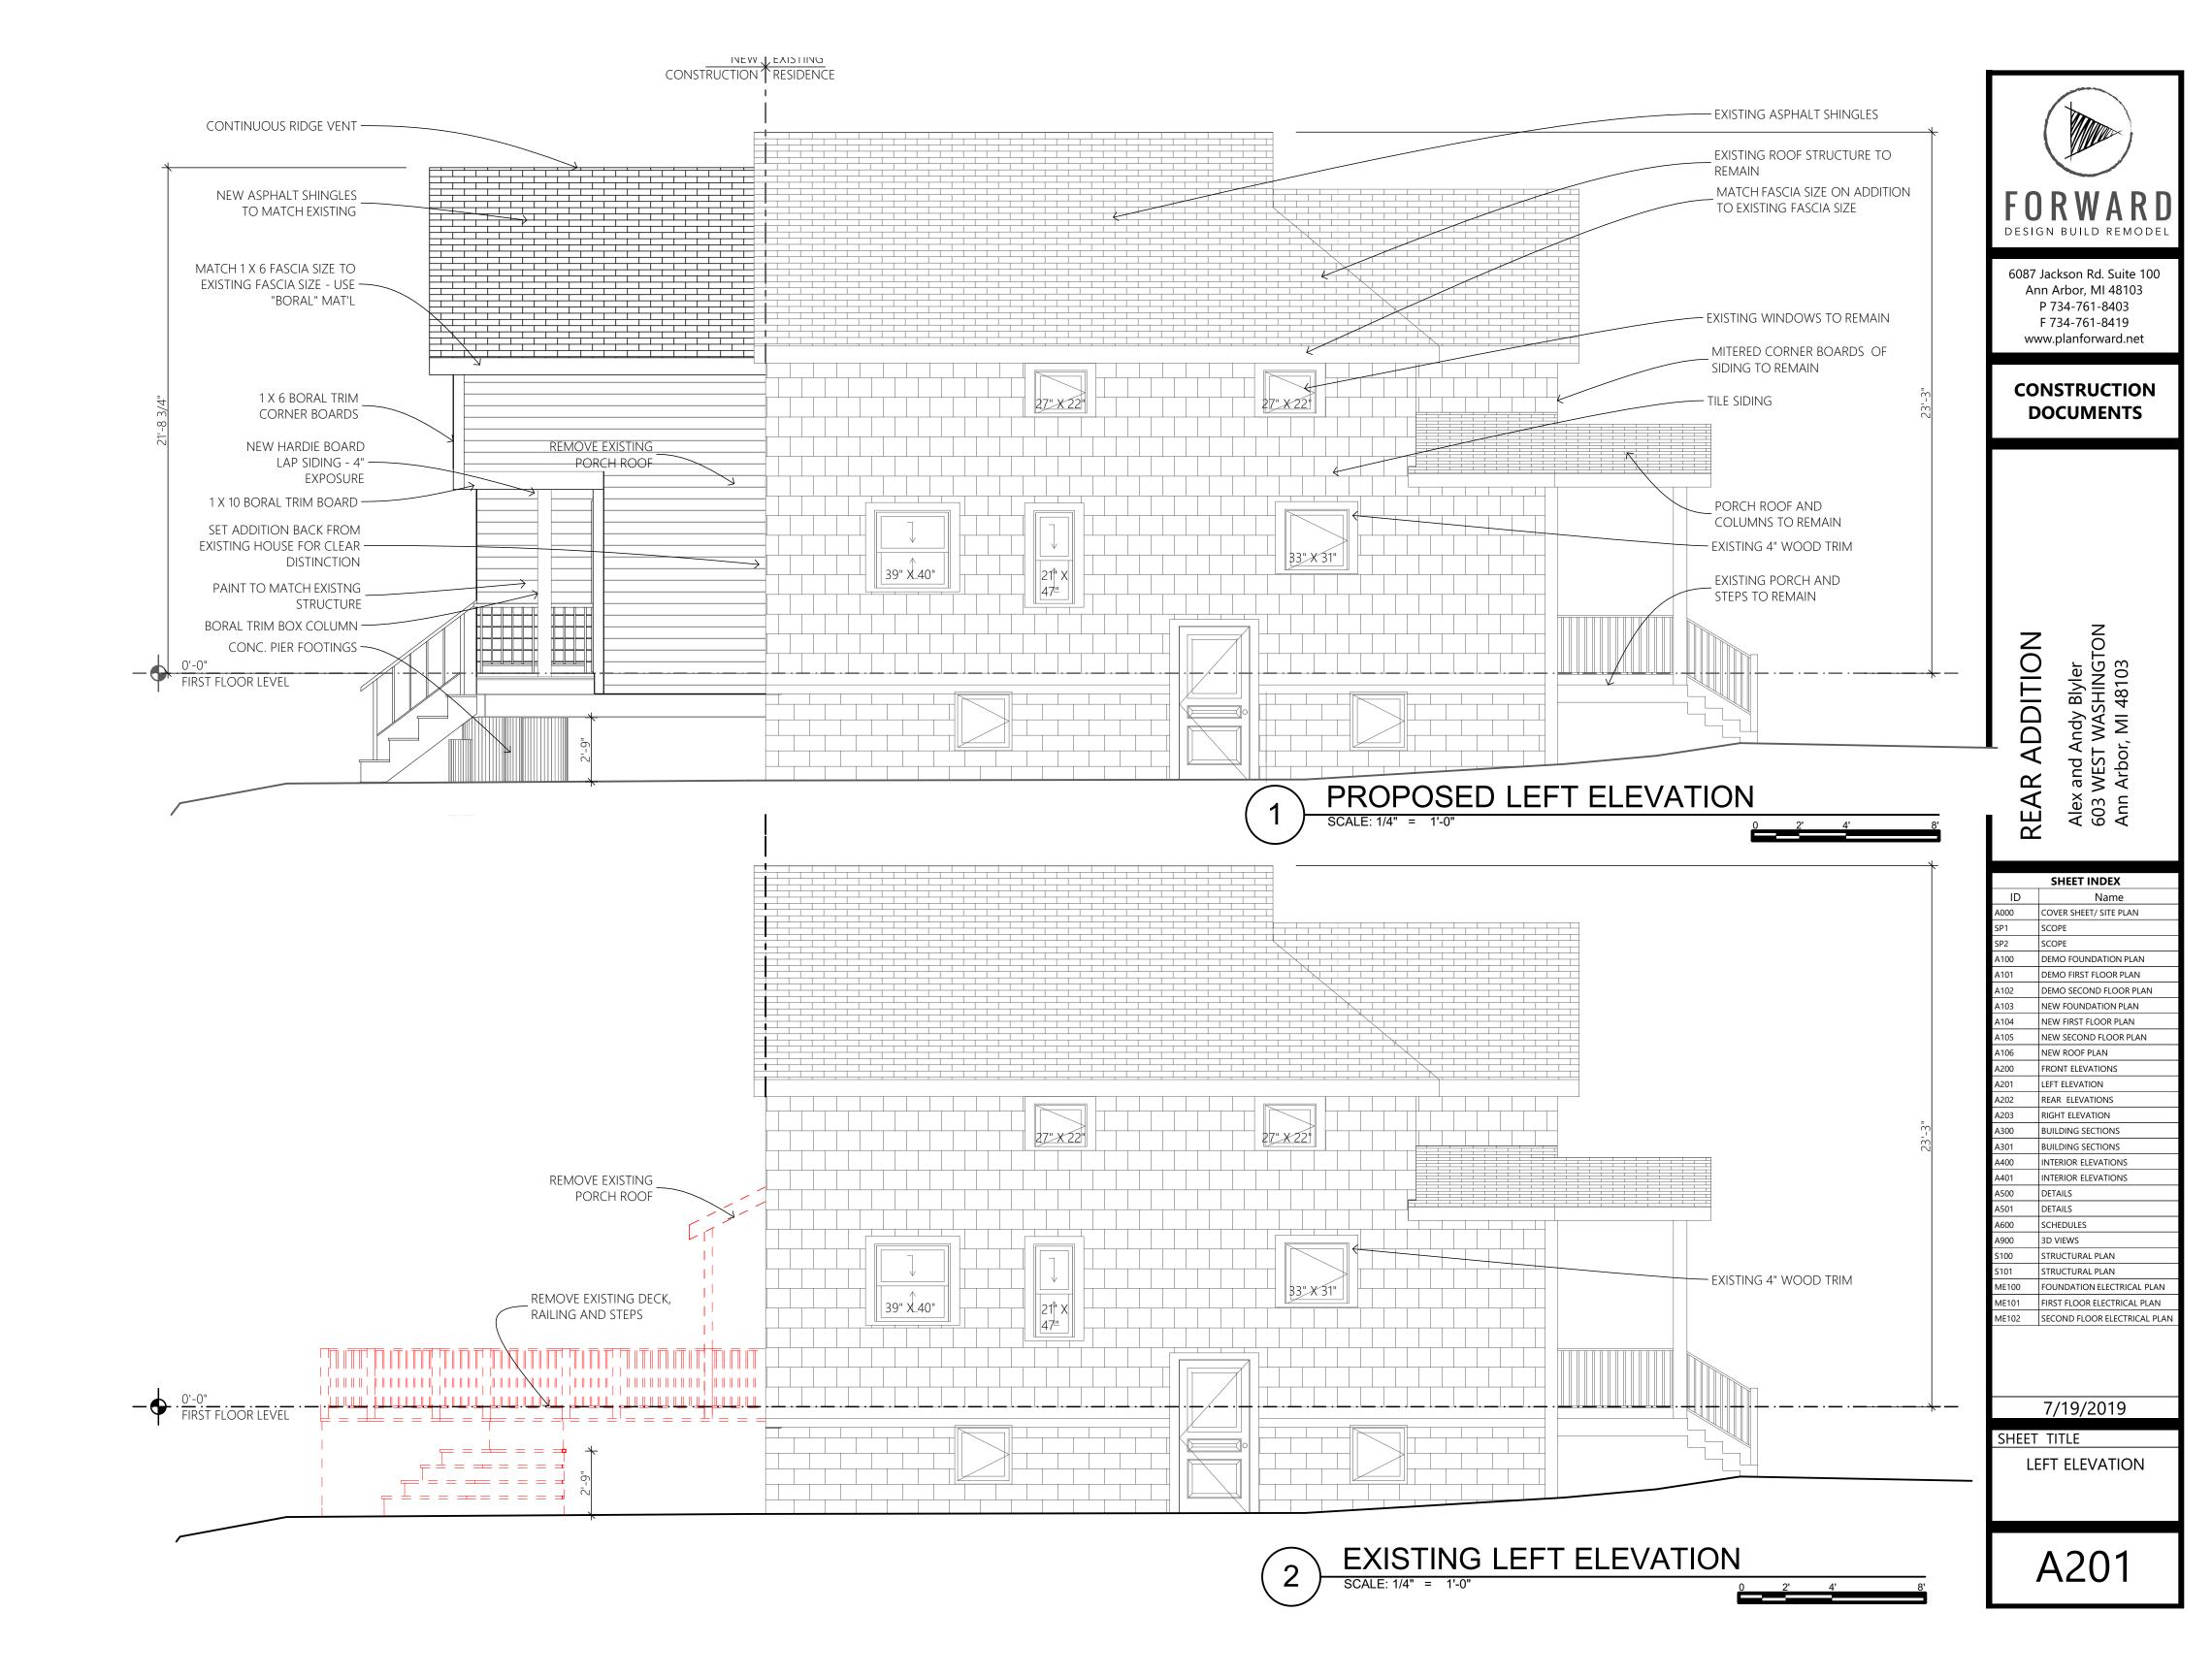

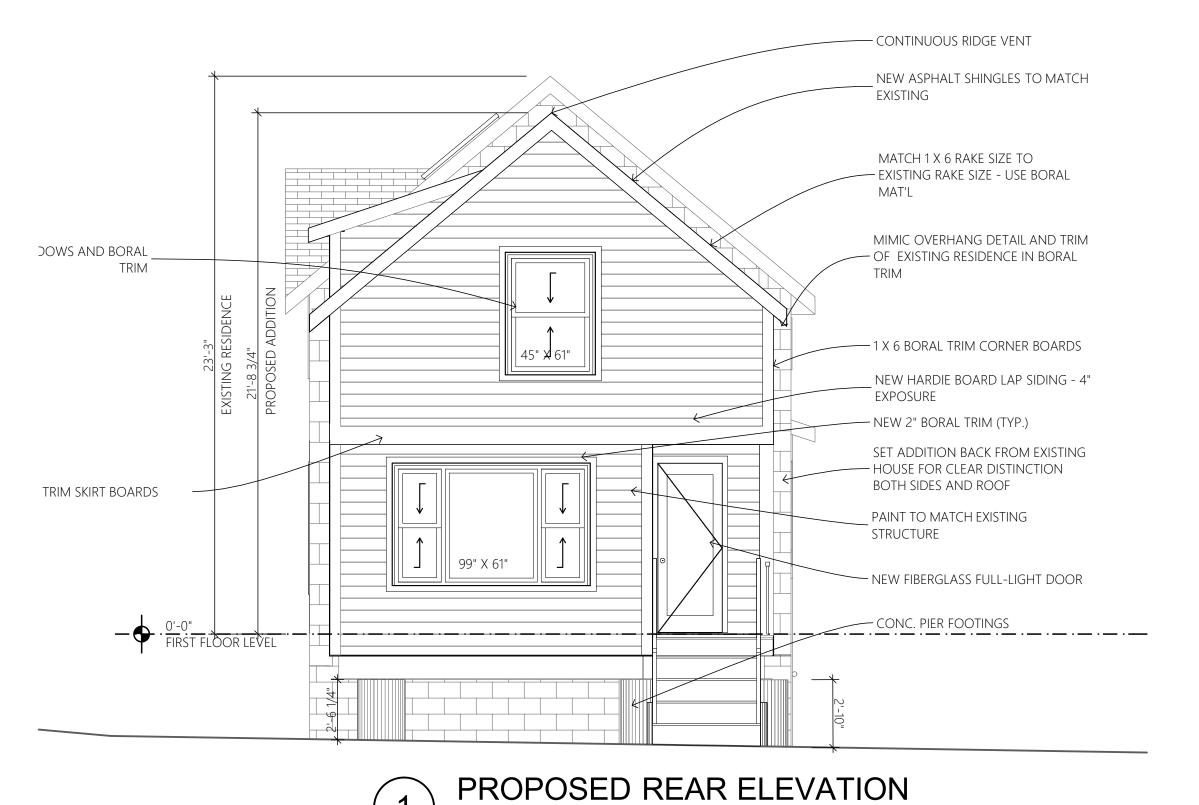EXISTING REAR ELEVATION

SCALE: 1/4" = 1'-0"



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### CONSTRUCTION DOCUMENTS


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REAR ELEVATIONS





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A400	INTERIOR ELEVATIONS	
A401	INTERIOR ELEVATIONS	
A500	DETAILS	
A501	DETAILS	
A600	SCHEDULES	
A900	3D VIEWS	
S100	STRUCTURAL PLAN	
S101	STRUCTURAL PLAN	
ME100	FOUNDATION ELECTRICAL PLAN	
ME101	FIRST FLOOR ELECTRICAL PLAN	
ME102	SECOND FLOOR ELECTRICAL PLAN	

7/19/2019

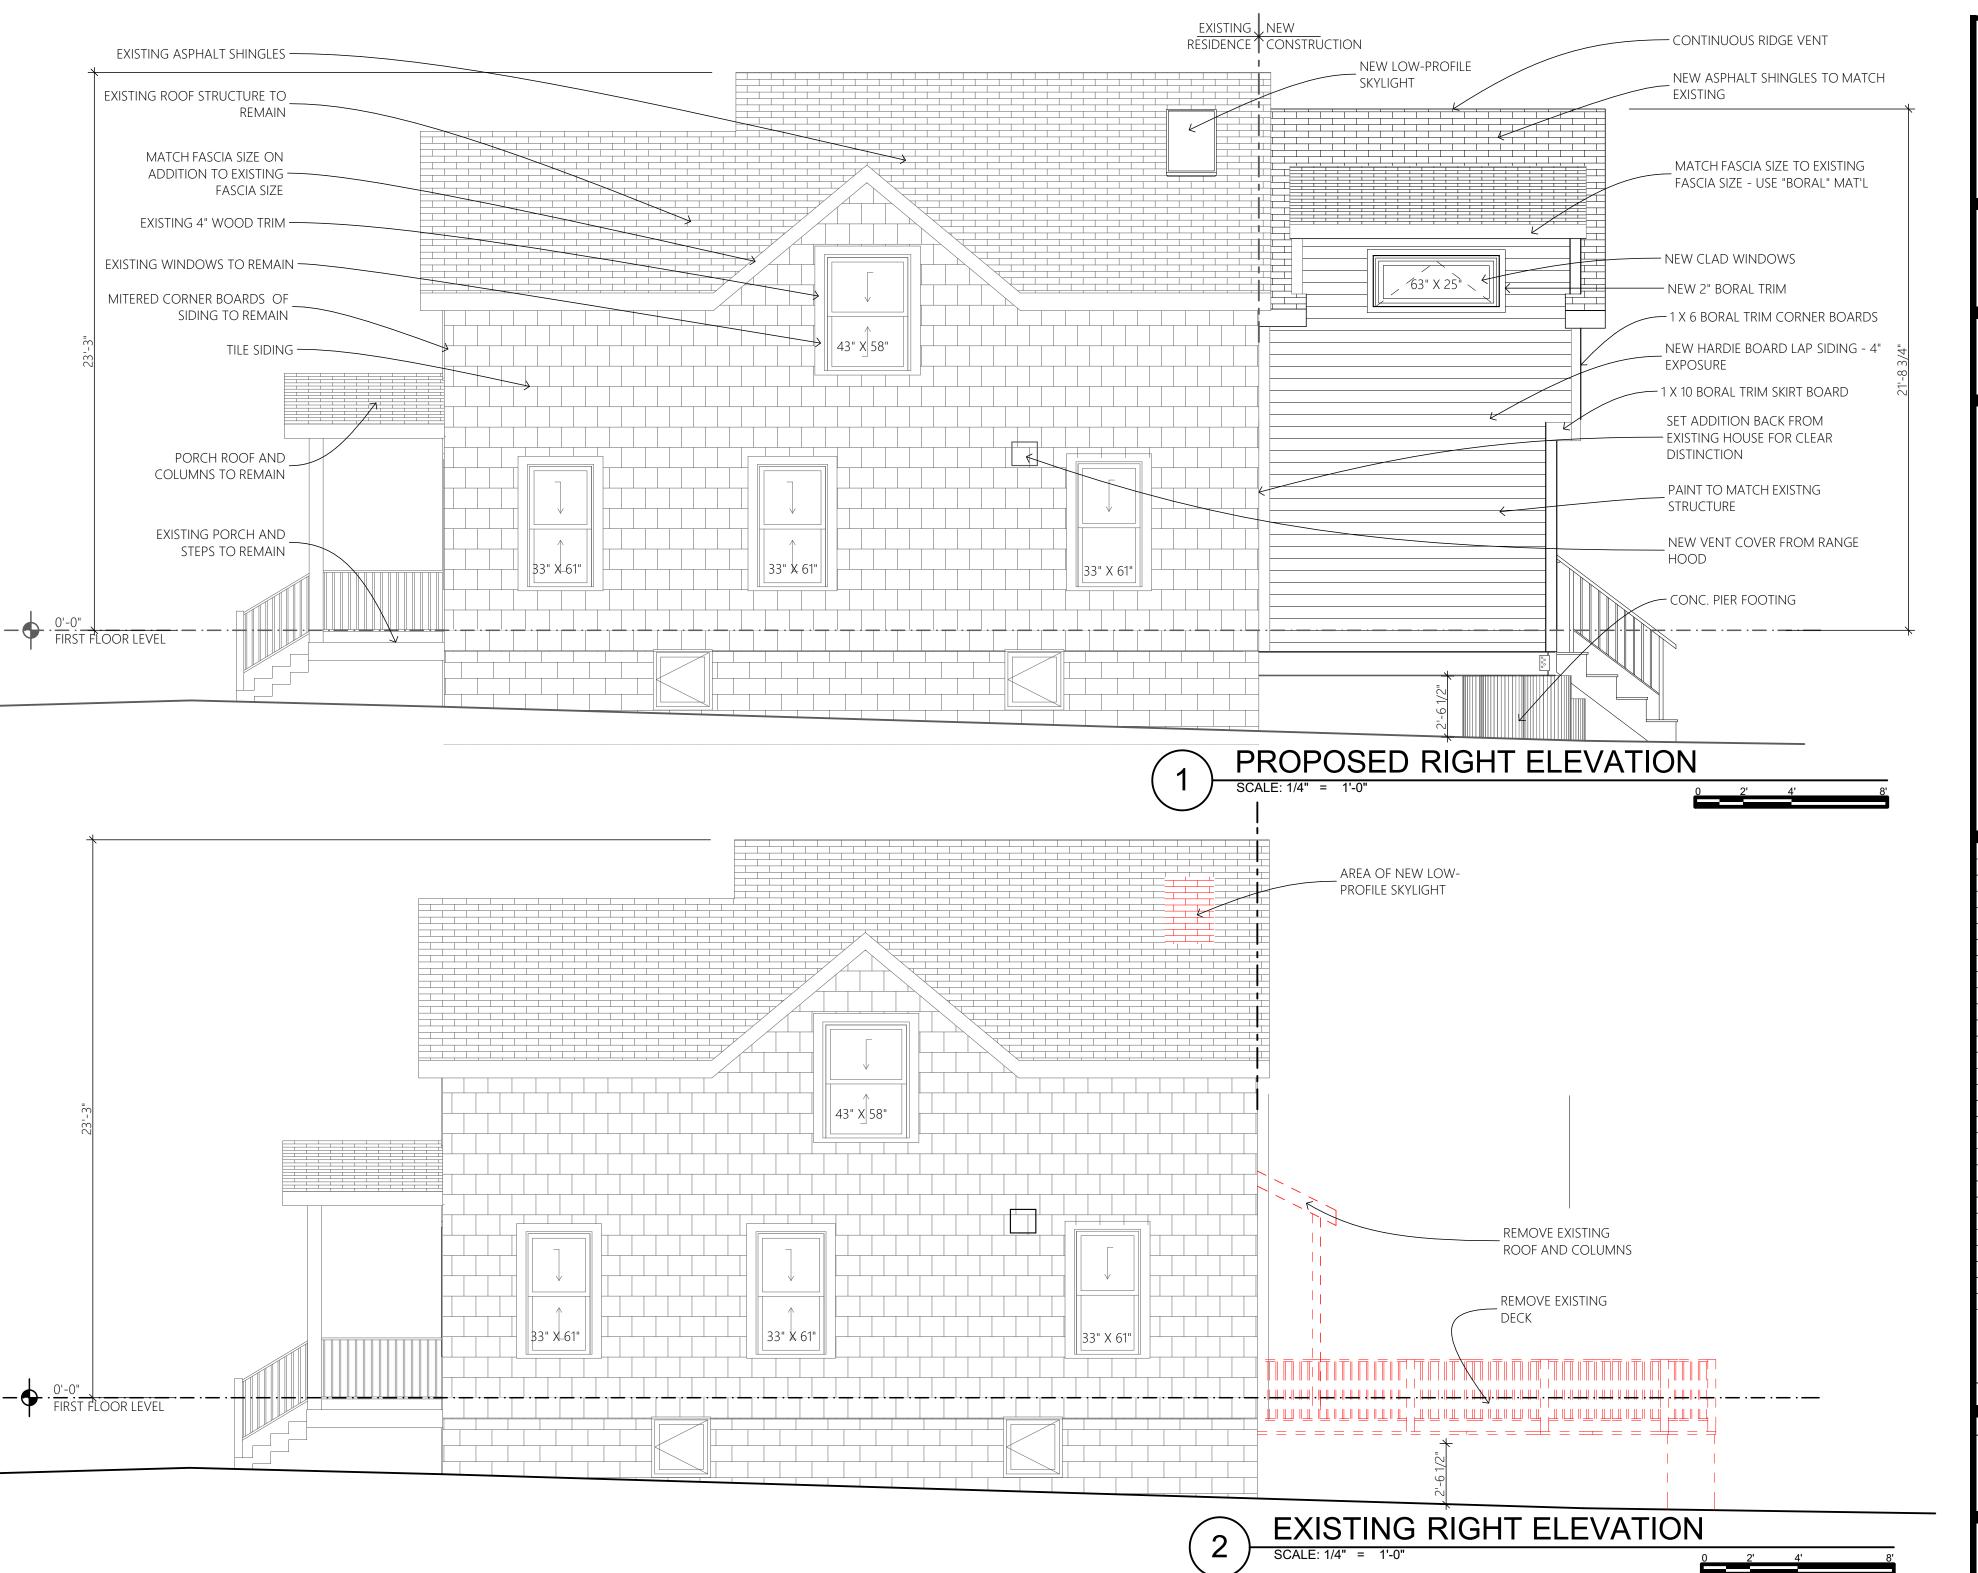
RIGHT ELEVATION

SHEET TITLE


## Pinnacle Series CLAD DOUBLE HUNG

SECTION DETAILS : CONSTRUCTION

SCALE: 2" = 1'-0"

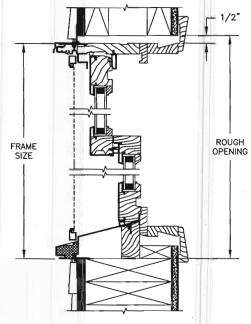


HEAD JAMB & SILL 2 X 6 FRAME WITH SIDING

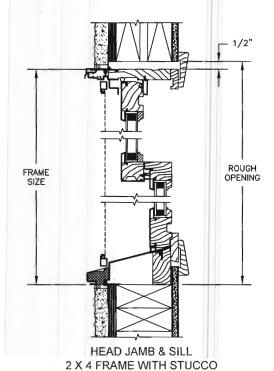

3/8" FRAME SIZE 3/8"

ROUGH OPENING

HEAD JAMB & SILL 2 X 6 FRAME WITH SIDING

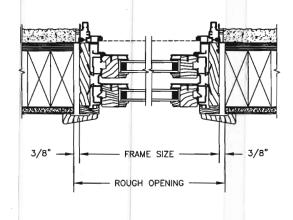

JAMBS 2 X 4 FRAME WITH STUCCO

NOTE:

THE ABOVE WALL SECTIONS REPRESENT TYPICAL WALL CONDITIONS, THESE DETAILS ARE NOT INTENDED AS INSTALLATIONS INSTRUCTIONS. PLEASE REFER TO THE INSTALLATION INSTRUCTIONS PROVIDED WITH THE PURCHASED UNITS.

## Pinnacle Series CLAD DOUBLE HUNG

SECTION DETAILS : OPERATING / PICTURE SCALE: 3" = 1'-0"

