

HISTORIC DISTRICT COMMISSION

PLANNING AND DEVELOPMENT SERVICES

City Hall: 301 E. Huron St. Ann Arbor, MI 48104-6120 *Mailing:* P.O. Box 8647, Ann Arbor, MI 48107-8647

Phone: 734.794.6265 ext. 42608 Fax: 734.994.8460 ithacher@a2gov.org

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Permit Number HDC# 18-278 BLDG# DATE STAMP CITY OF ANN ARBOR RECEIVED DEC 2 0 2018

APPLICATION MUST BE FILLED OUT COMPLETELY

		PLANNING & DEVI	ELOPMENT SERVICES
PROPERTY LOCATION/OWNER INFORMATION			
NAME OF PROPERTY OWNER Grace and Jon Vander	vliet	HISTÓRIC DISTRICT Ole	d West Side
PROPERTY ADDRESS 503 W Jefferson St			ANN ARBOR
ZIPCODE DAYTIME PHONE NUMBER	EMAIL ADDRESS		
48103 (734) 904-9409	gracevandervliet@gmail.co	m	
PROPERTY OWNER'S ADDRESS (IF DIFFERENT FROM ABOVE)		CITY	STATE, ZIP
PROPERTY OWNER'S SIGNATURE			
SIGN HERE M Graw Wand Which	PRINT NAME Grace Vande	ervliet	DATE 12/20/2018
APPLICANT INFORMATION			
NAME OF APPLICANT (IF DIFFERENT FROM ABOVE)			
			CITY
ADDRESS OF APPLICANT			CITY
STATE ZIPCODE	PHONE / CELL #	FAX No	
27.772	7 8	1	ì
EMAIL ADDRESS			1
EIVIAIL ADDRESS			
APPLICANT'S SIGNATURE (if different from Property	Owner)	DEMANDED BY CHESTS	
SIGN HERE	PRINT NAME X		DATE
BUILDING USE – CHECK ALL THAT APPLY			
	NTAL MULTIPLE FAMILY	☐ COMMERCIAL	□ INSTITUTIONAL
A SINGLE PAINTER LE BOILLER LE			
PROPOSED WORK	是 据这个"各种人" 医人名德		
Describe in detail each proposed exterior alteration, in	nprovement and/or repair (use additio	nal paper, if necessary).	\$
See attached.			
DESCRIBE CONDITIONS THAT JUSTIFY THE PROPOSED	CHANGES:		
See attached.			5.0
Fau Further Assistance With Populard Attachments places Vi	icit waaw azgou org/hdc		



HISTORIC DISTRICT COMMISSION APPLICATION

STAFF REVIEW FEES	FEE
Application for Staff Approval	\$35.00
Work started without approvals	Additional \$50.00
HISTORIC DISTRICT COMMISSION FEES	
All other proposed work not listed below	\$100.00
Work started without approvals	Additional \$250.00
RESIDENTIAL - Single and 2-story Structur	re
Addition: single story	\$300.00
Addition: taller than single story	\$550.00
New Structure - Accessory	\$100.00
New Structure – Principal	\$850.00
Replacement of single and 2-family window(s)	\$100 + \$25/window
COMMERCIAL – includes multi-family (3 ostructures	or more unit)
Additions	\$700.00
Replacement of multi-family and commercial window (s)	\$100 + \$50/window
Replacement of commercial storefront	\$250.00
DEMOLITION and RELOCATION	
Demolition of a contributing structure	\$1000.0
Demolition of a non-contributing structure	\$250.00
Relocation of a contributing structure	\$750.00
Relocation of a non-contributing structure	\$250.00

FOR COMMISSION REVIEWS:

- Application withdrawals made before public notice is published will qualify for a 50% refund of the application fee
- Application withdrawals made after public notice is sent but before the public hearing will qualify for a 25% refund of the application fee.

INSTRUCTIONS FOR SUBMITTING APPLICATIONS

All HDC applications must be signed by the property owner and the applicant, if different, with the exception of staff approvals, which may be signed by only the applicant.

All completed HDC applications and their attachments may be submitted to Planning and Development Services by mail, in person (paper or digital), faxed, or via email to building@a2gov.org.

We accept CASH, CHECK, and all major credit cards. Checks should be made payable to "City of Ann Arbor"

HDC applications that are incomplete or not submitted with the required documentation or payment will not be processed or approved.

APPLICATION EXPI	RATIO	N		
HDC applications ex	xpire tl	nree (3) years aft	er the c	late of approval.
OFFICE USE ONLY				
Date of Hearing:				
Action		HDC COA		HDC Denial
Action		HDC NTP		Staff COA
Staff Signature				
Comments				
Face				
Fee:	\$			

Building

From:

David Rochlen <david@charmarch.com>

Sent:

Thursday, December 20, 2018 12:10 PM

To:

Building

Subject:

HDC Application and Set

Attachments:

503 W Jefferson St - HDC Application - 20 DEC 2018.pdf; 503 W Jefferson St - HDC Set -

20 DEC 2018.pdf

Hi,

Please find attached an HDC Application and the associated drawing set to be included for the January meeting. I am running out to get my client's signature for the application and I will submit that to you ASAP.

Thanks, Dave

David B. Rochlen, AIA Charm Architecture, PLLC 734-546-6309

Ann Arbor Historic District Commission Application

Application Information

Grace and Jon Vandervliet 503 West Jefferson Street Ann Arbor, MI 48103

Proposed Work

This project proposes an interior and exterior renovation and a two-story addition to this historic home.

This project proposes several improvements to the home's site and existing exterior including to renovate the front walkway, to install a new side patio and stoop leading to a reconfigured side entry, to install a new door in the addition portion of the garage, to remove the existing aluminum siding and restore the historic wood clapboard siding and trim and to provide new anodized aluminum storm windows for all existing windows.

This project proposes to add a two-story rear yard addition to the existing house that will include the following improvements: a new foundation wall underneath the existing one story addition, a new basement living room accessed by a new stair and a new full bath in the basement. On the first floor, the project proposes to add a reconfigured side entry with a mud room leading to a renovated kitchen. On the second floor a new bedroom and full bathroom is proposed.

Conditions That Justify Proposed Changes

The house was partially converted from a duplex into a single family home by the previous owner. The current owners would like to complete that work and perform a much-needed renovation to the home's existing exterior. The addition would fix the existing awkward side entry and provide desired additional bedroom space on the second floor.

Sheet List

HDC 0.0	Sheet Number
Cover Sheet	mber Sheet Name

HDC 0.1	Sanborn Maps
HDC 0.2	Existing Photos
HDC 0.3	Removal Plan

Existing Roof Plan	HDC 1.4
Existing Second Floor Plan	HDC 1.3
Existing First Floor Plan	HDC 1.2
Existing Basement Plan	HDC 1.1
Existing Site Plan	HDC 1.0
Proposed Addition	HDC 0.4


IDC 1.4	Existing Roof Plan
1DC 2.0	Existing North Elevation
HDC 2.1	Existing South Elevation
HDC 2.2	Existing West Elevation
HDC 2.3	Existing East Elevation
HDC 3.0	Proposed Site Plan
HDC 3.1	Proposed Basement Plan

Section	HDC 5.1
Section	HDC 5.0
Proposed East Elevation	HDC 4.3
Proposed West Elevation	HDC 4.2
Proposed South Elevation	HDC 4.1
Proposed North Elevation	HDC 4.0
Proposed Roof Plan	HDC 3.4
Proposed Second Floor Plan	HDC 3.3
Proposed First Floor Plan	HDC 3.2


HDC 6.0 HDC 6.1 HDC 6.2

Area Calculation Material Schedule Window and Door Schedule


Sanborn Maps

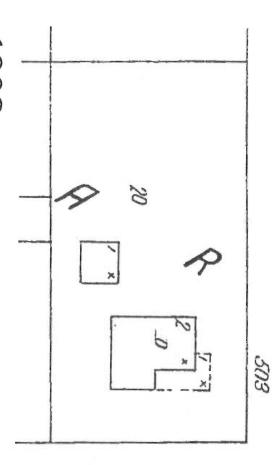


1908 Main house before addition.

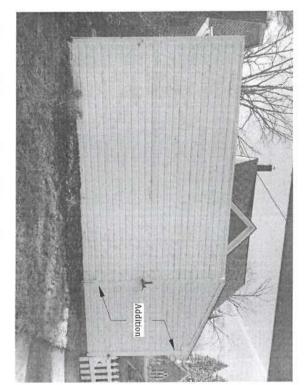

View of Garage East Elevation

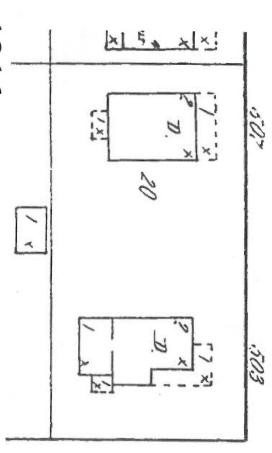


1916 Addition and side porch added. Garage removed.

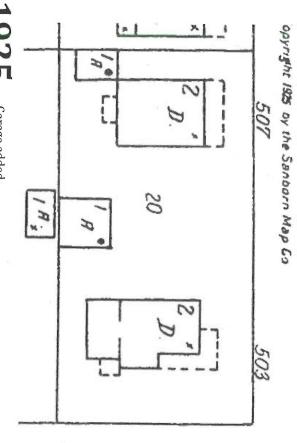


1925


Garage added.

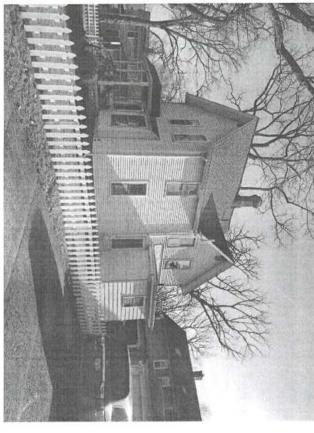


View of West Elevation

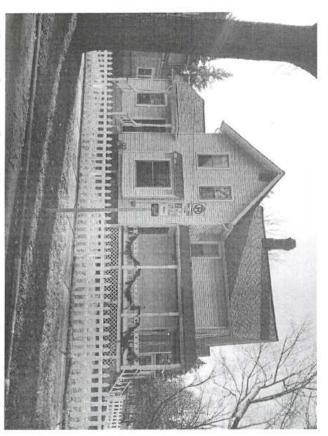

View of East Elevation

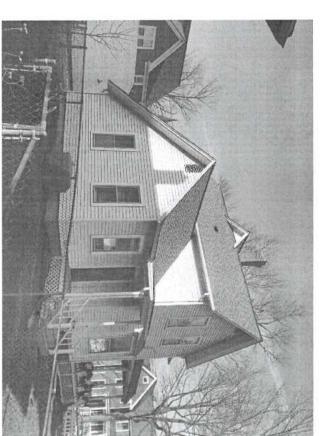



View of South Elevation

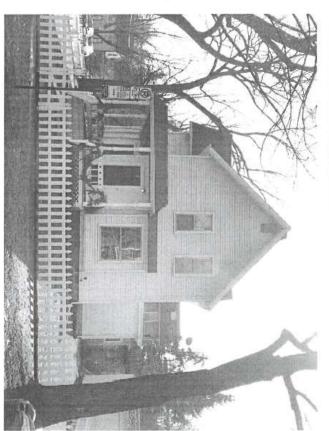


View of North Elevation

Removal Plan

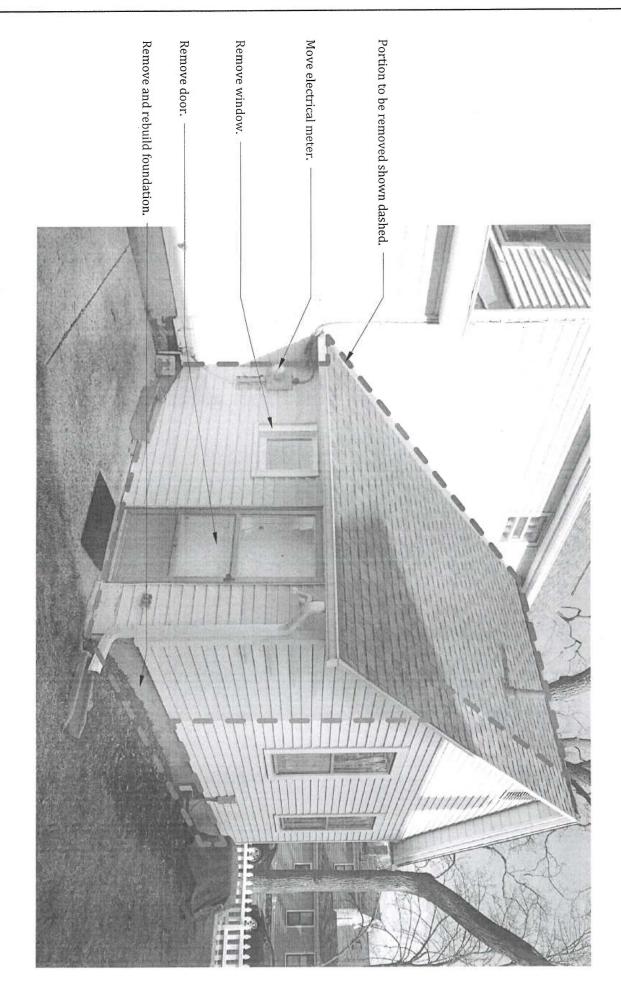

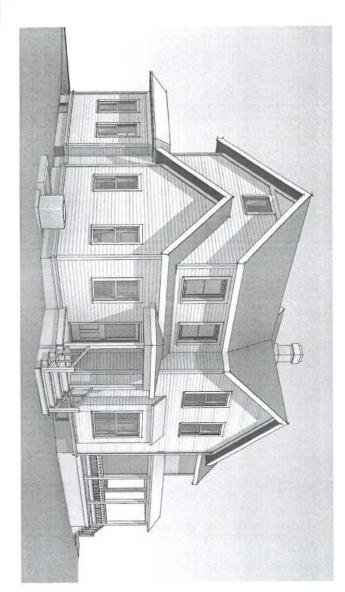


2 View From SE

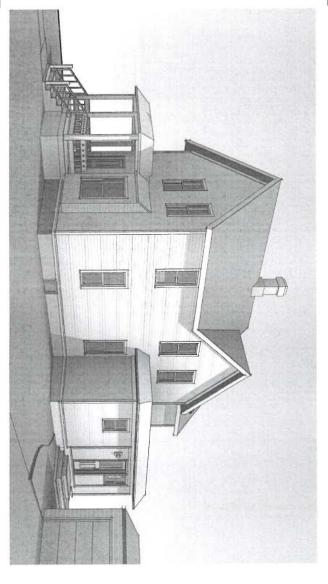

1) View From NW


1/16" = 1'-0"

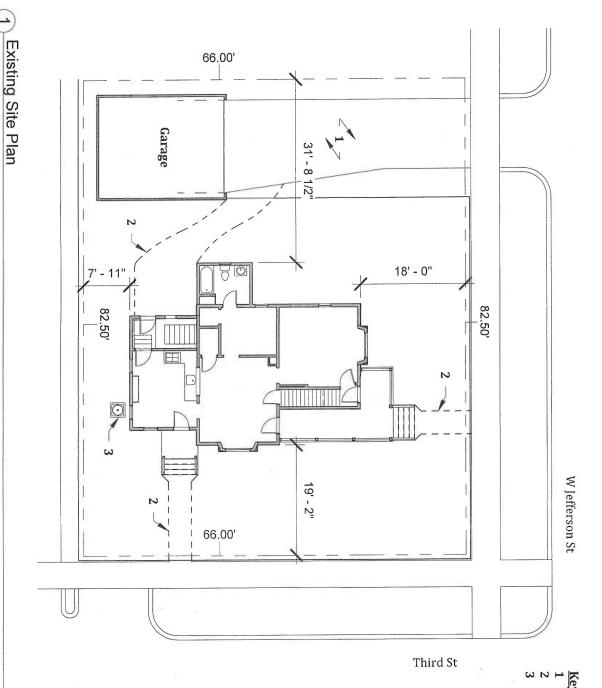

- Keynotes
 1 Existing asphalt driveway.
 2 Existing concrete walkway to be removed.
 3 Existing AC outdoor unit.

Existing Basement Floor Plan

1/8" = 1'-0"

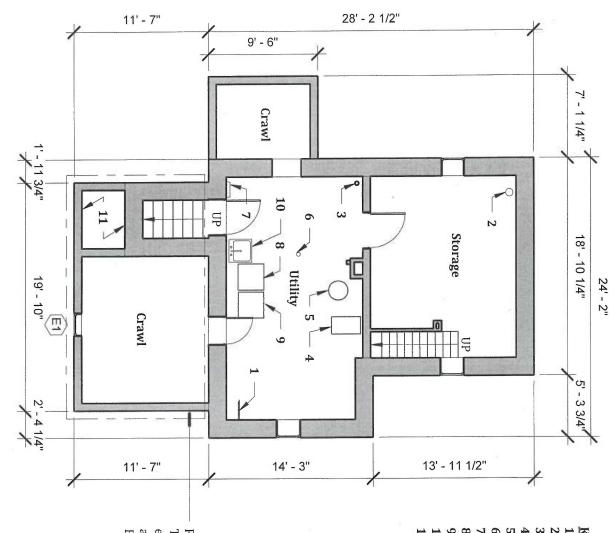

Keynotes

- Natural gas service
- Water service
- Radon mitigation system
- Furnace
- Domestic hot water
- Floor drain Electrical panel
- Washer
- Dryer
- Utility sink
- 11 Unexcavated

and the existing basement window existing rubble cellarway and stairs, The existing rubble foundation, the E1 are proposed to be removed.









Existing Second Floor Plan
1/8" = 1'-0"






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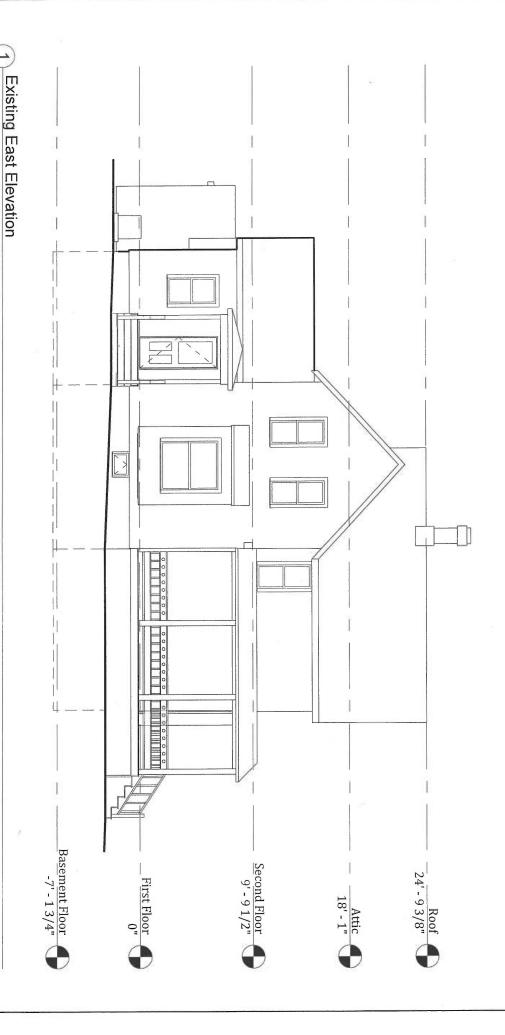


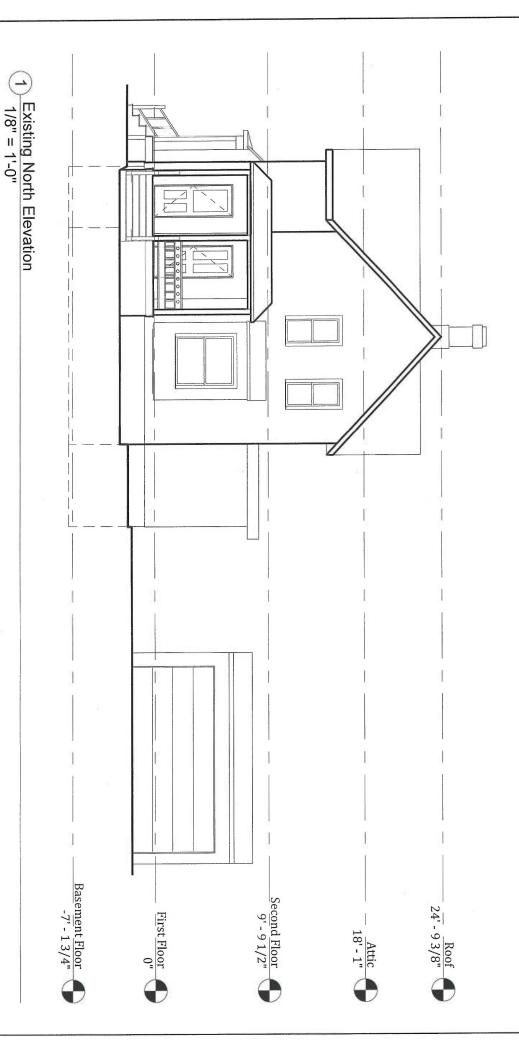

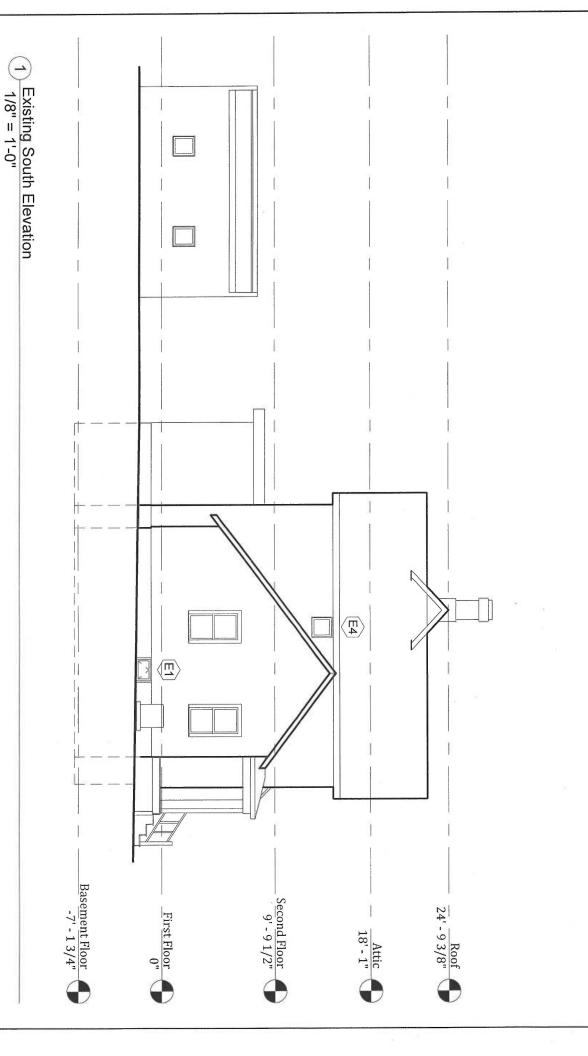Charm Architecture, PLLC - Grace and Jon Vandervliet 503 W Jefferson St Renovation and Addition

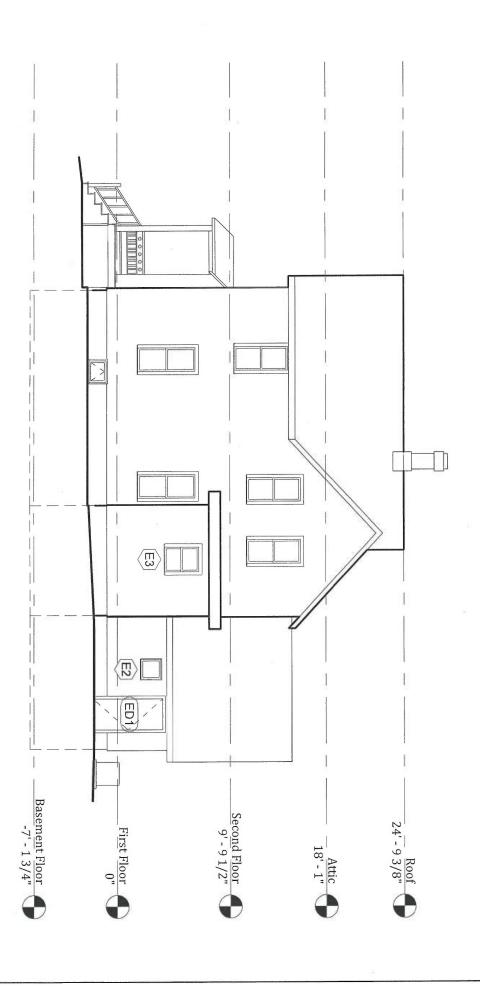


1) Existing West Elevation 1/8" = 1'-0"



Charm Architecture, PLLC - Grace and Jon Vandervliet 503 W Jefferson St Renovation and Addition


1/8" = 1'-0"

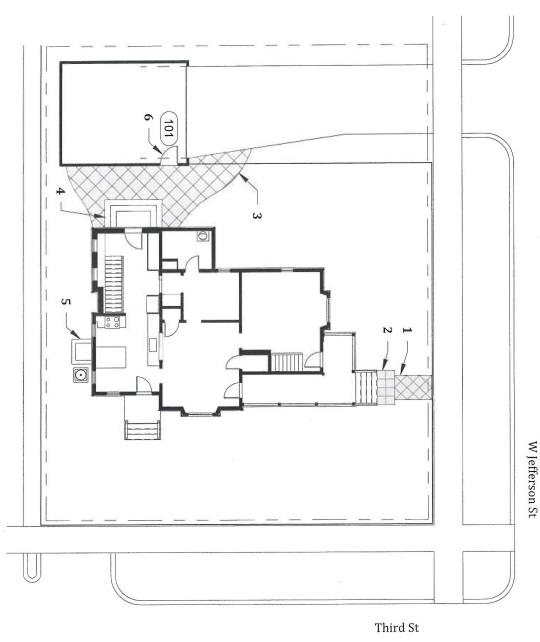


Keynotes

- Stone path, 4' wide.
 Stone landing, 3' deep.
 Stone patio, 230 SF, approx. 11'x21'.
- Wood (or composite wood) stoop with three risers.
- Concrete or CMU Egress window well.
- Door 101 added to addition portion of garage.


Proposed Site Plan 1/16" = 1'-0"

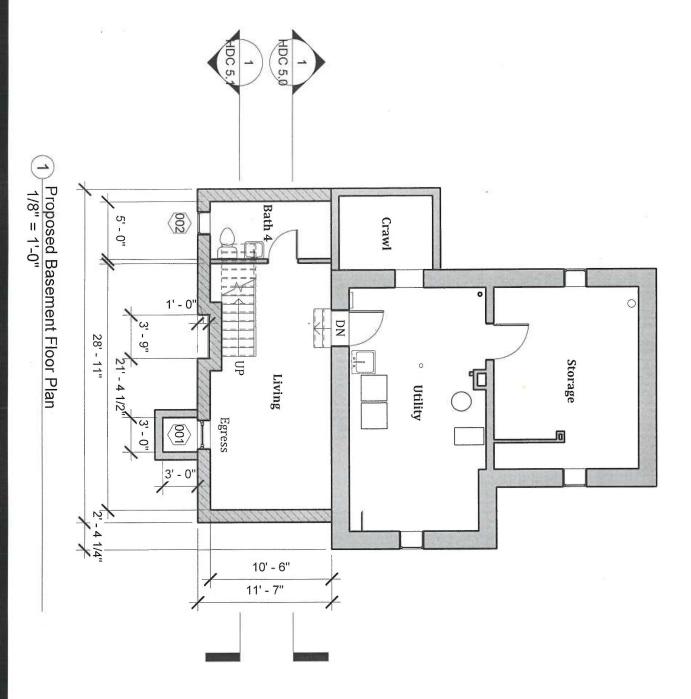




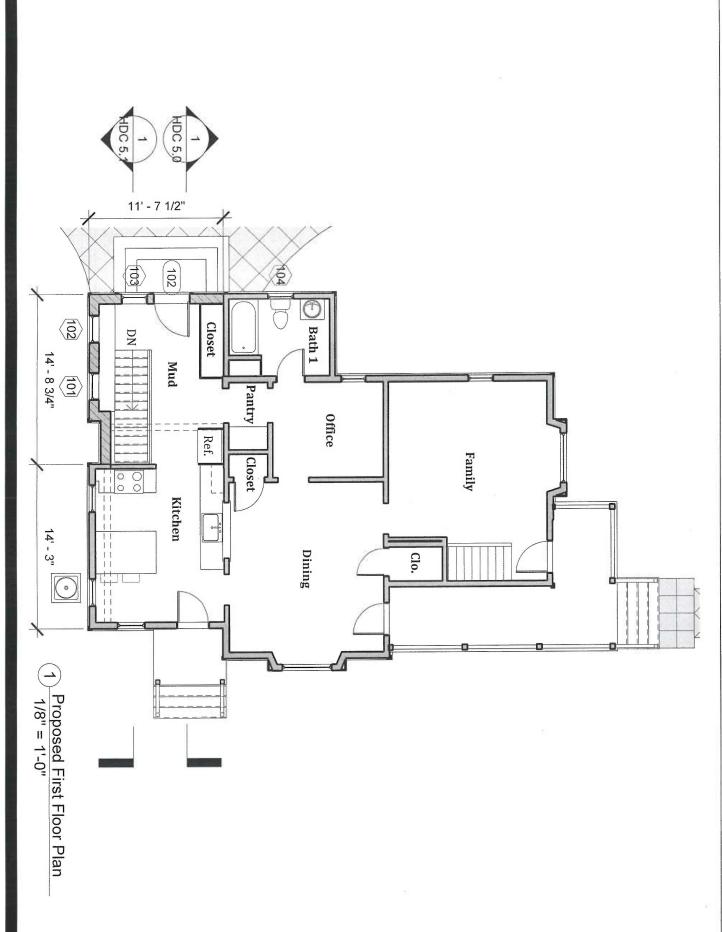




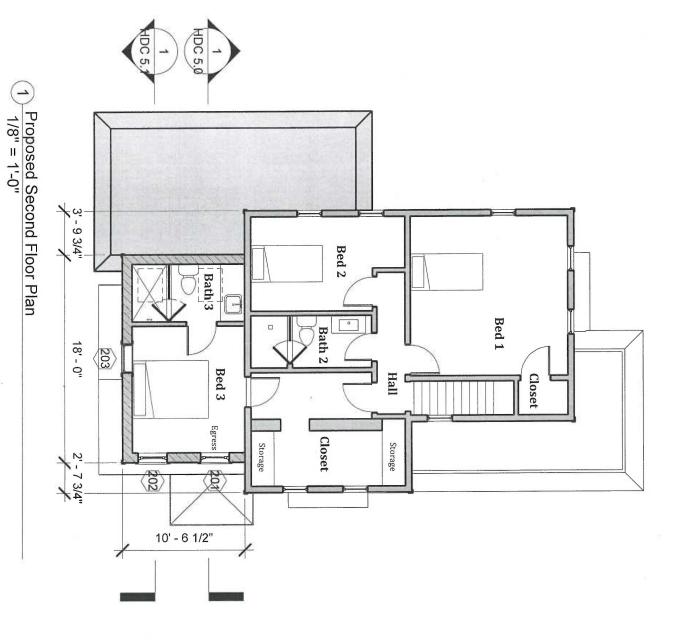

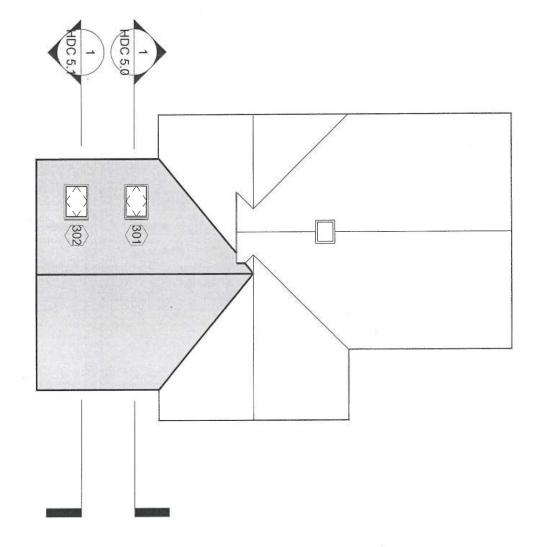


1) Proposed Roof Plan 1/8" = 1'-0"



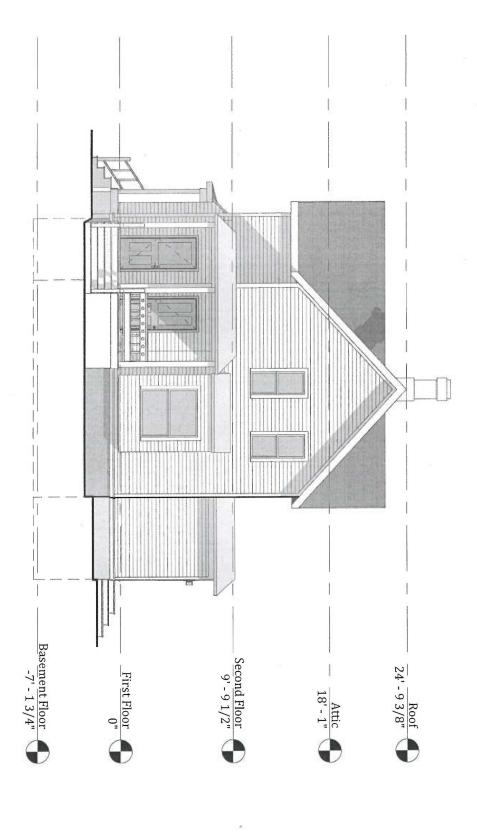



1) Proposed North Elevation 1/8" = 1'-0"

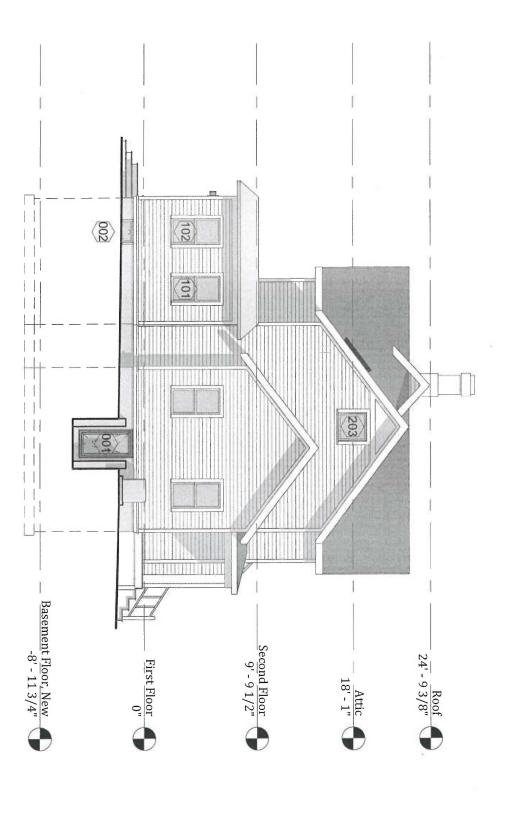


1) Proposed South Elevation 1/8" = 1'-0"

1/8" = 1'-0"

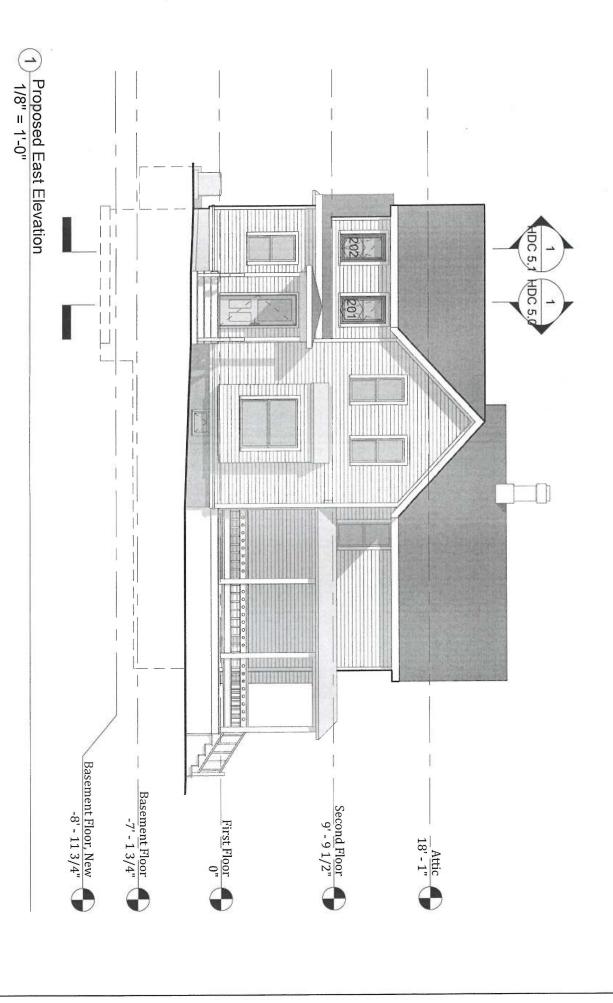

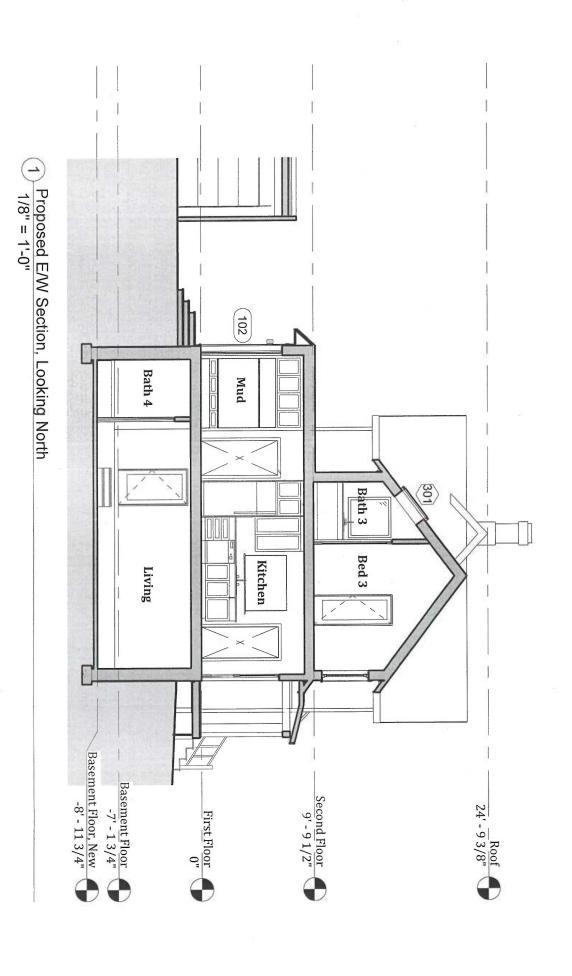

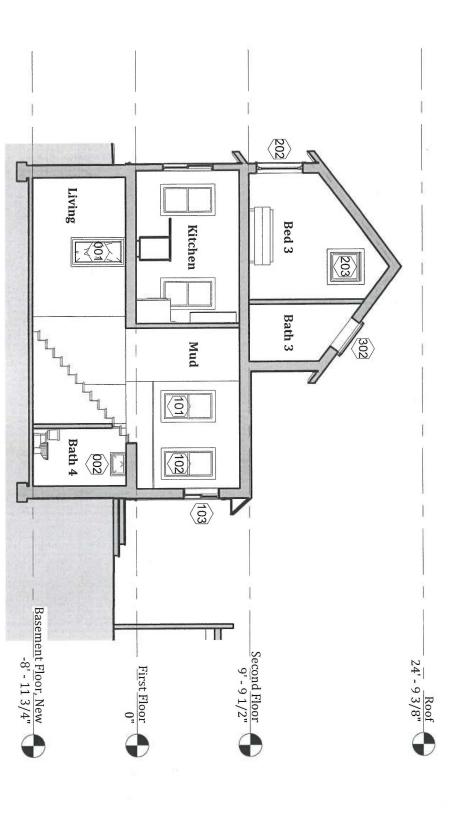

1) Proposed E/W Section, Looking South

Window and Door Schedules

Window Schedule - Existing To Be Removed

Mark	Level	Function	Material	Width	Height	Description
E1	Basement Floor	Fixed	Wood	2' - 0"	1'-4"	Basement window.
E2	First Floor	Fixed	Wood	1'-10"	1'-10"	Wall to be removed.
E3	First Floor	Double Hung	Wood	2' - 3"	3'-1"	Modern window in modern addition.
E4	Second Floor	Fixed	Glass Block	1'-9"	1'-9"	Modern window.
Contract of the Contract of th						

Window Schedule - Proposed

Mark	Level	Function	Material	Width	Height	Manufacturer
001	Basement Floor, New Tilt Turn	Tilt Turn	Aluminum Clad Wood 2' - 6"	2'-6"	4' - 9"	Marvin Windows and Doors
002	Basement Floor, New Tilt Turn	Tilt Turn	Aluminum Clad Wood 2' - 0"	2' - 0"	1'-4"	Marvin Windows and Doors
101	First Floor	Double Hung	Aluminum Clad Wood 2'-41/2"	2'-41/2"	4' - 4"	Marvin Windows and Doors
102	First Floor	Double Hung	Aluminum Clad Wood 2' - 4 1/2"	2' - 4 1/2"	4' - 4"	Marvin Windows and Doors
103	First Floor	Double Hung	Aluminum Clad Wood 2' - 3"	2' - 3"	3'-1"	Marvin Windows and Doors
104	First Floor	Double Hung	Aluminum Clad Wood 2' - 3"	2'-3"	3'-1"	Marvin Windows and Doors
201	Second Floor	Tilt Turn	Aluminum Clad Wood 2' - 6"	2'-6"	4'-0"	Marvin Windows and Doors
202	Second Floor	Tilt Turn	Aluminum Clad Wood 2' - 6"	2'-6"	4'-0"	Marvin Windows and Doors
203	Second Floor	Double Hung	Aluminum Clad Wood 2' - 6"	2'-6"	2'-6"	Marvin Windows and Doors
301	Roof	Operable Skylight	Aluminum Clad Wood 2' - 0"	2'-0"	3'-6"	Velux
302	Roof	Operable Skylight	Aluminum Clad Wood 2' - 0"	2'-0"	3'-6"	Velux

NOTE: Window 201 and 202 shall be furnished with one horizontal 1 1/8" Simulated Divided Lite with Square Interior muntin profile.

Door Schedule


Mark	Description	Width	Height	Manufacturer
101	Aluminum Clad Wood or Fiberglass entry door.	3'-0"	7' - 0"	TBD
102	Aluminum Clad Wood or Fiberglass entry door.	3' - 0"	7' - 0"	TBD
ED1	To be removed.	2'-8"	6'-0"	N/A


Area Calculation

Existing Area: Proposed Area: Footprint 105 SF 905 SF Floor Area 295 SF

Proposed/Existing: 12% 1,537 SF

Footprint Increase

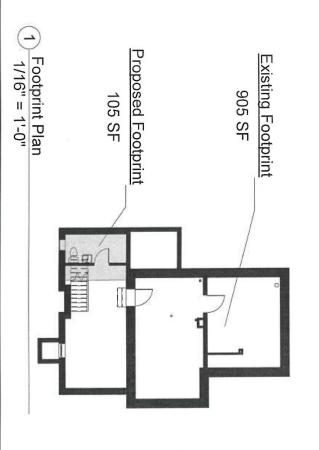

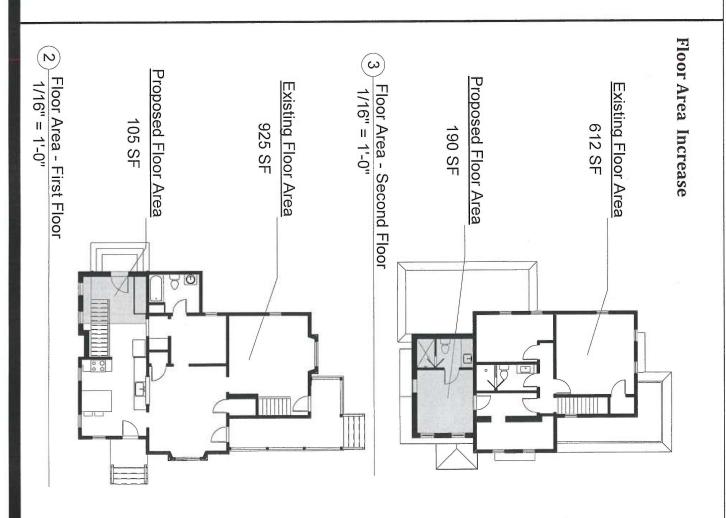

New Material Schedule

Item for Addition

Description

First Floor Roofing:

Second Floor Roofing: Cladding:

Egress Window Well: Fascia Board:

Foundation:

Soffit Board: Corner board: Frieze board:

Window and Door Head Trim:

Skirt Board:

Window Sill: Window and Door Side Trim:

> Asphalt roof shingles. Standing seam metal roofing.

Fiber cement lap siding, smooth texture, match existing exposure.

Concrete or CMU block with plaster parge coat.

Concrete or CMU block with plaster parge coat.

Fiber cement board, 5/4 x 5.5", smooth texture

Fiber cement panel, smooth texture.

Fiber cement board, 5/4 x 5.5", smooth texture.

Fiber cement board, 5/4 x 3.5", smooth texture.

Fiber cement board, 5/4 x 3.5", smooth texture. 2x poly-ash board over fiber cement board, $5/4 \times 3.5$ ", smooth texture.

Fiber cement board, 5/4 x 3.5", smooth texture.

2x poly-ash board.

Historic Portion of House

extant wood cladding and trim that is proposed to be restored in place, or replaced as needed with like materials and dimensions. The aluminum siding on the exterior walls is proposed to be removed. It is expected that there will be

The existing metal roofing is proposed to be replaced with similar metal roofing

New anodized aluminum storm windows are proposed for all existing windows. The frames shall not have