GENERAL INFORMATION

THE PROJECT INVOLVES THE PRESERVATION AND ADAPTIVE REUSE OF THE FORMER TREASURE MART BUILDING AT 521-525 DETROIT STREET FOR USE AS A CHURCH BY REDEEMER ANN ARBOR MINISTRY (OWNER) (http://www.redeemera2.org/). REDEEMER ANN ARBOR PROPOSES TO MOVE THEIR PRESENT OPERATION IN THE RENOVATED AND RESTORED FORMER DKE SHANT BUILDING AT 611 1/2 WILLIAMS STREET TO THIS LOCATION. THE FORMER TREASURE MART BUILDING CURRENTLY CONSISTS OF THE ORIGINAL 'MAIN BUILDING' (CONSTRUCTED IN 1861), A REAR 'STAIR ADDITION,' AND A REAR/SIDE 'OFFICE ADDITION.' SUPPLEMENTAL INVESTIGATION CONFIRMS THAT CURRENT ADDITIONS EXISTED AND/OR OCCUPIED THE SAME FOOTPRINT AREA PRIOR TO 1945 AS WELL AS A LARGE, BARN-LIKE WAREHOUSE BUILDING AT THE REAR OF THE SITE, WHICH HAS SINCE BEEN DEMOLISHED.

- RESTORE AND ADAPTIVELY RENOVATE THE ORIGINAL MAIN BUILDING TO ITS APPEARANCE WHEN ORIGINALLY
- CONSTRUCTED, IN 1861. · RECONSTRUCT THE ORIGINAL UPPER, WOOD CORNICE AT THE FRONT ELEVATION OF THE BUILDING. CONVERT THE FORMER BARN-TYPE DOORS, THAT ARE NOW LARGE WINDOWS, BACK TO DOORS.
- RESIZE AND REPLACE WINDOWS AND WINDOW TYPES BACK TO THE ORIGINAL OPENINGS AND DOUBLE HUNG 6/6 LITE
- · REPAIR CHANGES AND DAMAGE TO THE EXISTING BRICK WALLS TO RETURN THE WALLS TO THEIR ORIGINAL STATE.

THE REAR STAIR ADDITION, REBUILT IN CONCRETE BLOCK IN 1976, WILL BE RETAINED, AND AN ELEVATOR WILL BE ADDED. IN ADDITION, THE BUILDING WILL BE SIDED WITH A PRE-PAINTED, METAL SIDING. TO ACCOMMODATE A NEW MAIN ENTRYWAY, WHICH WILL BE CONSTRUCTED FACING DETROIT STREET, THE EXISTING OPEN-AIR CARPORT (NOT ORIGINAL TO THE BUILDING) WILL BE DEMOLISHED, AND ACCESS FROM THE MAIN ENTRY TO A NEW PARKING AREA AT THE REAR OF THE PROPERTY WILL BE PROVIDED. THE OFFICE ADDITION WILL BE COMPLETELY REBUILT FROM WITHIN TO ALIGN THE FLOORS OF THIS ADDITION WITH THE MAIN BUILDING MAKING IT ACCESSIBLE WITHIN THE BUILDING. A NEW SECOND STORY LEVEL WILL BE ADDED TO THIS AREA, AND THE ENTIRE OFFICE ADDITION WILL ALSO BE SIDED WITH A PRE-PAINTED METAL SIDING. TO MEET ENTRY AND EMERGENCY EXISTING REQUIREMENTS, A NEW STAIR/LOBBY ADDITION WILL BE CONSTRUCTED ON THE NORTH SIDE OF THE BUILDING, AHEAD OF THE EXISTING OFFICE ADDITION. THIS IS PROPOSED AS A TWO STORY SPACE OFFERING ENTRY TO THE FIRST FLOOR AND EGRESS FROM BOTH THE FIRST AND SECOND FLOORS. A BASEMENT LEVEL WILL BE CONSTRUCTED BELOW IT TO POTENTIALLY PROVIDE BARRIER-FREE TOILETS AT THAT LEVEL.

ALONG THE PERIMETER OF THE MAIN BUILDING AND EXISTING GRAVEL PARKING AREA, SEVERAL OLD BLOCK AND TIMBER RETAINING WALLS THAT ARE IN DISREPAIR WILL BE REMOVED AS WILL AN EXISTING PRIVACY FENCE, WHICH IS ALSO IN POOR REPAIR. IMPROVED GRADING OF THE PROPOSED ASPHALT PAVEMENT PARKING LOT AREA, COMPLETE WITH NEW CONCRETE CURB, WILL ELIMINATE THE NEED FOR REPLACING THE OLD WALLS AND IMPROVE THE AESTHETICS OF THE PROPERTY. ADDITIONALLY, A NEW PRIVACY FENCE WILL BE CONSTRUCTED ALONG THE WESTERN PERIMETER OF THE NEW PARKING LOT, AND THAT FENCE WILL BE SOFTENED WITH A VARIETY OF SHRUBS AND TREES. FURTHERMORE, AN ENCLOSED REFUSE CONTAINER STORAGE AREA WILL BE CONSTRUCTED IN THE REAR OF THE PROPERTY, ELIMINATING THE EYESORE OF THE CURRENT ROLL-UP DUMPSTER.

- THE REDEEMER ANN ARBOR PROJECT WILL EMBRACE SUSTAINABLE DESIGN, SYSTEMS, AND MATERIALS AS PART OF THE ADAPTIVE REUSE OF THE EXISTING BUILDING. IMPROVEMENTS WILL INCLUDE:
- . INCORPORATING A BELOW-GRADE INFILTRATION SYSTEM THAT WILL BYPASS THE CITY'S STORM SEWER FOR FIRST FLUSH EVENTS AND REDUCE IMPACT TO THE NEARBY HURON RIVER.
- ENERGY EFFICIENT BUILDING MATERIALS, INCLUDING NEW WINDOWS • A CHARGING STATION IN THE PARKING AREA FOR ELECTRIC CARS.
- EXTERIOR BICYCLE PARKING. • PROXIMITY TO PUBLIC TRANSPORTATION TO MINIMIZE TRAFFIC AND PERSONAL VEHICLE USE.

THE DETROIT STREET AREA IN THE VICINITY OF EAST KINGSLEY STREET AND NORTH DIVISION STREET IS A MIXTURE OF SINGLE FAMILY RESIDENTIAL, MULTI-FAMILY RESIDENTIAL, STUDENT APARTMENTS, AND COMMERCIAL THAT ARE BUFFERED ON EITHER SIDE BY RESIDENTIAL AREAS. RESTORING AND ADAPTING THE ORIGINAL BUILDING WILL IMPROVE THE VISUAL CHARACTER OF THE AREA WHILE MAINTAINING ASPECTS OF THE BUILDING'S ORIGINAL ARCHITECTURAL INTEREST.

COMMUNITY ANALYSIS

- A. THE IMPACT OF THE PROPOSED DEVELOPMENT ON PUBLIC SCHOOLS.
- THE REDEEMER ANN ARBOR MINISTRY IS NOT SPECIFICALLY TARGETING FAMILIES WITH SCHOOL-AGE CHILDREN, BUT IT WILL BE REACHING OUT TO THE COMMUNITY IN GENERAL.
- B. THE RELATIONSHIP OF INTENDED USE TO NEIGHBORING USES. • THE PROPOSED REDEVELOPMENT PROJECT IS SITUATED AMONG A MIXTURE OF SINGLE-FAMILY AND MULTI-FAMILY RESIDENTIAL, INCLUDING ON ADJACENT STREETS TO THE WEST AND EAST. TO THE IMMEDIATE SOUTH BEYOND EAST

STREET, LAND USES BECOME MORE COMMERCIAL AND RETAIL. WITH A MIXTURE OF BOUTIQUE SHOPS, RESTAURANTS, SMALL PROFESSIONAL OFFICES, AND A COMMUNITY HIGH SCHOOL. TO THE IMMEDIATE NORTH IS DEPOT STREET, WHICH RUNS PARALLEL TO THE HURON RIVER. THE MASSING OF THE EXISTING BUILDING AND ITS PROPOSED REUSE ARE SUPPORTED BY HE SURROUNDING BUILDINGS. WHICH. THOUGH MAINLY RESIDENTIAL IN NATURE. HAVE A SIMILAR HEIGHT AND SCALE FURTHER NORTH AND SOUTH ALONG THE SAME BLOCK OF DETROIT STREET. THERE ARE MORE MODERN, SMALL APARTMENT COMPLEXES THAT HAVE A MASSING SIMILAR TO THE EXISTING BUILDING AND ITS PROPOSED REUSE, WITH LARGE BRICK

- AND RECTANGULAR ELEMENTS AS OPPOSED TO TRADITIONAL SINGLE FAMILY ARCHITECTURAL DESIGN.
- AS A R4C-ZONED PARCEL, THE PROPOSED REUSE OF THE BUILDING RETAINS THE EXISTING STREETSCAPE AND PATTERN OF THE EXISTING NEIGHBORHOOD, INCLUDING SIZE AND MASSING.
- C. IMPACT OF ADJACENT USES ON THE PROPOSED DEVELOPMENT . THE CLOSE PROXIMITY OF RESIDENTS AND UNIVERSITY STUDENTS WILL POSITIVELY IMPACT THE REDEVELOPMENT OF THE EXISTING BUILDING INTO A HOUSE OF WORSHIP BY HAVING A SIGNIFICANT NUMBER OF VISITORS ABLE TO WALK OR BIKE TO THE SITE, WHICH WILL LIMIT THE IMPACT ON PARKING.
- D. IMPACT OF THE PROPOSED DEVELOPMENT ON THE AIR AND WATER QUALITY, AND ON EXISTING NATURAL FEATURES OF THE SITE AND NEIGHBORING SITES. . HISTORICALLY, THE EXISTING SITE HAS BEEN MOSTLY IMPERVIOUS, WITH A MIXTURE OF ROOF, CONCRETE DRIVEWAY, AND HARD-PACKED GRAVEL PARKING. RAINFALL HAS BEEN PRIMARILY DIRECTED TO THE REAR OF THE SITE, WHERE IT ENTERS AT THE EXISTING SITE TO CONTAMINATE RUNOFF, THE EXISTING ON—SITE STORM SYSTEM IS OLD AND PROVIDES NO FIRST FLUSH TREATMENT, DETENTION, OR OTHER MECHANISM TO MINIMIZE IMPACT TO THE HURON RIVER. THE PROPOSED
- STORM SEWERS WITHOUT TREATMENT THAT DISCHARGE INTO CITY STORM SYSTEMS. WHILE THERE ARE MINIMAL POLLUTANTS DEVELOPMENT WILL COLLECT THE MAJORITY OF THE SITE'S IMPERVIOUS RUNOFF, INCLUDING FROM THE NEW PARKING LOT, AND COLLECT IT WITHIN A NEW STORM SEWER SYSTEM THAT INCLUDES A PRETREATMENT STRUCTURE FOR DEBRIS, OIL, AND SEDIMENT. DOWNSTREAM OF THE PRETREATMENT STRUCTURE, FIRST FLUSH RUNOFF WILL ENTER A SUBSURFACE INFILTRATION SYSTEM AND FEED THAT WATER INTO PERFORATED PIPES, WHICH CONNECT HYDRAULICALLY TO A NATIVE SAND AND GRAVEL SEAM IN THE SOIL PROFILE. LARGER STORM EVENTS WILL HAVE THE ABILITY TO OVERFLOW INTO ADJACENT STORM PIPES THAT CONNECT WITH THE EXISTING CITY STORM SEWER SYSTEM IN THE DETROIT STREET RIGHT-OF-WAY. THE PROPOSED SYSTEM WILL IMPROVE STORM WATER PERFORMANCE BY INFILTRATING MOST STORM EVENTS ON-SITE.
- THE INCLUSION OF NUMEROUS LANDSCAPE TREES AND AT-GRADE SHRUB PLANTINGS WILL SUPPORT AIR QUALITY. THE PROPOSED DEVELOPMENT INCLUDES PLANTING A STREET TREE ON THE WEST SIDE OF DETROIT STREET TO INFILL A LOCATION WHERE THERE CURRENTLY IS NO TREE. THE PROPOSED LANDSCAPING WILL SUPPORT DETROIT STREET'S EXISTING AESTHETIC, WHICH IS A MIXTURE OF MATURE AND RECENTLY PLANTED TREES.
- . THE ADAPTIVE REUSE DESIGN WILL INCLUDE MULTIPLE ENERGY SAVING FEATURES, WITH AN INTENT TO MINIMIZE THE ENVIRONMENTAL IMPACT OF THE BUILDING. THIS WILL INCLUDE UPGRADING THE EXISTING WINDOWS TO MODERN, ENERGY EFFICIENT MODELS AS WELL AS MORE EFFICIENT HVAC SYSTEMS.
- . THE LOCATION OF THE PROPOSED HOUSE OF WORSHIP IS CONDUCIVE TO WALKING AND BIKING FROM SURROUNDING RESIDENTIAL NEIGHBORHOODS AND THE UNIVERSITY CENTRAL CAMPUS. TO ENCOURAGE THIS, THE PLAN INCLUDES AN AREA FOR BICYCLE PARKING AS WELL AS E/V PARKING. THE PROPOSED DEVELOPMENT IS ALSO LOCATED WITHIN CLOSE PROXIMITY TO BUS STOPS ON BEAKES STREET, NORTH DIVISION STREET, AND DEPOT STREET.
- E. IMPACT OF THE PROPOSED USE ON HISTORIC SITES OF STRUCTURES THAT ARE LOCATED WITHIN A HISTORIC DISTRICT OR LISTED ON THE NATIONAL REGISTER OF HISTORIC PLACES.
- THERE ARE BUILDINGS OF HISTORICAL SIGNIFICANCE ON THE SITE. HOWEVER, THE ORIGINAL BUILDING WAS CONSTRUCTED CIRCA 1861, AND ITS ARCHITECTURE AND SCALE WILL BE RESTORED AND IMPROVED TO ENSURE IT CONTINUES TO MAINTAIN CONSISTENCY WITH OTHER BUILDINGS IN THE HISTORIC DISTRICT. THESE INCLUDE THE QUEEN ANNE STYLE HOUSE AT 522 DETROIT ST. AND THE MILLER & REYER'S PLANNING MILL BUILDING AT 525 DETROIT ST. THE REDEEMER ANN ARBOR BUILDING USE WILL PERPETUATE THE BLEND OF HISTORIC AND NON-HISTORIC, COMMERCIAL, AND RESIDENTIAL
- F. ALL SIDEWALKS ARE TO BE KEPT AND MAINTAINED IN GOOD REPAIR BY THE OWNER OF THE LAND ADJACENT TO AND ABUTTING THE SAME. PRIOR TO THE ISSUANCE OF THE FINAL CERTIFICATE OF OCCUPANCY FOR THIS SITE, ALL EXISTING SIDEWALKS IN NEED OF REPAIR MUST BE REPAIRED IN ACCORDANCE WITH CITY STANDARDS.
- THE PROPERTY CONTAINS TWO HISTORIC STRUCTURES, A HOME AT 521 DETROIT STREET AND THE TREASURE MART BUILDING 525-525 DETROIT STREET. THE EXISTING NATURAL FEATURES ARE COMPRISED OF DOMESTIC LANDSCAPING WHICH INCLUDES. MOWED COOL SEASON GRASS LAWN, LARGE DECIDUOUS TREES, INCLUDING INVASIVE SPECIES, VARIOUS SHRUBBERY AND PERENNIAL FLOWERS. THERE ARE NO WETLANDS, THREATENED OR ENDANGERED SPECIES, FLOODPLAINS OR WATER COURSES. THE SITE GRADES ACROSS THE DEVELOPED PORTION OF THE SITE IS 2-5% WITH THE EXCEPTION OF A STEEP SLOPE, 20% GRADIENT, OCCUPYING THE NORTH CORNER OF THE SITE.

ARCHITECT

COOPER DESIGN INC. 2900 BROCKMAN BLVD ANN ARBOR, MI 48104 CONTACT: GARY L COOPER, ALSA, RA PH: (734) 769-7007 gcooper@cooperdesigninc.com

CIVIL ENGINEER


WASHTENAW ENGINEERING CO, INC 3526 W LIBERTY, STE 400, PO BOX 1128 ANN ARBOR, MI 48106 CONTACT: JOSEPH K. MAYNARD, PE PH: (734) 761-8800 jkm@wengco.com

SITE PLAN FOR CITY PLANNING COMMISSION APPROVAL

HISTORIC PRESERVATION & ADAPTIVE REUSE OF THE FORMER TREASURE MART BUILDING

521 - 525 DETROIT STREET ANN ARBOR, MI 48105

A PART OF THE SOUTHEAST 1/4 OF SECTION 29 CITY OF ANN ARBOR, T2S, R6E WASHTENAW COUNTY, MICHIGAN

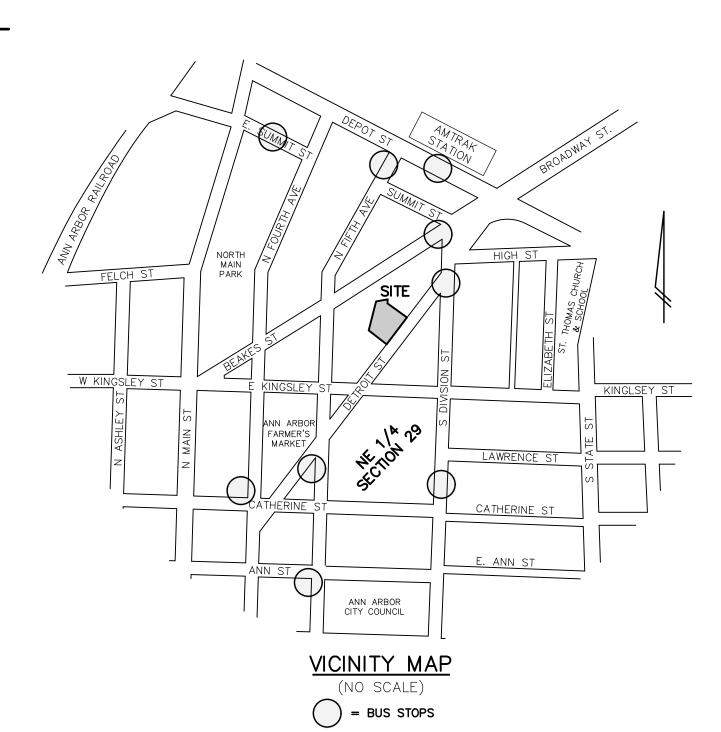

CONSTRUCTION MANAGER

PERKINS CONSTRUCTION COMPANY

CONTACT: GEOFFREY PERKINS

geoff@perkinsconstruction.net

5643 PLYMOUTH ROAD

ANN ARBOR, MI 48105

PH: (734) 769-7760

| SHEET TITLE | DRAWING |
|---|---|
| COVER SHEET ALTA SURVEY BOUNDARY & TOPOGRAPHICAL SURVEY REMOVAL PLAN DIMENSIONAL LAYOUT PLAN NATURAL FEATURES PLAN LANDSCAPE PLAN LANDSCAPE DETAILS GRADING & UTILITY PLAN SOIL EROSION & SEDIMENTATION CONTROL PLAN STORM WATER MANAGEMENT DRAINAGE PLANS INFILTRATION BASIN CALCULATIONS FIRE PROTECTION PLAN DETAILS BUILDING HEIGHTS | C3 C4 C5 C6 C7 C8 |
| ARCHITECTURAL SHEET EXISTING — BASEMENT LEVEL FLOOR PLAN EXISTING — FIRST FLOOR PLAN EXISTING — SECOND FLOOR PLAN EXISTING — BUILDING SECTION 1 EXISTING — EXTERIOR ELEVATIONS 1 EXISTING — EXTERIOR ELEVATIONS 2 BASEMENT LEVEL CONCEPT PLAN FIRST FLOOR CONCEPT PLAN SECOND FLOOR CONCEPT PLAN PROPOSED — EXTERIOR ELEVATIONS 1 PROPOSED — EXTERIOR ELEVATIONS 2 | A.1 A.2 A.3 A.4 A.5 A.6 A.7 A.8 A.9 A.10 A.11 |
| PHOTOMETRIC DI ANI | D 4 |
| PHOTOMETRIC PLAN PHOTOMETRIC DETAILS | P.1 P.2 |



CIVIL ENGINEERS * PLANNERS SURVEYORS * LANDSCAPE ARCHITECTS P.O. BOX 1128 3526 WEST LIBERTY RD, SUITE 400, ANN ARBOR, MICHIGAN 48106 TEL. 734-761-8800 FAX. 734-761-9530 E-MAIL: weco@wengco.com washtenawengineering.com

PROPERTY OWNER & PETITIONER

REDEEMER ANN ARBOR 611 1 EAST WILLIAMS STREET ANN ARBOR, MI 48104 CONTACT: BARTON BRYANT PH: (734) 502-3809 bbryant@redeemera2.org

COMPARISON CHART OF REQUIREMENTS

| | EXISTING | REQUIRED | PROPOSED |
|--|-------------------|---------------------------|-------------------|
| ZONING CLASSIFICATION | R4C | R4C | R4C |
| LOT AREA | 22,160 SF | 8,500 SF | 22,160 SF |
| RESIDENTIAL UNITS (521 DETROIT ST) | 4 | N/A | 4 |
| DENSITY - UNITS PER AC | 2.0 | 20 MAX | 2.0 |
| LOT AREA PER UNIT | 4,432 SF | 2,175 SF MIN. | 4,432 SF |
| OPEN SPACE | 6,495 SF (29%) | 40% MIN. | 9,780 SF (44%) |
| ACTIVE OPEN SPACE | 2,698 SF | N/A | 2,279 SF |
| ACTIVE OPEN SPACE PER UNIT | 540 SF | 300 SF MIN. | 570 SF |
| GROUND FLOOR AREA (521 DETROIT ST) | 1,500 SF | N/A | 1,500 SF |
| GROUND FLOOR COVERAGE (521 DETROIT ST) | 6.8% | N/A | 6.8% |
| GROUND FLOOR AREA (525 DETROIT ST) | 3,000 SF | N/A | 3,224 SF |
| GROUND FLOOR COVERAGE (525 DETROIT ST) | 10.3% | N/A | 10.3% |
| TOTAL FLOOR AREA | 10,946 SF | N/A | 12,260 SF |
| FLOOR AREA (521 DETROIT ST) | 2,546 SF | N/A | 2,546 SF |
| FLOOR AREA (525 DETROIT ST) | 8,400 SF | N/A | 9,714 SF |
| FLOOR AREA RATIO | 37.9% | N/A | 43.8% |
| SETBACKS | | | |
| FRONT (DETROIT ST) | 5.3 FT | 25 FT MIN. | 5.3 FT |
| REAR (WEST) | 32.5 FT | 30.83 FT MIN. | 32.5 FT |
| SIDE (NORTHEAST) | 20.1 FT | 12.83 FT MIN. | 20.1 FT |
| SIDE (SOUTHWEST) | 18.4 FT | 12 FT MIN. | 18.4 FT |
| NUMBER OF BUILDINGS | 2 | N/A | 2 |
| WIDTH BETWEEN BUILDINGS | 43.7 FT | 20 FT MIN. | 43.7 FT |
| WIDTH | 170.72 FT | 60 FT MIN. | 170.72 FT |
| HEIGHT (521 DETROIT ST) | 26'-10" (2 STORY) | 30' MAX. OR 2 STORY | 26'-10" 2 STORY |
| HEIGHT (525 DETROIT ST) | 24'-8" (2 STORY) | 30' MAX. OR 2 STORY | 24'-8" 2 STORY |
| VEHICULAR PARKING | 15 TOTAL | 88 TOTAL | 17 TOTAL |
| 190 SEATS W/ 160 OVERFLOW | 15 REGULAR | 1 SPACE PER 4 SEATS | 8 REGULAR |
| TOTAL 300 SÉATS | 0 BARRIER FREE | 300 SEATS/4 = 75 SPACES | 2 BARRIER FREE |
| ELECTRIC VEHICLE PARKING | 0 ELECTRIC | 15% EV-C | 4 EV-C |
| | | 10% EV-R | 2 EV-R |
| | | 10% EV-1 | 1 EV-1 |
| BICYCLE PARKING | NONE | 7 TOTAL (CLASS C) | 8 TOTAL (CLASS C) |
| | | 1 SPACE PER 50 SEATS | (==:::5 0) |
| | | 300 SEATS/50 = 6 SPACES | |

R4C - MULTIPLE-FAMILY DWELLING

LEGAL DESCRIPTION: LOTS 121 AND 122 OF ASSESSOR'S PLAT NO. 29 ALSO BEING A PART OF THE NORTHEAST 1/4 SECTION 29, T2S, R6E, CITY OF ANN ARBOR, WASHTENAW COUNTY, MICHIGAN AS RECORDED IN BOOK 9 OF PLATS, PAGE 20, WASHTENAW COUNTY PROJECT HAS AN EXISTING NON-CONFORMING FRONT YARD SETBACK.

EXISTING CANOPY IS WITHIN SIDE YARD SETBACK - WILL BE REMOVED SIDE YARD SETBACK OF 12' + 3" FOR EACH FOOT OF BUILDING HEIGHT ABOVE 35 FEET AND 1.5" FOR EACH FOOT OF BUILDING LENGTH

SIDE YARD SETBACK OF 12' + 1.5" FOR EACH FOOT OF BUILDING LENGTH OVER 50 FEET AND REAR YARD SETBACK OF 30' + 1.5" FOR EACH FOOT OF BUILDING WIDTH OVER 50 FEET. REAR YARD SETBACK OF 30' + 1.5" FOR EACH FOOT OF BUILDING HEIGHT OVER 35 FEET AND 1.5" FOR EACH FOOT OF BUILDING WIDTH

SPECIAL EXCEPTION USE PETITION

THE SITE IS LOCATED IN THE R4C (MULTIPLE-FAMILY DWELLING) DISTRICT. THE PROJECT IS SEEKING A SPECIAL EXEMPTION USE FOR A

LANDSCAPE MODIFICATION REQUEST

MODIFICATION REQUEST - SECTION 5.20.4 CONFLICTING LAND USE BUFFER

EXPLANATION: THE EXISTING DRIVEWAY ALONG THE NORTH SIDE OF EXISTING HISTORIC BUILDING OCCUPIES THE ENTIRE SPACE UP TO THE NORTH PROPERTY. THE DRIVEWAY IS NECESSARY TO PROVIDE SAFE AND FUNCTIONAL ACCESS THROUGH THE SITE. IN ADDITION, THE NEIGHBORS EXISTING DRIVEWAY ON THE PARCEL TO THE NORTH ENCROACHES ON THE PETITIONER'S SITE AND THAT ENCROACHMENT WILL REMAIN. THESE STATED CONDITIONS MAKE DEVELOPMENT OF A C.L.U.B. ALONG THE NORTH BOUNDARY IMPRACTICAL.

PROJECT HAS RECEIVED CERTIFICATE OF APPROPRIATENESS FROM HDC ON 8/12/2020

GENERAL NOTES

THE CONSTRUCTION COVERED BY THESE PLANS SHALL CONFORM TO THE CITY OF ANN ARBOR PUBLIC SERVICES DEPARTMENT STANDARD SPECIFICATIONS, WHICH ARE INCLUDED BY REFERENCE. THE OMISSION OF ANY CURRENT STANDARD DETAILS DOES NOT RELIEVE THE CONTRACTOR OF THIS REQUIREMENT. THE WORK SHALL BE PERFORMED IN COMPLETE CONFORMANCE THE THE CURRENT PUBLIC SERVICE DEPARTMENT STANDARD SPECIFICATIONS AND DETAILS.

LINE STOPS SHALL BE INSTALLED WHERE EXISTING WATER MAINS CANNOT BE SUFFICIENTLY ISOLATED TO COMPLETE THE WORK. THE COST OF ANY LINE STOP INSTALLATION IS THE RESPONSIBILITY OF THE DEVELOPER AND/OR CONTRACTOR.

PAVEMENT MARKINGS DISTURBED AS A RESULT OF PAVEMENT CUTS OR CONSTRUCTION ACTIVITIES SHALL BE REPLACED AS DIRECTED BY PROJECT MANAGEMENT OR THE MICHIGAN DEPARTMENT OF TRANSPORTATION. REPLACEMENT DURING CONSTRUCTION OF THE PROJECT MAY BE CONSIDERED TEMPORARY, WITH FINAL PAVEMENT MARKING RESTORATION TO OCCUR AT THE END OF THE PROJECT.

THE CONTRACTOR SHALL TAKE ALL NECESSARY PRECAUTIONS TO PROTECT THE EXISTING PUBLIC ROAD PAVEMENT. DAMAGE TO THE

PUBLIC ROAD PAVEMENT DURING THE COURSE OF CONSTRUCTION MAY NECESSITATE RESURFACING OF THE DAMAGED AREAS PRIOR TO ISSUANCE OF THE CERTIFICATE OF OCCUPANCY. CONFIRM WHERE STAGING WILL OCCUR FOR CONSTRUCTION AND NOTE IF A CRANE WILL BE NEEDED. IF A CRANE WILL BE USED FOR CONSTRUCTION PURPOSES AND IT IS NECESSARY TO LOCATE IT IN THE PUBLIC RIGHT-OF-WAY, A TEMPORARY LICENSE AGREEMENT MAY

A RIGHT-OF-WAY PERMIT WILL BE REQUIRED FOR ANY AND ALL WORK WITHIN THE PUBLIC RIGHT-OF-WAY, INCLUDING WORK ON PUBLIC

TRAFFIC IMPACT STATEMENT

FOR THE EXISTING AND PROPOSED BUILDING USES, TRIP GENERATION WAS ESTIMATED USING STANDARD RATES PUBLISHED BY THE INSTITUTE OF TRANSPORTATION ENGINEERS IN THE TRIP GENERATION MANUAL, 10TH EDITION. FOR THE EXISTING TREASURE MART, WHICH PRIOR TO ITS CLOSURE SOLD A MIXTURE OF ANTIQUES, VINTAGE CLOTHING, AND OTHER SMALL ITEMS, CONSIDERATION WAS GIVEN TO UTILIZING LAND USE (LU) 890 FURNITURE STORE, LU 876 APPAREL STORE, LU 815 FREE-STANDING DISCOUNT STORE, AND LU 814 VARIETY STORE. HOWEVER, FOR EACH OF THESE LAND USES, THEIR DESCRIPTIONS AND CORRESPONDING TRAFFIC STUDIES REFLECT BIG-BOX STORES THAT ARE SIGNIFICANTLY LARGER AND HAVE CONSIDERABLY MORE SPACE DEDICATED TO EACH ITEM OF MERCHANDISE, WHILE THE TREASURE MART TENDED TO HAVE MANY SMALL ITEMS DISPLAYED IN A MUCH SMALLER SPACE. BECAUSE OF THE SIGNIFICANTLY LARGE BUILDING SIZES OBSERVED IN THE TRAFFIC STUDIES THAT MAKE UP THE DATA FOR THE ABOVE LAND USE CATEGORIES AND THE MUCH SMALLER NATURE OF THE TREASURE MART, THE TRIP GENERATIONS FROM EACH OF THOSE CATEGORIES MAY REFLECT A MUCH HIGHER ESTIMATION OF VEHICLES IN THE AM AND PM PEAK HOURS THAN WAS EXPERIENCED AT THE SITE AND THEREFORE HAVE NOT BEEN UTILIZED.

THE LU 820 SHOPPING CENTER DATA IS COMPRISED OF NUMEROUS TRAFFIC STUDIES, MANY OF WHICH ARE OF SIMILAR SIZE TO THE TREASURE MART. WHILE LU 820 MAY ENCOMPASS A WIDE VARIETY OF BUILDING USES, INCLUDING SMALL SPECIALTY RETAIL, BANKS, RESTAURANTS, AND SMALL OFFICES, THIS LAND USE DATA WAS DEEMED MOST APPROPRIATE TO APPLY TO THE TREASURE MART. FOR THE PROPOSED BUILDING REUSE FOR REDEEMER ANN ARBOR, LU 560 CHURCH WAS UTILIZED. A COMPARISON OF EXISTING AND PROPOSEI TRIP GENERATION DURING WEEKDAY PEAK HOURS AS WELL AS SATURDAY AND SUNDAY PEAK HOUR OF GENERATOR ARE PROVIDED BELOW

| LAND USE | UNITS | | | | (HOUR TRAFFIC) | WEEKDA (ADJACEN | | | | UNITS | | RDAY F F GENE | | | | AY PE | | |
|-----------------|----------|------|-------|-----|--------------------|--------------------|-------|-----|-----|----------|------|------------------|-----|-----|------|-------|-----|-----|
| | | RATE | TRIPS | IN | OUT | RATE | TRIPS | IN | OUT | | RATE | TRIPS | IN | OUT | RATE | TRIPS | IN | OUT |
| EXISTING | | | | 62% | 38% | | | 48% | 52% | | | | 52% | 48% | | | 49% | 51% |
| SHOPPING CENTER | 8.4 KSF | 0.94 | 8 | 5 | 3 | 3.81 | 32 | 15 | 17 | 8.4 KSF | 4.50 | 38 | 20 | 18 | 2.79 | 24 | 11 | 13 |
| PROPOSED | | | | 60% | 40% | | | 45% | 55% | | | | 59% | 41% | | | 50% | 50% |
| CHURCH | 9.7 KSF | 0.33 | 3 | 2 | 1 | 0.45 | 4 | 2 | 2 | 9.7 KSF | 2.78 | 27 | 16 | 11 | 9.99 | 97 | 48 | 49 |
| NET CHANGE | +1.3 KSF | | -5 | -3 | -2 | | -28 | -13 | -15 | +1.7 KSF | | -11 | -4 | -7 | | 73 | 37 | 36 |

AS INDICATED IN THE ABOVE TABLE, THE PROPOSED REUSE OF THE BUILDING AS A CHURCH SHOULD RESULT IN SIGNIFICANTLY FEWER NUMBER OF TRIPS TO THE SITE DURING THE WEEKDAY AM AND PM PEAK HOURS AS WELL AS FEWER TRIPS ON SATURDAYS. THE SITE WILL EXPERIENCE A SIGNIFICANT INCREASE IN TRIPS ON SUNDAYS AS A RESULT OF WORSHIP SERVICES, BUT THE NET IMPACT FOR THE SITE WILL BE AN OVERALL REDUCTION IN TRIPS THE OTHER DAYS OF THE WEEK. THE IMPACT OF NEARBY PUBLIC TRANSPORTATION, A SIGNIFICANT RESIDENTIAL AND UNIVERSITY POPULATION WITHIN WALKING DISTANCE OF THE PROPOSED CHURCH, AND THE PROXIMITY OF PUBLIC PARKING AREAS MAY SERVE TO LOWER THE ESTIMATED NUMBER OF VEHICLE TRIPS




REVISED: 08-24-2022 REVISED: 07-25-2022 REVISED: 02-03-2022 ORIGINAL: 11-15-2021

0

0

0

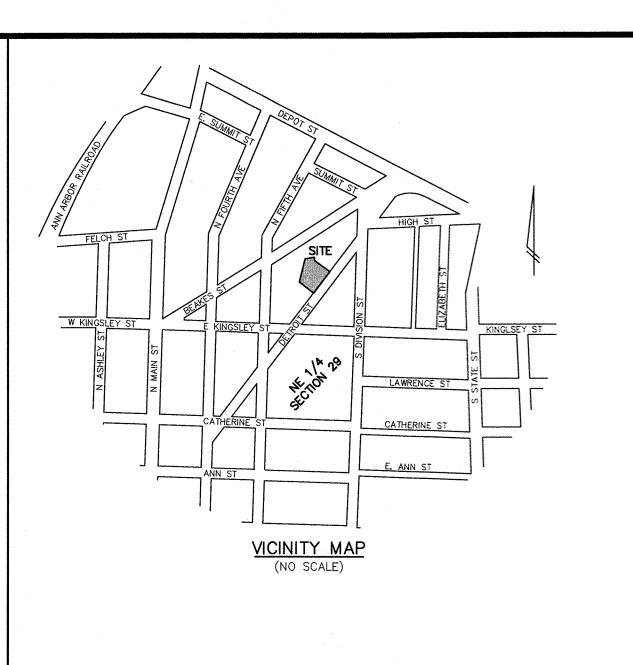

"CORMATION AND EXISTING RECORDS. THE SURVEYOR MAKES UTILITIES IN THE AREA, EITHER IN-SERVICE OR ABANDONED. SHOWN ARE IN THE EXACT LOCATION INDICATED. ALTHOUGHSIBLE FROM INFORMATION AVAILABLE. THE SURVEYOR HAS

THE UNDERGROUND UTLITIES SHOWN HAVE BEEN LOCATED FROM FIELD SURVEY IN NO GUARANTEES THAT THE UNDERGROUND UTLITIES SHOWN COMPRISE ALL SUCH THE SURVEYOR FURTHER DOES NOT WARRANT THE UNDERGROUND UTLITIES THE SURVEYOR DOES CERTIFY THAT THEY ARE LOCATED AS ACCURATELY AS POSN NOT PHYSICALLY LOCATED THE UNDERGROUND UTLITIES.

- 1. Absolute Title inc. file no. 89201N* revision. 1 dated December 30, 2020 with an effective date of October 1, 2020 was used in the preparation of this survey.
- 2. An 8" storm sewer running west from the rear parking lot of Lot 122 is without benefit of an easement disclosed within furnished title work. Storm sewer is shown on
- 3. Fence of unknown ownership lies east of property line near the southwest corner of Lot 121. See Note 4. Fence is shown on drawing.
- 4. Owner of Lot 120 disclosed her and her husband had purchased a triangular portion of property from the owner of the Lot 121. Furnished title work does not reflect this boundary adjustment.
- 5. Stone retaining wall of variable thickness and various state of disrepair along westerly property line. Determination of occupation is not possible without significant effort of excavation and unearthing the easterly line of the top of wall.
- 6. Chain link fence runs south of north property line. Fence is shown on the drawing.
- 7. Wood retaining wall along Northern property line is south of property line. Wall is
- 8. Block/stone retaining wall serving parcel (partially in disrepair), extends north of property line 0.3' +/- for approximately 20 feet.
- 9. South line of gravel driveway along north property line is south of the property line. Gravel drive is shown on the drawing.

Lots 121 and 122 of Assessor's Plat No. 29 also being a part of the Northeast 1/4 Section 29, T2S, R6E, City of Ann Arbor, Washtenaw County, Michigan as recorded in Book 9 of Plats, Page 20, Washtenaw County Records.


CERTIFICATION
To Absolute Title Inc., Perkins Construction, City of Ann Arbor,

This is to certify that this map or plat and the survey on which it is based were made in accordance with the 2021 Minimum Standard Detail Requirements for ALTA/NSPS Land Title Surveys, jointly established and adopted by ALTA and NSPS, and does not contain any items of Table A thereof. The field work was completed on September 15, 2021.

Date of Plat or Map: September 16, 2021

Robert Aaron Wanty, P.S. Michigan No. 65549



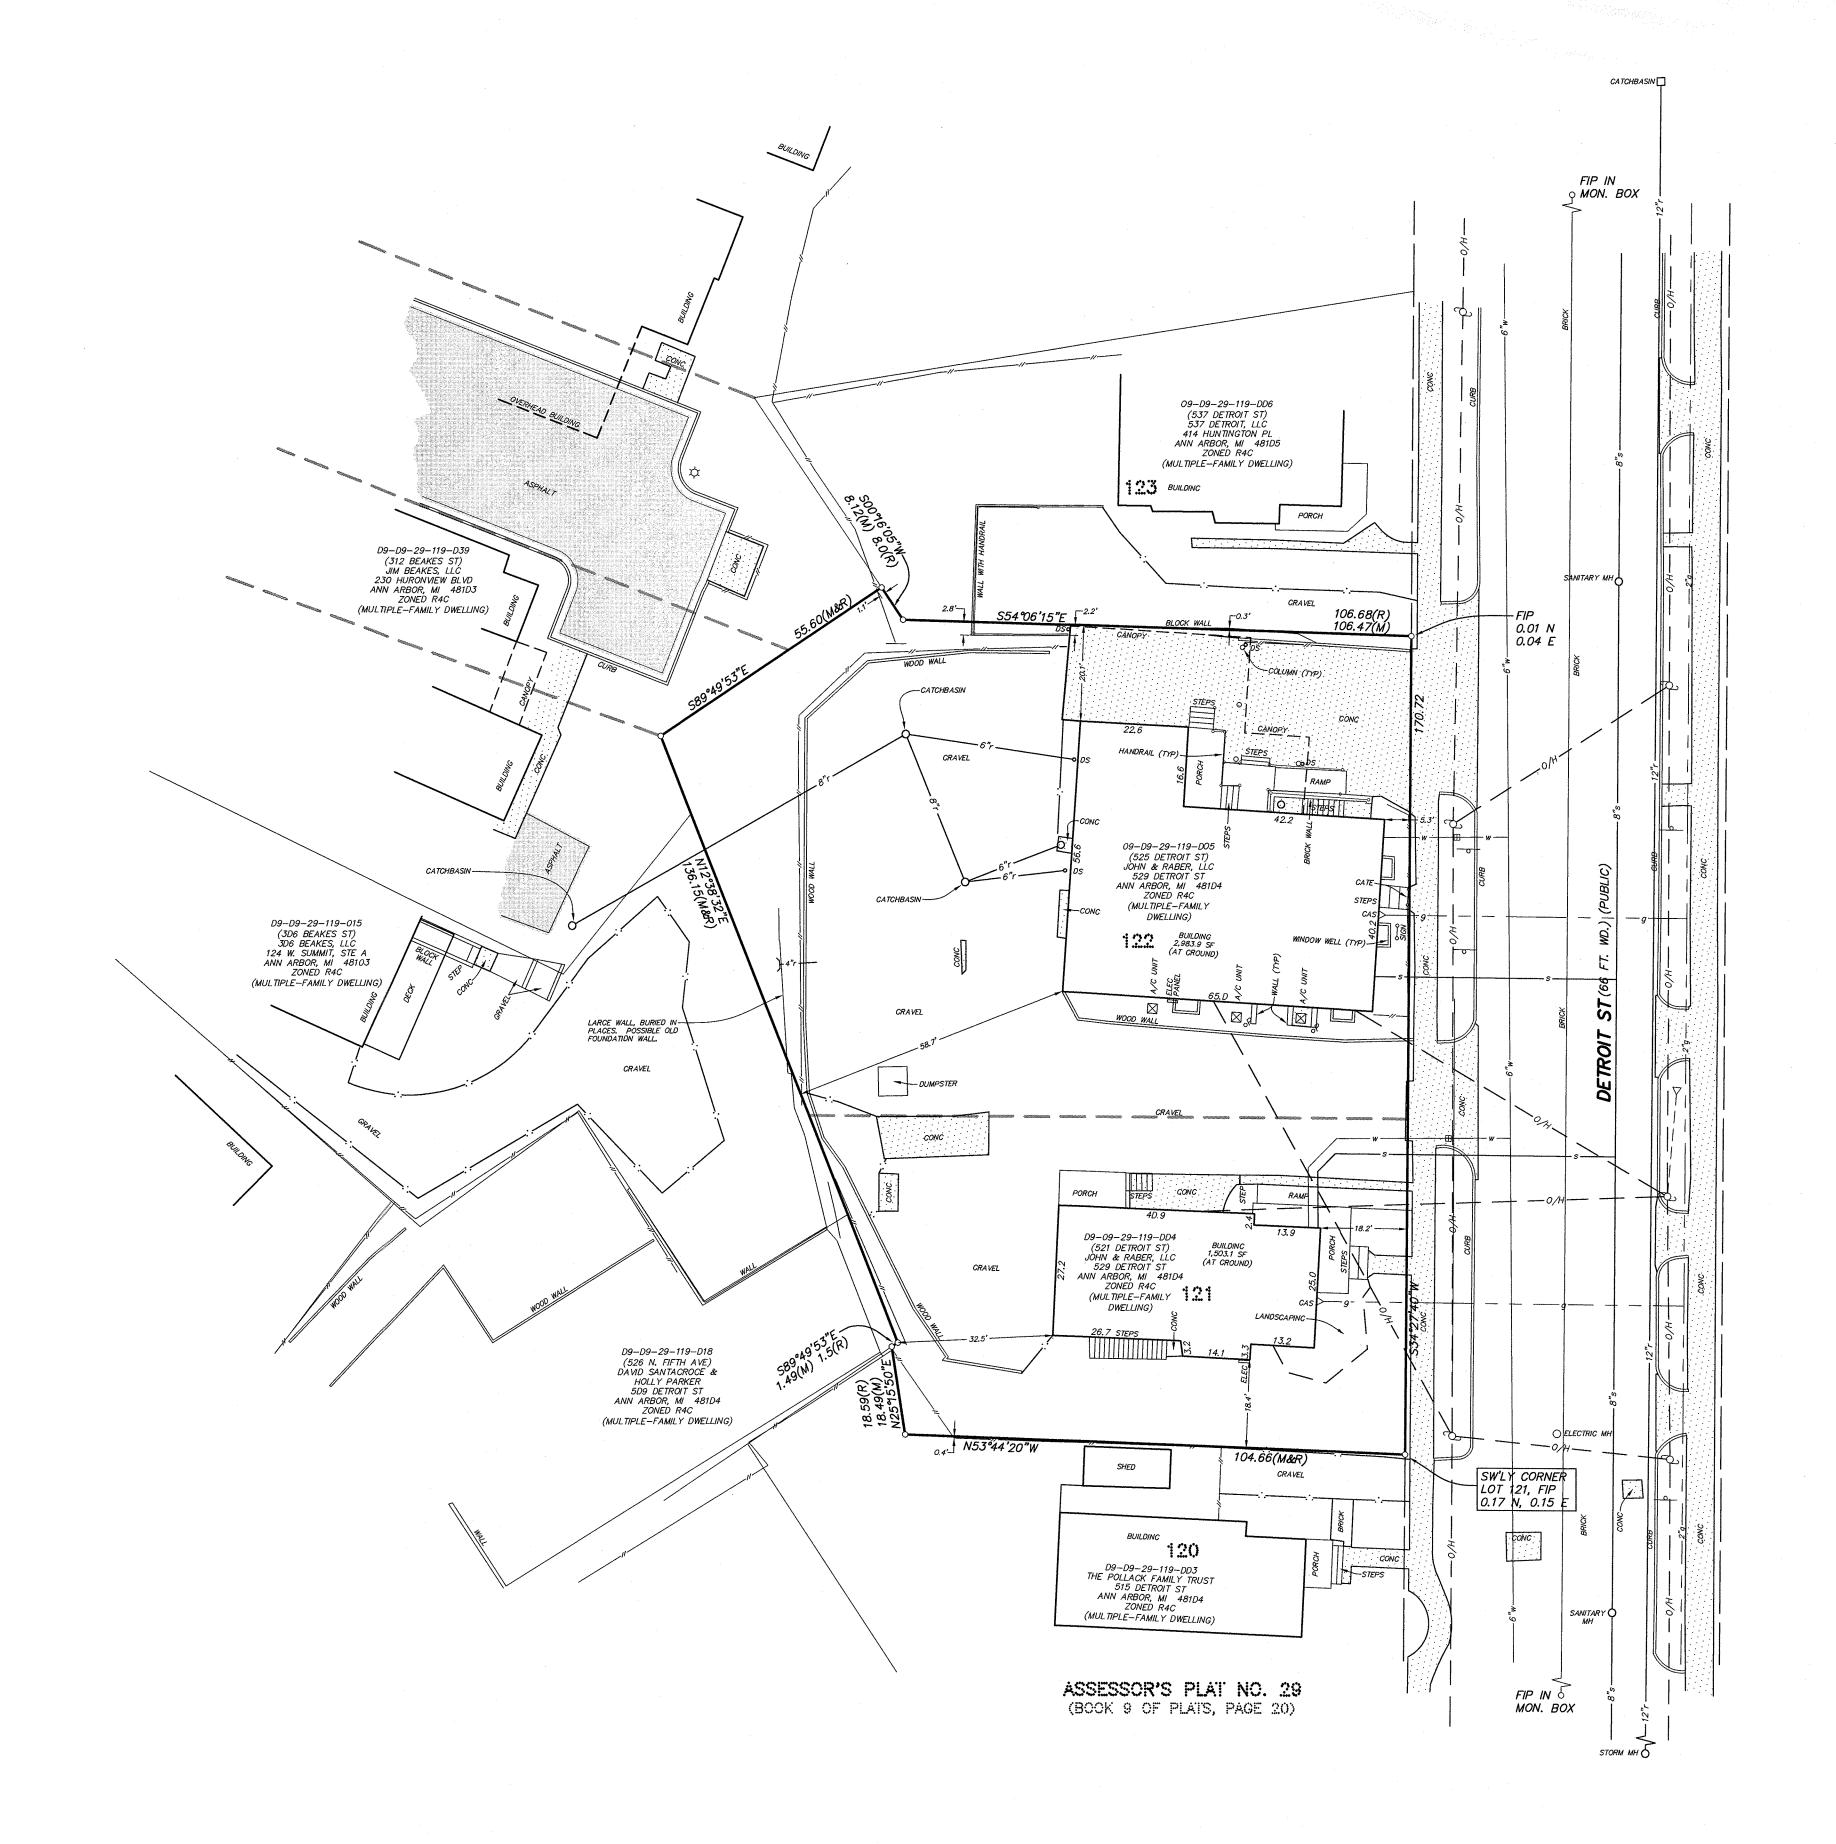

REVISIONS .

REDEEMER ANN ARBOR HISTORIC PRESERVATION & ADAPTIVE REUSE

Know what's below.

Call before you dig.

TC = TOP OF CURB TW = TOP OF WALL-:.— :.— = GRAVEL -<u>// - // = FENCE</u> $p^{0} = SPOT ELEV.$ $\Leftrightarrow = LIGHT POLE$ = CONCRETE o = MANHOLE $\Box = CATCHBASIN$ $- = GUY \ ANCHOR \otimes = GATE \ VALVE$ = ASPHALT


BENCHMARK BM1=NAIL IN S'LY FACE OF 12" MAPLE, NEAR NW'LY CORNER OF SITE, BM2=NAIL IN W'LY FACE OF UTILITY POLE, NEAR NE'LY CORNER OF SITE, ELEV=820.28. ---- e ---- = EXISTING ELECTRIC t ---- = EXISTING TELEPHONE DATUM=NAVD 88


SCALE


JOSEPH K. MAYNARD P.E., MICH No. 52559

 $\overline{}$ = END SECTION

PREPARED BY. SCALE: 1"=10'

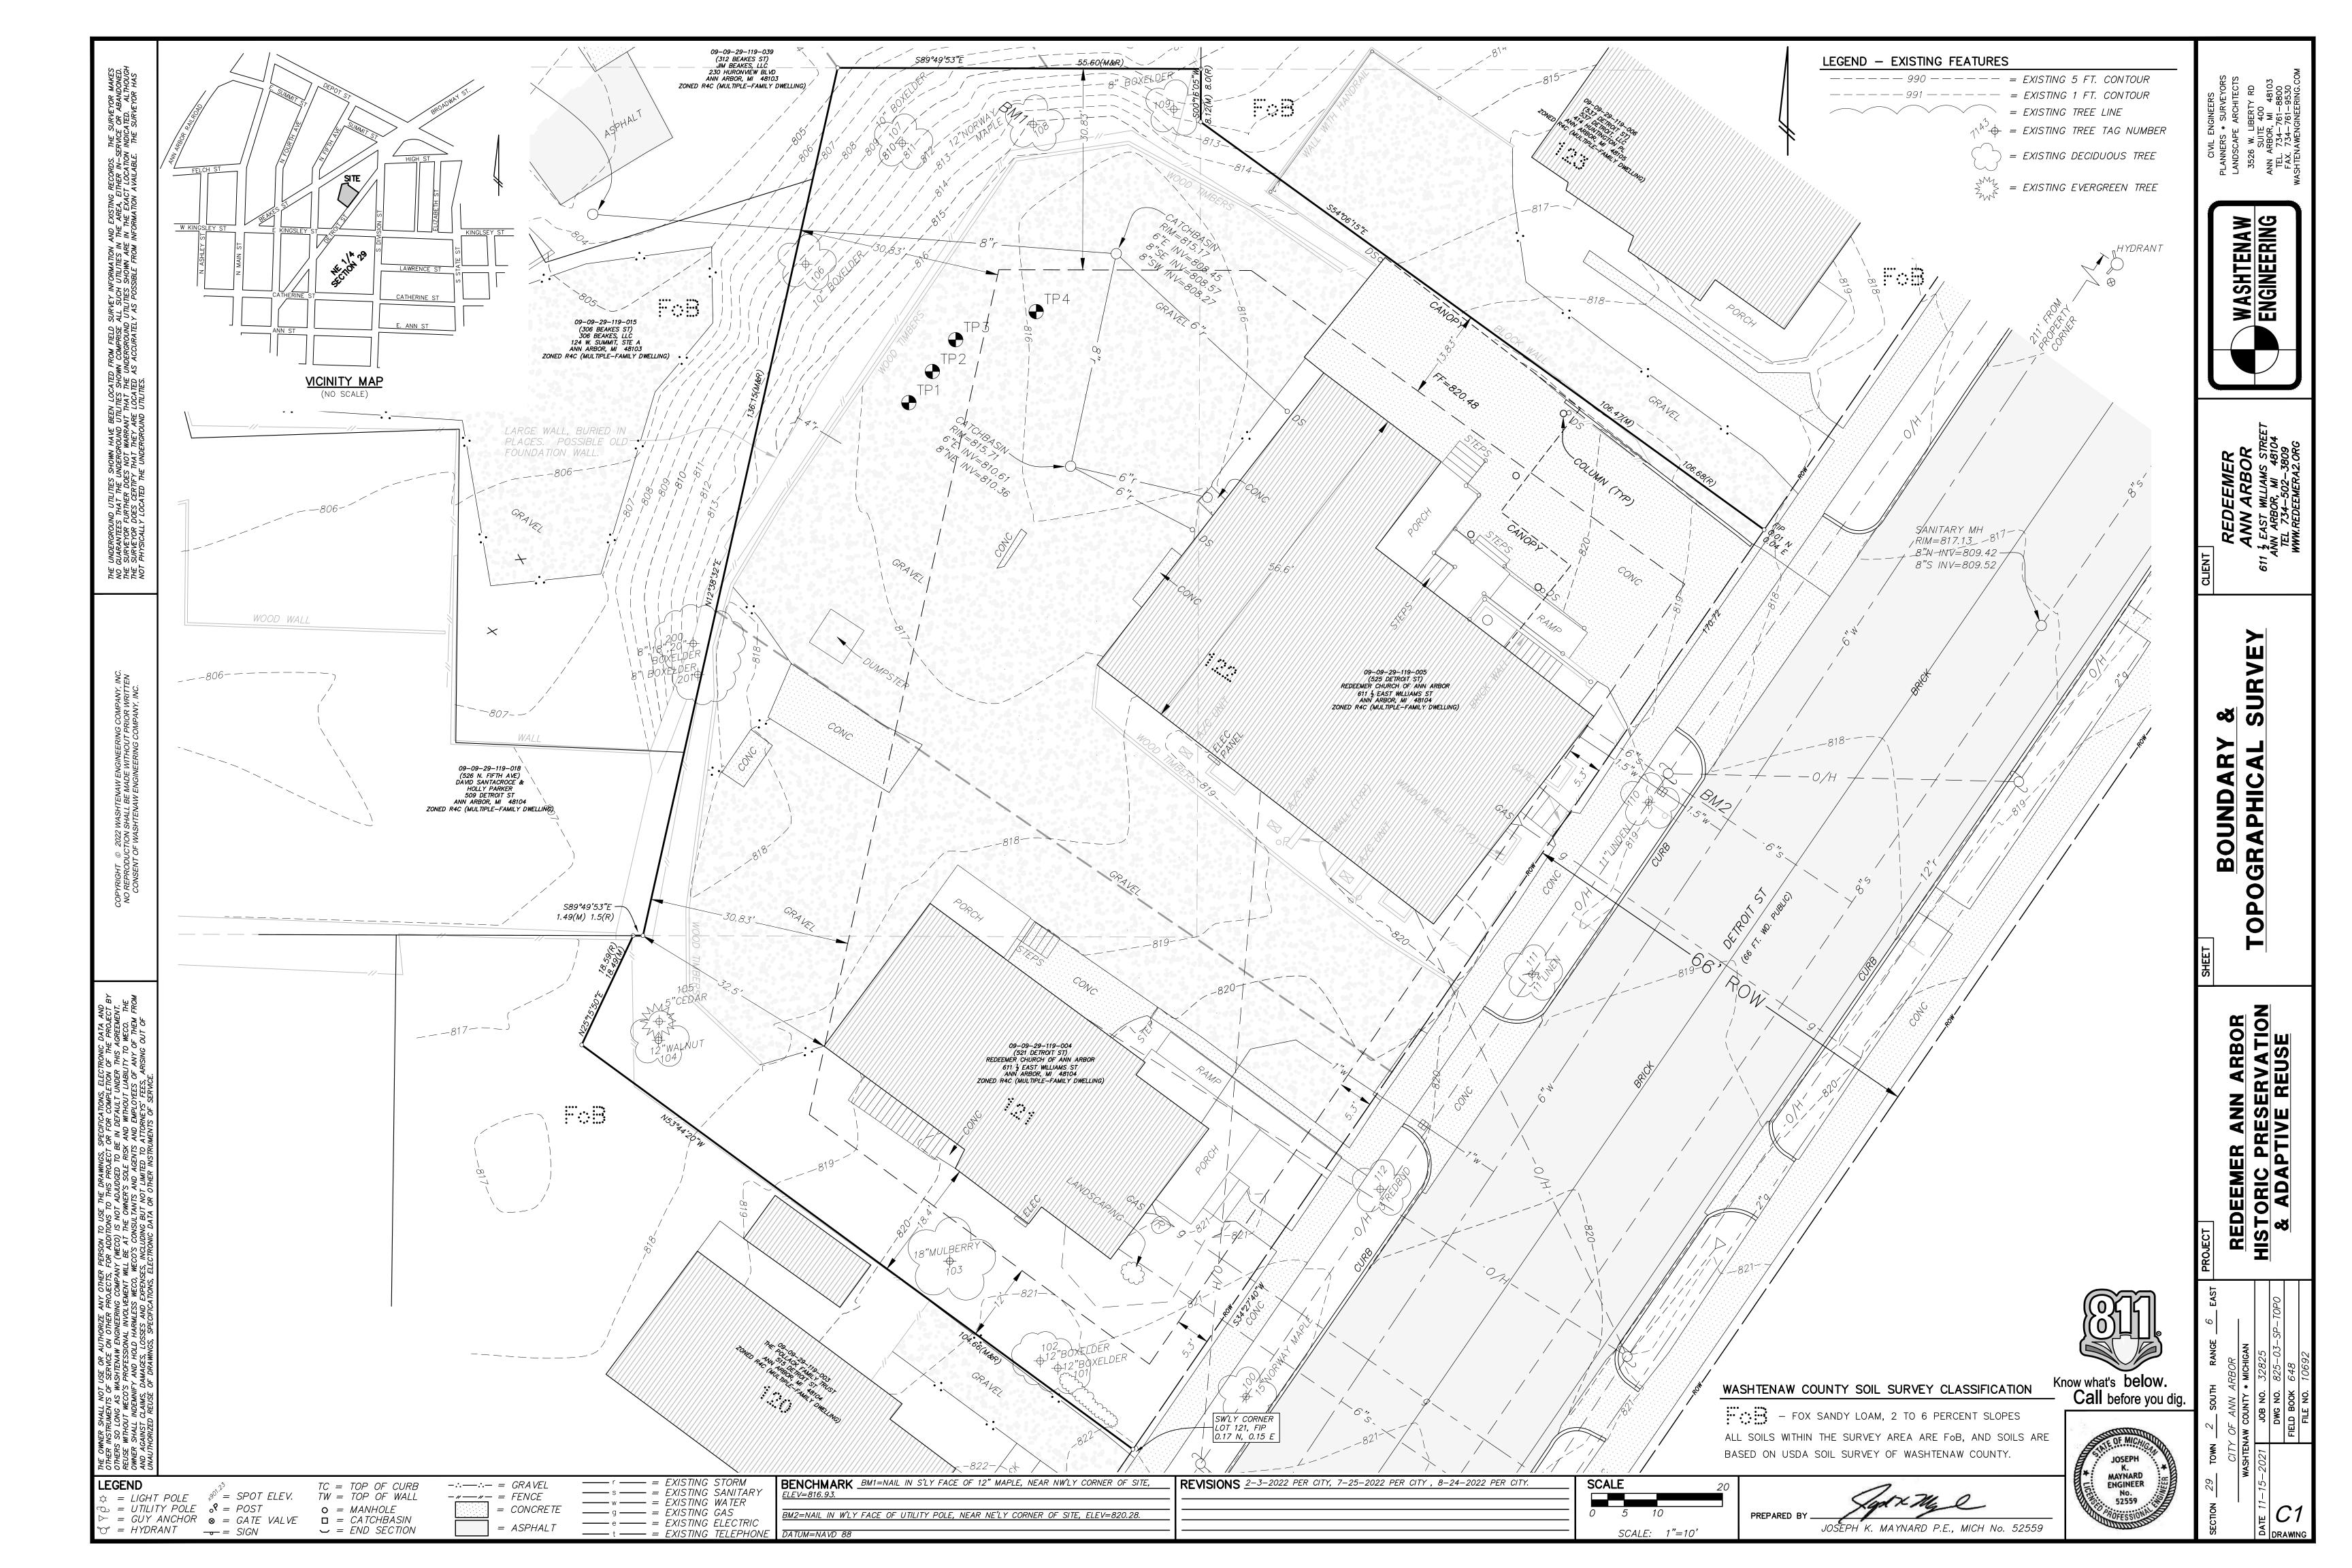

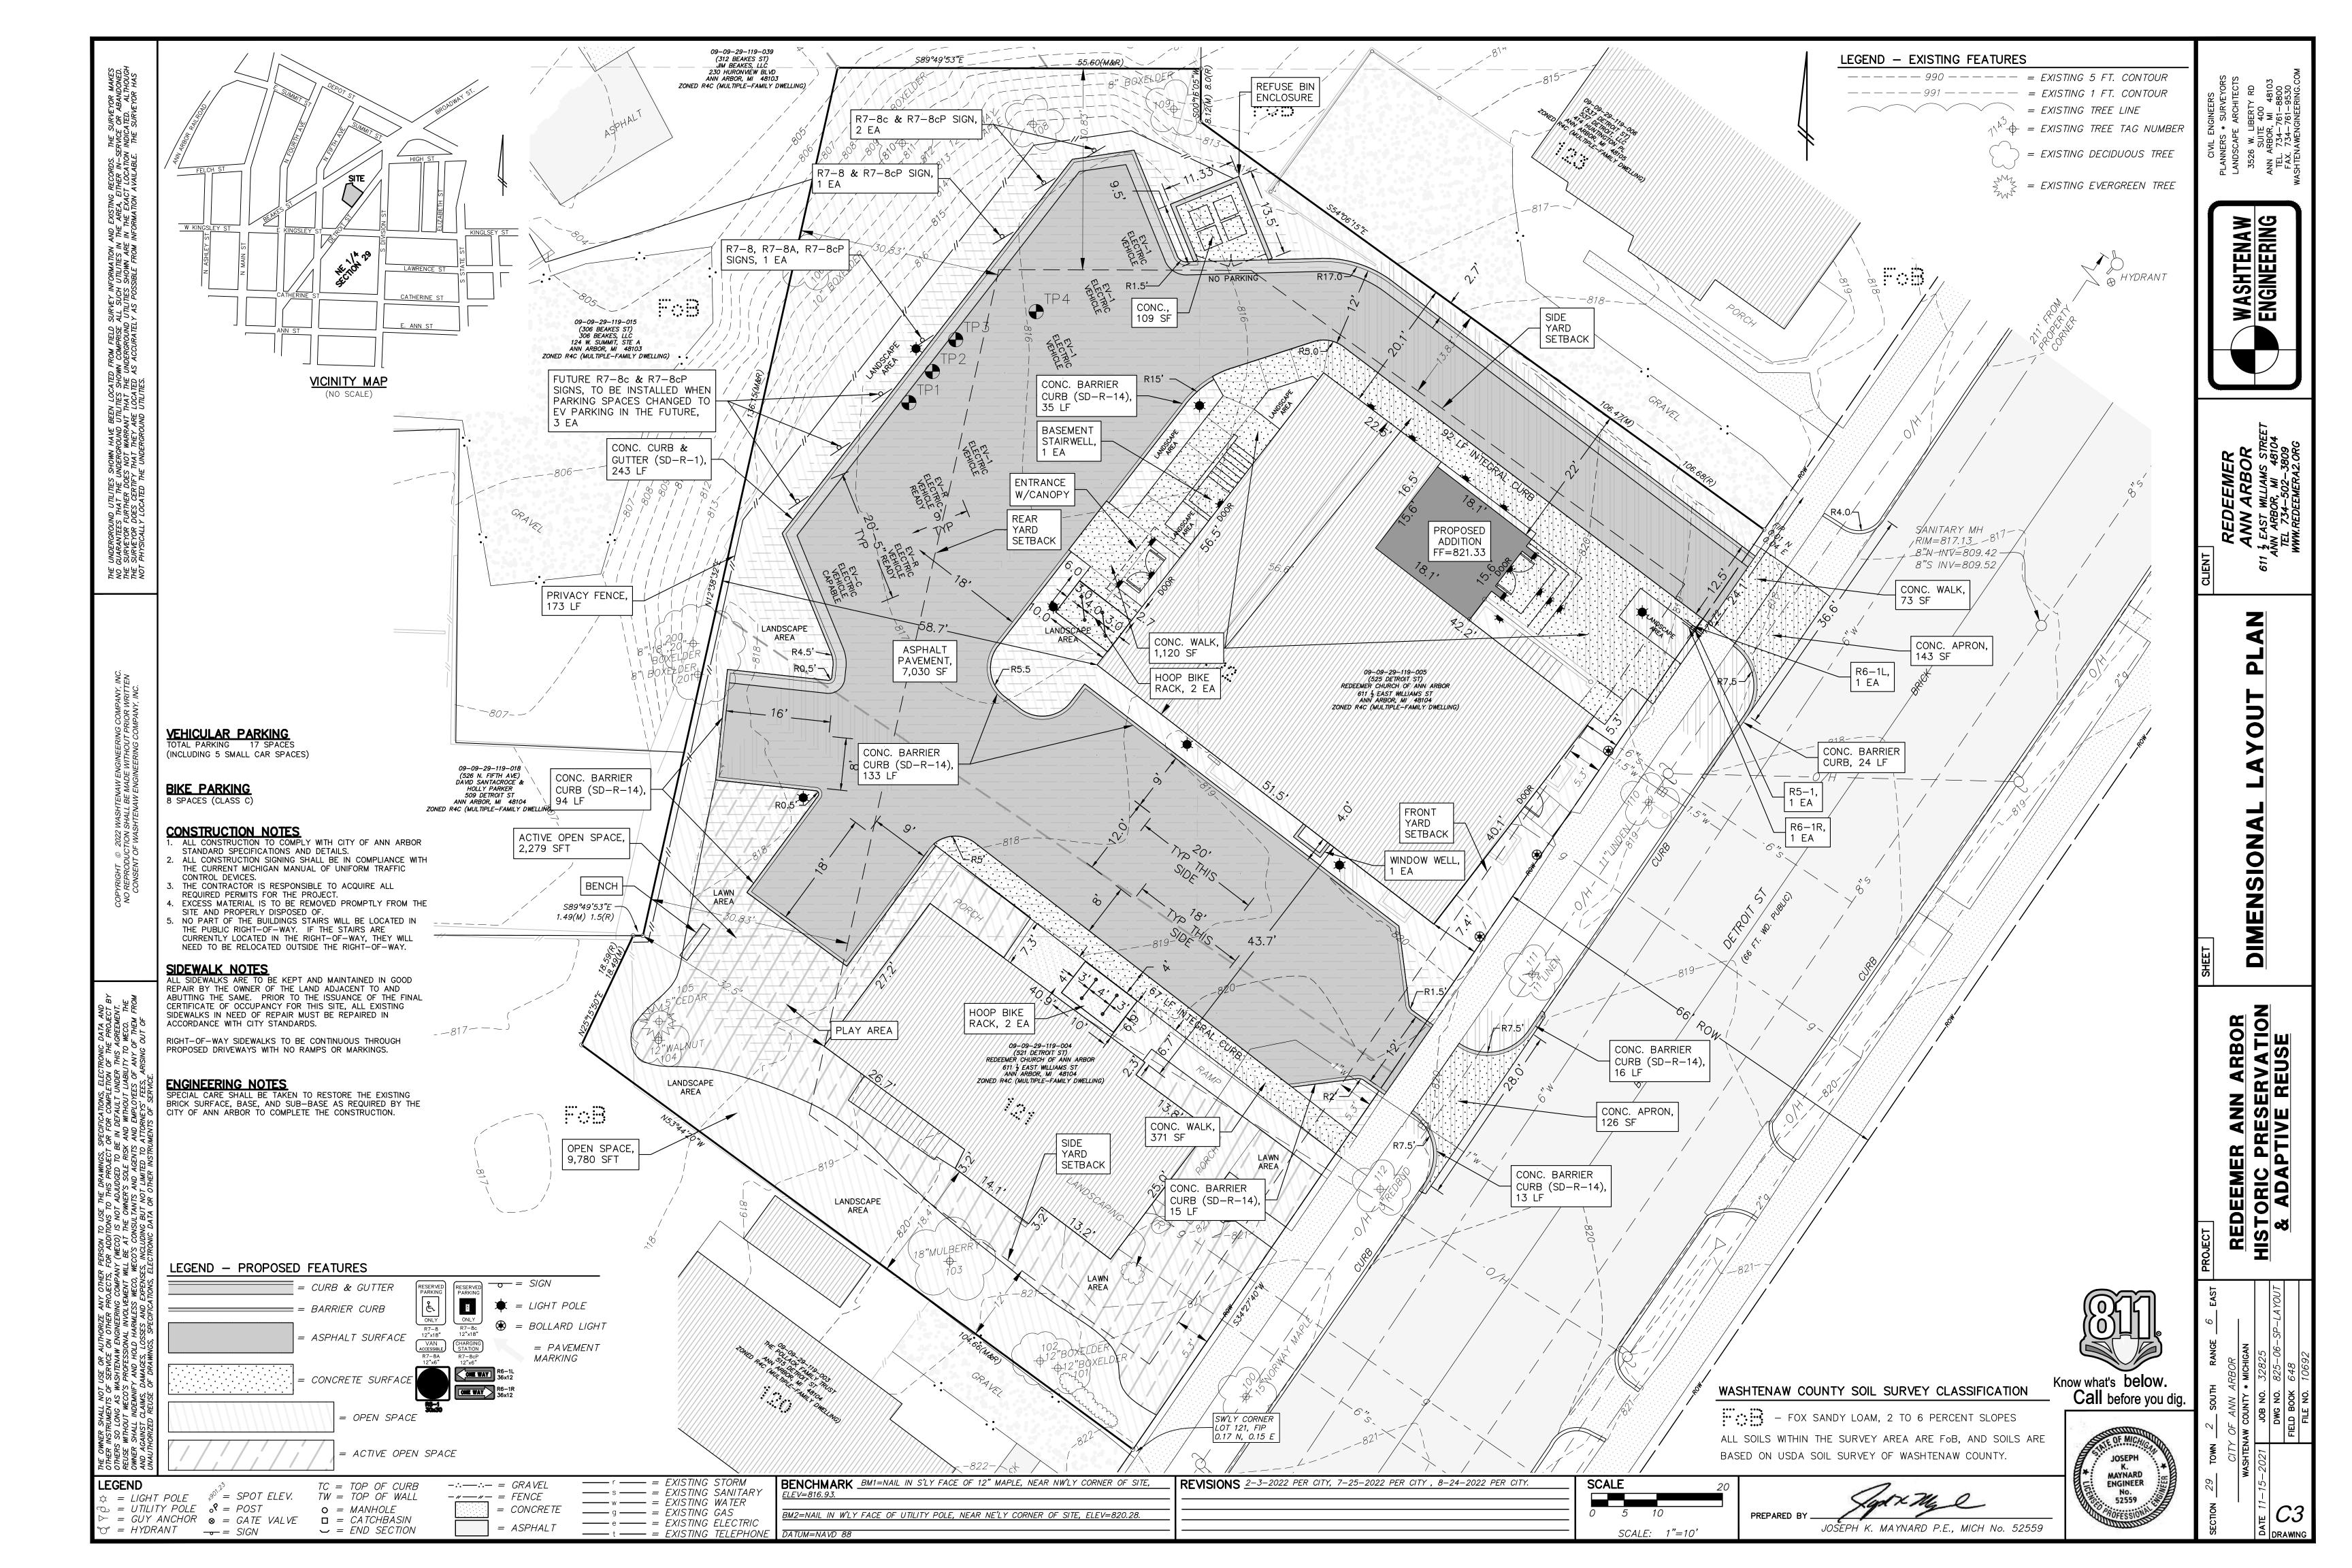

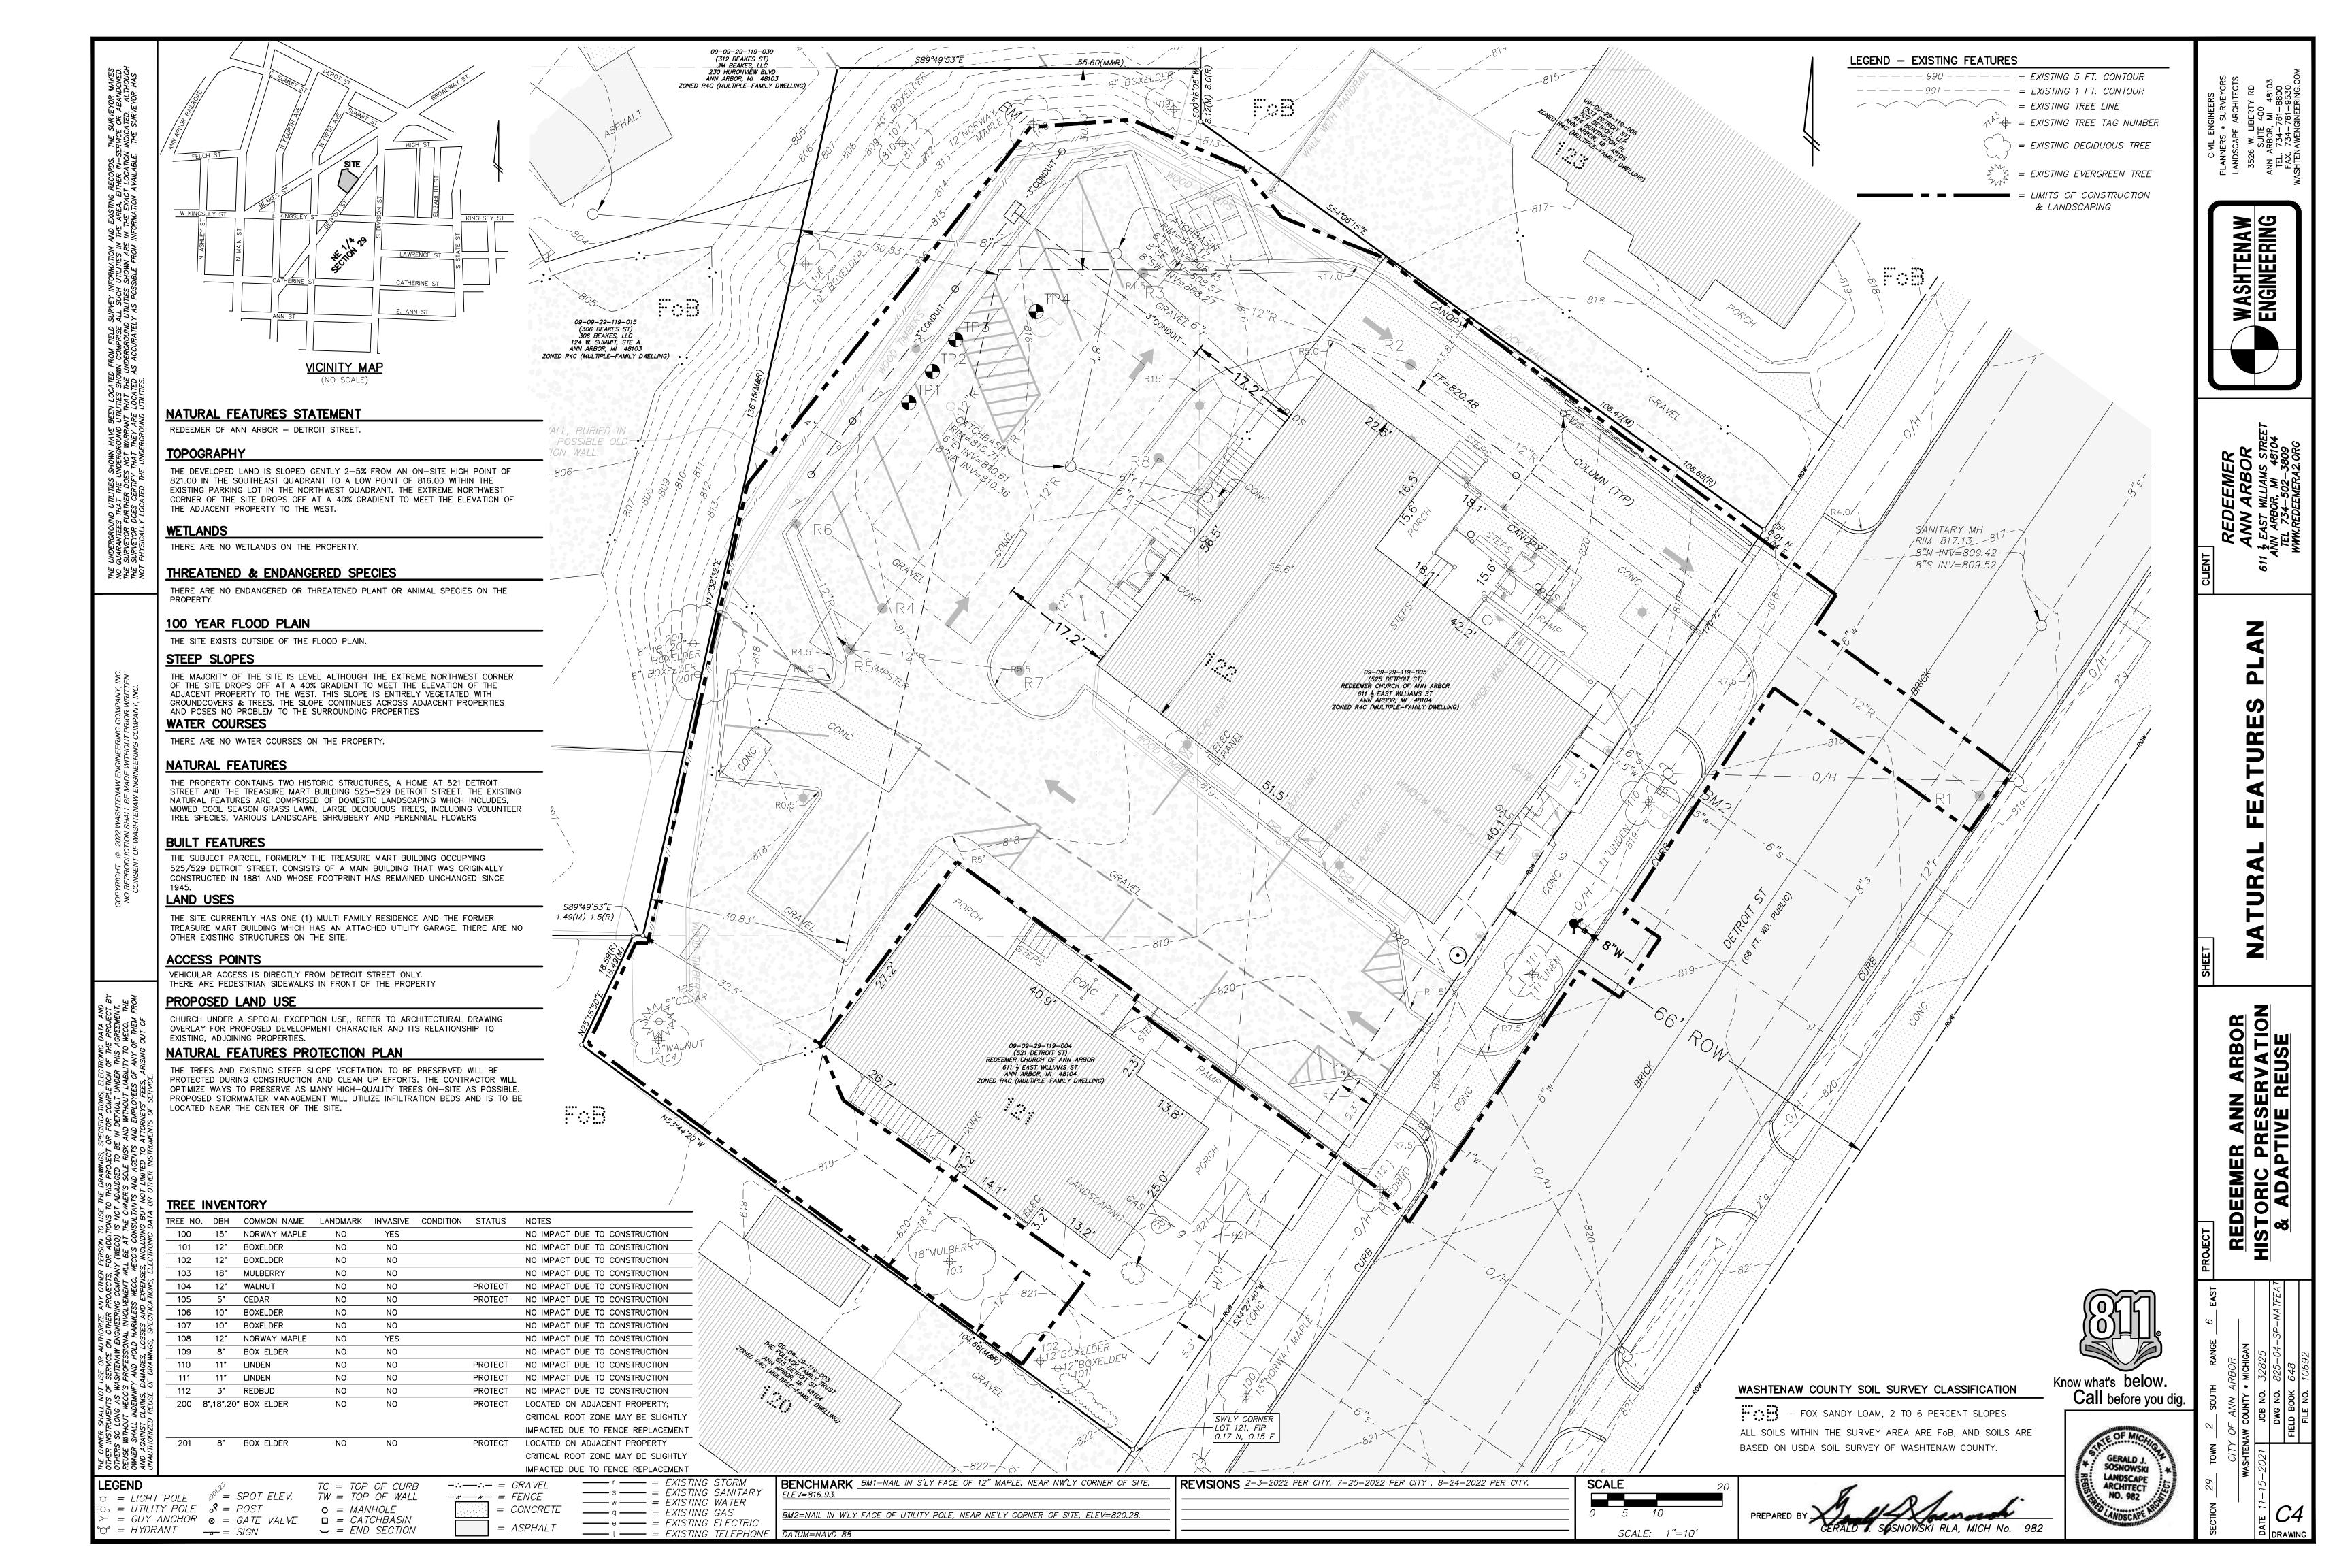

| LANDSCAPING AND SCREENING | REQUIREME | NTS | |
|--|--------------|----------|--------------|
| | REQUIRED | EXISTING | PROPOSED |
| 5.20.3.B VECHICULAR USE AR | EA (VUA) | | |
| VUA SIZE (SQ. FT.) | N/A | 6,722 | 5,884 |
| SQUARE FEET OF INTERIOR LANDSCAPE ISLAND | 750 SF | 0 | 750 SF |
| SQUARE FEET OF DEPPRESSED BIO-RETENTION INTERIOR | | | |
| LANDSCAPE ISLANDS (BIO-RENTENTION ISLANDS REQUIRED IF THE | N/A | N/A | N/A |
| INTERIOR LANDSCAPE ISLAND REQUIRMENT IS GREATER THAN 750 | | | |
| NUMBER OF INTERIOR LANDSCAPE ISLANDS TREES | 3 TREES | 0 | 3 TREES |
| SQ. FT. / 250 SQ. FT. = OR TREES | 3 INCES | 0 | 3 INCES |
| VUA INTERIOR ISLAND AND BIO-RENTENTION ISLAND CALCULATIONS | 882 SF | 0 SF | INFILTRATION |
| SQ. FT. X 15% = SQ. FT. VUA ISLANDS | 00Z 3F | USF | BED 1,540 |
| DEPRESSED BIO-RENENTION ISLAND CALCULATIONS | 375 SF | 0 SF | INFILTRATION |
| SQ. FT. X 50% = SQ. FT. | 3/3 3F | 0.3F | BED 1,540 |
| 5.20.4 CONFLICTING LAND USE BI | UFFER (CLUB) | | |
| NORTH PROPERTY LINE | | | |
| LENGTH OF CONFLICTION LAND USE BUFFER | 0 | 162' | 162' |
| WIDTH OF CONFLICTING USE BUFFER | 15 FT. MIN | N/A | VARIES |
| CLUB TREES | 8 | 3 | 2 |
| (1 TREE FOR EVERY 15 LINEAR FT OF CLUB; 50% MUST BE EVERGREEN) | 0 | 3 | |
| HEDGE, LANDFORM BERM, WALL, FENCE OR COMBINATION IF | FENCE | 0 | 6' FENCE |
| HEDGE/SHRUBS USED, NUMBER OR SHRUBS | PENCE | 0 | O PENCE |
| WEST PROPERTY LINE | | av. | |
| LENGTH OF CONFLICTION LAND USE BUFFER | 0 | 155' | 155' |
| WIDTH OF CONFLICTING USE BUFFER | 15 FT. MIN | 15' | VARIES |
| CLUB TREES | 11 | 4 | 7 |
| (1 TREE FOR EVERY 15 LINEAR FT OF CLUB; 50% MUST BE EVERGREEN) | 11 | 4 | , |
| HEDGE, LANDFORM BERM, WALL, FENCE OR COMBINATION IF | 6' FENCE | 0 | 34 SHRUBS |
| HEDGE/SHRUBS USED, NUMBER OR SHRUBS | O FENCE | | 6' FENCE |
| SOUTH PROPERTY LINE | | 223 | |
| LENGTH OF CONFLICTION LAND USE BUFFER | 0 | 105' | 105' |
| WIDTH OF CONFLICTING USE BUFFER | 15 FT. MIN | 15' | 15' |
| CLUB TREES | 7 | 5 | 2 |
| (1 TREE FOR EVERY 15 LINEAR FT OF CLUB; 50% MUST BE EVERGREEN) | , | 3 | |
| HEDGE, LANDFORM BERM, WALL, FENCE OR COMBINATION IF | 42 SHRUBS | 0 | 42 |
| HEDGE/SHRUBS USED, NUMBER OR SHRUBS | 42 SHRUDS | 0 | 442 |

GENERAL LANDSCAPE NOTES

まる苦苦の

- ALL WORKMANSHIP AND MATERIALS SHALL CONFORM TO CITY OF ANN ARBOR STANDARDS AND SPECIFICATIONS. ALL PLANT MATERIAL SHALL BE SIZES AND MEASUREMENTS CONFORMING TO THE USA STANDARD FOR NURSERY STOCK. ALL PLANT MATERIAL SHALL BE OF SELECTED SPECIMEN QUALITY AND HAVE A NORMAL HABIT OF GROWTH. ALL PLANT MATERIAL IS SUBJECT TO THE APPROVAL OF THE LANDSCAPE ARCHITECT.
- ALL PLANT MATERIAL SHALL BE BALLED AND BURLAPPED STOCK OR CONTAINER STOCK. NO BARE ROOT STOCK IS PERMITTED. ALL PLANT BALLS SHALL BE FIRM, INTACT AND SECURELY WRAPPED AND BOUND.
- ALL PLANT BEDS SHALL BE EXCAVATED OF ALL BUILDING MATERIALS AND OTHER EXTRANEOUS OBJECTS AND POOR SOILS TO A MINIMUM DEPTH OF TWELVE INCHES (12") AND ALL BACKFILLED TO GRADE WITH PLANTING MIX (SEE BELOW).
- PLANTING GROWTH MEDIA SHALL BE 33% COMPOSTED LEAF MOLD & 67% FRIABLE LOAM SOIL. INCLUDE 'MYKE' BRAND ROOT STIMULATOR PER MANUFACTURERS DIRECTIONS.
- ALL PLANT BEDS AND INDIVIDUAL PLANTS SHALL BE MULCHED WITH A THREE INCH (3") LAYER OF SHREDDED BARK MULCH. MULCH SHALL CONFORM TO 2012 M.D.O.T. SPECIFICATION 917.14.
- C.L.U.B. AREAS ALONG THE NORTH BOUNDARY IS OCCUPIED BY EXISTING BUILDING AND EXISTING DRIVEWAY. THE NORTHWEST CORNER OF THE SITE IS A STEEP GRADIENT OF 40% AND IS VEGETATED WITH EXISTING TREES AND VOLENTEER GROUND COVERS OF DOMESTIC SPECIES. THIS AREA WILL REMAIN UNTOUCHED AND A 6'HIGH PRIVACY FENCE WITH BE INSTALLED AT THE TOP OF THE SLOPE.
- THE CONTRACTOR SHALL GUARANTEE ALL PLANT MATERIALS FOR A PERIOD OF ONE (1) YEAR FROM THE DATE THE WORK IS ACCEPTED, IN WRITING, BY THE LANDSCAPE ARCHITECT. THE CONTRACTOR SHALL REPLACE, WITHOUT COST TO THE OWNER, WITHIN A SPECIFIED PERIOD OF TIME, ALL DEAD PLANTS, AND ALL PLANTS NOT IN A VIGOROUS, THRIVING CONDITION, AS DETERMINED BY THE LANDSCAPE ARCHITECT DURING AND AT THE END OF A VIGOROUS, THRIVING CONDITION, AS DETERMINED BY THE LANDSCAPE ARCHITECT DURING AND AT THE END OF THE GUARANTEE PERIOD. REPLACEMENT STOCK SHALL CONFORM TO THE ORIGINAL REQUIREMENTS.
- EDGING, WHERE NOTED ON THE PLANS, SHALL BE RYERSON STEEL EDGING ,3/16 "X 4". INSTALL PER MANUFACTURER'S INSTRUCTIONS. ALL EDGING SHALL BE INSTALLED IN STRAIGHT, TRUE
- IT IS THE RESPONSIBILITY OF THE CONTRACTOR TO ESTABLISH A DENSE LAWN OF PERMANENT GRASSES, FREE OF LUMPS AND DEPRESSIONS. ANY PART OF THE AREA THAT FAILS TO SHOW A UNIFORM GERMINATION SHALL BE RESEEDED AND SUCH RESEEDING SHALL CONTINUE UNTIL A DENSE LAWN IS ESTABLISHED. DAMAGE TO SEEDED AREAS RESULTING FROM EROSION SHALL BE
- 10. ALL AREAS OF THE SITE SCHEDULED FOR SEEDING SHALL BE DISCED AND GRADED IN CONFORMANCE WITH THE EROSION SHALL BE REPAIRED BY THE CONTRACTOR, GRADING PLAN.
- 11. IT IS THE CONTRACTOR'S RESPONSIBILITY TO LOCATE THE UTILITIES, BOTH ABOVE AND UNDERGROUND PRIOR TO LANDSCAPING. ANY CONFLICTS BETWEEN UTILITIES AND PLANT MATERIAL SHALL BE REPORTED TO THE LANDSCAPE ARCHITECT.
- 12. ALL DISEASED, DAMAGED, OR DEAD MATERIAL SHALL BE REPLACED IN ACCORDANCE WITH THE REQUIREMENTS OF THE CITY OF ANN ARBOR ZONING ORDINANCE AND BY THE END OF THE FOLLOWING PLANTING SEASON, AS A CONTINUING OBLIGATION FOR THE DURATION OF THE SITE.
- 13. MULCH ALL SHRUB BEDS AND TREE PLANTING TO RECEIVE 3" DEPTH OF HARDWOOD SHREDDED BARK MULCH UNDER ENTRY CANOPY SHALL RECEIVE 5"-6" SIZE WASHED COBBLE STONE ON GEO-FABRIC. ALL CURB AREAS TO RECEIVE 3" DEPTH OF HARDWOOD SHREDDED BARK MULCH.
- TREATMENT OF COMPACTED SOILS ROOT ZONE SOILS AROUND EXISTING, REMAINING TREES SHALL BE PROTECTED FROM CONSTRUCTION VEHICLES BY CONSTRUCTION MATS. ANY SOIL COMPACTED BY CONSTRUCTION IN EXCESS OF 83% PROCTOR SHALL BE AERATED MECHANICALLY USING A DISC, ROTO-TILLER AND/OR SURFACE AERATOR IMPLEMENT. 15. LANDSCAPE MAINTENANCE TREE PLANTING, SHALL BE WATERED AT TIME OF PLANTING AND RECEIVE 20-GALLON TREE WATERING BAGS TO MAINTAIN ADEQUATE MOISTURE THROUGHOUT THE
- GROWING SEASON. BAGS WILL BE FILLED WEEKLY BY INSTALLATION CONTRACTOR. SHRUB, FLOWER BEDS, SHALL BE WATERED VIA AUTOMATIC IRRIGATION SYSTEM. PLANT HEALTH WILL BE MONITORED AND CARED TO BY THE INSTALLATION CONTRACTOR FOR THE 1ST GROWING SEASON. LAWN AREAS, SHALL BE IRRIGATED BY AN AUTOMATIC IRRIGATION SYSTEM. FERTILIZATION WILL BE APPLIED 3X PER SEASON USING A, 'NO PHOSPHORUS FERTILIZER'. MOWING WILL BE CONDUCTED WEEKLY IN THE 1ST GROWING SEASON, LAWN HEIGHT WILL BE MAINTAINED 2.25 INCHES.
- 16. BIO-SWALES PLANTING WILL BE MONITORED MONTHLY DURING THE 1ST GROWING SEASON. WEED CONTROL SUPPLEMENT WATER AND CLEARING MISCELLANEOUS DEBRIS WILL BE ATTENDED TO IN THE 1ST GROWING SEASON.
- 17. THE CITY OF ANN ARBOR HAS ADOPTED AN ORDINANCE LIMITING PHOSPHORUS IN FERTILIZERS. THE PROPERTY DEVELOPER WILL RESTRICT THE APPLICATIONS OF FERTILIZER BEYOND THE INITIAL TOPSOIL AND SEEDING AND SHALL BE A FERTILIZER COMPOSITION WITH NO PHOSPHORUS.
- 18. THERE WILL NOT BE FALL PLANTINGS OF EVERGREEN TREES, AUG 1ST THRU MARCH 15TH.
- 19. SNOW STORAGE SHALL NOT BE PUSHED ONTO INTERIOR LANDSCAPE ISLANDS UNLESS DESIGNED FOR SNOW STORAGE.
- 20. NO PLANTING SUBSTITUTIONS ARE PERMITTED WITHOUT PRIOR APPROVAL OF THE CITY OF ANN ARBOR.

|--|

| <u> </u> | | | | | | | |
|----------|------------|--------------|----------|----------|-----------|---------|------------------------------------|
| TREE NO. | . DBH | COMMON NAME | LANDMARK | INVASIVE | CONDITION | STATUS | NOTES |
| 100 | 15" | NORWAY MAPLE | NO | YES | | | NO IMPACT DUE TO CONSTRUCTION |
| 101 | 12" | BOXELDER | NO | NO | | | NO IMPACT DUE TO CONSTRUCTION |
| 102 | 12" | BOXELDER | NO | NO | | | NO IMPACT DUE TO CONSTRUCTION |
| 103 | 18" | MULBERRY | NO | NO | | | NO IMPACT DUE TO CONSTRUCTION |
| 104 | 12" | WALNUT | NO | NO | | PROTECT | NO IMPACT DUE TO CONSTRUCTION |
| 105 | 5 " | CEDAR | NO | NO | | PROTECT | NO IMPACT DUE TO CONSTRUCTION |
| 106 | 10" | BOXELDER | NO | NO | | | NO IMPACT DUE TO CONSTRUCTION |
| 107 | 10" | BOXELDER | NO | NO | | | NO IMPACT DUE TO CONSTRUCTION |
| 108 | 12" | NORWAY MAPLE | NO | YES | | | NO IMPACT DUE TO CONSTRUCTION |
| 109 | 8" | BOX ELDER | NO | NO | | | NO IMPACT DUE TO CONSTRUCTION |
| 110 | 11" | LINDEN | NO | NO | | PROTECT | NO IMPACT DUE TO CONSTRUCTION |
| 111 | 11" | LINDEN | NO | NO | | PROTECT | NO IMPACT DUE TO CONSTRUCTION |
| 112 | 3 " | REDBUD | NO | NO | | PROTECT | NO IMPACT DUE TO CONSTRUCTION |
| 200 | 8",18",20" | BOX ELDER | NO | NO | | PROTECT | LOCATED ON ADJACENT PROPERTY; |
| | | | | | | | CRITICAL ROOT ZONE MAY BE SLIGHTLY |
| | | | | | | | IMPACTED DUE TO FENCE REPLACEMENT |
| 201 | 8" | BOX ELDER | NO | NO | | PROTECT | LOCATED ON ADJACENT PROPERTY |
| | | | | | | | |

PROTECT LOCATED ON ADJACENT PROPER CRITICAL ROOT ZONE MAY BE SLIGHTLY IMPACTED DUE TO FENCE REPLACEMENT

EXISTING TREE SURVEY & MITIGATION SUMMARY

| TOTAL DEAD TREES | | 0 0" | DBH |
|--------------------------------------|-----------|--------|-----|
| TOTAL INVASIVE TREES | | 0 0 | DBH |
| TOTAL FRUIT TREES | | 0 0" | DBH |
| TOTAL LANDMARK TREES | | 0 0" | DBH |
| LANDMARK TREES TO BE REMOVED | | 0 0" | DBH |
| REGULATED TREES REMOVED FOR CONST | RUCTION | 0 0" | DBH |
| INCHES OF TREE MITIGATION REQUIRED | | | |
| LAND | MARK = | 0" | |
| REGU | JLATED = | 0" | |
| TOTAL INCHES OF MITIGATION REQUIRED | | | |
| O" X | 50% = | 0" | |
| 0" / | 2.5" = | 0" | |
| TOTAL INCHES OF MITIGATED ON-SITE | = | 0" | |
| REMAINING MITIGATION FOR OFF-SITE | = | 0" | |
| CASH CONTRIBUTION TO CITY FUND (\$20 | 00 EA.) = | \$0.00 | |

LAWN MIX

TOTAL SURVEYED TREES

 EXISTING VEGETATION STEEP SLOPE TO REMAIN UNTOUCHED AND PROTECTED

DURING CONSTRUCTION BY PROTECTIVE

 ALL SITE STORM WATER IS DIRECTED INTO INFILTRATION BED THROUGH STORM STRUCTURES WITHIN PARKING LOT.

ISNOW FENCE!

6' PRIVACY FENCE

STORM INLET STRUCTURE

PROPOSED INTERIOR

PROPOSED 7: METAL BENCH

ANDSCAPE ISLAND, 250 SF

PROPOSED INTERIOR LANDSCAPE ISLAND,

PROPOSED SNOW STORAGE LOCATIONS

30% KY BLUEGRASS 25% TURF TYPE PRE. RYE 25% CR. RED FESCUE 10% BARON KY. BLUE 10% KENBLUE KY. BLUE SPREAD RATE: 3LBS PER 1,000 SF SPREAD FERTILIZER 15-30-15 AT 5.75LBS PER 1,000 SF SPREAD EZ STRAW MULCH

GREENSPACE PROVIDED

PROPOSED PLAY AREA

PROPOSED

2 HOOPS

RYERSON

| | , |
|--------------------------|-----------|
| TOTAL SITE (MINUS ROW) | 22,160 SF |
| IMPERVIOUS AREA | 15.211 SF |
| OPEN SPACE PROVIDED | 15% |
| OPEN LAWN SPACE PROVIDED | 1,100 SF |
| ACTIVE OPEN SPACE | 600 SF |
| | |

INTERIOR LANDSCAPE TABLE


| TREES | N/A |
|---------------------|----------|
| SHRUBS | N/A |
| INTERIOR OPEN SPACE | N/A (SF) |

ANNUAL MAINTENANCE


- WEED REMOVAL (HERBICIDE APPLICATION UPON NEED)
- PROPER TRIMMING OF TREES AND SHRUBS
- BED EDGES MAINTAINED
- DEADHEADING TO ENCOURAGE RE-BLOOM SPRING PERENNIAL CUT DOWN AND POST—WINTER GARDEN
- FALL CLEANUP AND ANTI-DESICCANT SPRAY TO EVERGREENS

• LAWN MOWING TO MAINTAIN 2 1/2" HEIGHT

- MULCH APPLIED EACH YEAR (FINE HARDWOOD BARK OR
- OWNERS CHOICE)
- COMPOST BLENDED INTO MULCH TO AID SOIL STRUCTURE. SLOW RELEASE FERTILIZER CUSTOM FORMULATED GARDEN

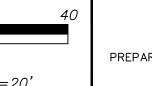



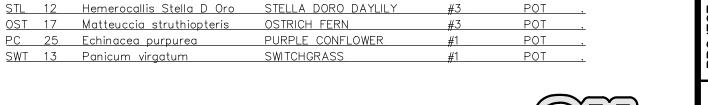

PLANTING SCHEDULE

PROPOSED PLANT LIST

SYM QTY BOTANICAL NAME

JUN 1 Juniperus chinensis

BUR 2 Quercus macrocarpa

HAC 7 Celtis occidentalis

SPR 16 Taxus cuspidata

SPI 18 Spirea prunifolia YEW 21 Taxus x media Wardii

RUF 8 SWEET WOODRUFF

BOX 13 Galium odoratum

FOR 42 Forsythia suspense

<u>FIR 2 Pseudotsuga menziesii</u>

- EVERGREEN TREES AND SHRUBS MAY 15, THRU AUGUST 1.
- NO FALL PLANTING ALLOWED. TREAT ALL EVERGREENS WITH ANTI-DESCANT IN SEPTEMBER

ELM 5 Ulmus americana 'princeton' PRINCETON ELM

DECIDUOUS TREES AND SHRUBS • MARCH 15, THRU AUGUST 1

• SEPTEMBER 5, THRU NOVEMBER 1.





 \rightarrow = PLANT QUANTITY & IDENTIFICATION

+)= DECIDUOUS TREES TO REMAIN

₹ + 5 = EVERGREEN TREES TO REMAIN

PROPOSED DECIDUOUS TREE

(= PROPOSED EVERGREEN TREE

⊙ ⊕ = PROPOSED DECIDUOUS SHRUBS

o o o = PROPOSED RYERSON STEEL EDGING

= PROPOSED MULCH BED

= PROPOSED LAWN MIX

= STREET TREES/SHRUBS

SIZE COMMENT

<u>7'HT B&B.</u>

<u>6' HT B & B .</u>

2.5" CAL B & B .

2.5" CAL B & B . 2.5" CAL B & B .

24" CONTAINER

CONTAINER

CONTAINER

CONTAINER

CONTAINER

CONTAINER

V = PROPOSED VUA TREES/SHRUBS

= PROPOSED C.L.U.B. TREES/SHRUBS

\$1.30 PER LF FRONTAGE

171 LF

4 TREES

180 LF

= PROPOSED BENCH

(+) = PROPOSED EVERGREEN SHRUBS





IN ARBOR ERVATION REUSE

LEGEND $\wp^{\circ} = SPOT ELEV.$ \Leftrightarrow = LIGHT POLE

 \succ = GUY ANCHOR \otimes = GATE VALVE \square = CATCHBASIN

TW = TOP OF WALL $\circ = MANHOLE$ \smile = END SECTION

TC = TOP OF CURB

-"-"-"-=FENCE= CONCRETE = ASPHALT

-:.—:.— = GRAVEL

----- s ----- = EXISTING SANITARY----- w ----- = EXISTING WATER ——— g ——— = *EXISTING GAS* —— e — = EXISTING ELECTRIC ---- t ---- = EXISTING TELEPHONE

----r ---- = EXISTING STORM

BENCHMARK BM1=NAIL IN S'LY FACE OF 12" MAPLE, NEAR NW'LY CORNER OF SITE, BM2=NAIL IN W'LY FACE OF UTILITY POLE, NEAR NE'LY CORNER OF SITE, ELEV=820.28. DATUM=NAVD 88

REVISIONS 2-3-2022 PER CITY, 7-25-2022 PER CITY, 8-24-2022 PER CITY.

SCALE: 1"=20'

SCALE

SNOW FENCE

2 HOOPS

PROPOSED INTERIOR

LANDSCAPE ISLAND,

PRIVACY FENCE

PROPOSED ENCLOSURE FOR 96 GAL. ROLLUP REFUSE BINS

> **PROPOSED** BUILDING ADDITION

> > ALL BRANCHES

TO BE TRIMMED TO A MIN. OF 8

STREET TREE ESCROW

FRONTAGE ON DETROIT STREET

45 FEET PER EXISTING TREE

TOTAL REQUIRED ESCROW

COMMON NAME

HETZII COLUMNARIS

SPREADING YEW

WEEPING FORSYTHIA

BRIDAL WREATH SPIREA

GREEN GEM BOXWOOD

Buxus microphylla 'koreana' 24"

DOUGLAS FIR

BUR OAK


HACKBERRY

WARDS YEW

LESS CREDIT FOR REMAINING TREES

NOTE: THERE ARE TWO (2) EXISTING ACCESS DRIVES ON THE DETROIT STREET FRONTAGE.

REQUIREMENT

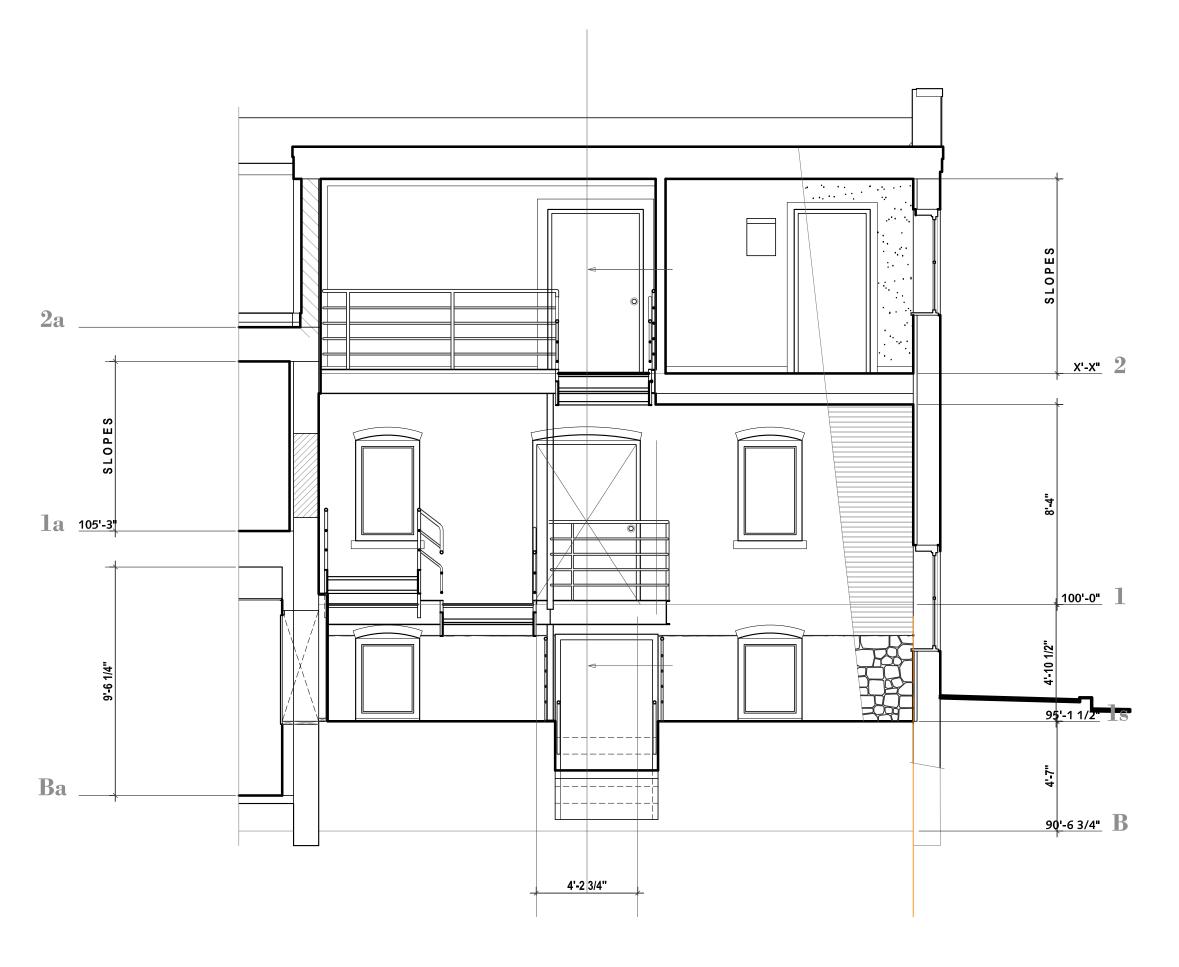

1027 1/2 2 1027 1/2 2 1027 1/2 2

EXISTING

NORTH - SOUTH SECTION


STAIR ADDITION


LOOKING EAST
SCALE 1/4" = 1'-0"

EXISTING

NORTHSOUTH SECTION

LOOKING WEST
SCALE 1/4" = 1'-0"

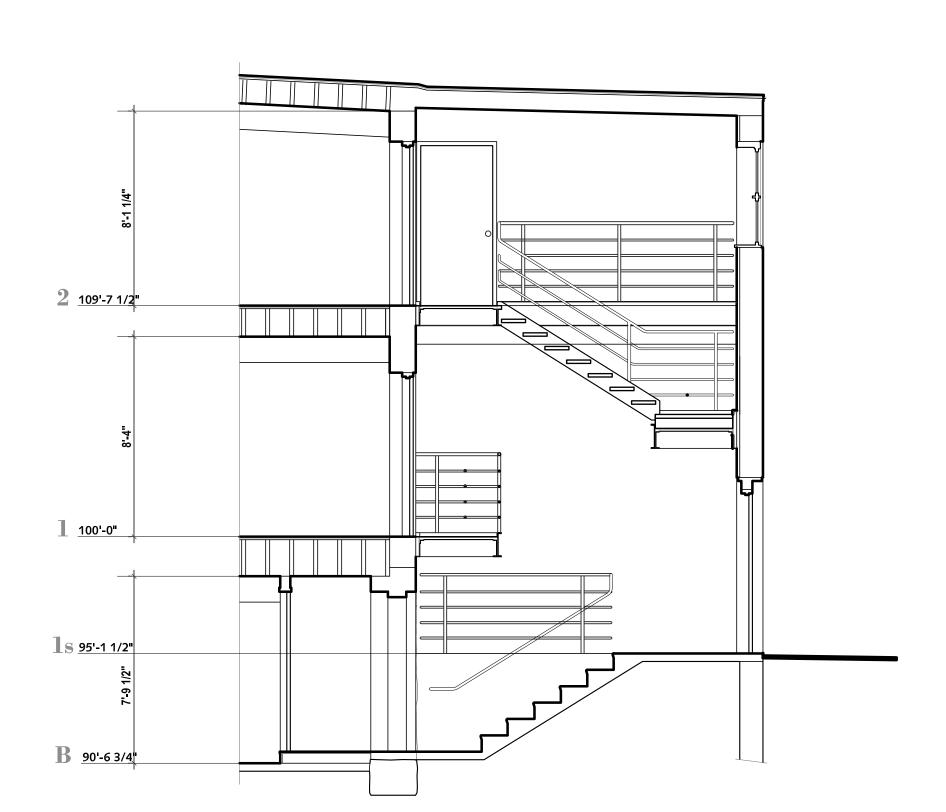

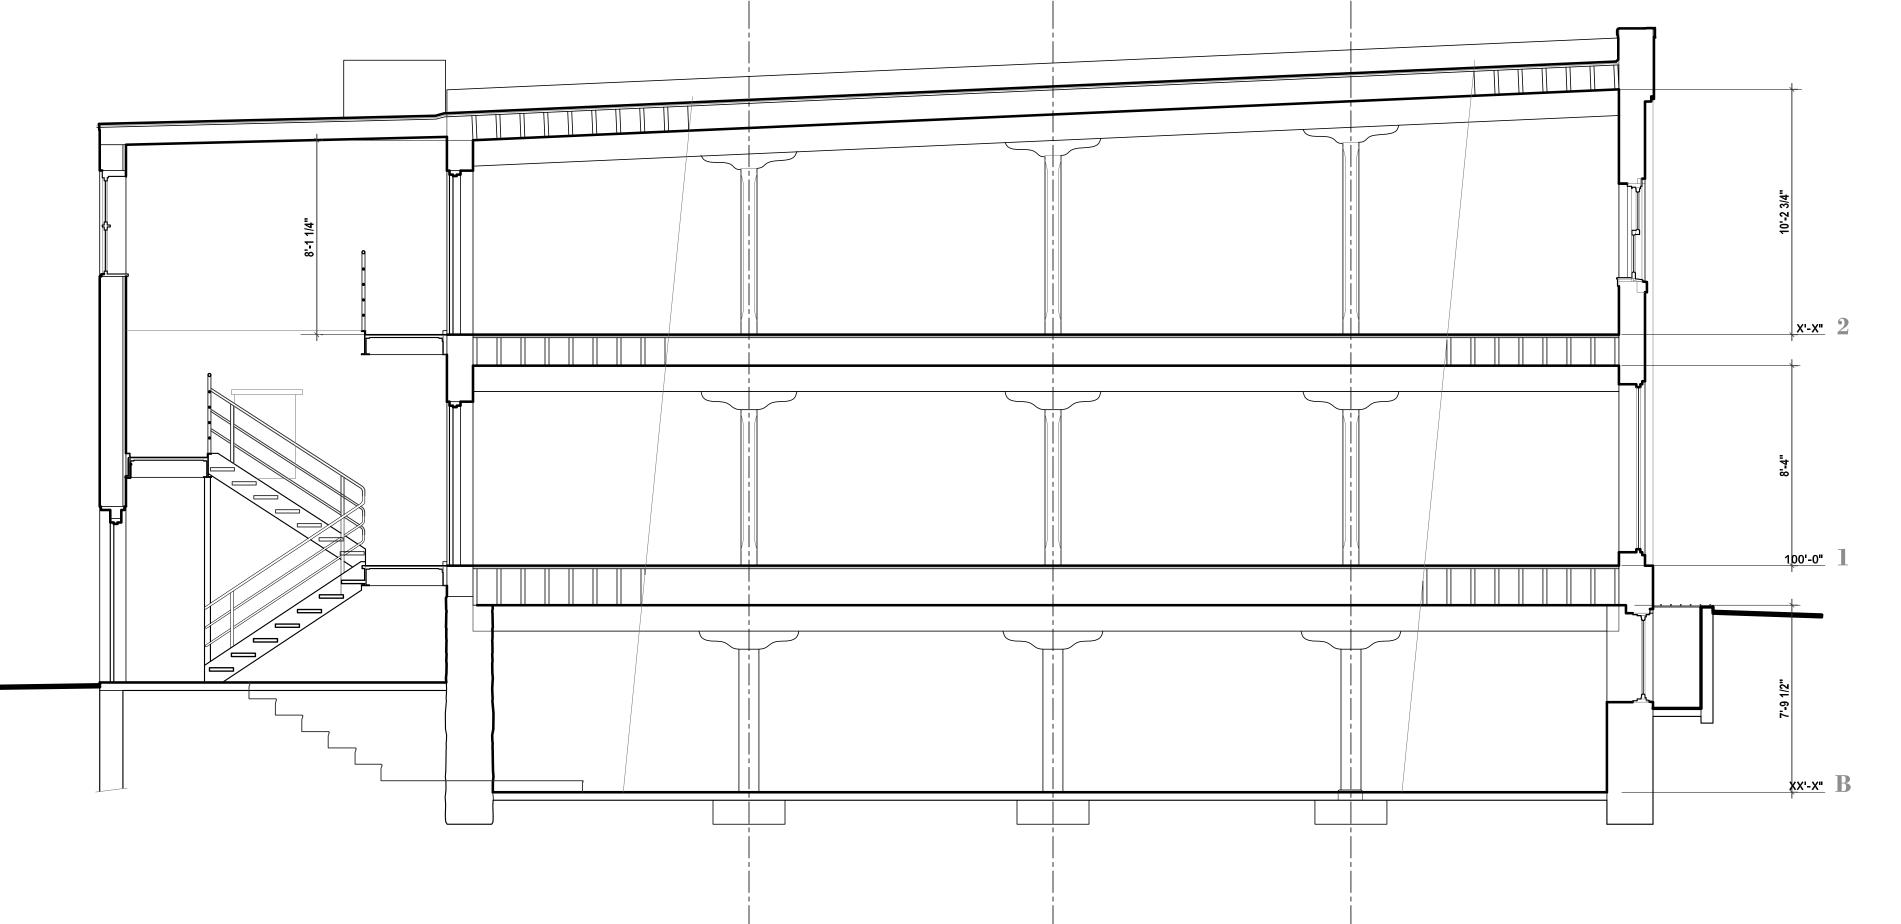

EXISTING

E A S T - W E S T S E C T I O N

O S T A I R A D D I T I O N

LOOKING SOUTH
SCALE 1/4" = 1"-0"



COOPER DESIGN

2900 Brockman Boulevard
Ann Arbor, Michigan 48104
734.769.7007 office
734.646.7043 mobile

Redeemer Church of Ann Arbor

HISTORIC PRESERVATION ADAPTIVE REUSE

OF THE FORMER
TREASURE MART
BUILDING

521 & 525 Detroit Street
Ann Arbor, Michigan 48104

Project Number 202110

Sheet Title

EXISTING - BUILDING SECTIONS 1

Scale As Shown
Drawn By GLC

Issued For

15 NOVEMBER 2021

PLANNING COMMISSION REVIEW

PLANNING COMMISSION REVIEW

Sheet No

A.4





VIEW OF EXISTING SOUTH ELEVATION




VIEW OF WEST & SOUTH ELEVATIONS FROM THE SOUTHWEST




VIEW OF EXISTING FRONT, EAST ELEVATION



VIEW OF EXISTING NORTH ELEVATION W/OFFICE AND SHED ADDITIONS

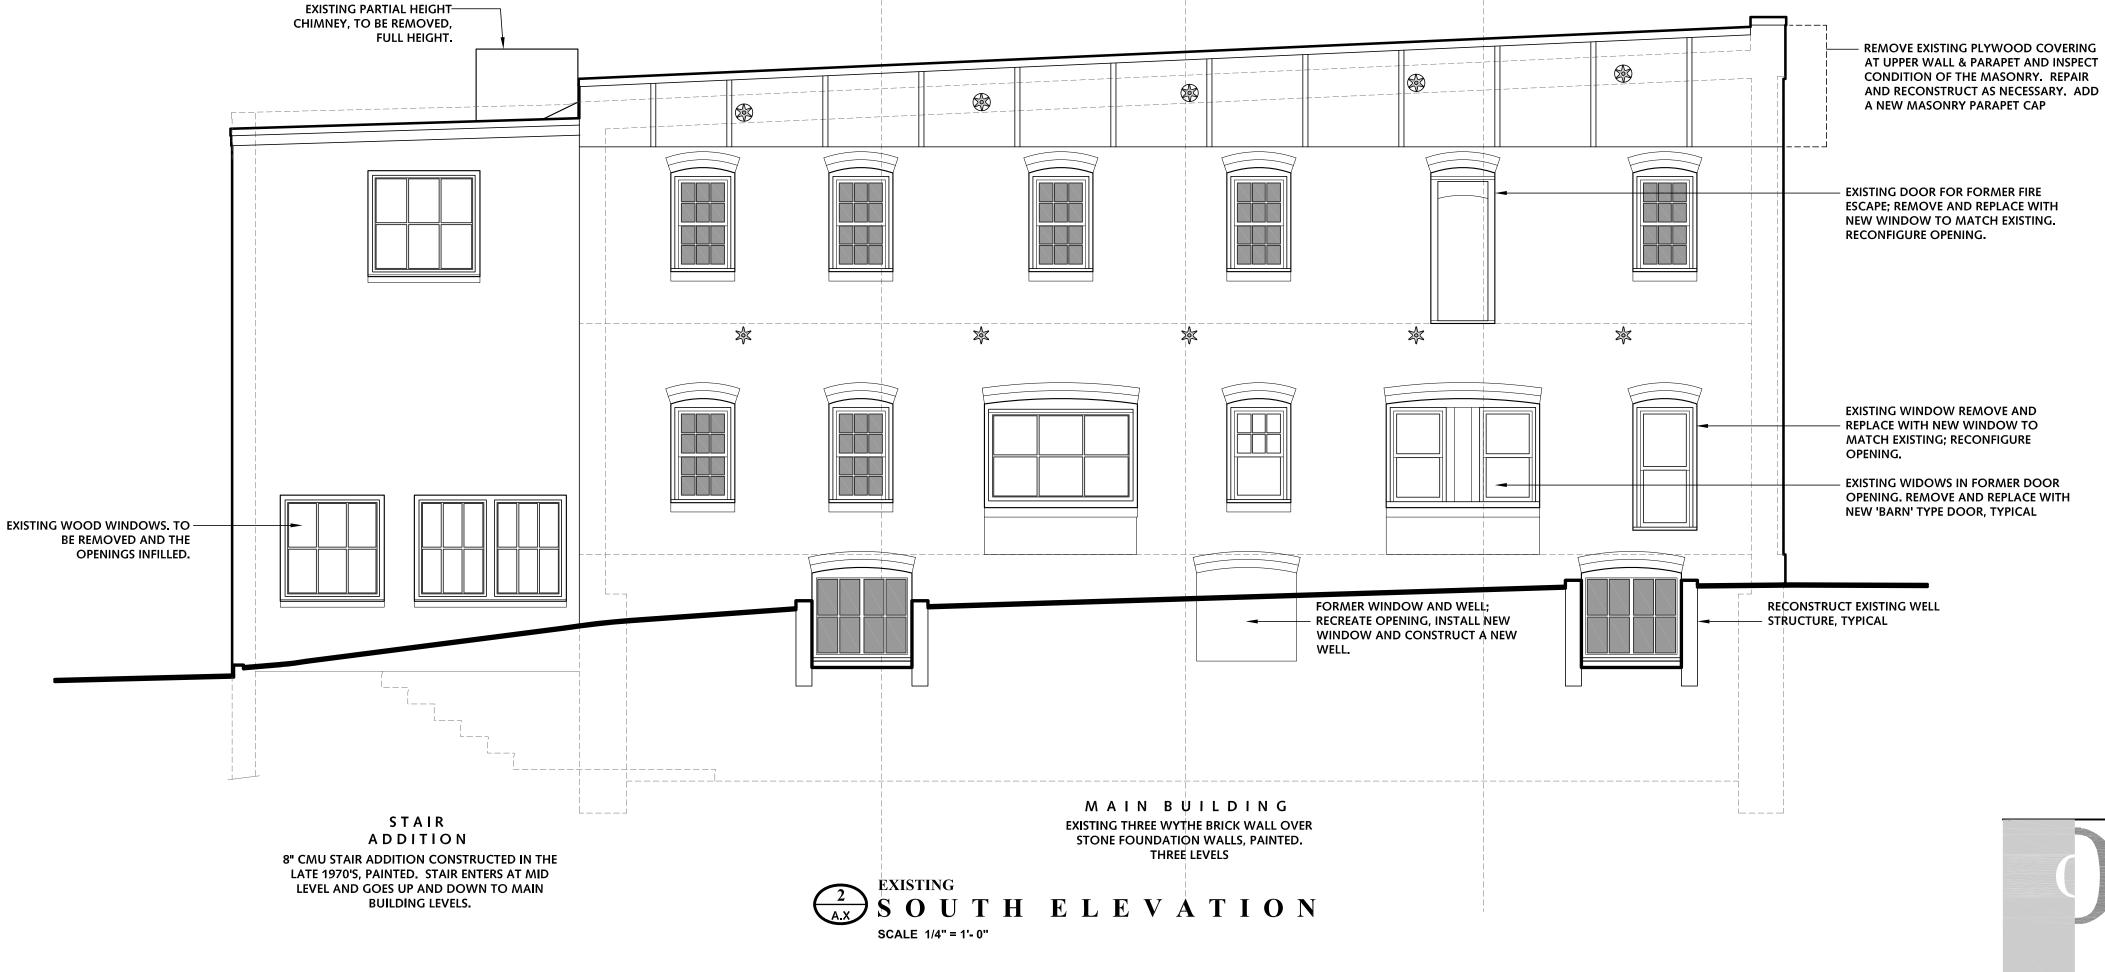

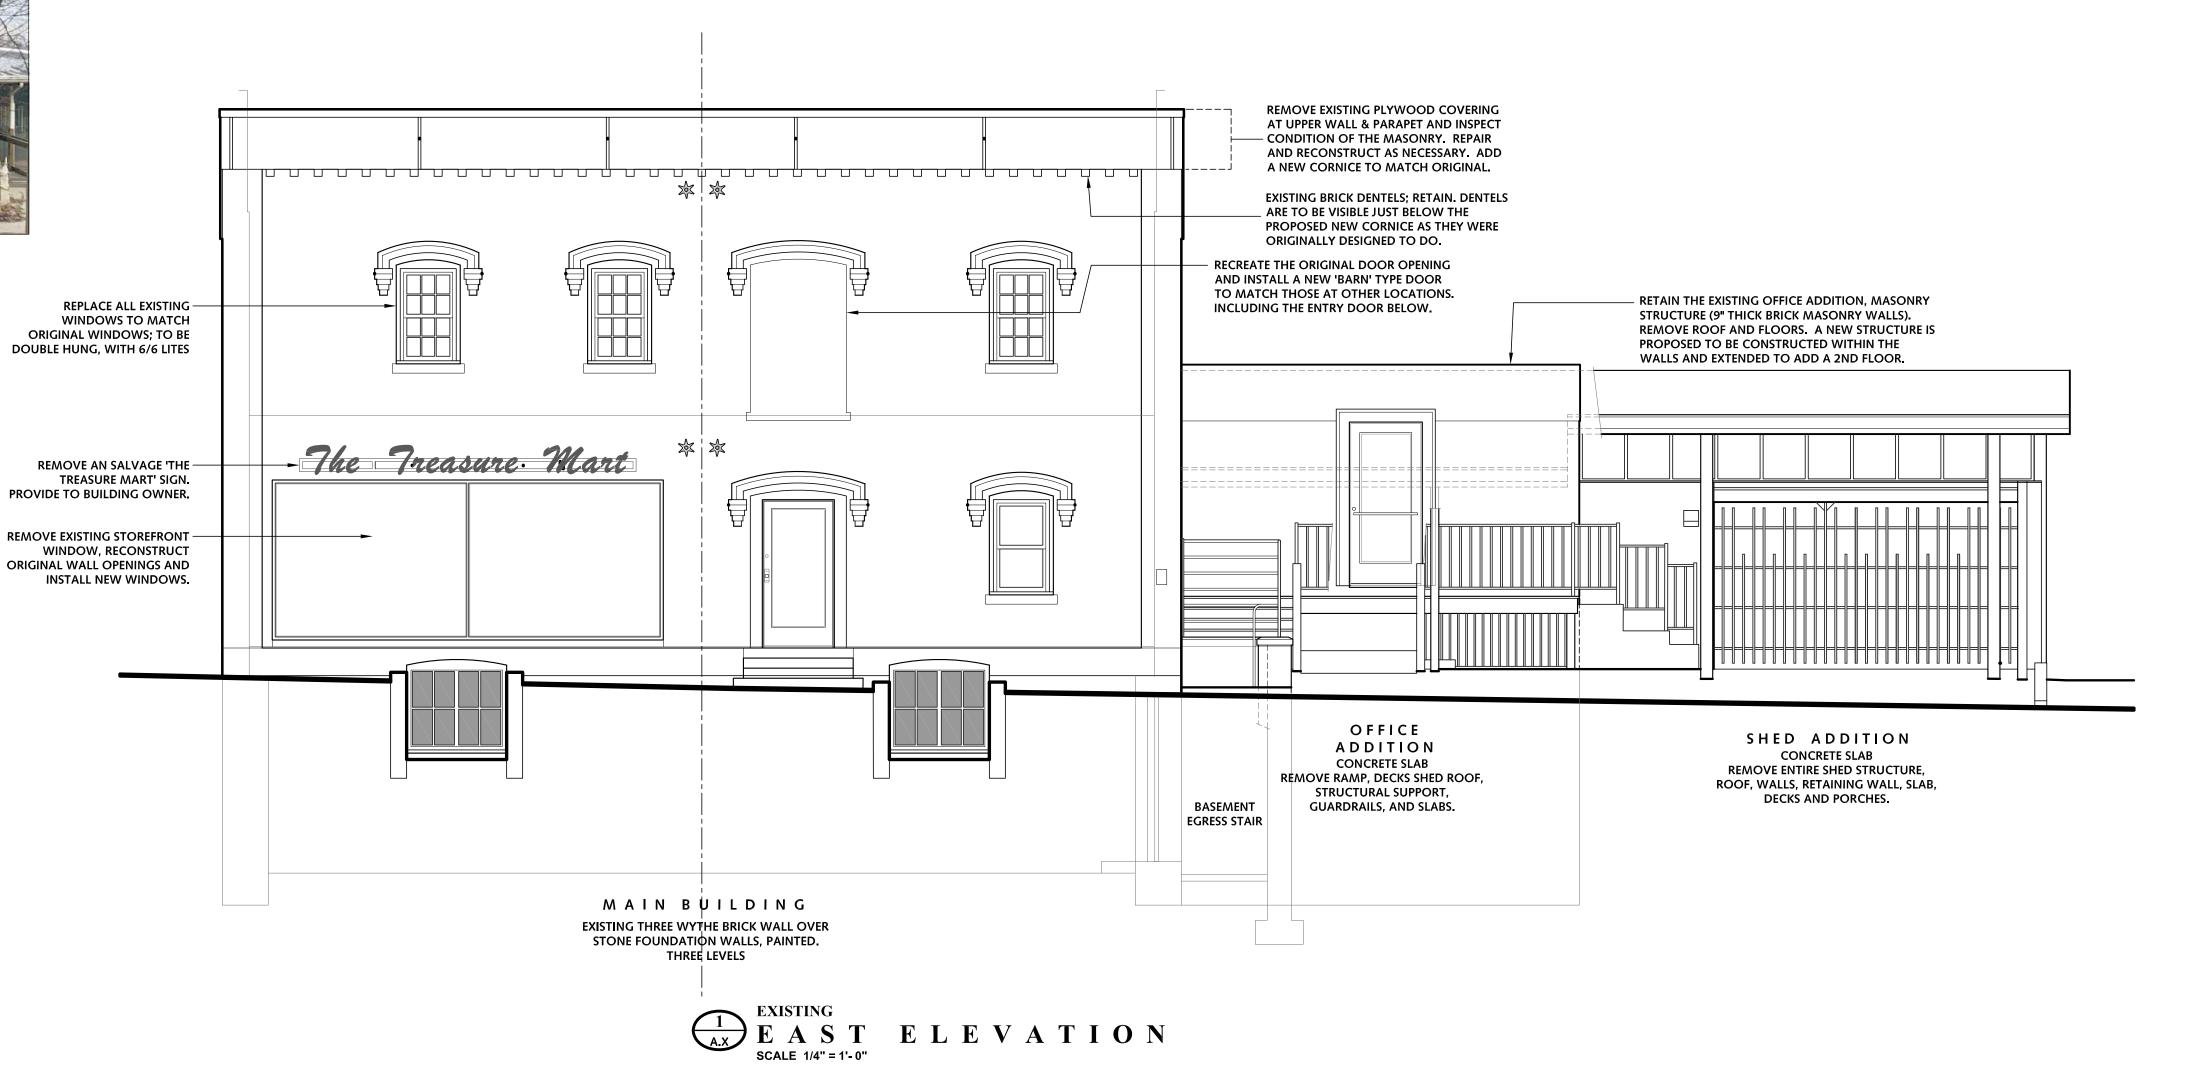

COOPER DESIGN

Ann Arbor, Michigan 48104 734.769.7007 office 734.646.7043 mobile info@cooperdesigninc.com

Redeemer Church of Ann Arbor

HISTORIC PRESERVATION **ADAPTIVE REUSE**

521 & 525 Detroit Street Ann Arbor, Michigan 48104

OF THE FORMER TREASURE MART **BUILDING**

Project Number 202110 Sheet Title **EXISTING - EXTERIOR ELEVATIONS 1**

As Shown GLC Drawn By

Issued For **15 NOVEMBER 2021**

PLANNING COMMISSION REVIEW

Sheet No.



VIEW OF A PORTION OF THE EXISTING NORTH ELEVATION




VIEW OF EXISTING NORTH ELEVATION, UNDER SHED ADDITION



VIEW OF WEST & SOUTH ELEVATIONS FROM THE SOUTHWEST - 1




VIEW OF EXISTING WEST ELEVATIONFROM THE SOUTH WEST - 2

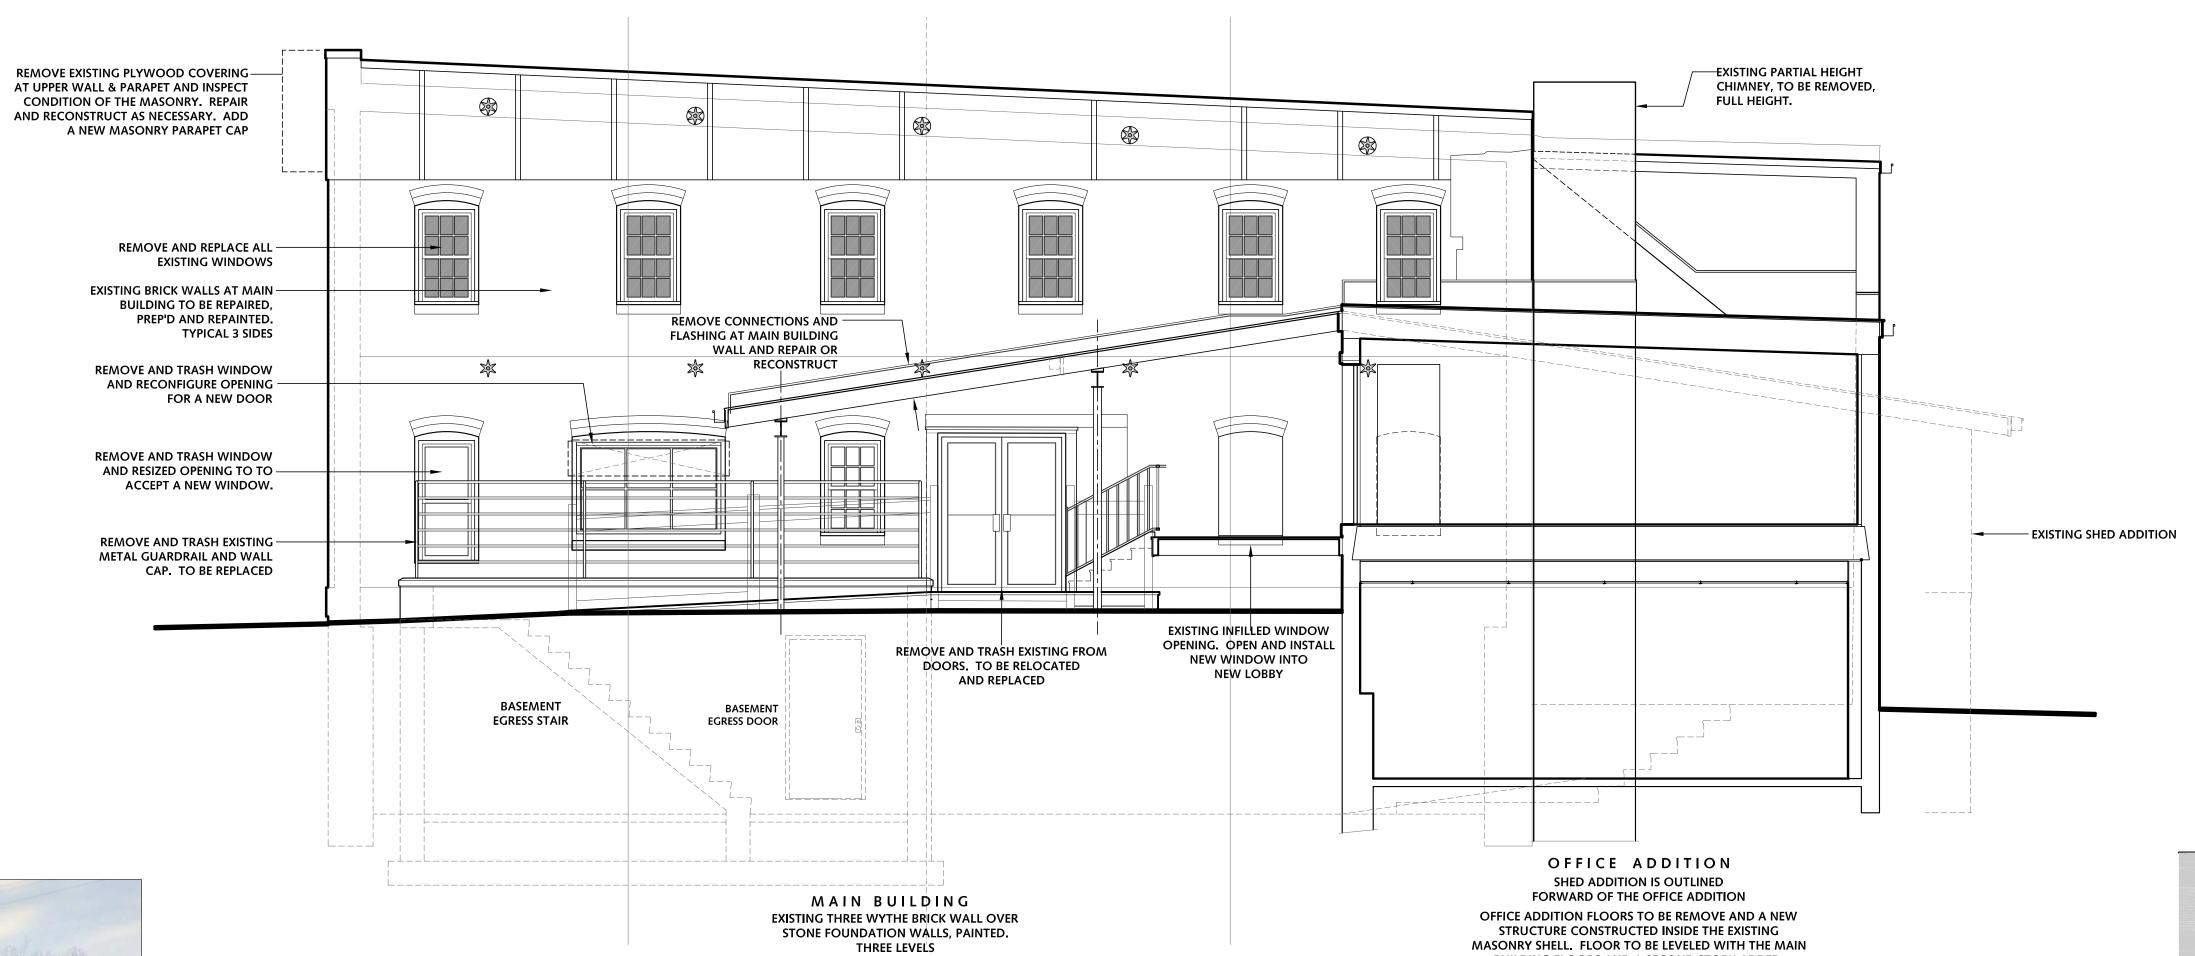


EXISTING NORTH SECTION - ELEVATION

MASONRY SHELL. FLOOR TO BE LEVELED WITH THE MAIN BUILDING FLOORS AND A SECOND STORY ADDED.

BUILDING LEVELS.

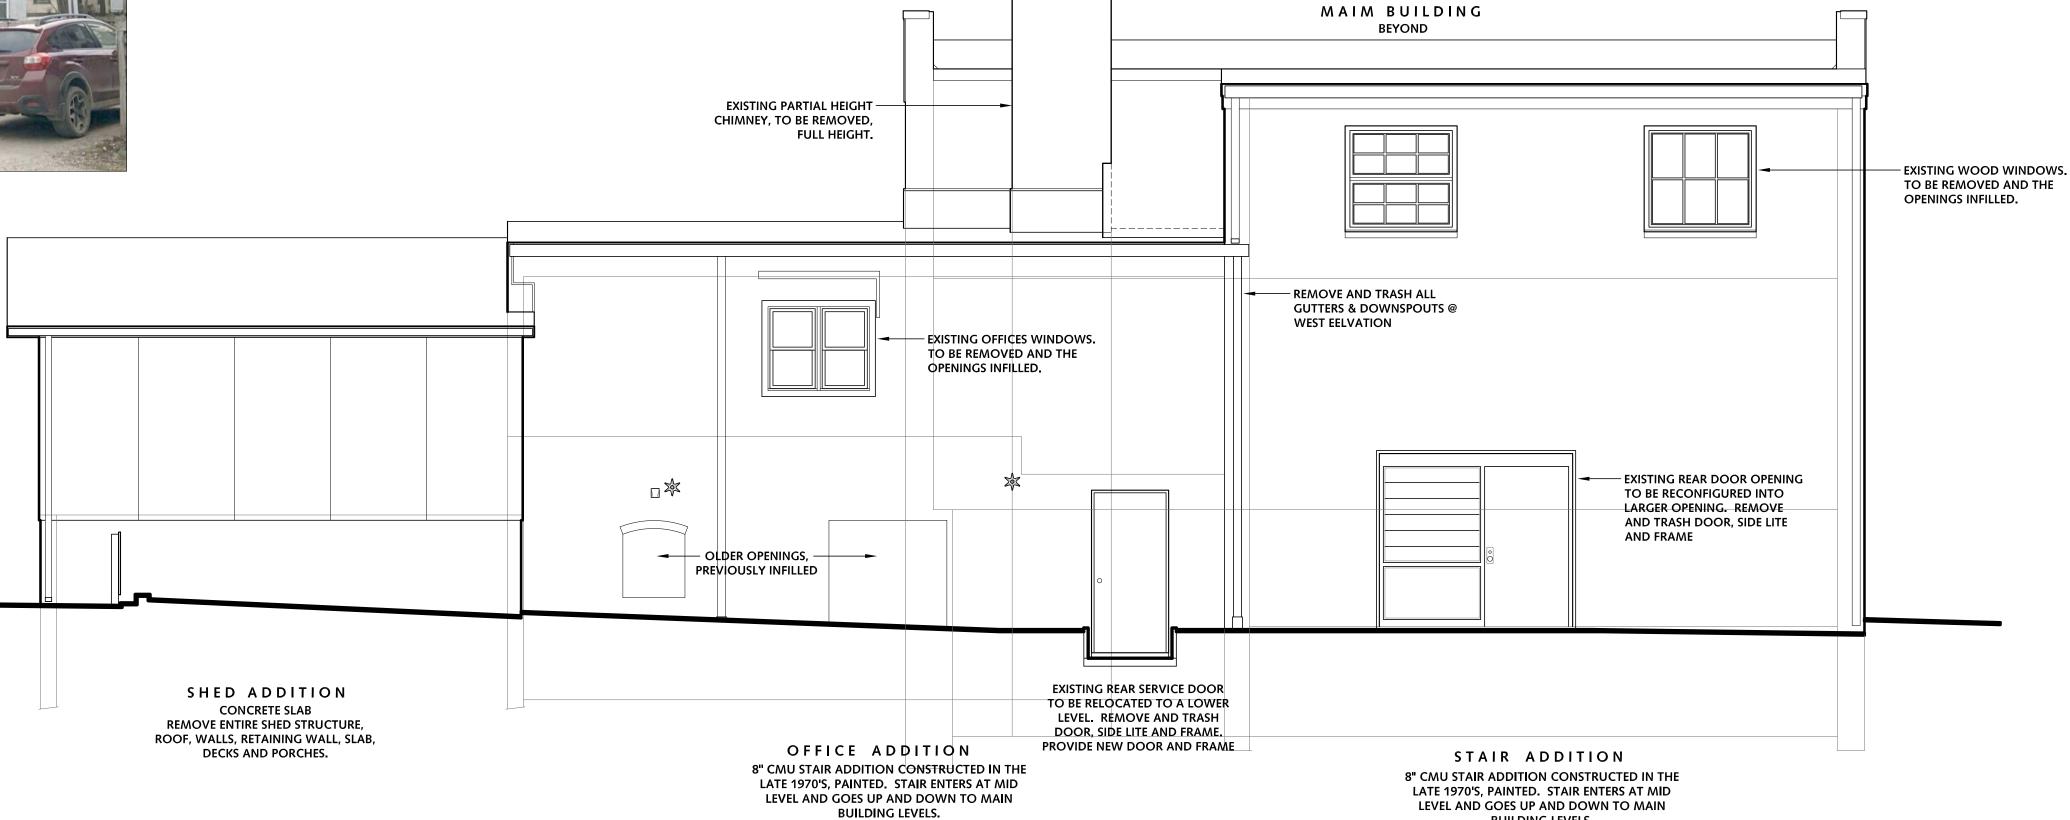



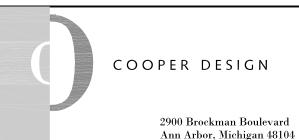

734.769.7007 office 734.646.7043 mobile info@cooperdesigninc.com

Redeemer Church of Ann Arbor

HISTORIC PRESERVATION **ADAPTIVE REUSE**

521 & 525 Detroit Street Ann Arbor, Michigan 48104

OF THE FORMER TREASURE MART **BUILDING**

Project Number 202110 Sheet Title


EXISTING - EXTERIOR ELEVATIONS 2

As Shown GLC Drawn By

Issued For **15 NOVEMBER 2021**

PLANNING COMMISSION REVIEW

Sheet No.

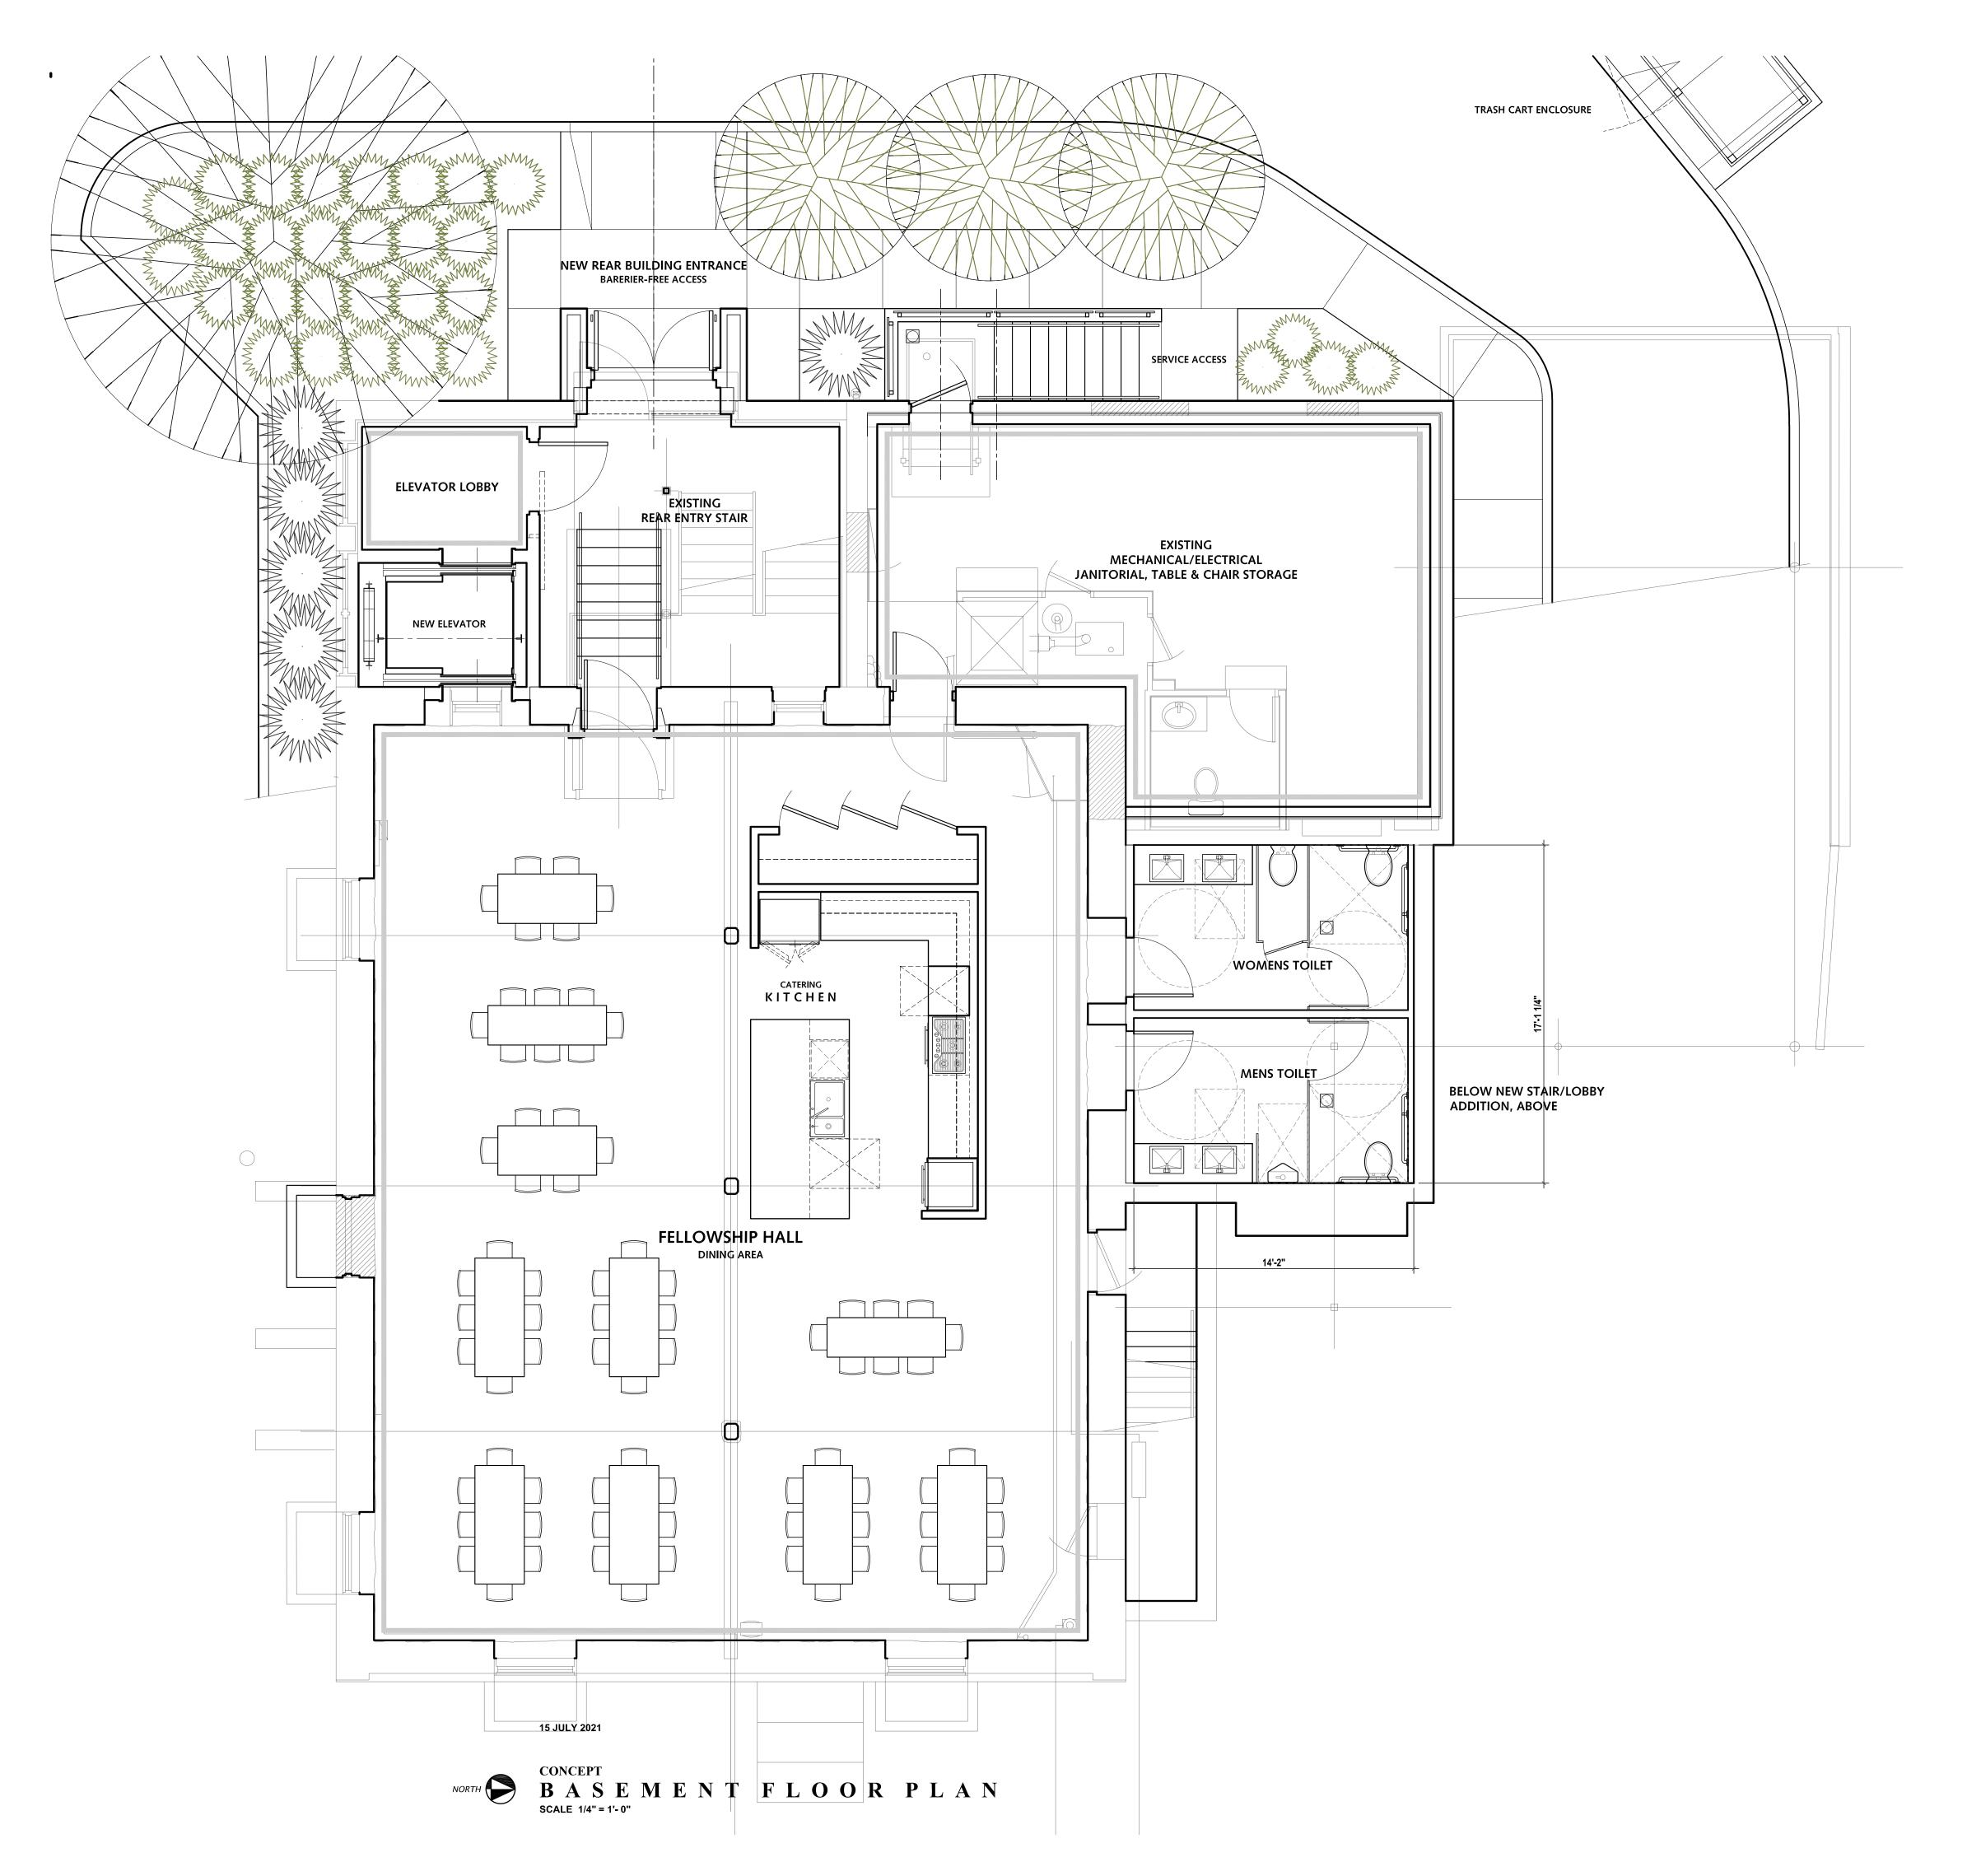



Redeemer Church of Ann Arbor

info@cooperdesigninc.com

HISTORIC PRESERVATION ADAPTIVE REUSE

OF THE FORMER TREASURE MART **BUILDING** 521 & 525 Detroit Street Ann Arbor, Michigan 48104

Sheet Title BASEMENT LEVEL - CONCEPT PLAN

Project Number 202110

As Shown GLC


Issued For


Drawn By

15 NOVEMBER 2021

PLANNING COMMISSION REVIEW

Sheet No.

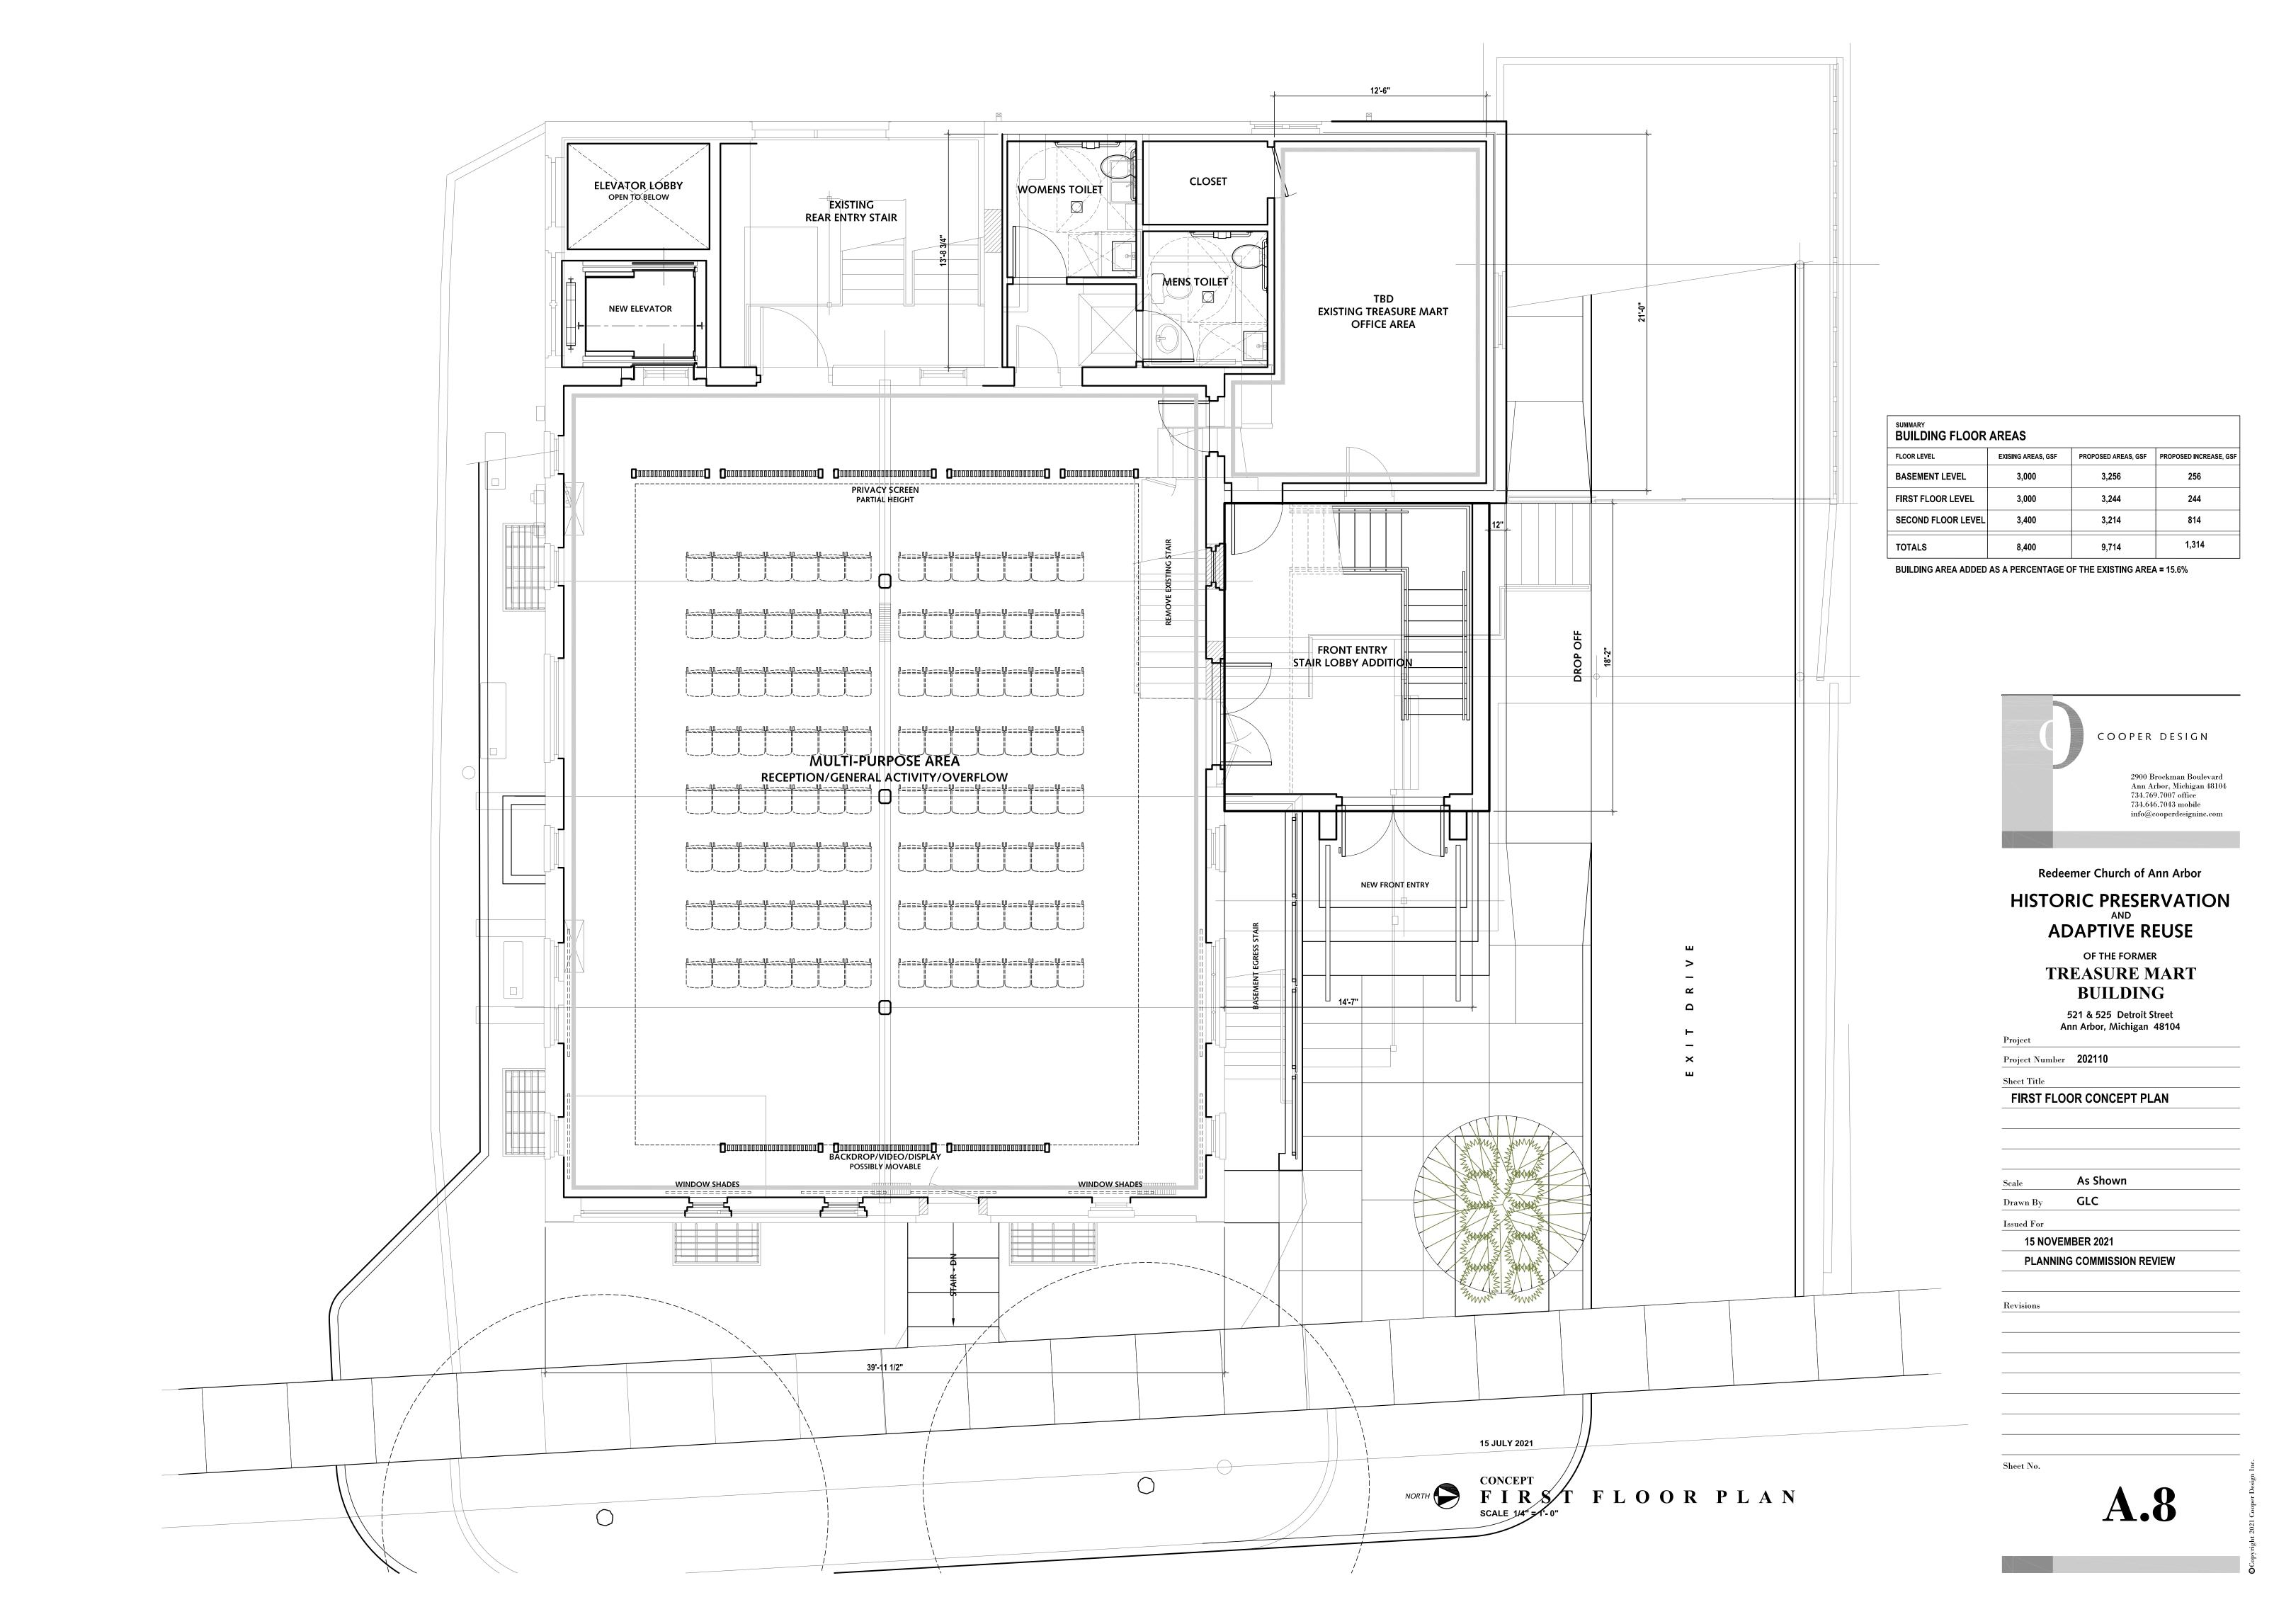

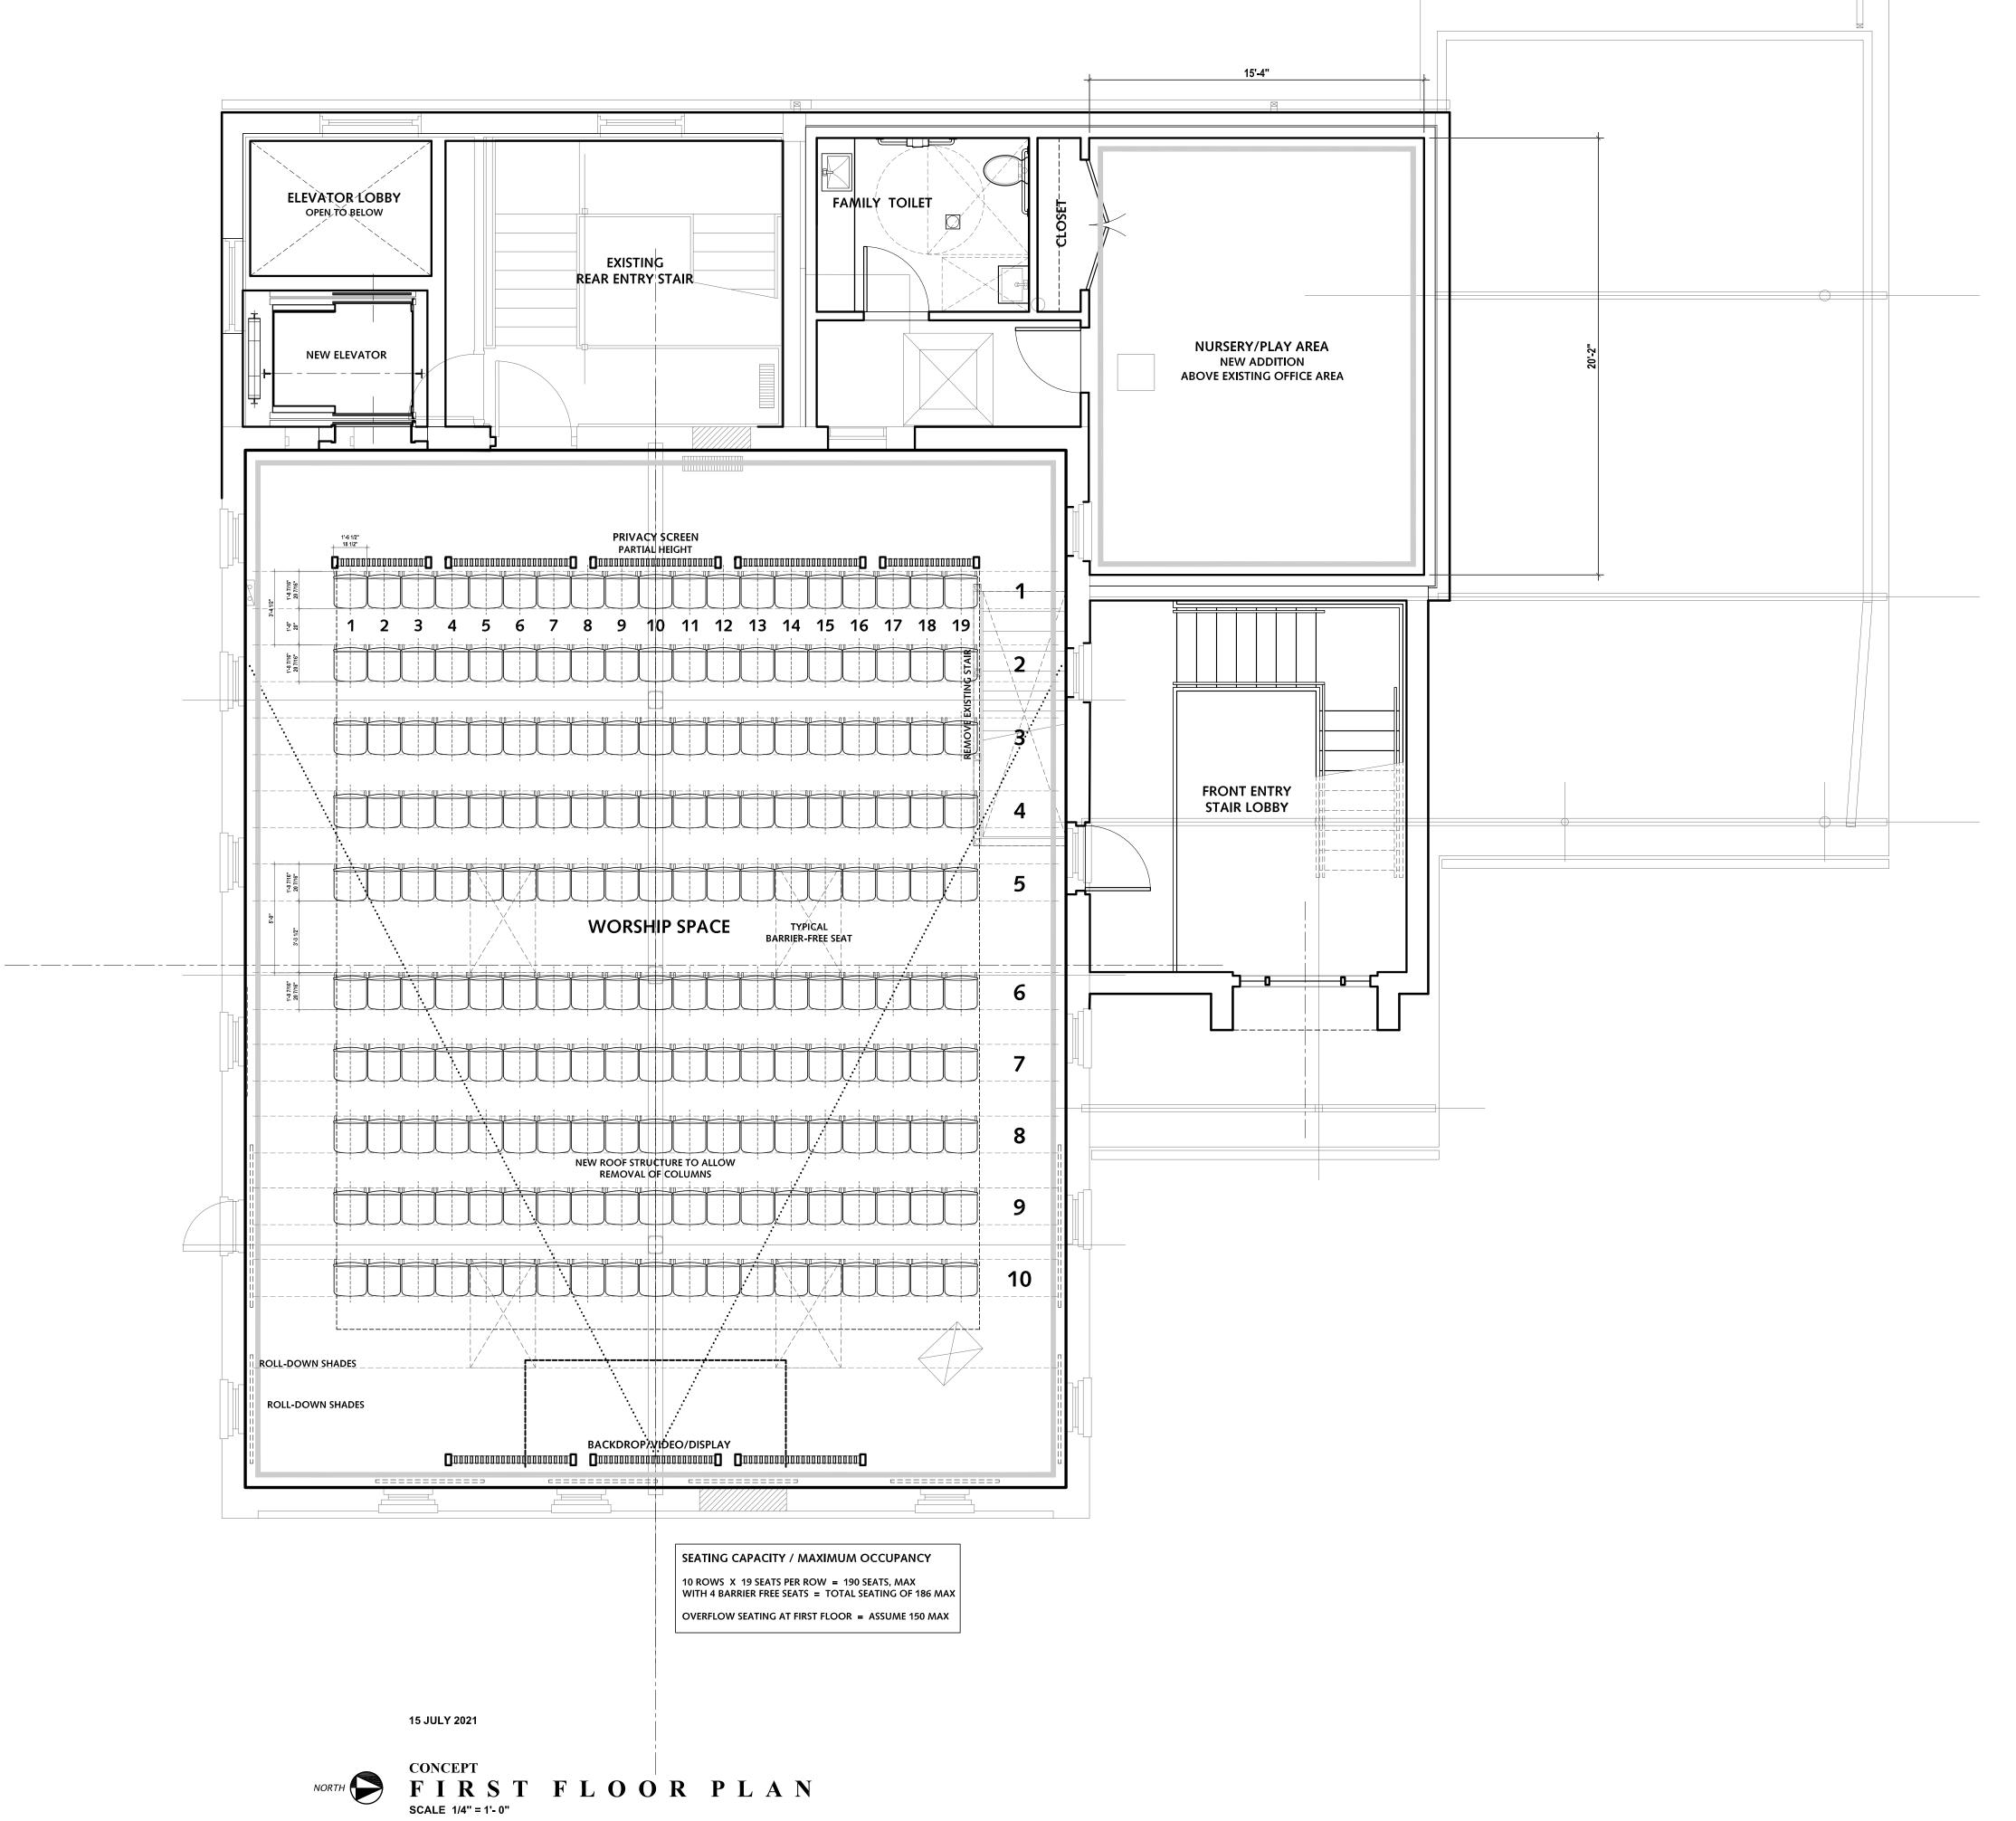

COOPER DESIGN

2900 Brockman Bouleva
Ann Arbor, Michigan 48

2900 Brockman Boulevard Ann Arbor, Michigan 48104 734.769.7007 office 734.646.7043 mobile

info@cooperdesigninc.com

Redeemer Church of Ann Arbor

HISTORIC PRESERVATION ADAPTIVE REUSE

OF THE FORMER
TREASURE MART
BUILDING

521 & 525 Detroit Street
Ann Arbor, Michigan 48104

Project Number 202110

SECOND FLOOR CONCEPT PLAN

Scale As Shown
Drawn By GLC

Issued For
15 NOVEMBER 2021


Sheet Title

PLANNING COMMISSION REVIEW


Revisions

Sheet No.

A.9.2

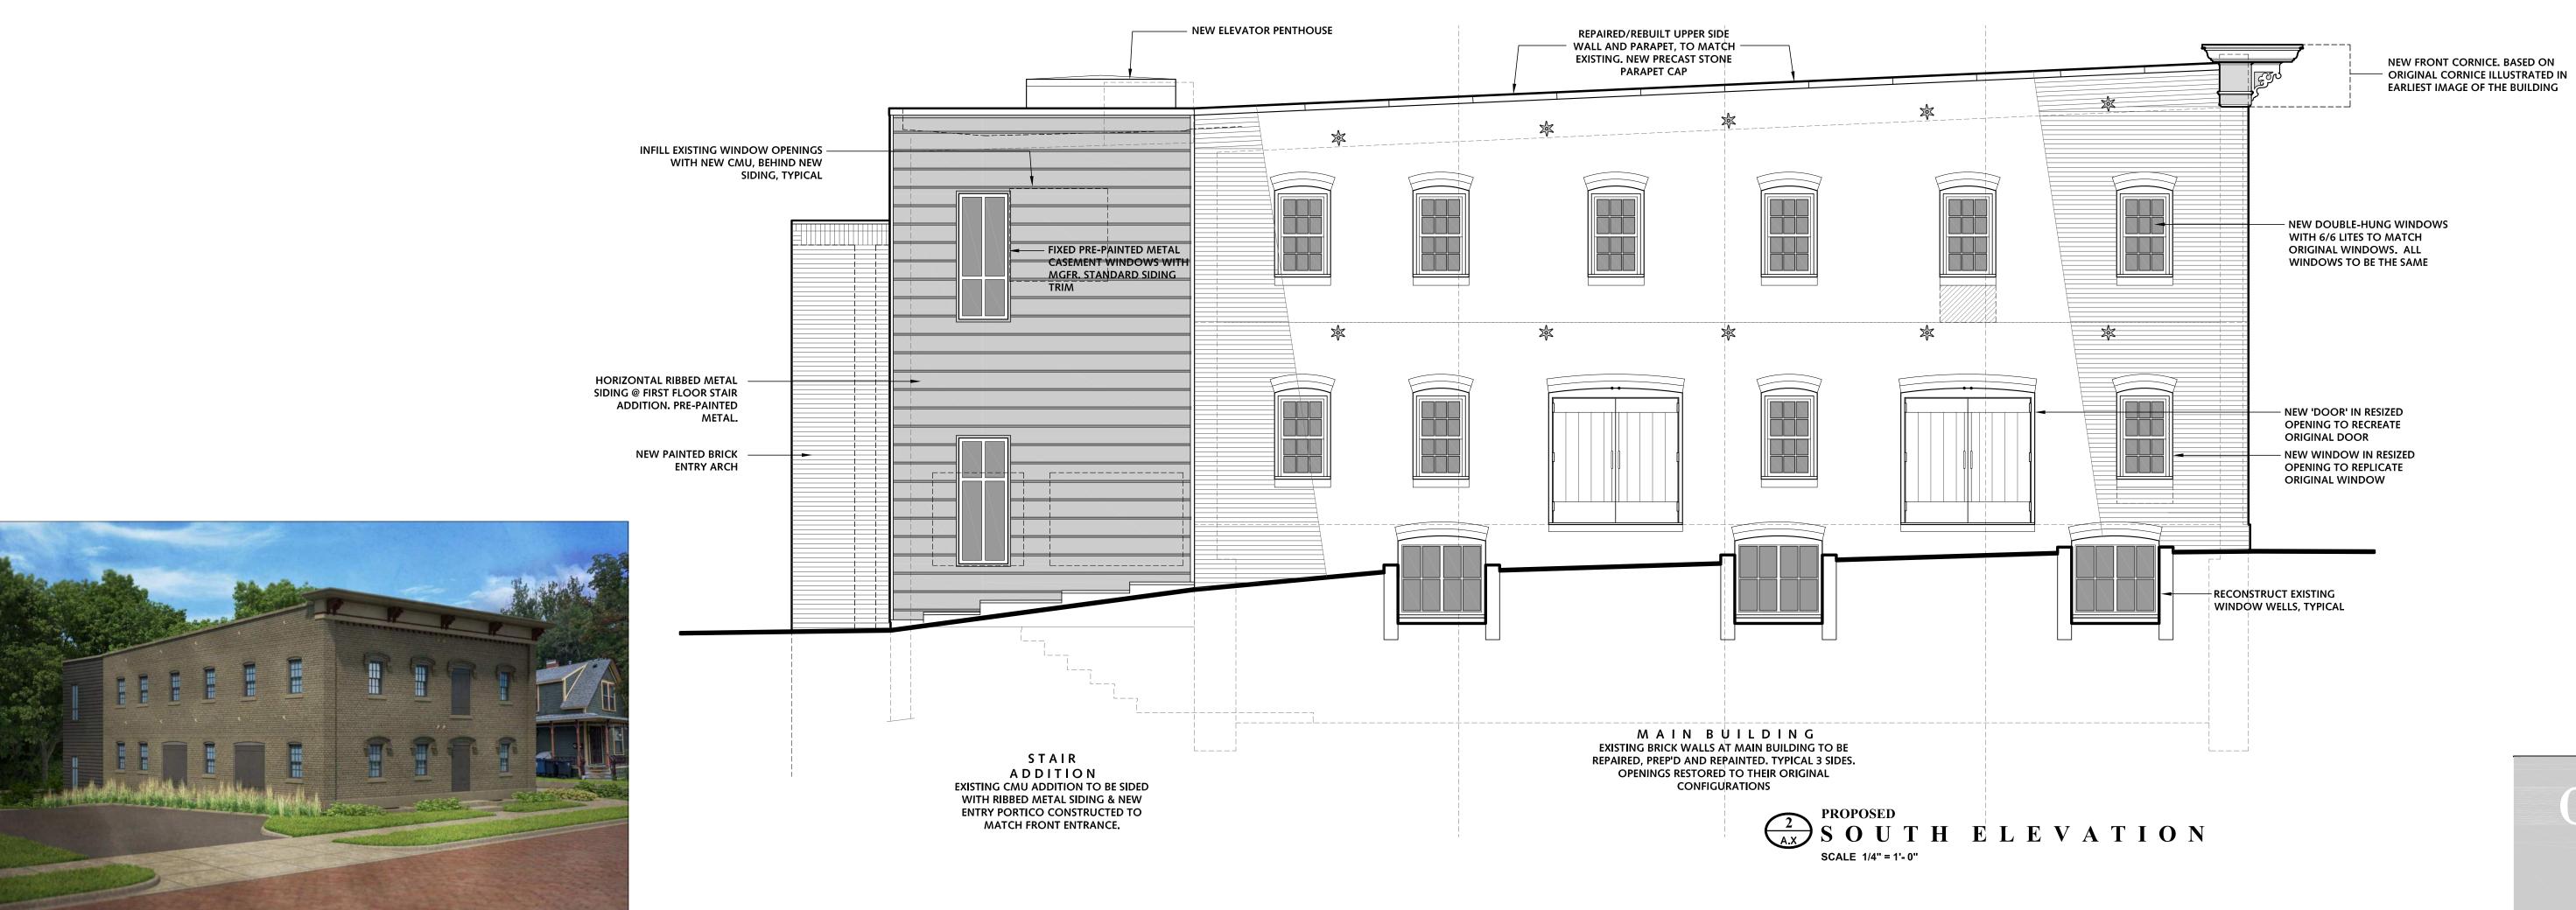

PROPOSED VIEW FROM DETROIT STREET, SOUTHEAST

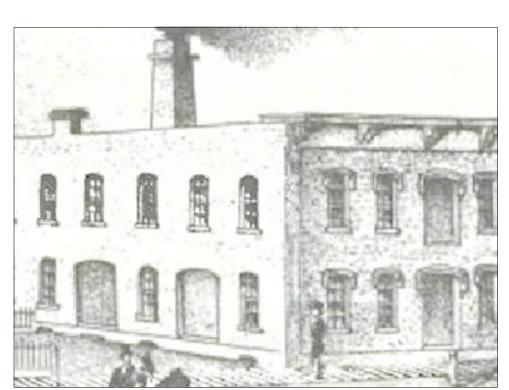

EARLY ILLUSTRATION FROM THE 1800'S, ENLARGED



HISTORIC PHOTO - 1936.



COOPER DESIGN

2900 Brockman Boulevard
Ann Arbor, Michigan 48104
734.769.7007 office

Redeemer Church of Ann Arbor

HISTORIC PRESERVATION ADAPTIVE REUSE

734.646.7043 mobile info@cooperdesigninc.com

OF THE FORMER
TREASURE MART
BUILDING

521 & 525 Detroit Street
Ann Arbor, Michigan 48104

| Project Number | 202110 |
|----------------|---------------------|
| Sheet Title | |
| EXISTING - | EXTERIOR ELEVATIONS |

Scale As Shown
Drawn By GLC

Issued For
15 NOVEMBER 2021

PLANNING COMMISSION REVIEW

Revisions

18 July 2021 HDC REVISIONS

Sheet No.

A.10 R



REPAIRED/REBUILT UPPER SIDE


WALL AND PARAPET, TO MATCH



HISTORIC PHOTO - 1980'S.



HISTORIC PHOTO - 1960'S.

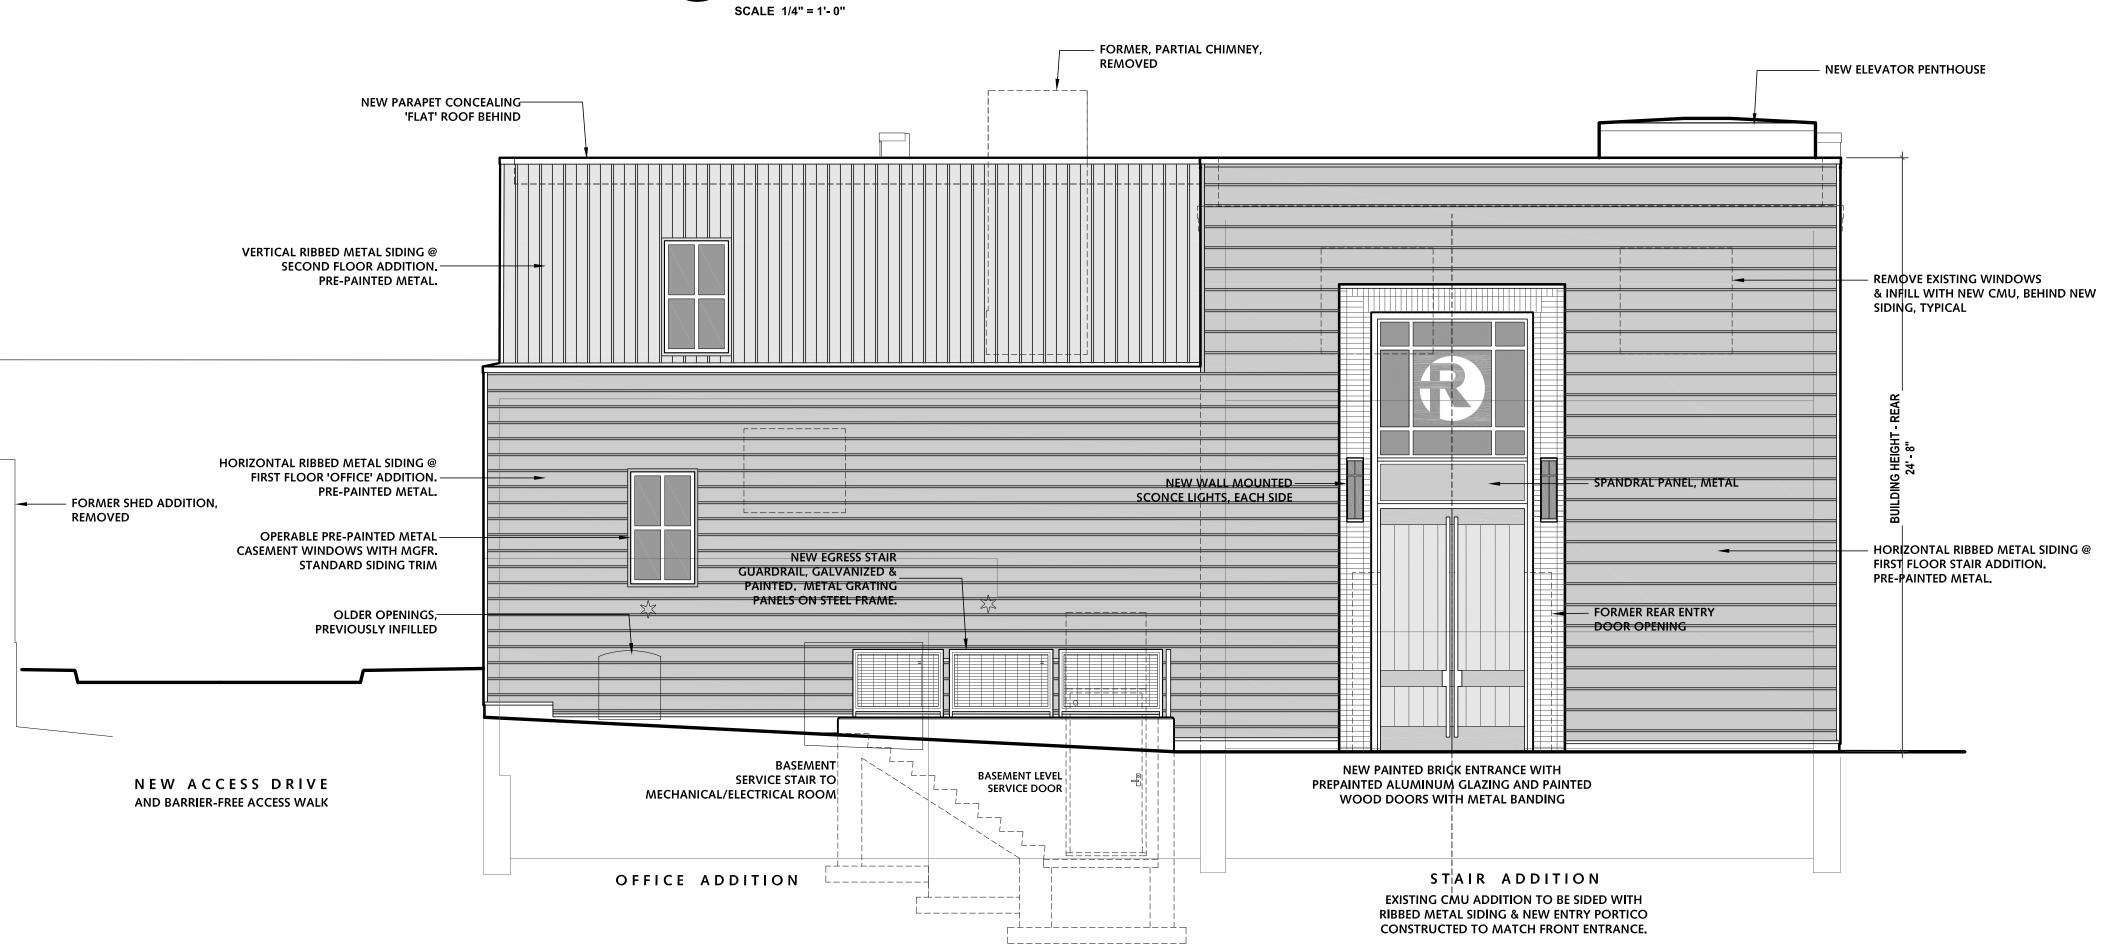


WEST ELEVATION
SCALE 1/4" = 1'-0"

PARAPET LOWERED TO 12" BELOW EXISTING MAIN BUILDING PARAPET, AS SHOWN.

ORIGINALLY PROPOSED SLOPING ROOF

REMOVED AT REQUEST OF HDC.

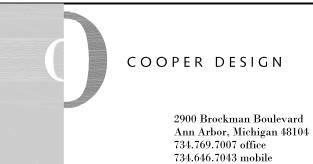

Redeemer Church of Ann Arbor

info@cooperdesigninc.com

HISTORIC PRESERVATION ADAPTIVE REUSE

OF THE FORMER

TREASURE MART
BUILDING

521 & 525 Detroit Street
Ann Arbor, Michigan 48104

Project Number 202110
Sheet Title

PROPOSED - EXTERIOR ELEVATIONS 2

de As Shown

Issued For

Drawn By

15 NOVEMBER 2021

PLANNING COMMISSION REVIEW

GLC

18 July 2021 HDC REVISIONS

Sheet No.

A.11 R