
WHEELER FACILITY POND DREDGING

4170 PLATT ROAD CITY OF ANN ARBOR WASHTENAW COUNTY, MICHIGAN HRC JOB No. 20190818

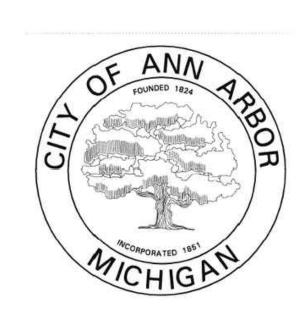

CITY OF ANN ARBOR PUBLIC WORKS

4251 STONE SCHOOL ROAD ANN ARBOPR, MI 48104 PHONE: (734) 794-6350

WEB SITE: https://www.a2gov.org/departments/public-works/Pages/default.aspx



PHONE: (248) 454-6300 FAX (1st. Floor): (248) 454-6312 FAX (2nd. Floor): (248) 338-2592


WEB SITE: http://www.hrc-engr.com



ALL EXISTING UTILITIES SHOWN ON THIS TOPOGRAPHICAL SURVEY HAVE BEEN TAKEN FROM VISUAL OBSERVATION, AND RECORD MAPPING WHERE AVAILABLE. NO GUARANTEE IS MADE, OR SHOULD BE ASSUMED, AS TO THE COMPLETENESS OR ACCURACY OF THE UTILITIES SHOWN ON THIS DRAWING. PARTIES UTILIZING THIS INFORMATION SHALL FIELD VERIFY THE ACCURACY AND COMPLETENESS PRIOR TO CONSTRUCTION ACTIVITIES.




CALL MISS DIG **72 HOURS** (3 WORKING DAYS) **BEFORE YOU DIG** Know what's **below** 1-800-482-7171 **Call** before you dig. OR 811 (TOLL FREE) CALL811.COM

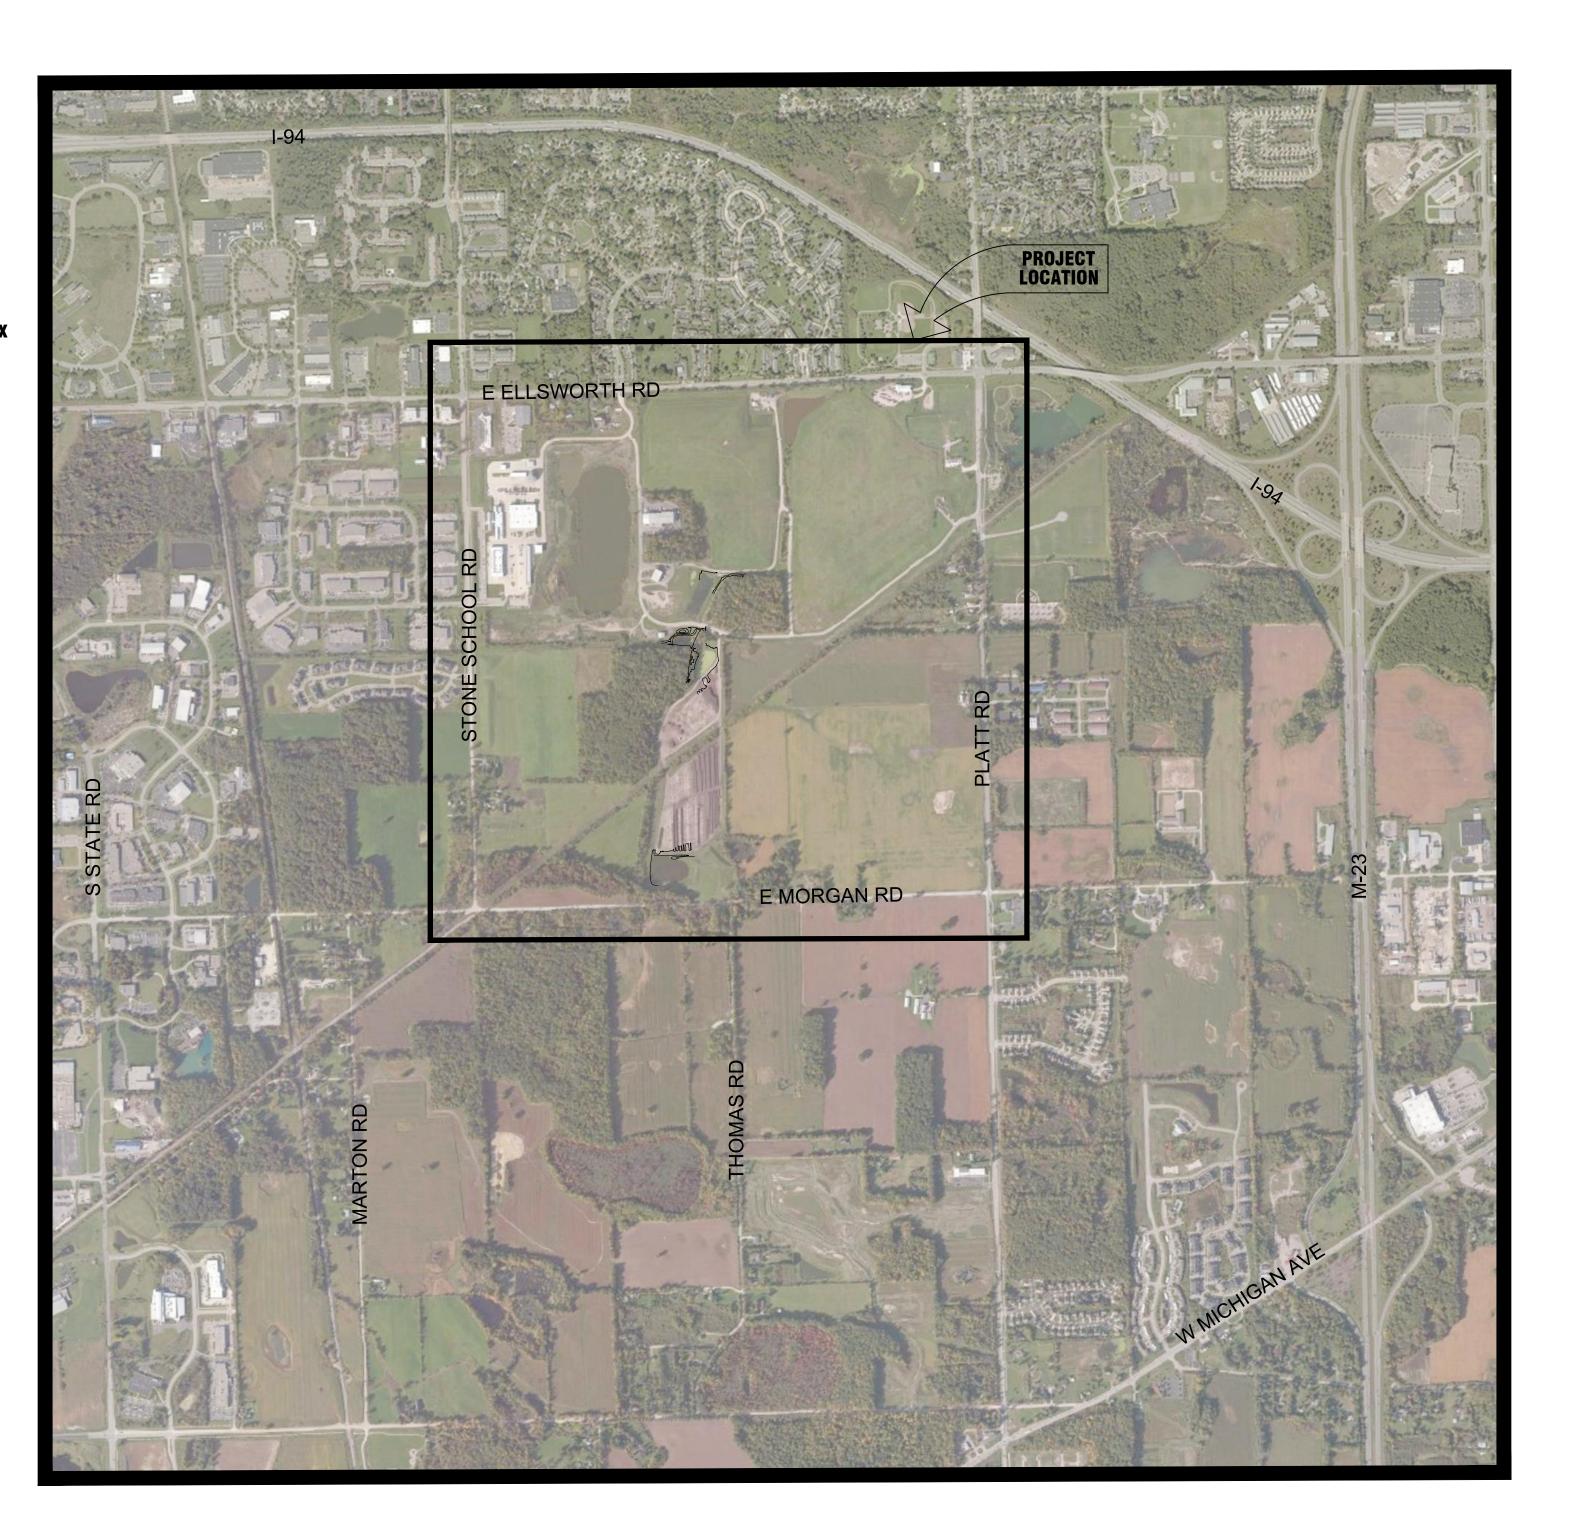

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	DATE	ADDITIONS AND	OR REVISIONS E(SLE-V
	06/18/20	ISSUED FOR OWNER REVIEW		
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GENERAL NOTES:

COOPERATION BY THE CONTRACTOR: NO ADDITIONAL COMPENSATION WILL BE PAID TO THE CONTRACTOR FOR ANY DELAY OR INCONVENIENCE DUE TO MATERIAL SHORTAGES OR REASONABLE DELAYS DUE TO THE OPERATIONS OF SUCH OTHER PARTIES DOING WORK INDICATED OR SHOWN ON THE PLANS OR IN THE PROPOSAL OR FOR ANY REASONABLE DELAYS IN CONSTRUCTION DUE TO THE ENCOUNTERING OF EXISTING UTILITIES THAT MAY OR MAY NOT BE SHOWN ON THE PLANS.

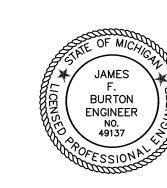LIMITATIONS ON PRIVATE WORK: DURING CONSTRUCTION OPERATIONS, THE CONTRACTOR SHALL NOT PERFORM WORK BY PRIVATE AGREEMENT WITH PROPERTY OWNERS ADJACENT TO THE PROJECT WITHOUT PRIOR OWNER CONSENT. WORK MAY BE ALLOWED WHEN REQUESTED, BUT ONLY WITH WRITTEN CONSENT.

THE CONTRACTOR SHALL CONDUCT HIS OPERATIONS IN SUCH A MANNER TO COMPLY WITH ALL FEDERAL, STATE, AND LOCAL CODES FOR NOISE LEVELS, VIBRATIONS, OR ANY OTHER RESTRICTIONS WHILE PERFORMING ANY CONSTRUCTION OPERATIONS WITHIN THIS CONTRACT, COSTS TO BE INCLUDED IN THE RESPECTIVE ITEM OF WORK.

THE CONTRACTOR SHALL BE REQUIRED TO NOTIFY THE CITY OF ANN ARBOR FIRE & POLICE DEPARTMENTS, POST OFFICE, AND THE CITY 24 HOURS IN ADVANCE OF PROPOSED ROAD

CLOSURES, OR TEMPORARY TRAFFIC CONTROL MEASURES.

THE CONTRACTOR SHALL, BEFORE EACH DAYS WORK, OR WHEN MOVING TO A NEW AREA OF WORK, DETERMINE AND EVALUATE THE LOCATION OF ALL UNDERGROUND FACILITIES IN THE AREA. IF LOCATION STAKES HAVE BEEN MOVED OR DO NOT APPEAR CORRECT, THE CONTRACTOR SHALL NOT EXCAVATE UNTIL ALL UTILITIES HAVE HAD AN OPPORTUNITY TO CHECK OR RESTAKE THEIR LOCATIONS. ANY DELAYS INCURRED, DUE TO THE CHECKING OR RESTAKING OF UTILITIES SHALL NOT BE A BASIS FOR ADDITIONAL COMPENSATION.

THERE WILL BE NO ADJUSTMENT IN THE CONTRACT UNIT PRICE REGARDLESS OF THE PERCENTAGE OF INCREASE OR DECREASE ABOVE OR BELOW THE CONTRACT QUANTITY FOR ANY ITEM OF WORK.

IT IS THE INTENT THAT ALL GOVERNMENT CORNERS ON THIS PROJECT BE PRESERVED AND THAT, WHERE NECESSARY, MONUMENT BOXES BE PLACED OR ADJUSTED, AT THE CONTRACTORS EXPENSE WHETHER SHOWN OR NOT.

THE LOCATION OF ALL PUBLIC UTILITIES SHOWN ON THESE PLANS IS TAKEN FROM THE BEST AVAILABLE DATA. THE OWNER & HUBBELL, ROTH AND CLARK, INC. WILL NOT BE HELD RESPONSIBLE FOR ANY OMISSION OR VARIATIONS FROM THE LOCATIONS SHOWN. PURSUANT TO ACT 53 OF THE PA OF 1974 AS A CONDITION OF THIS CONTRACT NOTICE SHALL BE GIVEN TO MISS DIG PRIOR TO UNDERGROUND WORK TO BE PERFORMED IN ACCORDANCE WITH THIS CONTRACT. PHONE (800)-482-7171 OR 647-7344.

CONTRACTOR TO SUBMIT DETAILED CONSTRUCTION SEQUENCE AT THE PRECONSTRUCTION MEETING NOTING ALL CHANGES TO PROPOSED SCHEDULE OF WORK PROPOSED OR WORK PROPOSED TO OCCUR CONCURRENTLY WITH OTHER ITEMS OF WORK.

CONSTRUCTION NOTES:

DRIVEWAYS AND ENTRANCES TO BUILDINGS, REAL PROPERTY AND THE LIKE SHALL NOT BE BLOCKED EXCEPT FOR SHORT DURATIONS AND ONLY WHEN APPROVED BY THE ENGINEER. VEHICULAR ACCESS SHALL BE MAINTAINED AT ALL TIMES. IT SHALL BE THE CONTRACTOR'S RESPONSIBILITY TO COORDINATE ALL NECESSARY DRIVEWAY CLOSURES WITH THE COMPOST FACILITY OPERATOR IN THE AREAS OF CONSTRUCTION.

THE LOCATION AND DEPTH OF EXISTING UTILITIES AND SERVICE LEADS ARE TO BE FIELD VERIFIED BY THE CONTRACTOR PRIOR TO CONSTRUCTION.

LOCATION AND DEPTH OF UTILITIES AS DEPICTED ON THE PLANS IS APPROXIMATE AND SHOWN ACCORDING TO THE BEST INFORMATION AVAILABLE. IT IS THE CONTRACTOR'S RESPONSIBILITY TO EXCAVATE AHEAD AND ADJUST DEPTH OF UTILITIES IN CONFLICT ACCORDINGLY. AND DAMAGE TO UTILITIES IS THE CONTRACTOR'S RESPONSIBILITY TO AVOID AND/OR REPAIR AS NECESSARY.

DURING NON-WORKING HOURS, NO MORE THAN 25 FEET OF TRENCH SHALL REMAIN OPEN. ANY OPEN TRENCH SHALL BE PROPERLY SECURED WITH PROTECTIVE FENCING. THIS WORK SHALL NOT BE PAID SEPARATELY BUT INCLUDED IN THE COST OF THE PROJECT.

ALL TRENCHES SHALL BE EXCAVATED TO MIOSHA REQUIREMENTS, INCLUDING ANY REQUIRED TRENCH DESIGNS OUTLINED IN PART 9 OF THE GUIDELINES.

THE CONTRACTOR SHALL BACKFILL TRENCHES IN ACCORDANCE WITH TRENCH DETAILS SPECIFIED ON THE PLANS. CONCRETE REMOVALS AND REPLACEMENTS REQUIRED FOR THIS WORK WILL BE PAID SEPARATELY.

POSTAL DELIVERY AND REFUSE PICKUP SHALL BE MAINTAINED AT ALL TIMES BY THE CONTRACTOR.

WHEN STREET CURBS ARE UNDERMINED DUE TO CONSTRUCTION ACTIVITIES, THEY SHALL BE REMOVED AND REPLACED AS DIRECTED BY THE ENGINEER.

ALL CURB, SIDEWALK AND DRIVEWAY APPROACH REMOVALS SHALL BE APPROVED BY THE ENGINEER PRIOR TO THE WORK BEING COMPLETED.

SAWED SEWER PIPE CONNECTIONS SHALL BE COUPLED WITH A FERNCO FLEXIBLE COUPLING AND A STAINLESS STEEL SHEAR RING.

THE LOCATION OF MATERIAL STOCKPILES AND ONSITE STAGING AREAS SHALL BE APPROVED BY THE ENGINEER.

ALL STRUCTURES RECEIVING NEW CASTINGS AS DIRECTED BY THE ENGINEER, AS SPECIFIED BY THE CASTING SCHEDULE. THE EXISTING CASTINGS SHALL BECOME THE PROPERTY OF THE CITY OF

PAYMENT FOR DRAINAGE STRUCTURE SUMPS, WHERE SPECIFIED, SHALL BE INCLUDED IN THE PAYMENT FOR THE VARIOUS DRAINAGE STRUCTURE SIZE AND/OR TYPES.

WHERE SEWER PIPES OF DIFFERENT SIZES OR MATERIALS ARE JOINED, FERNCO FLEXIBLE COUPLINGS WITH STAINLESS STEEL SHEAR RINGS SHALL BE USED. THE CONTRACTOR'S PURCHASE PRICE FOR THESE DEVICES, INCLUDING SHIPPING, SHALL BE PAID AS AN EXTRA. PRIOR TO PAYMENT OF THIS ITEM, THE CONTRACTOR SHALL SUBMIT RECEIPTS FOR THE ENGINEER'S REVIEW AND APPROVAL. ALL OTHER COSTS ASSOCIATED WITH THE INSTALLATION OF THESE DEVICES SHALL BE INCLUDED IN THE PAYMENT OF THE SEWER.

THE CONTRACTOR SHALL BE RESPONSIBLE FOR ANY DAMAGE TO THE PROPERTY BEYOND THE SLOPE STAKE LINE, INCLUDING EXISTING FENCING, LAWN, TREES AND SHRUBBING.

TRAFFIC MAINTENANCE & CONTROL

ON-SITE TRAFFIC SHALL BE MAINTAINED SO AS TO NOT INTERFERE OR INTERRUPT THE OPERATIONS OF THE LANDFILL. CONTRACTOR TO COORDINATE WITH SITE OPERATIONS MANAGER PRIOR TO START OF CONSTRUCTION

<u>UTILITIES</u>

THE FOLLOWING UTILITY COMPANIES MAY HAVE FACILITIES WITHIN THE PROJECT LIMITS:

UTILITY CONTACT INFORMATION			
PUBLIC UTILITIES	OWNER	CONTACT	
FORESTRY		MATT WALDSMITH 734-794-6350 mwaldsmith@a2gov.org	
SANITARY SEWER	CITY OF ANN ARBOR	RYAN FERRELL 734-794-6350 rferrell@a2gov.org	
STORM SEWER	FIELD OPERATIONS SERVICE UNIT W.R. WHEELER SERVICE CENTER 4251 STONE SCHOOL ROAD	KEVIN ERNST 734-794-6350 X43327 kernst@a2gov.org	
TRAFFIC SIGNS & SIGNALS	ANN ARBOR, MI 48108	CHUCK FOJTIK 734-794-6350 X43322 cfojtik@a2gov.org	
WATER SYSTEM		DAN WOODEN 734-794-6350 X43324 dcwooden@a2gov.org	
PRIVATE UTILITIES	OWNER	CONTACT	
GAS	DTE 17150 ALLEN ROAD MELVINDALE, MI 48122	LAURIE FORRESTER 313-389-7261 laura.forrester@dteenergy.com	
ELECTRIC	DTE WESTERN WAYNE CENTER 8001 HAGGERTY RD BELLEVILLE, MI 48111	ANTHONY IGNASIAK 734-397-4447 anthony.ignasiak@dteenergy.con	
PHONE	AT&T METRO WEST LEGAL MANDATES 550 S. MAPLE RD, 2ND FLOOR ANN ARBOR, MI 48103	JEFF LEHMAN SR. 734-730-2013 jl4582@att.com	
CABLE	COMCAST 25626 TELEGRAPH RD SOUTHFIELD, MI 48033	DARYL WOOD daryl_wood@cable.comcast.com	
ITC	ITC 27175 ENERGY WAY NOVI, MI 48377	PAUL BELZAK pbelzak@itctransco.com	
FIBER OPTIC	MCI 2800 N. GLENFILLE ROAD RICHARDSON, TX 75082	DEAN BOYERS (972) 729-6016	

ALL UTILITIES WITHIN ZONE OF INFLUENCE OF PROPOSED WORK ARE TO BE FIELD LOCATED AND HAND DUG INCLUDED IN THE UNIT BID PRICES FOR APPROPRIATE ITEMS.

ALL GAS FACILITIES SHALL BE PROTECTED AND SUPPORTED PER MICHCON OR CONSUMER ENERGY STANDARDS AS APPLICABLE.

PRIOR TO WORK ON FACILITIES BELONGING TO THE ABOVE AGENCIES, A MINIMUM OF 72 HOURS NOTICE MUST BE GIVEN IN ORDER TO INSURE PROPER INSPECTION BY THE RESPECTIVE

CONCRETE, GRADE S3, SHALL BE USED TO ENCASE UTILITIES THAT ARE IN CLOSE PROXIMITY TO THE PROPOSED CONSTRUCTION ONLY AS DIRECTED BY THE ENGINEER.

ALL EXPLORATORY WORK REQUIRED FOR LOCATING EXISTING UTILITIES SHALL NOT BE PAID FOR SEPARATELY BUT SHALL BE INCLUDED IN THE CONSTRUCTION OF THE PROJECT.

THE EXISTING UTILITIES LISTED HEREIN AND SHOWN ON THESE PLANS REPRESENT THE BEST INFORMATION AVAILABLE AS OBTAINED FROM SURVEYS AND FROM UTILITY RECORD MAPS. THIS INFORMATION DOES NOT RELIEVE THE CONTRACTOR OF THE RESPONSIBILITY TO SATISFY HIMSELF AS TO THEIR ACCURACY OR OF HIS RESPONSIBILITY IN CASE UTILITIES HAVE BEEN CONSTRUCTED, RELOCATED OR REMOVED. OWNERS OF PRIVATE UTILITIES WILL NOT BE REQUIRED TO MOVE ADDITIONAL POLES AND STRUCTURES THAT ARE NOT SPECIFICALLY INDICATED AS SUCH ON THE PLANS.

THE CONTRACTOR SHALL LOCATE ALL ACTIVE UNDERGROUND UTILITIES PRIOR TO STARTING WORK, AND SHALL CONDUCT HIS OPERATIONS IN SUCH A MANNER AS TO INSURE THAT THOSE UTILITIES NOT REQUIRING RELOCATION WILL NOT BE DISTURBED.

FOR PROTECTION OF UNDERGROUND UTILITIES, THE CONTRACTOR SHALL DIAL 800-482-7171 A MINIMUM OF 3 WORKING DAYS, EXCLUDING SATURDAYS, SUNDAYS AND HOLIDAYS, PRIOR TO EXCAVATING IN THE VICINITY OF UTILITY LINES. ALL "MISS DIG" PARTICIPATING WILL THUS BE ROUTINELY NOTIFIED. THIS DOES NOT RELIEVE THE CONTRACTOR OF THE RESPONSIBILTY OF NOTIFYING UTILITY OWNERS WHO MAY NOT BE A PART OF THE 'MISS DIG' ALERT SYSTEM.

STAGING AREA NOTES

STAGING AREA FOR PROJECT SHALL BE LIMITED TO THE AREA SHOWN ON THE PLAN SHEETS

IF THE CONTRACTOR WOULD LIKE TO PROPOSE ANOTHER STAGING AREA LOCATION. HE MUST SUBMIT IT IN WRITING TO BE APPROVED BY THE ENGINEER.

RESTORATION FOR THE STAGING AREA SHALL INCLUDE BUT NOT BE LIMITED TO: FINAL GRADING, SODDING, GRAVEL ROAD REPAIRS AND REPLACEMENT PER DETAIL AND RESTORATION SPECIFICATIONS, REMOVAL OF ALL CONSTRUCTION DEBRIS, AND ANYTHING ELSE DEEMED NECESSARY TO RETURN AREA TO EXISTING CONDITIONS. PAID FOR UNDER LUMP SUM COST FOR "Restoration".

CONTRACTOR SHALL BE RESPONSIBLE FOR RESTORING DAMAGED PAVEMENT CAUSED BY HIS ACTIVITIES OUTSIDE THE WORK AREA AND DESIGNATED HAUL ROUTE.

THE STAGING AREA MUST BE FENCED OFF FROM THE PUBLIC, AND ONLY CONSTRUCTION RELATED TRAFFIC WILL BE PERMITTED WITHIN ITS LIMITS.

HEAVY EQUIPMENT ACCESS AND OPERATION

THE CONTRACTOR SHALL STAY WITHIN THE LIMITS OF CONSTRUCTION AND MINIMIZE THE AREA AND DURATION OF DISTURBANCE AT ALL TIMES. ALL OTHER TREE CLEARING NECESSARY TO CONSTRUCT THE PROJECT PER THE PLANS AND FOR SITE ACCESS SHALL BE MINIMIZED TO THE EXTENT POSSIBLE, AND APPROVED BY THE ENGINEER.

THE CONTRACTOR SHALL USE REASONABLE MEASURES TO AVOID SOIL COMPACTION BY HEAVY EQUIPMENT.

CONTRACTOR SHALL USE EQUIPMENT SUITABLE FOR WORK IN THE PONDS. THE INSPECTOR RESERVES THE RIGHT TO EXCLUDE ANY EQUIPMENT HE DEEMS UNACCEPTABLE TO ENTER THE PONDS DUE TO LEAKING FLUIDS, ACCUMULATED SEDIMENT OR OTHER POTENTIAL HAZARDS TO WATER QUALITY. TEMPORARY RIP RAP OR OTHER MEANS AS NECESSARY SHALL BE USED TO PROTECT THE BANKS WHEN ENTERING OR EXITING THE PONDS. THE ACCESS PATH WILL BE GRADED AND STABILIZED BY THE CONTRACTOR TO SUPPORT HIS OPERATIONS WHILE MINIMIZING DISRUPTION AND RESTORATION. THE CONTRACTOR SHALL PROVIDE ACCESS PLANS AND DETAILS FOR REVIEW AT THE PRECONSTRUCTION MEETING. ALL COSTS ASSOCIATED WITH THE CONTRACTOR'S CHOSEN MEANS OF ACCESS SHALL BE INCIDENTAL TO THE PROJECT AND INCLUDED IN OTHER LINE ITEMS AS NECESSARY. THE CONTRACTOR WILL NOT BE COMPENSATED FOR EXCESS CLEARING, GRADING, OR RESTORATION DUE TO THE CONTRACTOR'S OPERATIONS

ALL EQUIPMENT ENTERING THE SITE SHALL COMPLY WITH THE SPECIAL PROVISION PREVENT SPREADING OF INVASIVE SPECIES CONTROL MEASURES.

EARTH EXCAVATION

EARTH EXCAVATION SHOULD BE BASED ON SURVEYED CROSS-SECTIONS AND PROFILES. ACTUAL ELEVATIONS TO BE STAKED IN THE FIELD.

SPOILS DISPOSAL AREA NOTES

CONTRACTOR SHALL MAKE EVERY EFFORT TO PROTECT THE TREES LOCATED ADJACENT TO SPOILS AREAS. FILL DEPTHS SHALL NOT EXCEED 6 INCHES AT THE BASE OF TREES.

ALL SPOILS ARE TO BE PLACED WITH A MAX. SLOPE OF 1'V:5'H AND TO A MAX. HEIGHT OF 5 FEET.

THE SPOILS SHALL BE COVERED WITH 3"-4" OF ON-SITE TOPSOIL, SPECIFIED SEED MIX, AND MULCH.

SILT FENCE SHALL BE MAINTAINED AROUND THE BASE OF THE SPOILS UNTIL VEGETATION BECOMES FULLY ESTABLISHED.

CONSTRUCTION STAKING:

GRADING LIMITS, ELEVATIONS, AND LOCATIONS OF STRUCTURES AND BANK TREATMENTS SHALL BE STAKED BY THE ENGINEER. THE CONTRACTOR SHOULD PROVIDE 72 HOURS NOTICE OF STAKING NEEDS PRIOR TO WORK COMMENCING. THE CONTRACTOR SHALL MAINTAIN ALL STAKING THROUGH THE DURATION OF THE PROJECT.

RESTORATION

RESTORATION OF THE SITE SHALL BE IN ACCORDANCE WITH THE FOLLOWING AND SHALL BE PAID FOR AS INDICATED BELOW:

1. ALL DISTURBED AREAS IN THE FLOOD PLAIN SHALL BE RESTORED WITH SPECIFIED SEED MIX AND HYDROMULCH.

2. RESTORATION IN OTHER AREAS TO BE PER PLAN NOTES AND DETAILS. SEE LANDSCAPE PLANS. SHEETS L-1 & L-2.

REMOVE ALL CONSTRUCTION EQUIPMENT, EXCESS MATERIALS, DEBRIS, ETC., ESTABLISH FINE GRADE, AND RESTORE (PER PLANS AND SPECIFICATIONS). ALL COSTS FOR THE LABOR, EQUIPMENT AND MATERIALS SHALL BE INCLUDED IN UNIT PRICE BID FOR GRADING.

REMOVE ANY HAUL ROADS OR ACCESS ROADS, MATERIAL STOCKPILES, AND CONSTRUCTION FENCING. THIS SHALL BE CONSIDERED INCIDENTAL TO PROJECT ITEM.

ALL PAVEMENT DAMAGED DURING CONTRACTOR OPERATIONS SHALL BE REPLACED AT THE EXPENSE OF THE CONTRACTOR TO THE CITY OF ANN ARBOR SPECIFICATIONS.

WATER REQUIRED FOR SOD AND SEEDING SHALL BE INCLUDED IN THE CONTRACT COST FOR THESE ITEMS. WATER REQUIRED FOR COMPACTION SHALL BE INCLUDED IN THE COST OF CONSTRUCTION FOR THIS PROJECT. CONTRACTOR SHALL WATER THE PLANTINGS AND SEEDED AREAS DAILY FOR A MINIMUM OF 14 DAYS WITH AN ADDITIONAL FOUR (4) WATERING EVENTS IN THE FOLLOWING TWO WEEKS AFTER THE DAILY WATERING. WATERING SHALL NOT OCCUR ON SATURDAYS, SUNDAYS, OR IMMEDIATELY AFTER RAIN EVENTS. ALL EXCEPTIONS SHALL BE APPROVED BY THE PROJECT ENGINEER. WATER CAN BE TAKEN FROM THE RIVER FOR THE PLANTINGS.

ALL AREAS DISTURBED BY THE CONTRACTOR AND/OR HIS SUBCONTRACTOR BEYOND THE NORMAL CONSTRUCTION LIMITS OF THIS PROJECT SHALL BE RESTORED AS SPECIFIED OR DIRECTED BY THE ENGINEER. NO ADDITIONAL PAYMENT OR COMPENSATION WILL BE ALLOWED FOR THIS ACTIVITY. THIS INCLUDES RESTORATION TO ALL MATERIAL STORAGE OR STAGING AREAS.

SPRINKLER SYSTEMS SHALL NOT BE COVERED WHEN PLACING TOPSOIL AND SOD.

ALL DISTURBED AREAS TO BE RESTORED WITHIN SEVEN (7) DAYS OF COMPLETION. CONTRACTOR TO CHECK ON SEED AND SOD GROWTH & SUPPLEMENT AS NEEDED. COSTS FOR RESEEDING AND RESODDING TO BE INCLUDED IN THE UNIT PRICE FOR SITE RESTORATION.

MISCELLANEOUS ITEMS OF WORK

SEVERAL PAY ITEMS INCLUDED IN THE PROPOSAL ARE NOT SPECIFICALLY SHOWN ON THE PLANS. THESE ITEMS SHALL BE CONSTRUCTED AS DIRECTED BY THE PROJECT ENGINEER OR USED AS NEEDED. THEY ARE:

MOBILIZATION, 10% MAX.	LS
AUDIO VIDEO SITE SURVEY	LS
VEGETATIVE ESTABLISHMENT AND INVASIVE CONTROL MEASURES	LS
TRAFFIC MAINTENANCE AND CONTROL	LS
FLOW MANAGEMENT	LS
BYPASS PUMPING	LS
RESTORATION	LS

MISCELLANEOUS

FOR PROPOSED WORK IN AREAS CLOSE TO UTILITY POLES, NO EXCAVATIONS WITHIN TEN (10) FEET AND NO BORES WITHIN (3) FEET FROM THE UTILITY POLES ARE ALLOWED.

CONTRACTOR RESPONSIBLE TO REPAIR OR REPLACE ANY EXISTING TRAFFIC SIGNS DAMAGED BY HIS OPERATION DURING CONSTRUCTION. SIGNS TO BE IN ACCORDANCE WITH THEE LATEST EDITION OF THE MMUTCD.

ACCESS TO AREAS OUTSIDE OF PROJECT LIMITS TO BE APPROVED BY THE ENGINEER PRIOR TO START OF CONSTRUCTION.

CONTRACTOR TO COORDINATE CONSTRUCTION ACTIVITIES WITH OTHER CONTRACTORS WORKING IN AREA.

CONTRACTOR IS TO REVIEW SOIL BORING DATA & RECOMMENDATIONS AS PREPARED BY THE GEOTECHNICAL FIRM IF AVAILABLE.

ANY DEWATERING NECESSARY TO CONSTRUCT THIS PROJECT SHALL BE CONSIDERED INCIDENTAL AND ALL COSTS ASSOCIATED SHALL BE INCLUDED IN THE UNIT BID PRICE FOR THE AFFECTED UTILITY INSTALLATION

ALL UTILITY CROSSINGS TO HAVE A MINIMUM OF 18" VERTICAL CLEARANCE TYPICAL.

NO RAP (RECYCLED ASPHALT PRODUCTS) WILL BE ALLOWED IN ANY WEARING COURSE

NO BROKEN CONCRETE IN ANY RIP RAP WILL BE ALLOWED ON THIS PROJECT.

SEQUENCE OF CONSTRUCTION - SOIL EROSION CONTROL

1. THE CONTRACTOR SHALL INSTALL AND MAINTAIN THE SEDIMENT TRAP, TEMPORARY SOIL EROSION AND SEDIMENT CONTROL MEASURES PRIOR TO COMMENCEMENT OF EARTH CHANGE. CONTRACTOR TO PLACE APPROVED SOIL EROSION BARRIERS AND CONSTRUCTION FENCING. WHILE SILT FENCE IS NOT SHOWN ON THE PLANS AS THE PROPOSED WORK IS WITHIN THE STREAM AND FLOODPLAIN, IT SHALL BE PLACED AROUND ALL MATERIAL STOCKPILE AREAS PER DETAILS.

2. REMOVE VEGETATION AND TOPSOIL FROM CONSTRUCTION AREA.

3. BEGIN CONSTRUCTION.

4. CHECK AND MAINTAIN SOIL EROSION CONTROL MEASURES DAILY. ALL TEMPORARY SOIL EROSION AND SEDIMENTATION CONTROL MEASURES SHALL BE MAINTAINED UNTIL PERMANENT SOIL EROSION AND SEDIMENTATION CONTROL MEASURES ARE IN PLACE AND THE AREA IS STABILIZED.

5. COMPLETE CONSTRUCTION

6. RESTORE ALL DISTURBED AREAS AS SPECIFIED HEREIN. PERMANENT SOIL EROSION AND SEDIMENTATION CONTROL MEASURES FOR ALL SLOPES, CHANNELS, DITCHES OR ANY DISTURBED AREA SHALL BE INSTALLED WITHIN FIVE (5) CALENDAR DAYS AFTER FINAL GRADING OR THE FINAL EARTH CHANGE HAS BEEN COMPLETED.

7. CONTRACTOR TO MAINTAIN SEDIMENT CONTROL MEASURES THROUGHOUT THE DURATION OF THE PROJECT UNTIL GRASS IS ESTABLISHED, THEN THE CONTRACTOR IS TO REMOVE THEM.

ALL SOIL EROSION CONTROL MEASURES AS SHOWN ON THESE PLANS OR AS NEEDED TO COMPLETE THIS PROJECT PAID FOR AT THE UNIT PRICES AS INCLUDED IN THE PROPOSAL. ADDITIONAL SILT FENCE AND/OR OTHER SOIL EROSION CONTROL MEASURES MAY BE REQUIRED.

PERMITS TO BE OBTAINED BY THE CONTRACTOR PRIOR TO THE BEGINNING OF CONSTRUCTION		
PERMIT	ISSUING AUTHORITY	
GRADING/SOIL EROSION & SEDIMENTATION CONTROL PERMIT *	CITY OF ANN ARBOR PROJECT MANAGEMENT UNIT	
LANE CLOSURE PERMIT*	CITY OF ANN ARBOR PROJECT MANAGEMENT UNIT	
* NO COST TO CONTRACTOR		



HUBBELL, ROTH & CLARK. INC CONSULTING ENGINEERS SINCE 1915 555 HULET DRIVE P.O. BOX 824 BLOOMFIELD HILLS, MICH.

PHONE: (248) 454-6300 FAX (1st. Floor): (248) 454-6312 FAX (2nd. Floor): (248) 454-6359 WEB SITE: http://www.hrcengr.com

E ELLSWORTH RD E MORGAN RD

09/18/20 ISSUED FOR CITY PERMITS

DESIGNED D.HURRISH

CHECKED J.BALINT, A.GROAT

APPROVED J.BALINT, A.GROAT

DRAWN

06/18/20 ISSUED FOR OWNER REVIEW

ADDITIONS AND/OR REVISIONS

WHEELER FACILITY POND DREDGING

PROJECT NOTES

RC JOB NO. SCALE NTS 20190818 SHEET NO. A EGLE-V April 2020

CONTRACTOR SHALL OBTAIN ALL LOCAL AND STATE PERMITS REQUIREMENT TO WORK WITHIN THE UTILITY, ROAD, AND DRAIN RIGHT-OF-WAYS UNLESS OTHERWISE PROVIDED

CONTRACTOR SHALL CONFORM TO THE SOIL EROSION AND SEDIMENTATION CONTROL ACT, PART 91 OF ACT 451 OF 1994, CITY OF ANN ARBOR STANDARDS, AND MACDC

ALL WORK SHALL BE WITHIN IDENTIFIED EASEMENTS. WORK OUTSIDE EASEMENTS MUST BE AGREED UPON BY LANDOWNER AND ENGINEER WITH A SIGNED LANDOWNER AGREEMENT FORM (SEE SPECIFICATION) PRIOR TO WORK ON THAT PROPERTY

CONTRACTOR SHALL FIELD LOCATE ALL UTILITIES PRIOR TO BEGINNING CONSTRUCTION AND SHALL NOTIFY THE ENGINEER IF POSSIBLE CONFLICT EXISTS

ANY UTILITIES ENCOUNTERED DURING CONSTRUCTION SHALL BE SUPPORTED, PER THE SPECIFICATIONS OF THE INDIVIDUAL UTILITY COMPANY CLAIMING OWNERSHIP OF THE UTILITY. COST ARE IDENTIFIED AND INCLUDED WITH THE PAY ITEM BEING INSTALLED. ANY UTILITIES DAMAGED DURING CONSTRUCTION SHALL BE REPAIRED AT THE CONTRACTOR'S

PROTECT ALL BITUMINOUS ROADS, DRIVES, OR PARKING AREAS NOT SPECIFIED TO BE REMOVED DURING CONSTRUCTION. REPAIR ANY UNAUTHORIZED DAMAGE AT CONTRACTOR'S EXPENSE

THE CONTRACTOR SHALL MAINTAIN LOCAL TRAFFIC AND ACCESS TO HOMES AT ALL TIMES DURING THE PROJECT. COST SHALL BE INCLUDED IN THE PAY ITEM FOR MAINTAINING TRAFFIC. 24-48 HOURS NOTICE IS REQUIRED OF ALL IMPACTED AREAS

THE CONTRACTOR SHALL CAREFULLY REMOVE AND NEATLY STOCKPILE ALL FENCES, LANDSCAPING, ETC. OUTSIDE OF THE EASEMENT

WORK HOURS ARE 7 AM TO 7 PM MONDAY THROUGH SATURDAY. WORK ON SUNDAYS AND HOLIDAYS IS NOT PERMITTED WITHOUT OWNER APPROVAL.

ALL EXCAVATED MATERIAL NOT TO BE REUSED OR DISPOSED OF ON SITE SHALL BE REMOVED FROM SITE. THE CONTRACTOR IS RESPONSIBLE FOR DISPOSING OF MATERIALS ACCORDING TO LOCAL AND STATE REQUIREMENTS

ALL RIP RAP SHALL BE NATURAL TYPE MATERIAL AS APPROVED BY THE ENGINEER UNLESS OTHERWISE DIRECTED. SUBMIT SAMPLES TO ENGINEER FOR APPROVAL PRIOR TO CONSTRUCTION. OWNER AND ENGINEER RESERVES THE RIGHT TO REJECT ANY AND ALL

CONTRACTORS SHALL FINISH GRADE, SEED, FERTILIZE, AND MULCH DAILY ON ALL DISTURBED AREAS AS DESCRIBED IN THE SPECIFICATIONS. ALL AREAS TO RECEIVE LANDSCAPE SEEDING SHALL HAVE 4" TOPSOIL PLACED AS DETAILED IN THE SPECIFICATIONS. TOPSOIL SHALL BE STRIPPED AND STOCKPILED FOR USE AS TOPSOIL SURFACE AS DIRECTED BY THE ENGINEER

CONTRACTOR SHALL MAINTAIN ACCESS FOR POSTAL AND PARCEL DELIVERY AND GARBAGE AND RECYCLING PICKUP AT ALL TIMES. CONTRACTOR IS RESPONSIBLE FOR TAKING THE NECESSARY ACTIONS IF SERVICE IS INTERRUPTED. CONTRACTOR SHALL PROTECT, REMOVE AND REPLACE ALL MAILBOXES AND POSTS. ANY DAMAGED MAILBOXES AND POSTS SHALL BE REPLACED AT CONTRACTOR'S EXPENSE

CONTRACTOR SHALL PROTECT ALL POWER POLES. POWER POLES WITHIN DRAIN INFLUENCE SHALL BE RELOCATED OR REMOVED BY OTHERS AS SPECIFIED ON PLANS

CONTRACTOR SHALL PROTECT ALL TELEPHONE PEDESTALS & RISERS. TELEPHONE PEDESTALS & RISERS WITHIN DRAIN BANKS SHALL BE RELOCATED OUTSIDE OF DRAIN BANKS BY OTHERS

CONTRACTOR SHALL CLEAN OUT ALL SIDE DITCHES TO LIMITS OF EASEMENT OR AS

COORDINATE DRIVE CLOSURES AND MAILBOX RELOCATION WITH LANDOWNERS A MINIMUM OF ONE DAY IN ADVANCE

CONTRACTOR TO PROVIDE DUST CONTROL AND SWEEP ROADS DAILY

UNDERGROUND UTILITIES/MISS DIG

FOR PROTECTION OF UNDERGROUND UTILITIES AND IN CONFORMANCE WITH PUBLIC ACT 174, 2013, THE CONTRACTOR SHALL DIAL 1-800-482-7171 OR 811 A MINIMUM OF THREE FULL WORKING DAYS, EXCLUDING SATURDAYS, SUNDAYS, AND HOLIDAYS PRIOR TO BEGINNING EACH EXCAVATION IN AREAS WHERE PUBLIC UTILITIES HAVE NOT BEEN PREVIOUSLY LOCATED. MEMBERS WILL THUS BE ROUTINELY NOTIFIED. THIS DOES NOT RELIEVE THE CONTRACTOR OF THE RESPONSIBILITY OF NOTIFYING UTILITY OWNERS WHO MAY NOT BE A PART OF THE "MISS DIG" ALERT SYSTEM

ALL CONSTRUCTION UNDER CLASS III UTILITIES, INCLUDING HOUSE SERVICES, SHALL BE COMPLETELY BACKFILLED WITH SAND, IN 12" LAYERS, AND COMPACTED TO NOT LESS THAN 95% OF MAXIMUM UNIT WEIGHT

THE CONTRACTOR SHALL MAINTAIN LOCAL TRAFFIC AT ALL TIMES. SIGNAGE MUST BE IN ACCORDANCE WITH THE MICHIGAN MANUAL ON UNIFORM TRAFFIC CONTROL DEVICES AND SHALL BE COORDINATED WITH THE ENGINEER AND GOVERNING ROAD AGENCY. PERMITS MAY BE REQUIRED. PAID FOR AS TRAFFIC CONTROL

PRIOR TO COMMENCING CONSTRUCTION, THE CONTRACTOR IS RESPONSIBLE FOR OBTAINING ALL PERMITS REQUIRED BY THE APPROPRIATE AGENCIES

CONTRACTOR SHALL RESTORE INCIDENTAL DAMAGES ON THE PROJECT AS DIRECTED BY OWNER AND ENGINEER

REMOVE EXISTING FENCES, LANDSCAPING, AND OTHER STRUCTURES IN THE EASEMENT AS NEEDED FOR CONSTRUCTION. REINSTALLATION OF FENCES MUST BE COORDINATED WITH THE LAND OWNER. PAID FOR AS "REMOVE & REPLACE FENCE"

TOPSOIL SHALL BE STRIPPED AND STOCKPILED FOR USE AS TOPSOIL SURFACE AS DIRECTED BY THE ENGINEER. RESTORE ALL LAWN AREAS WITH 4" OF TOPSOIL AND SEED AND MULCH

ALL SPRINKLER SYSTEMS DAMAGED SHALL BE REPAIRED BY THE CONTRACTOR. COST TO BE INCLUDED IN OTHER WORK ITEMS OF THE PROJECT

CONTRACTOR SHALL COORDINATE RELOCATION/REMOVAL OF ALL TREES WITHIN THE

LIMITS OF CONSTRUCTION WITH THE PROPERTY OWNER AND ENGINEER

CONTRACTOR TO CLEAR TREES, STUMPS, AND BRUSH WITHIN THE EASEMENT AS NECESSARY FOR CONSTRUCT DRAIN (MIN 20 FT CENTERED ON STORM SEWER) AND LEVEL OR HAUL SPOILS AS SHOWN ON PLANS AND DETAILS. TREES, STUMPS, AND BRUSH SHALL BE TAKEN OFF-SITE UNLESS A SIGNED LAND OWNER AGREEMENT IS OBTAINED BY CONTRACTOR. IF A LAND OWNER AGREEMENT IS SIGNED, WOODY DEBRIS MUST BE PLACED OUTSIDE OF DRAIN EASEMENT.

GENERAL NOTES (CONT)

ELECTRIC, GAS AND TELEPHONE UTILITIES LOCATED IN THE ROAD AND EASEMENT WILL BE RELOCATED BY OTHERS IF NECESSARY

ANY UTILITIES DAMAGED DURING CONSTRUCTION SHALL BE REPAIRED AT THE CONTRACTOR'S EXPENSE

GRADING AROUND MANHOLES/CATCH BASINS, FLARED END SECTIONS, AND OTHER INLETS DETERMINED BY THE ENGINEER PROPERLY SHALL BE SMOOTH AND SHAPED TO PROVIDE POSITIVE DRAINAGE INTO THE INLETS

ALL MANHOLE TO PLASTIC PIPE CONNECTIONS SHALL BE MADE WITH KOR-N-SEAL BOOT OR ENGINEER APPROVED EQUAL

ALL STORM SEWER SHALL BE PREMIUM JOINT UNLESS OTHERWISE SPECIFIED

ALL FLARED END SECTIONS UNDER 8" IN DIAMETER SHALL HAVE FACTORY SUPPLIED

DEMOLISH EXISTING STRUCTURE(S) AND DISPOSE OF IN ACCORDANCE WITH LOCAL, STATE, AND FEDERAL REQUIREMENTS, INCIDENTAL TO THE PROJECT

CONTRACTOR SHALL CONNECT ANY AND ALL FIELD TILE OUTLETS AND OTHER STORM LEADS TO PROPOSED STORM SEWER WITH PRE-MANUFACTURED TEES, WYES, GASKETS, SEALS, COUPLERS, BOOTS, ETC. COST TO BE PAID FOR AS PART OF LATERAL TILE DRAIN

RIM GRADES ARE SUBJECT TO ADJUSTMENT PER PROJECT ENGINEER DEPENDING ON FIELD CONDITIONS.

REPRESENTATIVE

TOPSOIL, RAKE, SEED, AND MULCH ALL DISTURBED GRASS AREAS. FOR FARM AREAS, REPLACE TOPSOIL, RAKE, AND FINISH GRADE. CONTRACTOR SHALL DEEP RIP ANY AREAS THAT ARE COMPACTED DUE TO CONSTRUCTION ACTIVITIES PRIOR TO PLACING TOPSOIL.

REMOVE AND PROPERLY DISPOSE OF EXISTING TILE & STRUCTURES LOCATED WITHIN PROPOSED STORM SEWER TRENCH. REMOVED STRUCTURES & TILE OR DEBRIS SHALL BECOME PROPERTY OF THE CONTRACTOR. REMOVAL TO BE INCLUDED IN THE COST PER LINEAR FOOT OF STORM SEWER.

CONNECTION TO PROPOSED HDPE STORM SEWER SHALL BE SOIL TIGHT AND SHALL BE MADE WITH PRE-MANUFACTURED FITTINGS APPROVED BY THE ENGINEER.

CONTRACTOR SHALL FIELD VERIFY ANGLE OF CONNECTION PRIOR TO CONSTRUCTION

CONTRACTOR IS RESPONSIBLE FOR SETTING UP AND MAINTAINING TRAFFIC CONTROL PER THE WASHTENAW COUNTY ROAD COMMISSION STANDARDS FOR THE COURSE OF THE

CONTRACTOR SHALL TIE IN ALL SUMP CONNECTIONS. PRIVATE DRAINS, AND OTHER STORM WATER DRAINAGE SYSTEMS WITHIN THE INFLUENCE OF THE STORM DRAIN. CONNECTIONS SHALL BE MADE WATER-TIGHT USING "INSERT-A-TEE" OR APPROVE EQUAL. COST SHALL BE INCLUDED IN THE UNIT PRICE FOR HOUSE LEAD REPAIR OR LATERAL TILE DRAIN REPAIR.

CONTRACTOR SHALL SUPPORT ALL EXISTING UTILITIES DURING CONSTRUCTION PER THE REQUIREMENTS OF UTILITY REPRESENTATIVE, ENGINEER, OWNER AND/OR OWNER'S

CONTRACTOR SHALL MAINTAIN DRAINAGE DURING CONSTRUCITON

CONTRACTOR SHALL COORDINATE INSTALLATION OF EROSION CONTROL STRUCTURES WITH ENGINEER PRIOR TO CONSTRUCTION. LOCATIONS, QUANTITIES, OR TYPES MAY VARY BASED ON FIELD DECISIONS

CONTRACTOR TO HAUL ALL WOODY DEBRIS.

THE CONTRACTOR SHALL PROTECT ALL ROADWAY AND DRIVEWAY DITCH SLOPES DURING CONSTRUCTION. COST SHALL BE INCIDENTAL TO THE PROJECT

COORDINATE FINAL LOCATION OF TEES AND CATCH BASINS WITH ENGINEER


CONTRACTOR TO COORDINATE FINAL RIM GRADES WITH OWNER/ENGINEER IN THE FIELD. ADJUSTMENT SHALL BE INCIDENTAL TO PROJECT



HUBBELL, ROTH & CLARK, INC CONSULTING ENGINEERS SINCE 1915 555 HULET DRIVE BLOOMFIELD HILLS, MICH.

PHONE: (248) 454-6300 FAX (1st. Floor): (248) 454-6312 FAX (2nd. Floor): (248) 454-6359

WEB SITE: http://www.hrcengr.com

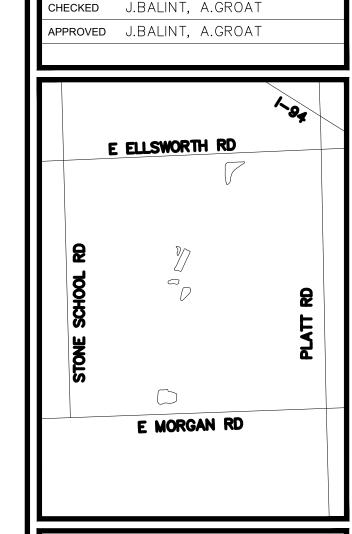

09/18/20 ISSUED FOR CITY PERMITS

06/18/20 ISSUED FOR OWNER REVIEW

ADDITIONS AND/OR REVISIONS

WHEELER FACILITY POND DREDGING

PROJECT NOTES

HRC JOB NO.	SCALE
20190818	NTS
DATE April 2020	SHEET NO. B

SEED MIX A

SEED MIX A:

SPECIES	COMMON NAME	RATE (LBS./AC.
Agrostis alba palustris	Bent Grass	6.000
Alisma subcordatum	Common Water Plantain	0.375
Asclepias incarnata	Swamp Milkweed	0.062
Aster nova-angliae	New England Aster	0.062
Aster simplex	Panicled Aster	0.031
Bidens cernua	Nodding Bur Marigold	0.312
Bidens frondosa	Common Beggar's Tick	0.125
Boltonia latisquama	False Aster	0.188
Carex bebbii	Bebb's Sedge	0.125
Carex comosa	Bottlebrush Grass	0.125
Carex lupuliformis	Knobbed Hop Sedge	0.062
Carex stipata	Awl-fruited Sedge	0.125
Carex scoparia	Pointed Broom Sedge	0.125
Carex vulpinoidea	Fox Sedge	0.500
Eleocharis species	Spike Rush Species	0.062
Elymus virginicus	Virginia Wild Rye	1.500
Eupatorium maculatum	Spotted Joe Pye Weed	0.125
Glyceria striata	Fowl Manna Grass	0.125
Helenium autumnale	Sneezeweed	0.250
Iris virginica	Southern Blue Flag	0.188
Juncus species	Rush Species	0.062
Leersia oryzoides	Rice Cut Grass	0.188
Ludwigia polycarpa	False Loosestrife	0.001
Mimulus ringens	Monkeyflower	0.031
Onoclea sensibilis	Sensitive Fern	0.031
Penthorum sedoides	Ditch Stonecrop	0.001
Polygonum hydropiperoides	Mild Water Pepper	0.750
Rudbeckia laciniata	Green Coneflower	0.125
Sagittaria latifolia	Duck Potato	0.062
Scirpus atrovirens	Dark Green Rush	1.250
Scirpus fluviatilis	River Bulrush	0.125
Scirpus pendulus	Red Bulrush	0.031
Scirpus validus	Soft Stem Bulrush	0.031
Sparganium eurycarpum	Common Bur-Reed	0.062
Verononia fasciculata	Common Ironweed	0.062
Verbena hastata	Blue Vervain	0.125
	TOTAL:	13.404

SPECIES	COMMON NAME	RATE (25 LBS./AC.)

Cover Crop

Avena sativa Seed Oats 33% Red Top Grass 33% Agrostis gigantes Annual Rye 33% Lolium multiflorum

NOTES:

Seed mix to be broadcast over the wetland mitigation and enhancement areas as indicated on the plans. This is Geneisi Nurseeryy's Sedge Ghetto--The Next Generation seed mix modified for use in Michigan. A total of 109.91 pounds needed for ± 8.20 acres of wetland mitigation and enhancement.

SEED MIX B

SEED MIX B:

SPECIES	COMMON NAME	RATE (LBS/AC.)
Andropogon scoparius	Little Bluestem	3.000
Avena sativa	Seed Oats	20.000
Elymus virginicus	Virginia Wild Rye	1.000
Asclepias syriaca	Common Milkweed	0.063
Aster ericoides	Heath Aster	0.031
Aster nova-angliae	New England Aster	0.250
Desmodium canadense	Showy Tick Trefoil	0.031
Echinacea pallida	Pale Purple Coneflower	0.063
Echinacea purpurea	Purple Coneflower	0.375
Heliopsis helianthodes	False Sunflower	0.125
Lespedeza capitata	Roundheaded Bush Clover	0.125
Liatris spicata	Spiked Gayfeather	0.125
Monarda fistulosa	Bergamot	0.031
Parthenium integrifolium	Wild Quinine	0.375
Penstemon digitalis	Foxglove Beardtongue	0.063
Petalostemum purpureum	Purple Prairie Clover	0.250
Ratibida pinnata	Yellow Coneflower	0.250
Rudbeckia hirta	Black-eyed Susan	0.375
Rudbeckia subtomentosa	Sweet Coneflower	0.063
Solidago rigida	Rigid Goldenrod	0.375
	TOTAL:	26.970

NOTE:
Seed mix to be broadcast over upland areas for meadow. This is Genesis Nursery's Lo pro
prairie for clay soils.

00		
SPECIES	COMMON NAME	RATE (LBS/AC.
Bromus latiglumis	Ear-Leafed Brome	0.125
Bromus pubescense	Woodland Brome	0.031
Elymus canadensis	Canada Wild Rye	1.000
Glyceria striata	Fowl Manna Grass	0.062
Hystrix patula	Bottlebrush Grass	0.062
Anemone virginiana	Tall anemone	0.031
Aquilegia canadensis	Columbine	0.006
Aster drummondii	Drummond's Aster	0.031
Aster lateriflorus	Side-flowering Aster	0.031
Aster sagittifolius	Arrow-leafed Aster	0.062
Clematis virginiana	Virgin's Bower	0.031
Pycnanthemum pilosum	Hairy Mt. Mint	0.016
Smilacina racemosa	Feathery False Solomon's Seal	0.016
Solidago flexicaulis	Zig Zag Goldenrod	0.031
Solidago juncea	Early Goldenrod	0.031
	TOTAL:	1.566

SPECIES	COMMON NAME	RATE (25 LBS./AC.)
Cover Crop		

Avena sativa Seed Oats Red Top Grass 33% Agrostis gigantes Annual Rye 33% Lolium multiflorum

NOTES:

Seed mix to be broadcast over woodland edges and interior areas with thin canopy. This is Genesis Nursery's Mesic to Dry Open Woodland seed mix.

Seed mix to be covered with North American Green C125bn erosion control blanket or equivalent installed in compliance with manufacturer's specifications on all slope areas exceeding 1 on 3.

SEED MIX C

SPECIES	COMMERCIAL NAME	RATE (LBS/AC.)
Turk type tall fescus	Rebel, Apache or equal	250
Perrenial rye grass	K-31, Pennington or equal	250
Kentucky bluegrass	Glade, Palmer II or equal	250
	·	

TOTAL: 750 NOTES:

Seed mix to be covered with North American Green C125bn erosion control blanket or equivalent installed in compliance with manufacturer's specifications on all slope areas exceeding 1 on 3.

Seed mix to be broadcast over all lawn areas disturbed by construction activities not specifically designated to be seeded by another mix specified on the sheet or on the plans.

SEED MIX D

WETLAND PLANTS:


SPECIES	COMMON NAME	QUANTITY	SIZE
Acorus calamus	Sweet Flag	75 / 100 sft	Tuber or Plants
Iris virsacolor	Blue Flag	75 / 100 sft	Tuber or Plants
Juncus effusus	Soft-Stemmed Rush	75 / 100 sft	Tuber or Plants
Nymphaea tuberosa	Sweet-Scented Waterlily	75 / 100 sft	Tuber or Plants
Peltandra virginica	Arrow-Arum	75 / 100 sft	Tuber or Plants
Polygonum amphibium	Water Smartweed	75 / 100 sft	Tuber or Plants
Pontederia cordata	Pickerel Weed	75 / 100 sft	Tuber or Plants
Sagittaria latifolia	Common Arrowhead	75 / 100 sft	Tuber or Plants
Schoenoplectus acutus	Bulrush	75 / 100 sft	Tuber or Plants
Scirpus cyperinus	Wool-Grass	75 / 100 sft	Tuber or Plants
Sparganium americanum	American Bur-Reed	75 / 100 sft	Tuber or Plants
Sparganium eurycarpum	Common Bur-Reed	75 / 100 sft	Tuber or Plants
Scirpus americanus	3 Square Bulrush	75 / 100 sft	Tuber or Plants

Plant Zone B species in group of 25 plants of any three species within each 100 sft planting zone having 3 different species each.

OFFSET ROW OF NATIVE SHRUBS — PLANT SHRUBS IN GROUPS OF 5 TO 7 OF SAME SPECIES (5'+ ON CENTER OFFSET)


TYPICAL PLUG LAYOUT PLAN

NTS

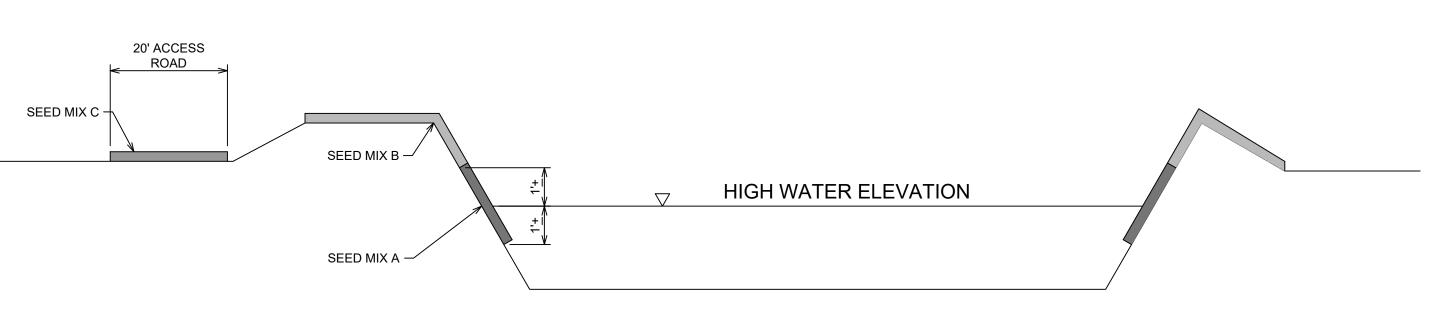

Know what's **below Call** before you dig.

CALL MISS DIG 72 HOURS (3 WORKING DAYS) **BEFORE YOU DIG** 1-800-482-7171 OR 811 (TOLL FREE)

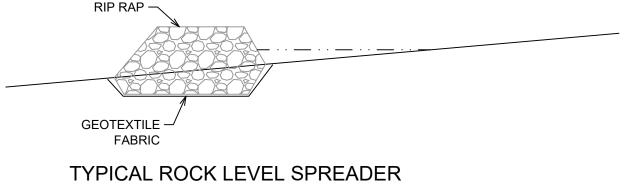

TYPICAL SEEDING MIX NTS

POND DREDGING

WHEELER FACILITY

E MORGAN RD

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DESIGNED D.HURRISH

CHECKED J.BALINT, A.GROAT

APPROVED J.BALINT, A.GROAT

E ELLSWORTH RD

06/18/20 ISSUED FOR OWNER REVIEW


DATE ADDITIONS AND/OR REVISIONS


P.O. BOX 824


PROJECT DETAILS


HRC JOB NO. NTS 20190818 SHEET NO. C EGLE-W April 2020

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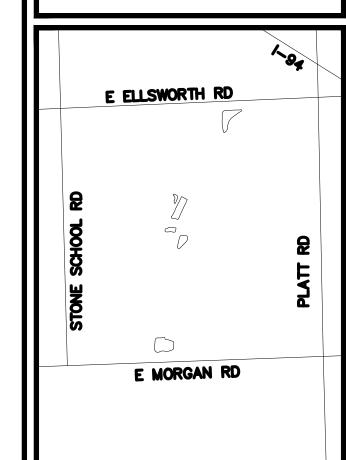
09/18/20 ISSUED FOR CITY PERMITS
06/18/20 ISSUED FOR OWNER REVIEW
DATE ADDITIONS AND/OR REVISIONS

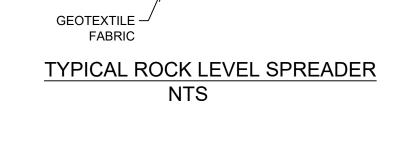DESIGNED D.HURRISH

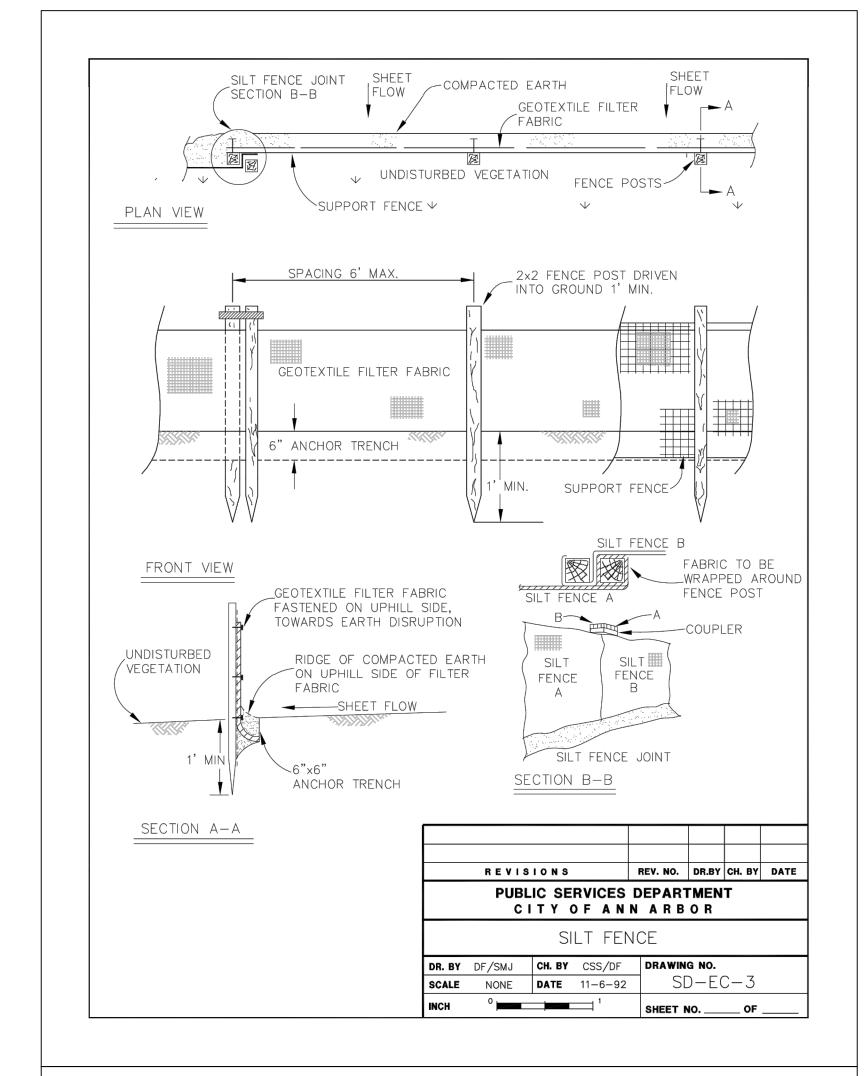DRAWN D.HURRISH

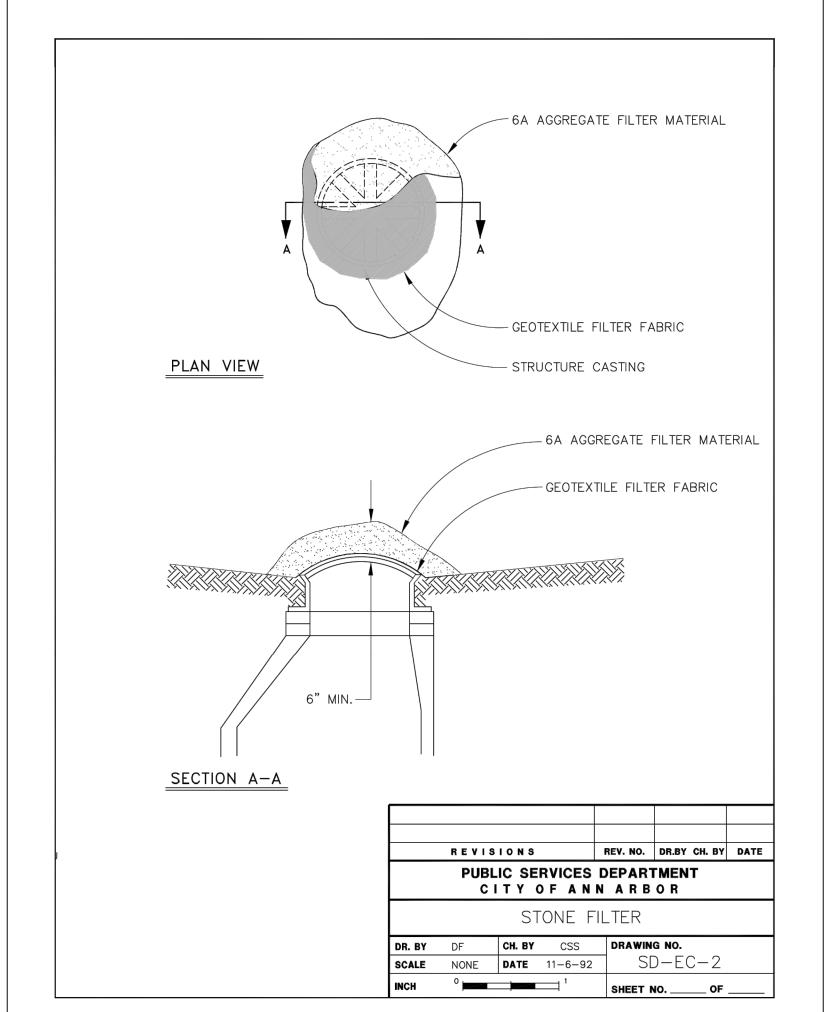CHECKED J.BALINT, A.GROAT

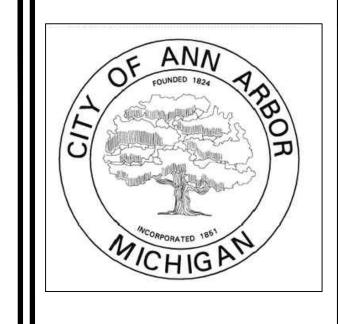APPROVED J.BALINT, A.GROAT



WHEELER FACILITY POND DREDGING

CITY OF ANN ARBOR SESC DETAILS

DATE
April 2020

SCALE
NTS


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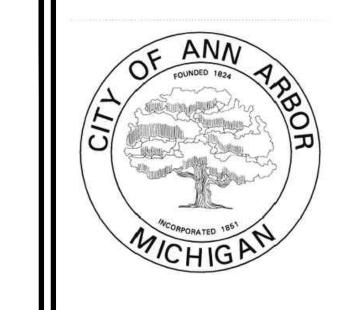
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CALL MISS DIG
72 HOURS
(3 WORKING DAYS)
BEFORE YOU DIG
1-800-482-7171
OR 811

(TOLL FREE)





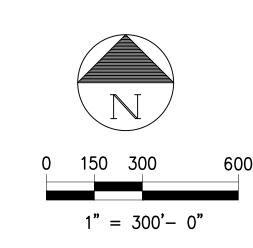


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WHEELER FACILITY POND DREDGING

OVERALL SITE PLAN

HRC JOB NO. 1"=300' 20190818 April 2020



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WHEELER FACILITY POND DREDGING

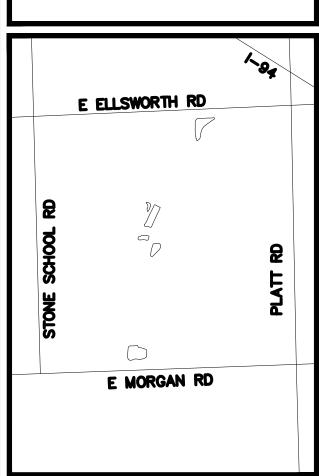
E MORGAN RD

E ELLSWORTH RD

SOUTH COMPOST PAD POND

IRC JOB NO. 20190818 April 2020

ORIGINAL PLOT SIZE: ARCH FULL BLEED D (36.00 X 24.00 INCHES)

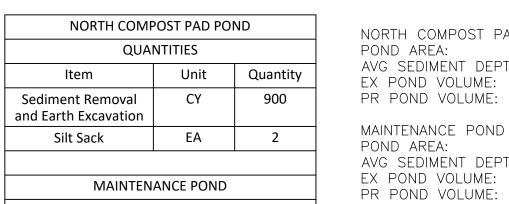

QUANTITIES Unit Quantity Item Sediment Removal

EMERGENT

WETLANDS

NORTH COMPOST PAD POND POND AREA: 28,900 SF AVG SEDIMENT DEPTH: 0.57 FT 2,300 CY 3,200 CY EX POND VOLUME: PR POND VOLUME:


MAINTENANCE POND 16,380 SF POND AREA: AVG SEDIMENT DEPTH: 0.55 FT

300 CY

1,100 CY

- ALL EX CONTOURS SHOWN ARE BOTTOM OF POND ELEVATIONS - EXISTING AERATORS WILL BE REMOVED FROM PONDS BY


FACILITY STAFF - REMOVE PHARMGMITES AS PART OF DREDGING OPERATION

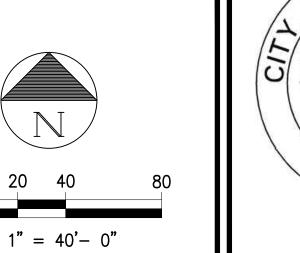


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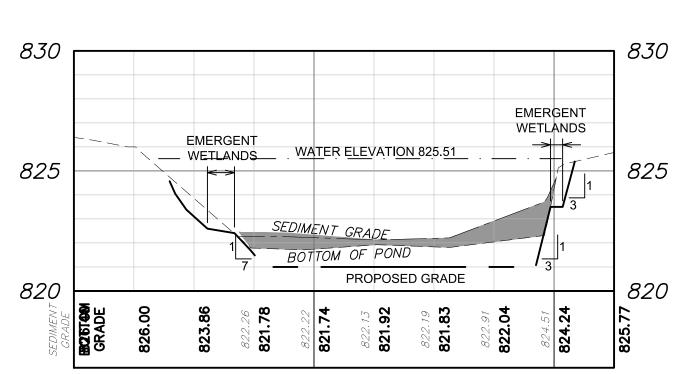
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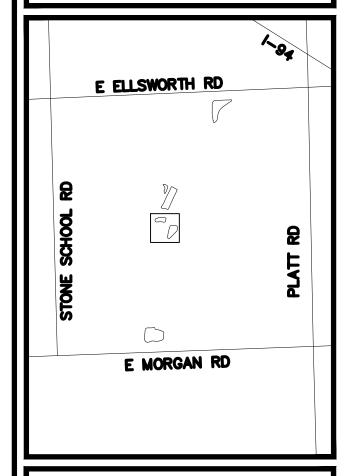
MAINTENANCE POND A-A



MAINTENANCE POND B-B

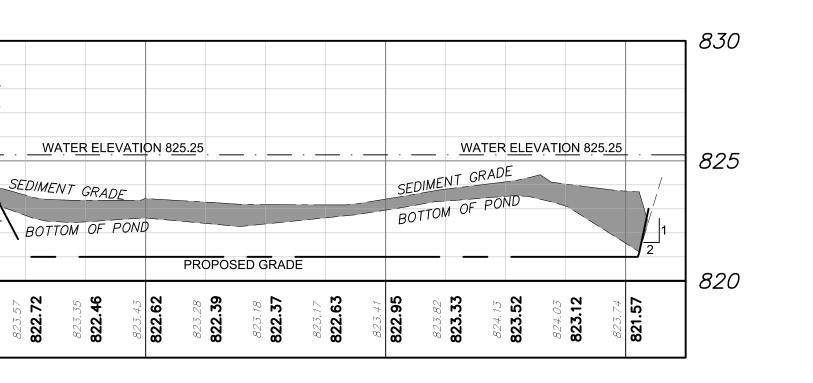

NORTH COMPOST PAD POND B-B

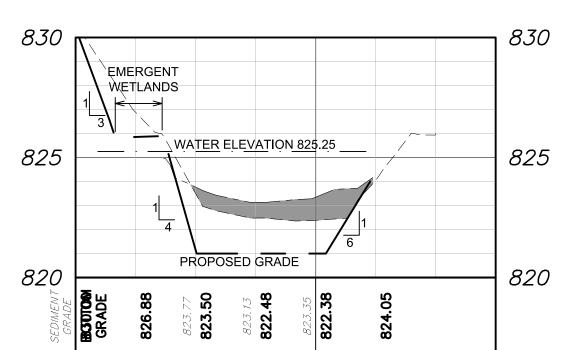

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DATE ADDITIONS AND/OR REVISIONS

CHECKED J.BALINT, A.GROAT APPROVED J.BALINT, A.GROAT

> WHEELER FACILITY POND DREDGING

NORTH COMPOST PAD POND & MAINTENANCE POND

HRC JOB NO.	SCALE H: 1"=	,
20190818	V: 1"=	4
DATE April 2020	SHEET NO. 3	E

WETLANDS 825 BOTTOM OF POND BOTTOM OF POND

NORTH COMPOST PAD POND A-A

Know what's **below Call** before you dig. OR 811 (TOLL FREE)

STAGING AREA

SEED MIX A

SEED MIX B

SEED MIX C

SEED MIX D

CALL MISS DIG

72 HOURS

(3 WORKING DAYS)

BEFORE YOU DIG

1-800-482-7171

ORIGINAL PLOT SIZE: ARCH FULL BLEED D (36.00 X 24.00 INCHES)

WATER ELEVATION 827.81

PROPOSED GRADE

FOREBAY A-A

WATER ELEVATION 826.18


820


SEDIMENT GRADE


PROPOSED GRADE

BOTTOM OF POND



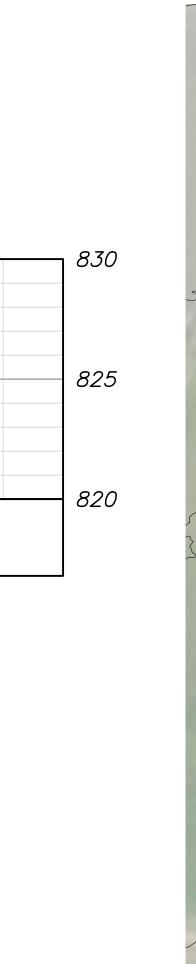

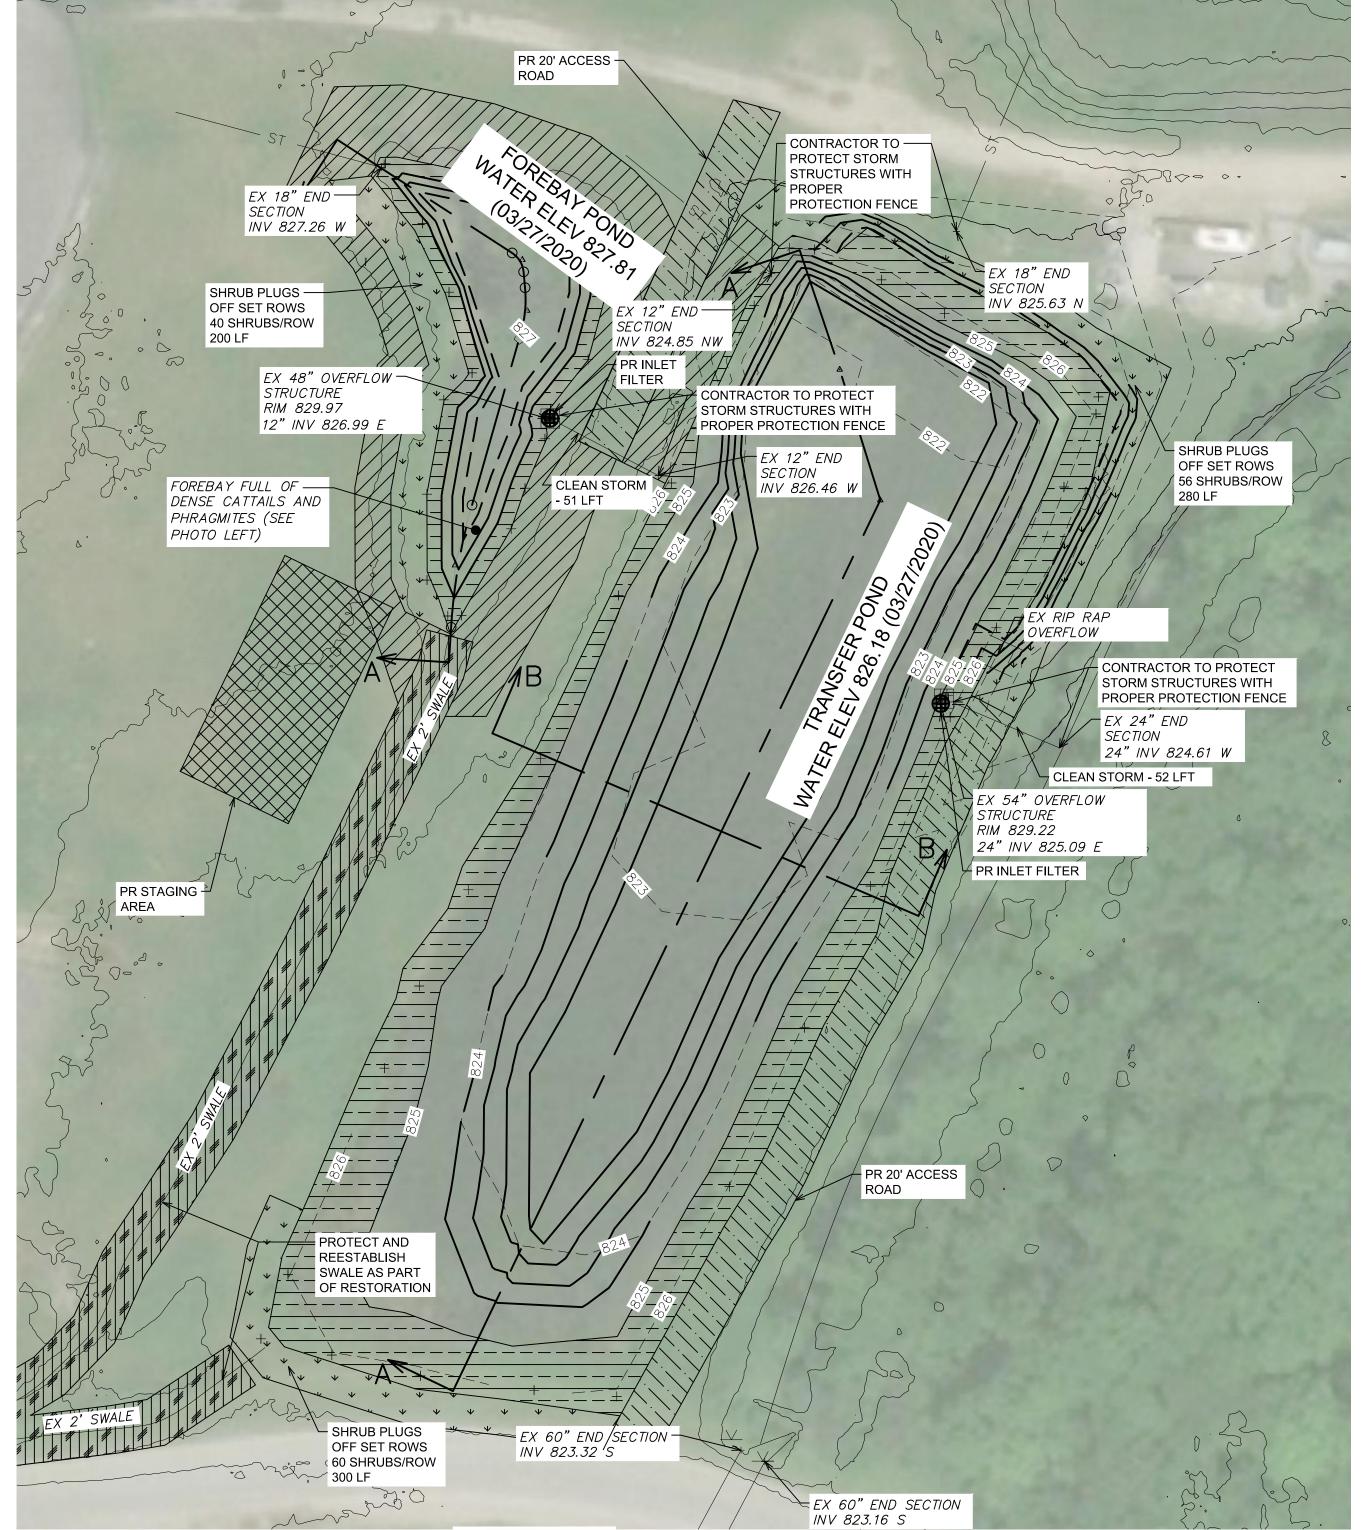

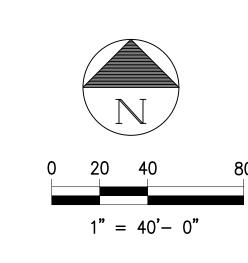

INLET FILTER EX CONTOUR PR CONTOUR STAGING AREA SEED MIX A SEED MIX B SEED MIX C SEED MIX D PLANT PLUGS

FO	REBAY			
QUANTITIES				
ltem	Unit	Quantity		
Sediment Removal and Earth Excavation	CY	500		
Silt Sack	EA	1		
Shrub Plug				
TRANSFER POND				
QUANTITIES				
Item	Unit	Quantity		
Sediment Removal and Earth Excavation	CY	2300		
Silt Sack	EA	1		
Shrub Plug				


FOREBAY POND AREA: 8,720 SF EX POND VOLUME: PR POND VOLUME: 25 CY 525 CY

TRANSFER POND POND AREA: 47,550 SF AVG SEDIMENT DEPTH: 0.36 FT EX POND VOLUME: PR POND VOLUME: 1,400 CY 3,700 CY

- ALL EX CONTOURS SHOWN ARE BOTTOM OF POND ELEVATIONS EXISTING AERATORS WILL BE

REMOVED FROM PONDS BY
FACILITY STAFF

- REMOVE PHARMGMITES AS PART OF DREDGING OPERATION

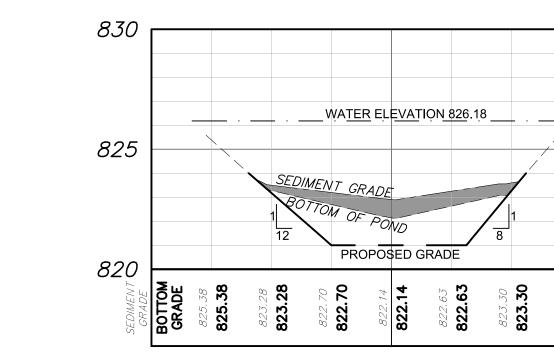

TRANSFER POND A-A


SEDIMENT GRADE

BOTTOM OF POND

PROPOSED GRADE

WATER ELEVATION 826.18

830

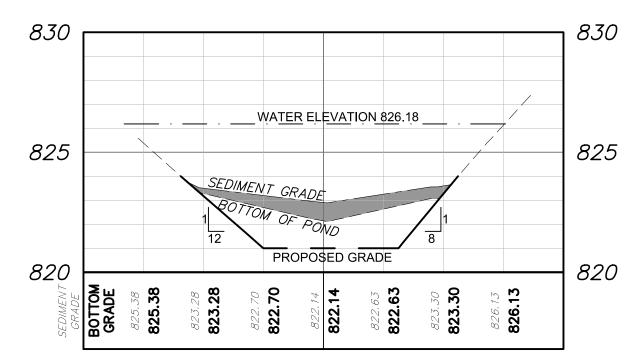

TRANSFER POND B-B

FOREBAY AND TRANSFER POND

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E ELLSWORTH RD

E MORGAN RD

WHEELER FACILITY

POND DREDGING


06/18/20 ISSUED FOR OWNER REVIET DATE ADDITIONS AND/OR REVISIONS

SCALE H: 1"=40' HRC JOB NO. 20190818 SHEET NO. 4 EGLE-V April 2020

ORIGINAL PLOT SIZE: ARCH FULL BLEED D (36.00 X 24.00 INCHES)

OR 811

(TOLL FREE)

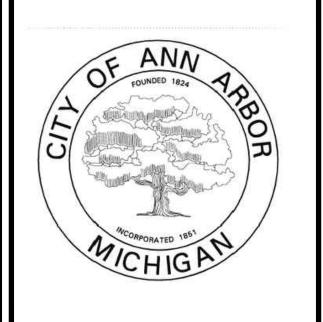

HUBBELL, ROTH & CLARK, INC CONSULTING ENGINEERS SINCE 1915 555 HULET DRIVE P.O. BOX 824 BLOOMFIELD HILLS, MICH.

PHONE: (248) 454-6300 FAX (1st. Floor): (248) 454-6312 FAX (2nd. Floor): (248) 454-6359

WEB SITE: http://www.hrcengr.com

09/18/20 ISSUED FOR CITY PERMITS 06/18/20 ISSUED FOR OWNER REVIE DATE ADDITIONS AND/OR REVISIONS CHECKED J.BALINT, A.GROAT APPROVED J.BALINT, A.GROAT E ELLSWORTH RD

> WHEELER FACILITY POND DREDGING

E MORGAN RD

LANDFILL POND

HRC JOB NO. 20190818 April 2020