Landscape Requirements Summary

Vehicular Use Areas above 3,300 SF shall receive 1 SF of Landscape Area per 20 SF of Vehicular Use Area and

1 Shade Tree per 250 SF of required Landscape Area

26,252 SF Total (see Sheets 33-37) Required: No Vehicular Use Area exceeds 3,300 SF

Conflicting Land Use Buffers

Min. 15' Buffer between Vehicular Use Area or

Refuse/Recycling Container and Public Park or Land Zoned for

1 Tree per 15 LF of required Buffer 18.5 LF (See Sheet 34 for Buffer location)

Length off Buffers: Required:

1 Tree Proposed:

Street Trees

Required: 1 Deciduous Tree per 30 LF of street frontage Street Frontage Total:

Required: 457 Trees 457 Trees Proposed:

Refuse / Recycling Container Screening

Container shall be screened by min. 6' ht. wall or fence 6' ht. Screen Wall Proposed:

Public R.O.W. Street Trees

1 Tree per 45 LF of public R.O.W. Pontiac Trail R.O.W.: 308 LF

Pontiac Trail Required: 7 Trees Pontiac Trail Proposed: 7 Trees Dhu Varren R.O.W.: 330 LF

Dhu Varren Required: 8 Trees Dhu Varren Proposed: 8 Trees (6 Proposed & 2 Existing)

Woodland Replacement Summary

1,289

Landmark Trees Total Trees Surveyed: 114 Total Trees Removed:

2,477.00" Total DBH Removed: 1,238.50" Replacement Required:

Total Trees Surveyed: Total Trees Removed:


Woodland Trees

6,749.00" Total DBH Removed: Replacement Required: 3,375.00"

Total Replacement Required Total DBH Required: Total Replacement Provided: 3,993.00"

*Note: It is intended that the remaining 620.50" of required replacement shall be paid into the Ann Arbor Tree Fund at the rate of \$200.00 per replacement inch not planted on site. This total amounts to \$124,100.00.

Vehicular Use Areas (VUA) Legend

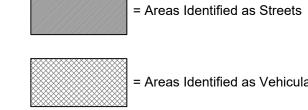

= Areas Identified as Vehicular Use Areas

- Areas identified as VUAs meet the definition of Vehicular Use Area as written in the Ann

Arbor Code of Ordinances Article VIII: Definitions (see below). - Areas identified as Streets shall not be considered a part of a VUA per the below definition. - Areas not designated either as VUA or Street are considered paved areas to facilitate the movement of vehicles between VUAs and Streets, and are not counted as VUAs per the

Vehicular Use Area Definition per Ann Arbor Unified Development Code

Vehicular Use Area

Any area of 1,200 square feet or more of a property that is not located within an enclosed Structure and that is devoted to a use by or for motor vehicles, including parking (accessory or non-accessory) or storage of Automobiles, trucks or other vehicles, loading areas, service areas and drives. The area within a carport is considered part of the Vehicular Use Area. Any paved area designed to be used solely for access between the street and the Vehicular Use Area shall not be considered part of the Vehicular Use Area.

General Landscape Notes

- Utility box locations are unknown at this time. Once the box locations are known they will be screened on 3 sides. See detail on Sheet 33.
- Disturbed areas shall be sodded or seeded.
- Landscape areas shall be irrigated.
- Snow shall be stored along streets. Storage shall not include detention areas or
- Trees shall be planted a min. 5'-8' from utility leads. Trees shall be planted such that a 1:1 trench could be dug to access utility leads.
- Trees shall be planted a min. 10' from Water Main & Sanitary Sewer
 All deciduous trees shall be planted a min. 15' o.c. Evergreen trees shall be planted a
- min. 12' o.c.
- Trees shall be planted a min. 15' from fire hydrantsSnow Storage Areas shall be a min. 15' from fire hydrants



■ revisions: 10.11.2021 Per Municipal Review 01.20.2022 Per Municipal Review 03.31.2022 Per Municipal Review 06.15.2022 Per Municipal Review 08.22.2022 Per PC Comments



design studio

landscape architecture / land planning

750 Forest Ave. - Suite 101

= Existing Tree To Remain

Deciduous Tree

= Proposed Conflicting Land Use Buffer

= Proposed Public R.O.W. Tree

= Proposed Woodland Replacement Evergreen Tree

Overall Landscape

Village of Ann Arbor

City of Ann Arbor, Michigan

Robertson Brothers Co.

Bloomfield Hills, MI 48301

DTN Management Company

■ date:

WTK

06.01.2021

checked by:

Phone: 248.657.4968

2502 Lake Lansing Rd.

Phone: 517.371.5300

Lansing, MI 48912

■ job number:

18004

■ drawn by

6905 Telegraph Rd. - Suite 200

Plan

project title:

prepared for:


= Proposed Private Street & Shared


= Proposed Woodland Replacement

Birmingham, MI 48009

T:: 248.594.3220

LEGEND

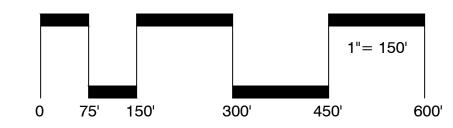

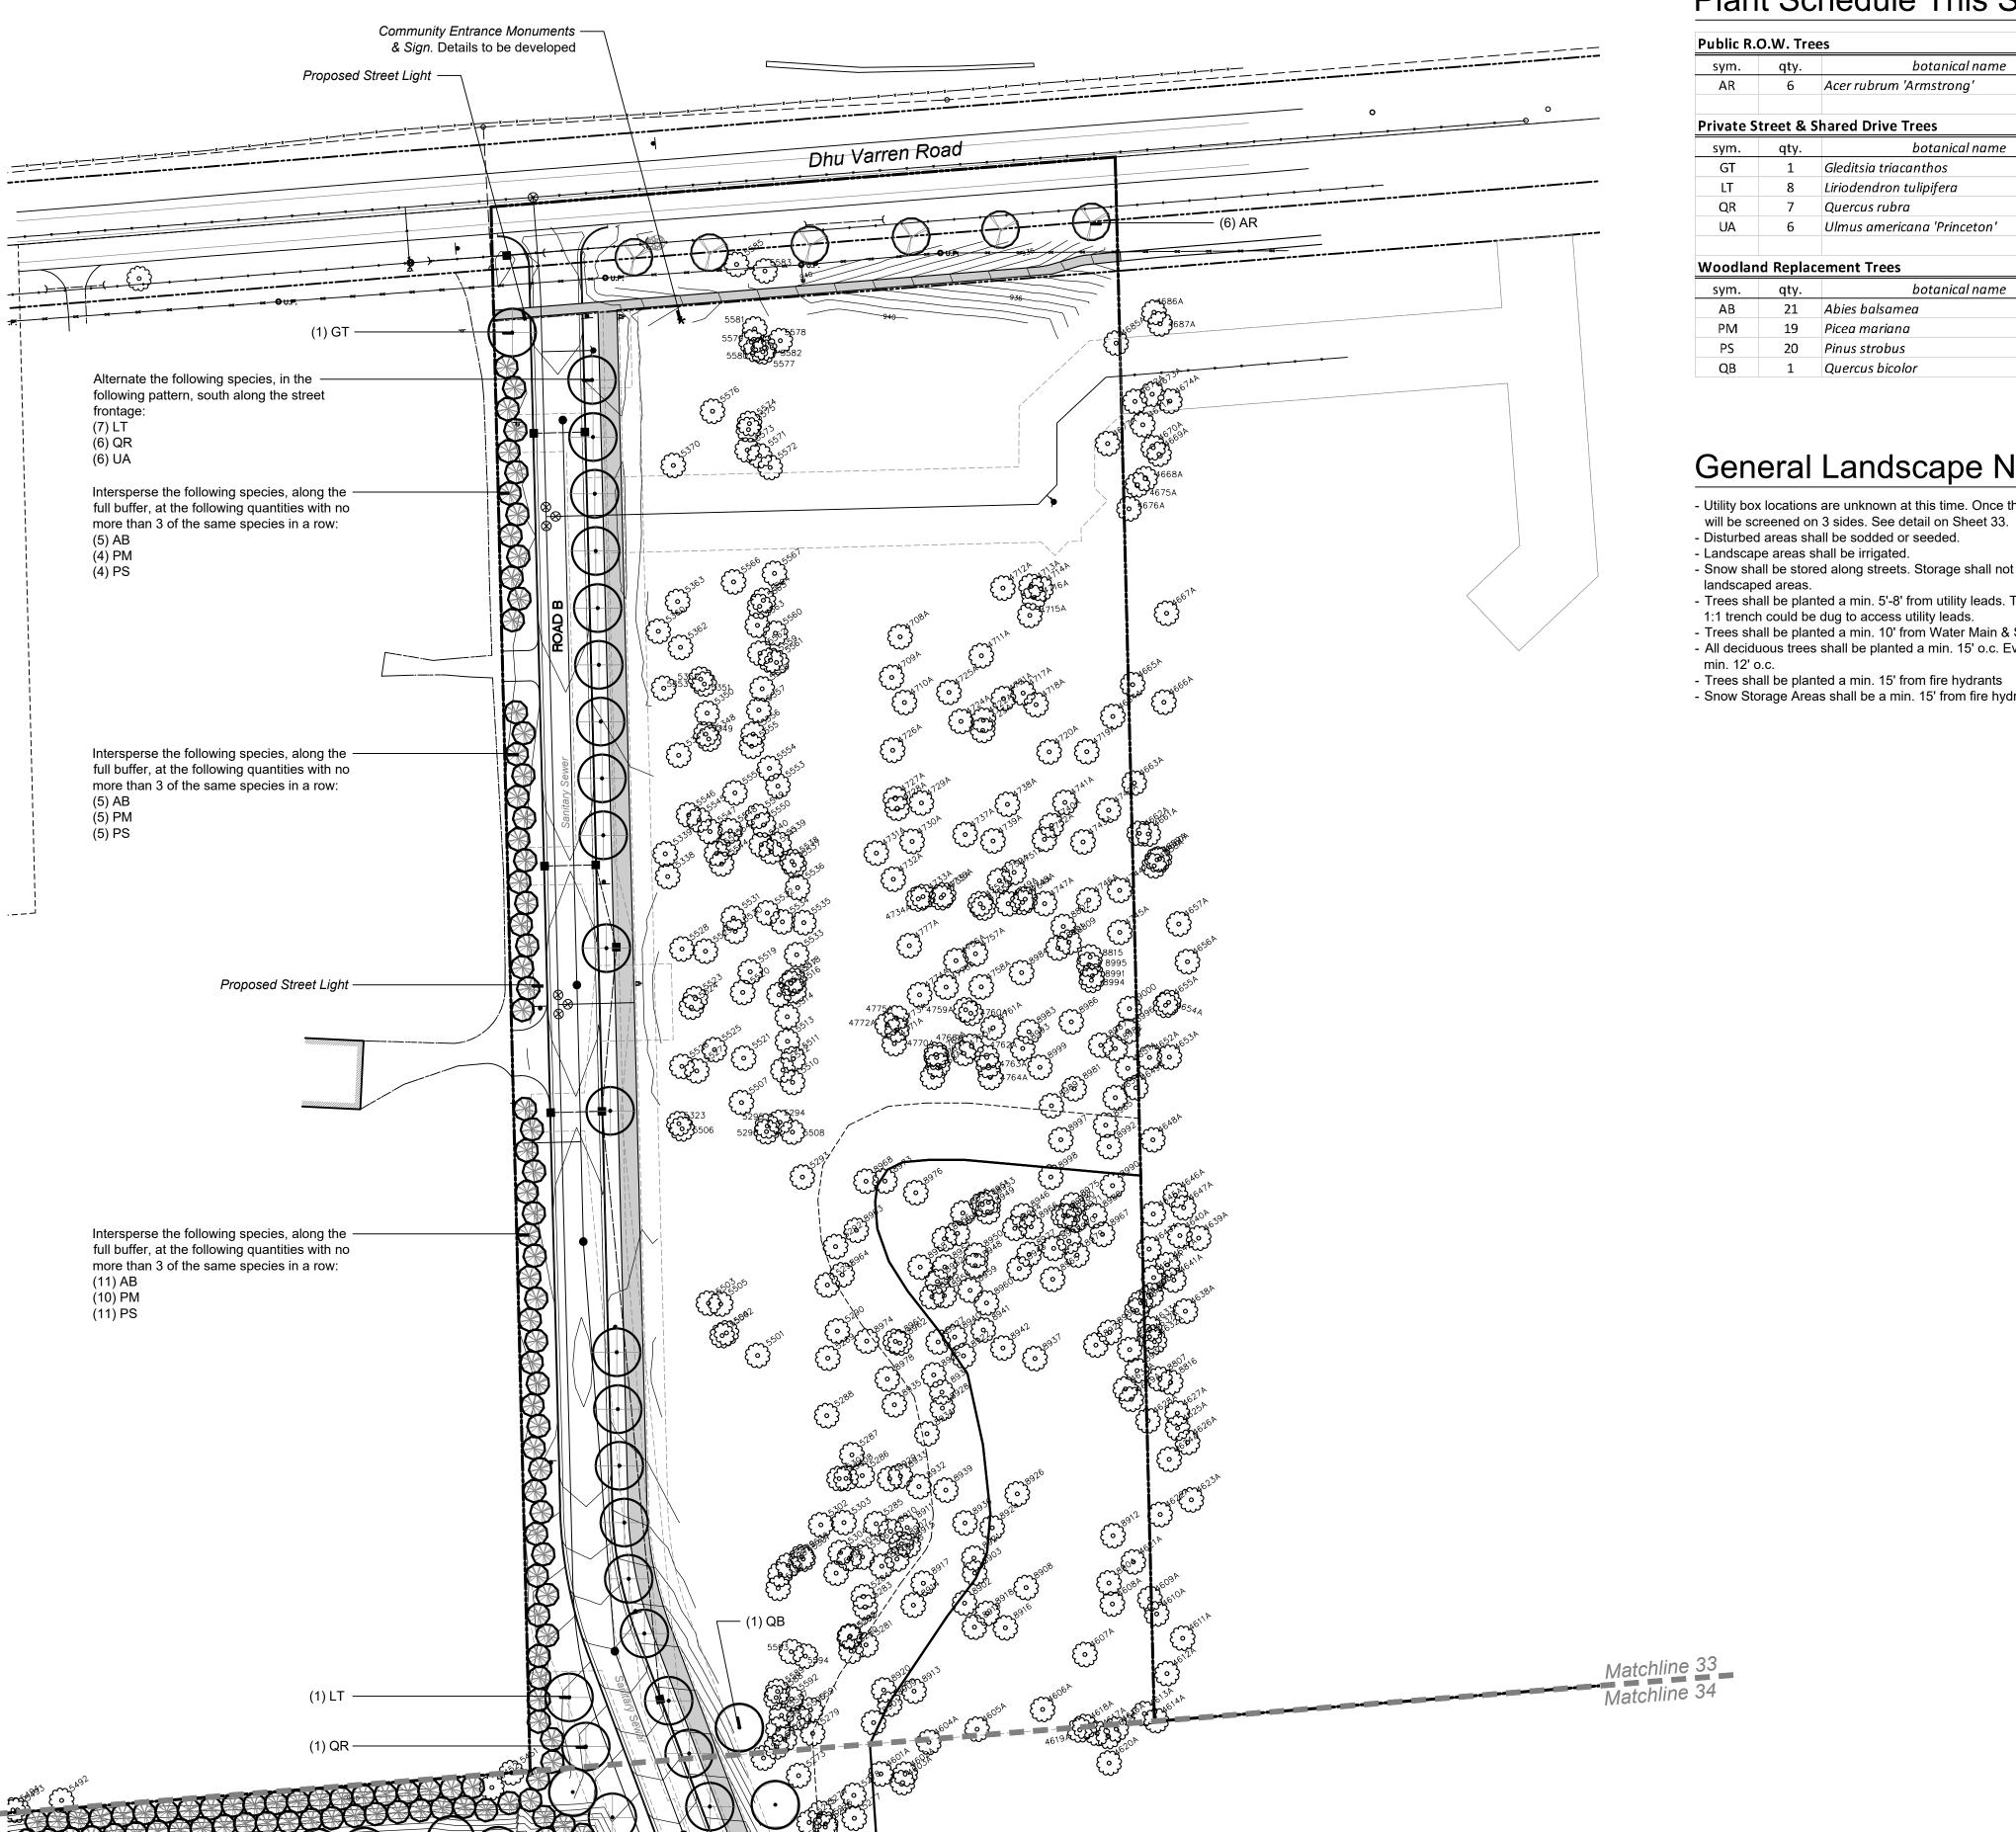

Plant Schedule This Sheet

| sym. | qty. | botanical name | common name | size | spacing | root |
|-----------|----------|-----------------------------|------------------------|-----------|-----------|------|
| AR | 6 | Acer rubrum 'Armstrong' | Armstrong Red Maple | 2.5" cal. | per plans | B&B |
| Private S | treet & | Shared Drive Trees | | | | |
| sym. | qty. | botanical name | common name | size | spacing | root |
| GT | 1 | Gleditsia triacanthos | Honeylocust | 2.5" cal. | per plans | B&B |
| LT | 8 | Liriodendron tulipifera | Tulip Tree | 2.5" cal. | per plans | B&B |
| QR | 7 | Quercus rubra | Red Oak | 2.5" cal. | per plans | B&B |
| UA | 6 | Ulmus americana 'Princeton' | Princeton American Elm | 2.5" cal. | per plans | B&B |
| Woodlan | ıd Repla | cement Trees | | | | |
| sym. | qty. | botanical name | common name | size | spacing | root |
| АВ | 21 | Abies balsamea | Balsam Fir | 8' ht. | per plans | B&B |
| PM | 19 | Picea mariana | Black Spruce | 8' ht. | per plans | B&B |
| PS | 20 | Pinus strobus | White Pine | 8' ht. | per plans | B&B |
| QB | 1 | Quercus bicolor | Swamp White Oak | 3" cal. | per plans | B&B |

General Landscape Notes

- Utility box locations are unknown at this time. Once the box locations are known they
- Disturbed areas shall be sodded or seeded.
- Landscape areas shall be irrigated.Snow shall be stored along streets. Storage shall not include detention areas or

- Trees shall be planted a min. 5'-8' from utility leads. Trees shall be planted such that a 1:1 trench could be dug to access utility leads.
 Trees shall be planted a min. 10' from Water Main & Sanitary Sewer
 All deciduous trees shall be planted a min. 15' o.c. Evergreen trees shall be planted a
- Trees shall be planted a min. 15' from fire hydrants
 Snow Storage Areas shall be a min. 15' from fire hydrants

design studio

landscape architecture / land planning

750 Forest Ave. - Suite 101 Birmingham, MI 48009 T:: 248.594.3220

LEGEND

= Existing Tree To Remain

= Proposed Conflicting Land Use Buffer

= Proposed Private Street & Shared

= Proposed Public R.O.W. Tree

= Proposed Woodland Replacement Deciduous Tree

= Proposed Woodland Replacement Evergreen Tree



sheet title:

Landscape Plan -Area 1

project title:

Village of Ann Arbor

City of Ann Arbor, Michigan

prepared for:

Robertson Brothers Co. 6905 Telegraph Rd. - Suite 200 Bloomfield Hills, MI 48301

Phone: 248.657.4968


DTN Management Company 2502 Lake Lansing Rd. Lansing, MI 48912

Phone: 517.371.5300


| Job number: | ■ date: |
|-------------|---------------|
| 18004 | 06.01.2021 |
| ■ drawn by: | ■ checked by: |
| EMJ | WTK |




| ■ revisions: | |
|--------------|----------------------|
| 10.11.2021 | Per Municipal Review |
| 01.20.2022 | Per Municipal Review |
| 03.31.2022 | Per Municipal Review |
| 06.15.2022 | Per Municipal Review |
| 08.22.2022 | Per PC Comments |

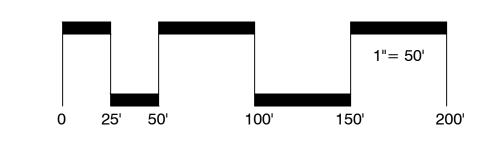



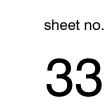

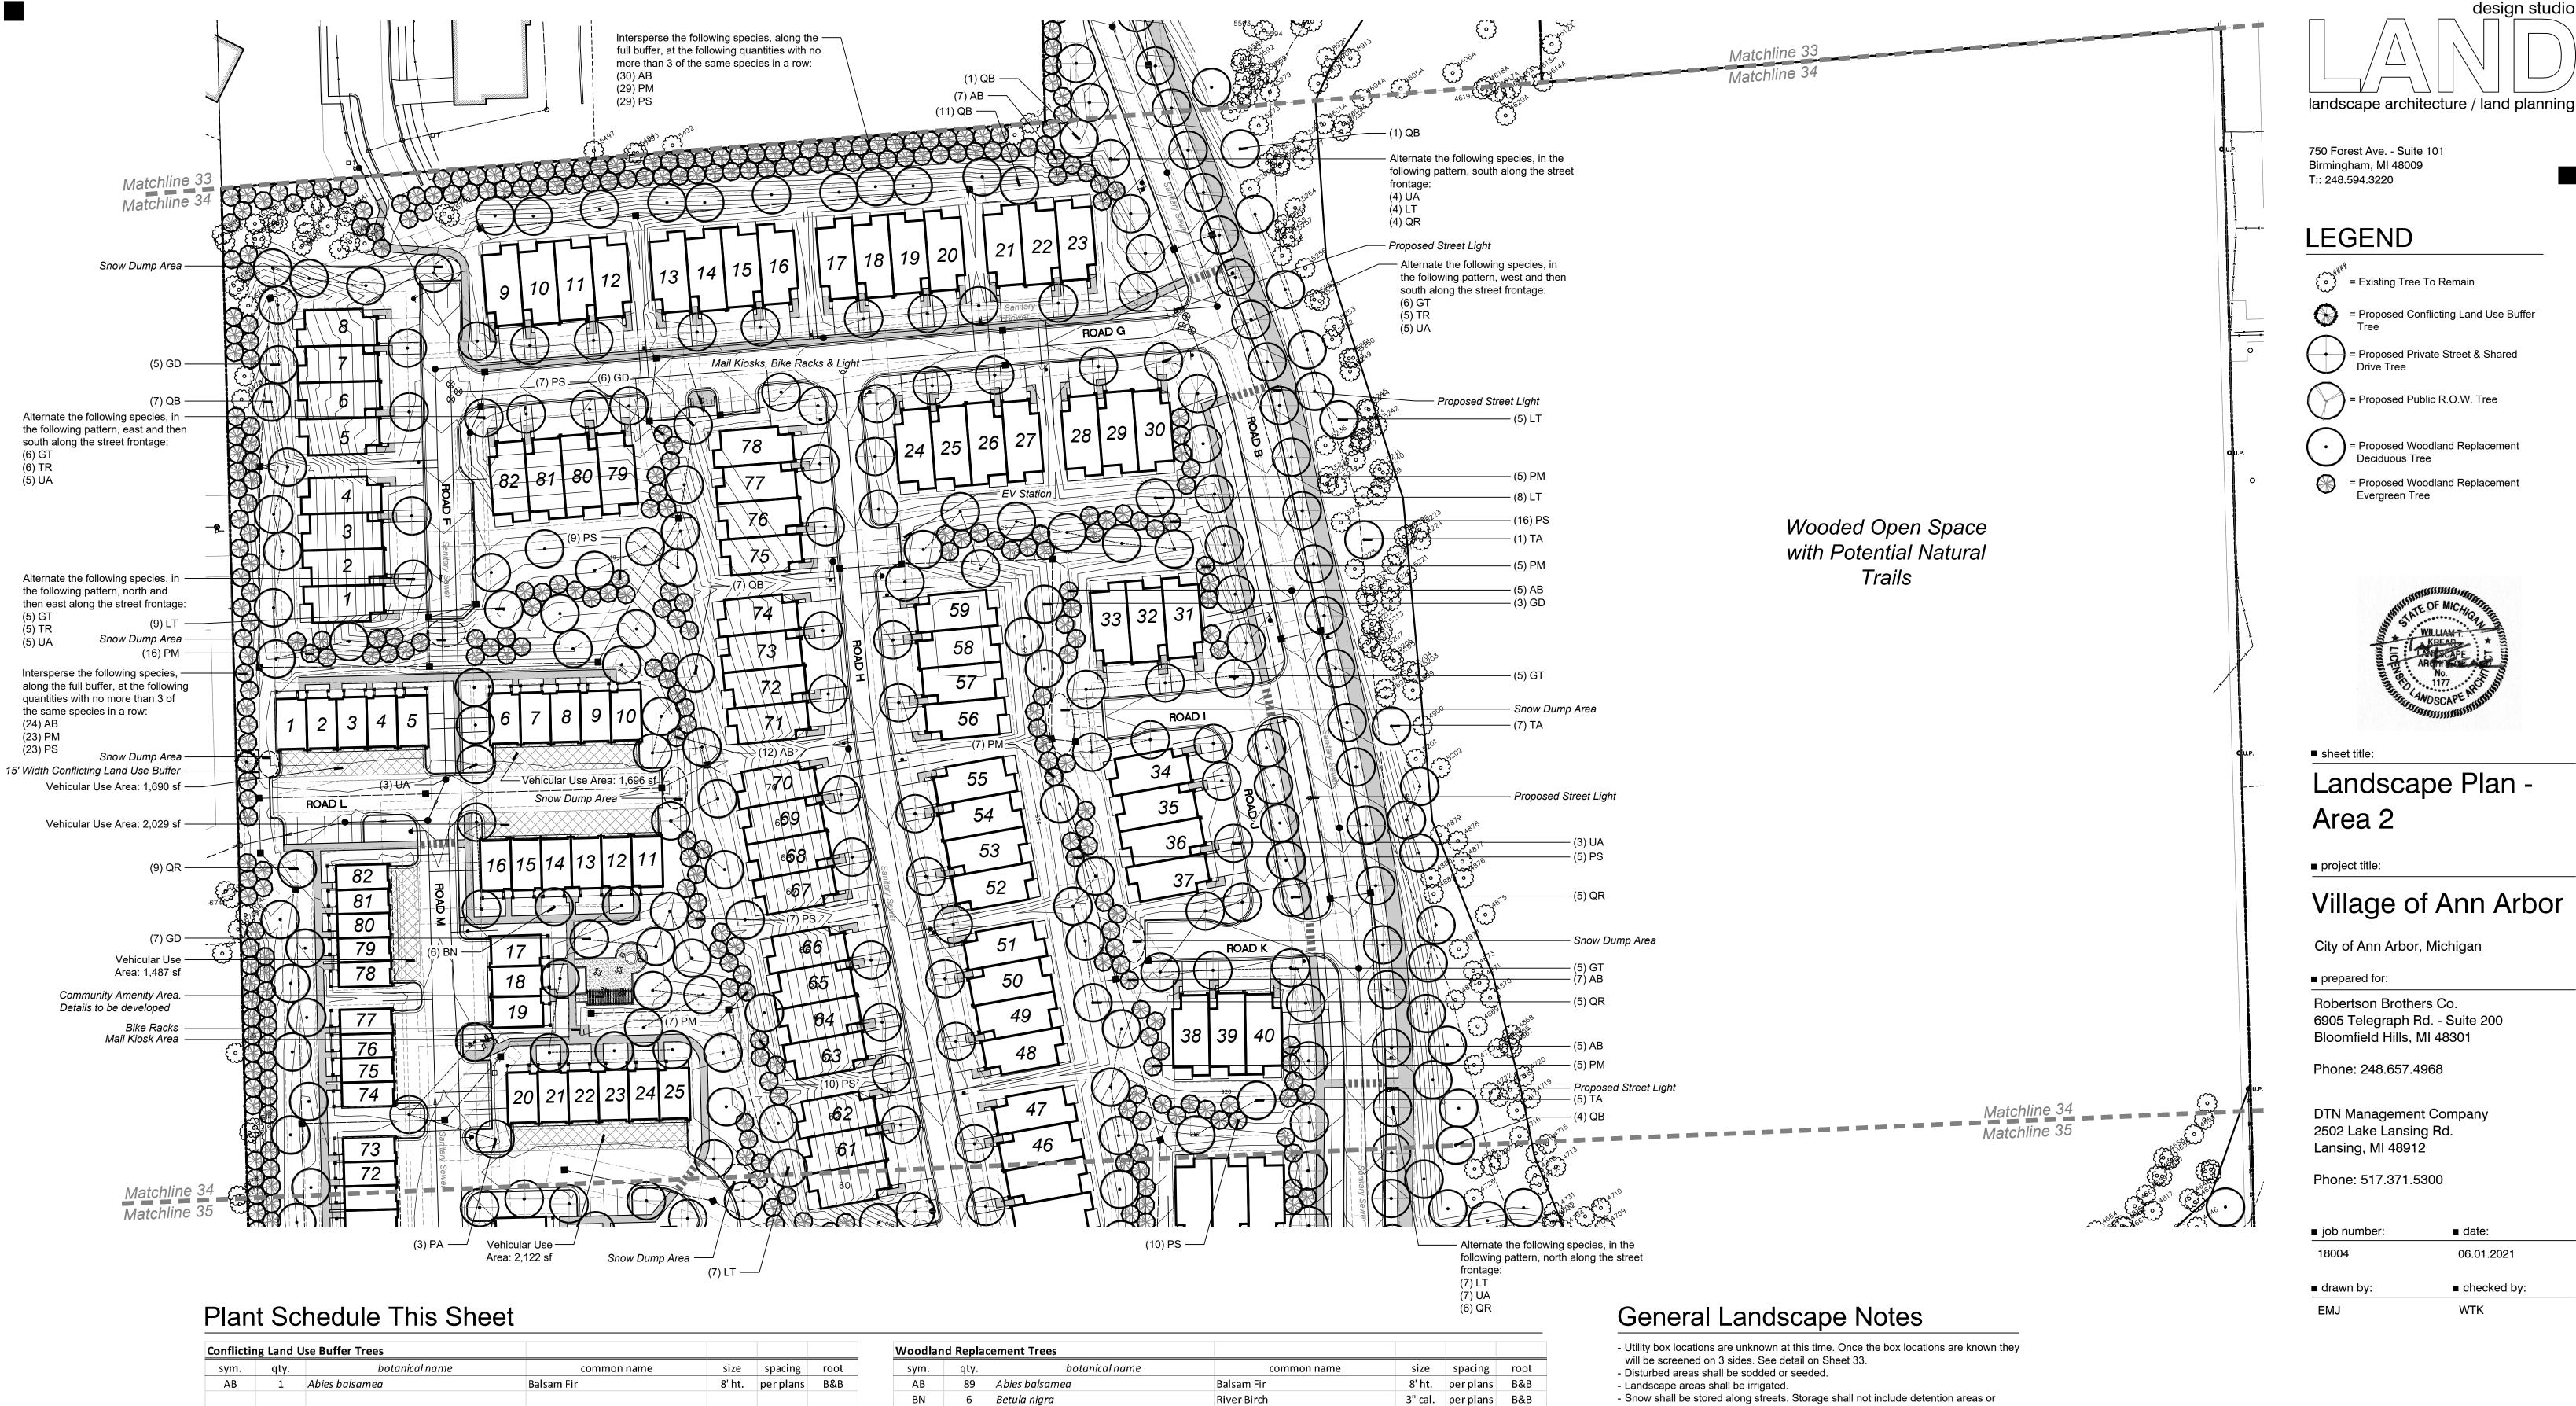

Kentucky Coffeetree

Swamp White Oak

Tulip Tree

Black Spruce

White Pine

Red Oak

Basswood

3" cal. per plans B&B

3" cal. per plans B&B

8' ht. per plans B&B

8' ht. per plans B&B

3" cal. per plans B&B

3" cal. per plans B&B

3" cal. per plans B&B

Gymnocladus diocus

28 Liriodendron tulipifera

Quercus bicolor

Quercus rubra

Picea mariana

116 Pinus strobus

13 Tilia americana

size spacing root

2.5" cal. per plans B&B

2.5" cal. perplans B&B

2.5" cal. per plans B&B

3" cal. perplans B&B

2.5" cal. per plans B&B

2.5" cal. per plans B&B 2.5" cal. per plans B&B

common name

Thornless Honeylocust

Swamp White Oak

Redmond Linden

Princeton American Elm

Exclamation London Planetree


Tulip Tree

Red Oak

- landscaped areas.
- Trees shall be planted a min. 5'-8' from utility leads. Trees shall be planted such that a 1:1 trench could be dug to access utility leads.
- Trees shall be planted a min. 10' from Water Main & Sanitary Sewer
- All deciduous trees shall be planted a min. 15' o.c. Evergreen trees shall be planted a min. 12' o.c.
- Trees shall be planted a min. 15' from fire hydrants
- Snow Storage Areas shall be a min. 15' from fire hydrants



| | ■ revisions: | | |
|------|--------------|----------------------|--|
| | 10.11.2021 | Per Municipal Review | |
| | 01.20.2022 | Per Municipal Review | |
| | 03.31.2022 | Per Municipal Review | |
| | 06.15.2022 | Per Municipal Review | |
| dig. | 08.22.2022 | Per PC Comments | |
| U | | | |

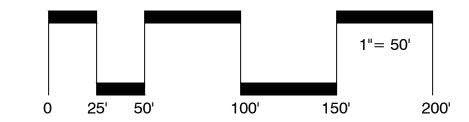



Private Street & Shared Drive Trees

Gleditsia triacanthos var. Inermis

Platanus x acerifolia 'Exclamation'


Liriodendron tulipifera

Tilia americana 'Redmond'

Ulmus americana 'Princeton'

Quercus bicolor

Quercus rubra

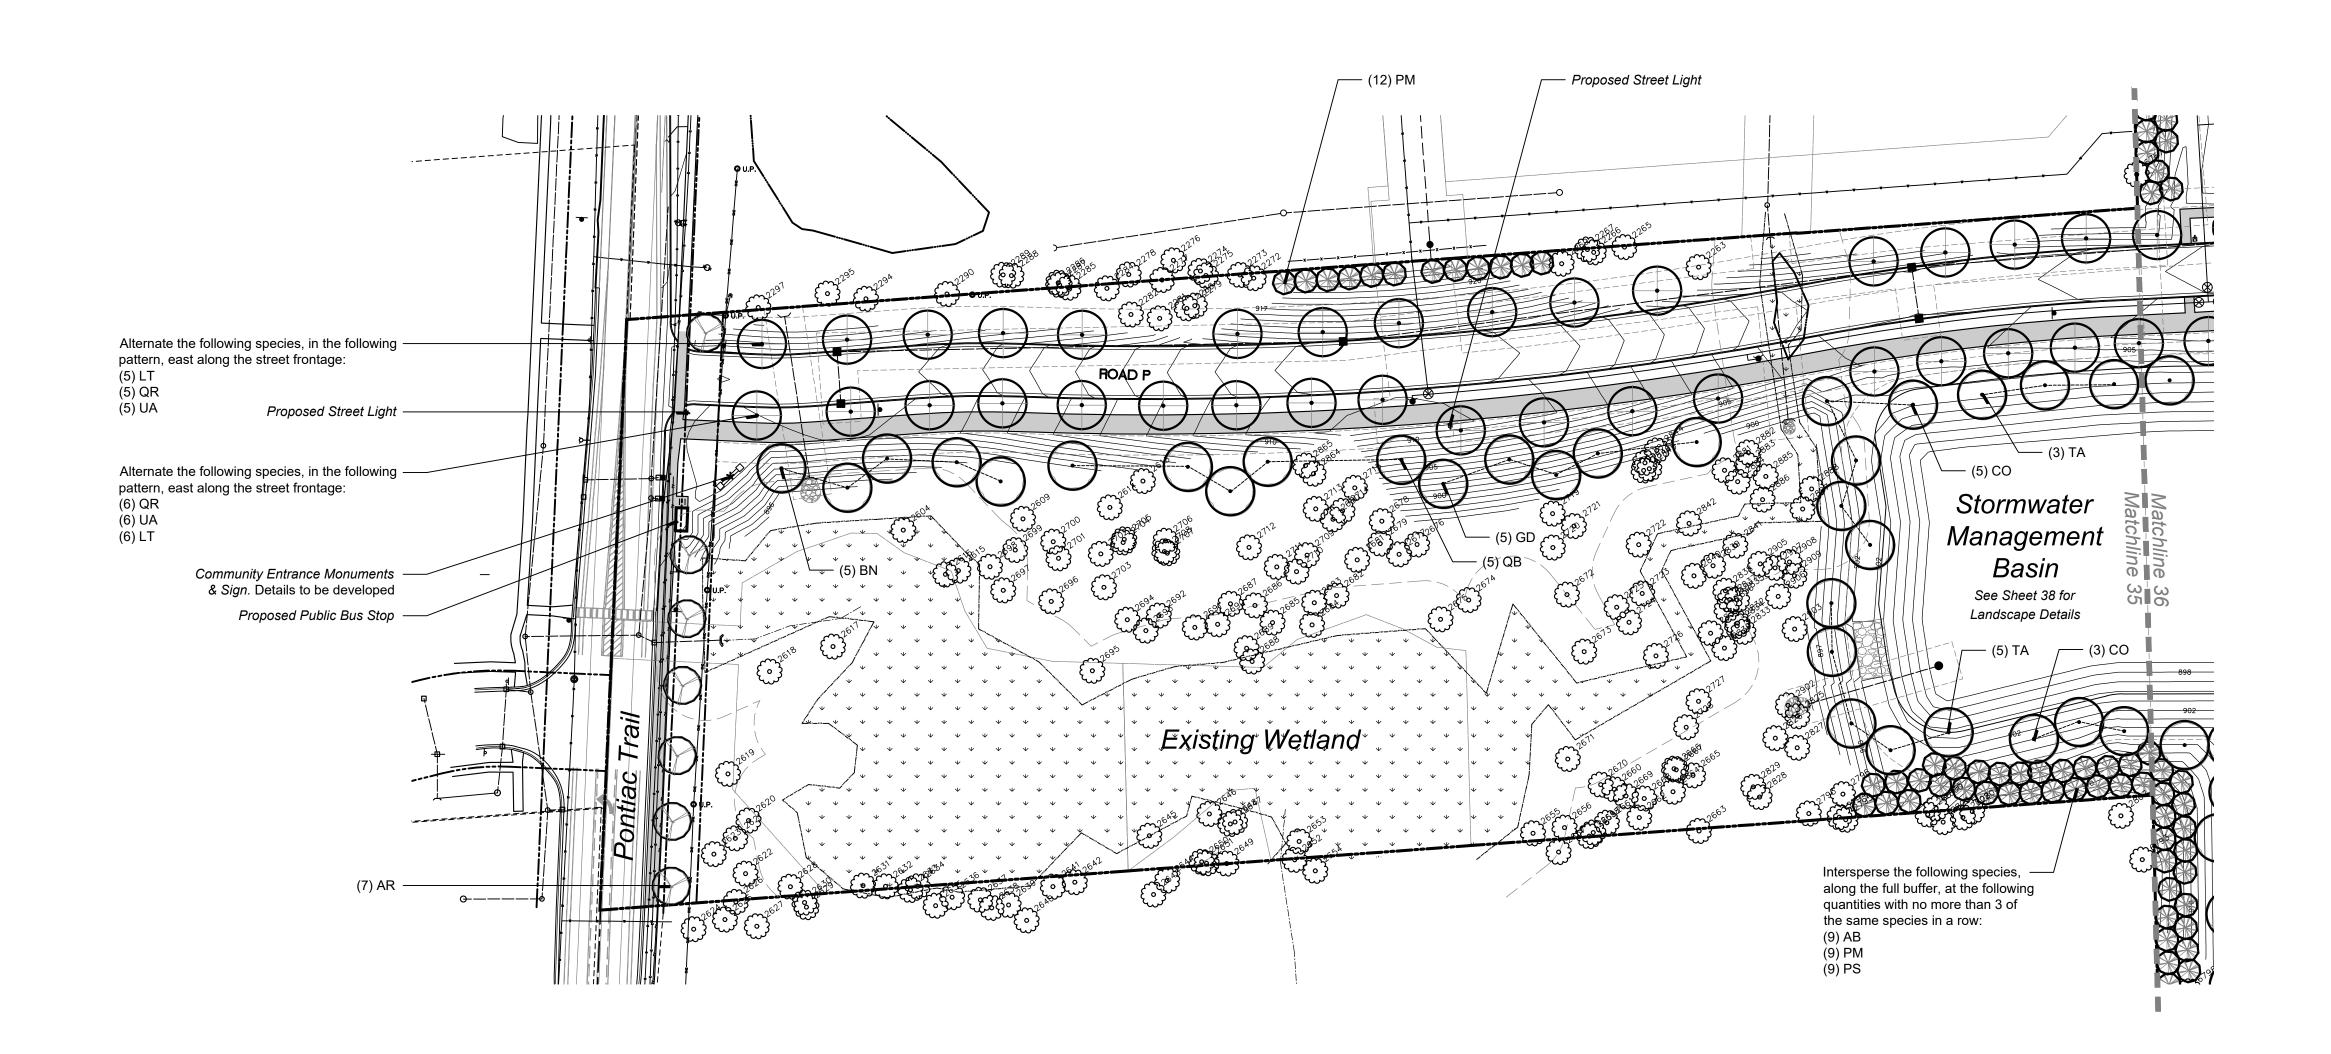

Plant Schedule This Sheet

| | HEEL & | Shared Drive Trees | | | | |
|----------------|----------|--|-------------------------------------|-------------------|------------------------|--------------------------|
| sym. | qty. | botanical name | common name | size | spacing | roo |
| LT | 11 | Liriodendron tulipifera | Tulip Tree | 2.5" cal. | per plans | B&E |
| QR | 11 | Quercus rubra | Red Oak | 2.5" cal. | per plans | B&E |
| UA | 11 | Ulmus americana 'Princeton' | Princeton American Elm | 2.5" cal. | per plans | B&E |
| Public R. | O.W. Tre | es | | | | |
| sym. | qty. | botanical name | common name | size | spacing | roo |
| AR | 7 | Acer rubrum 'Armstrong' | Armstrong Red Maple | 2.5" cal. | per plans | В&Е |
| Voodlan | d Repla | cement Trees | | | | |
| sym. | qty. | botanical name | common name | size | spacing | roo |
| AB | 9 | Abies balsamea | Balsam Fir | 8' ht. | per plans | B&I |
| | 5 | Betula nigra | River Birch | 3" cal. | per plans | В&I |
| BN | | | Hadibarm | 3" cal. | per plans | B&I |
| BN CO | 8 | Celtis occidentalis | Hackberry | J car. | | |
| | 8 5 | Celtis occidentalis Gymnocladus diocus | Kentucky Coffeetree | 3" cal. | per plans | B&I |
| СО | | | · | | | |
| CO GD | 5 | Gymnocladus diocus | Kentucky Coffeetree | 3" cal. | per plans | В& |
| CO GD PM | 5 21 | Gymnocladus diocus Picea mariana | Kentucky Coffeetree Black Spruce | 3" cal. 8' ht. | per plans per plans | B&I B&I B&I B&I |

General Landscape Notes

- Utility box locations are unknown at this time. Once the box locations are known they will be screened on 3 sides. See detail on Sheet 33.
- Disturbed areas shall be sodded or seeded.
- Landscape areas shall be irrigated.
- Snow shall be stored along streets. Storage shall not include detention areas or landscaped areas.
- Trees shall be planted a min. 5'-8' from utility leads. Trees shall be planted such that a 1:1 trench could be dug to access utility leads.
- Trees shall be planted a min. 10' from Water Main & Sanitary Sewer
 All deciduous trees shall be planted a min. 15' o.c. Evergreen trees shall be planted a
- min. 12' o.c.
- Trees shall be planted a min. 15' from fire hydrants - Snow Storage Areas shall be a min. 15' from fire hydrants



750 Forest Ave. - Suite 101 Birmingham, MI 48009 T:: 248.594.3220

LEGEND

= Existing Tree To Remain

= Proposed Conflicting Land Use Buffer

= Proposed Private Street & Shared
Drive Tree

= Proposed Public R.O.W. Tree

Proposed Woodland Replacement Deciduous Tree

= Proposed Woodland Replacement Evergreen Tree



■ sheet title:

Landscape Plan -Area 3

project title:

Village of Ann Arbor

City of Ann Arbor, Michigan

prepared for:

Robertson Brothers Co. 6905 Telegraph Rd. - Suite 200 Bloomfield Hills, MI 48301

Phone: 248.657.4968

DTN Management Company 2502 Lake Lansing Rd. Lansing, MI 48912


Phone: 517.371.5300

| ■ job number: | ■ date: |
|---------------|---------------|
| 18004 | 06.01.2021 |
| ■ drawn by: | ■ checked by: |
| EMJ | WTK |




revisions:

10.11.2021 Per Municipal Review 01.20.2022 Per Municipal Review 03.31.2022 Per Municipal Review 06.15.2022 Per Municipal Review 08.22.2022 Per PC Comments

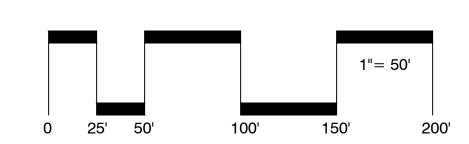





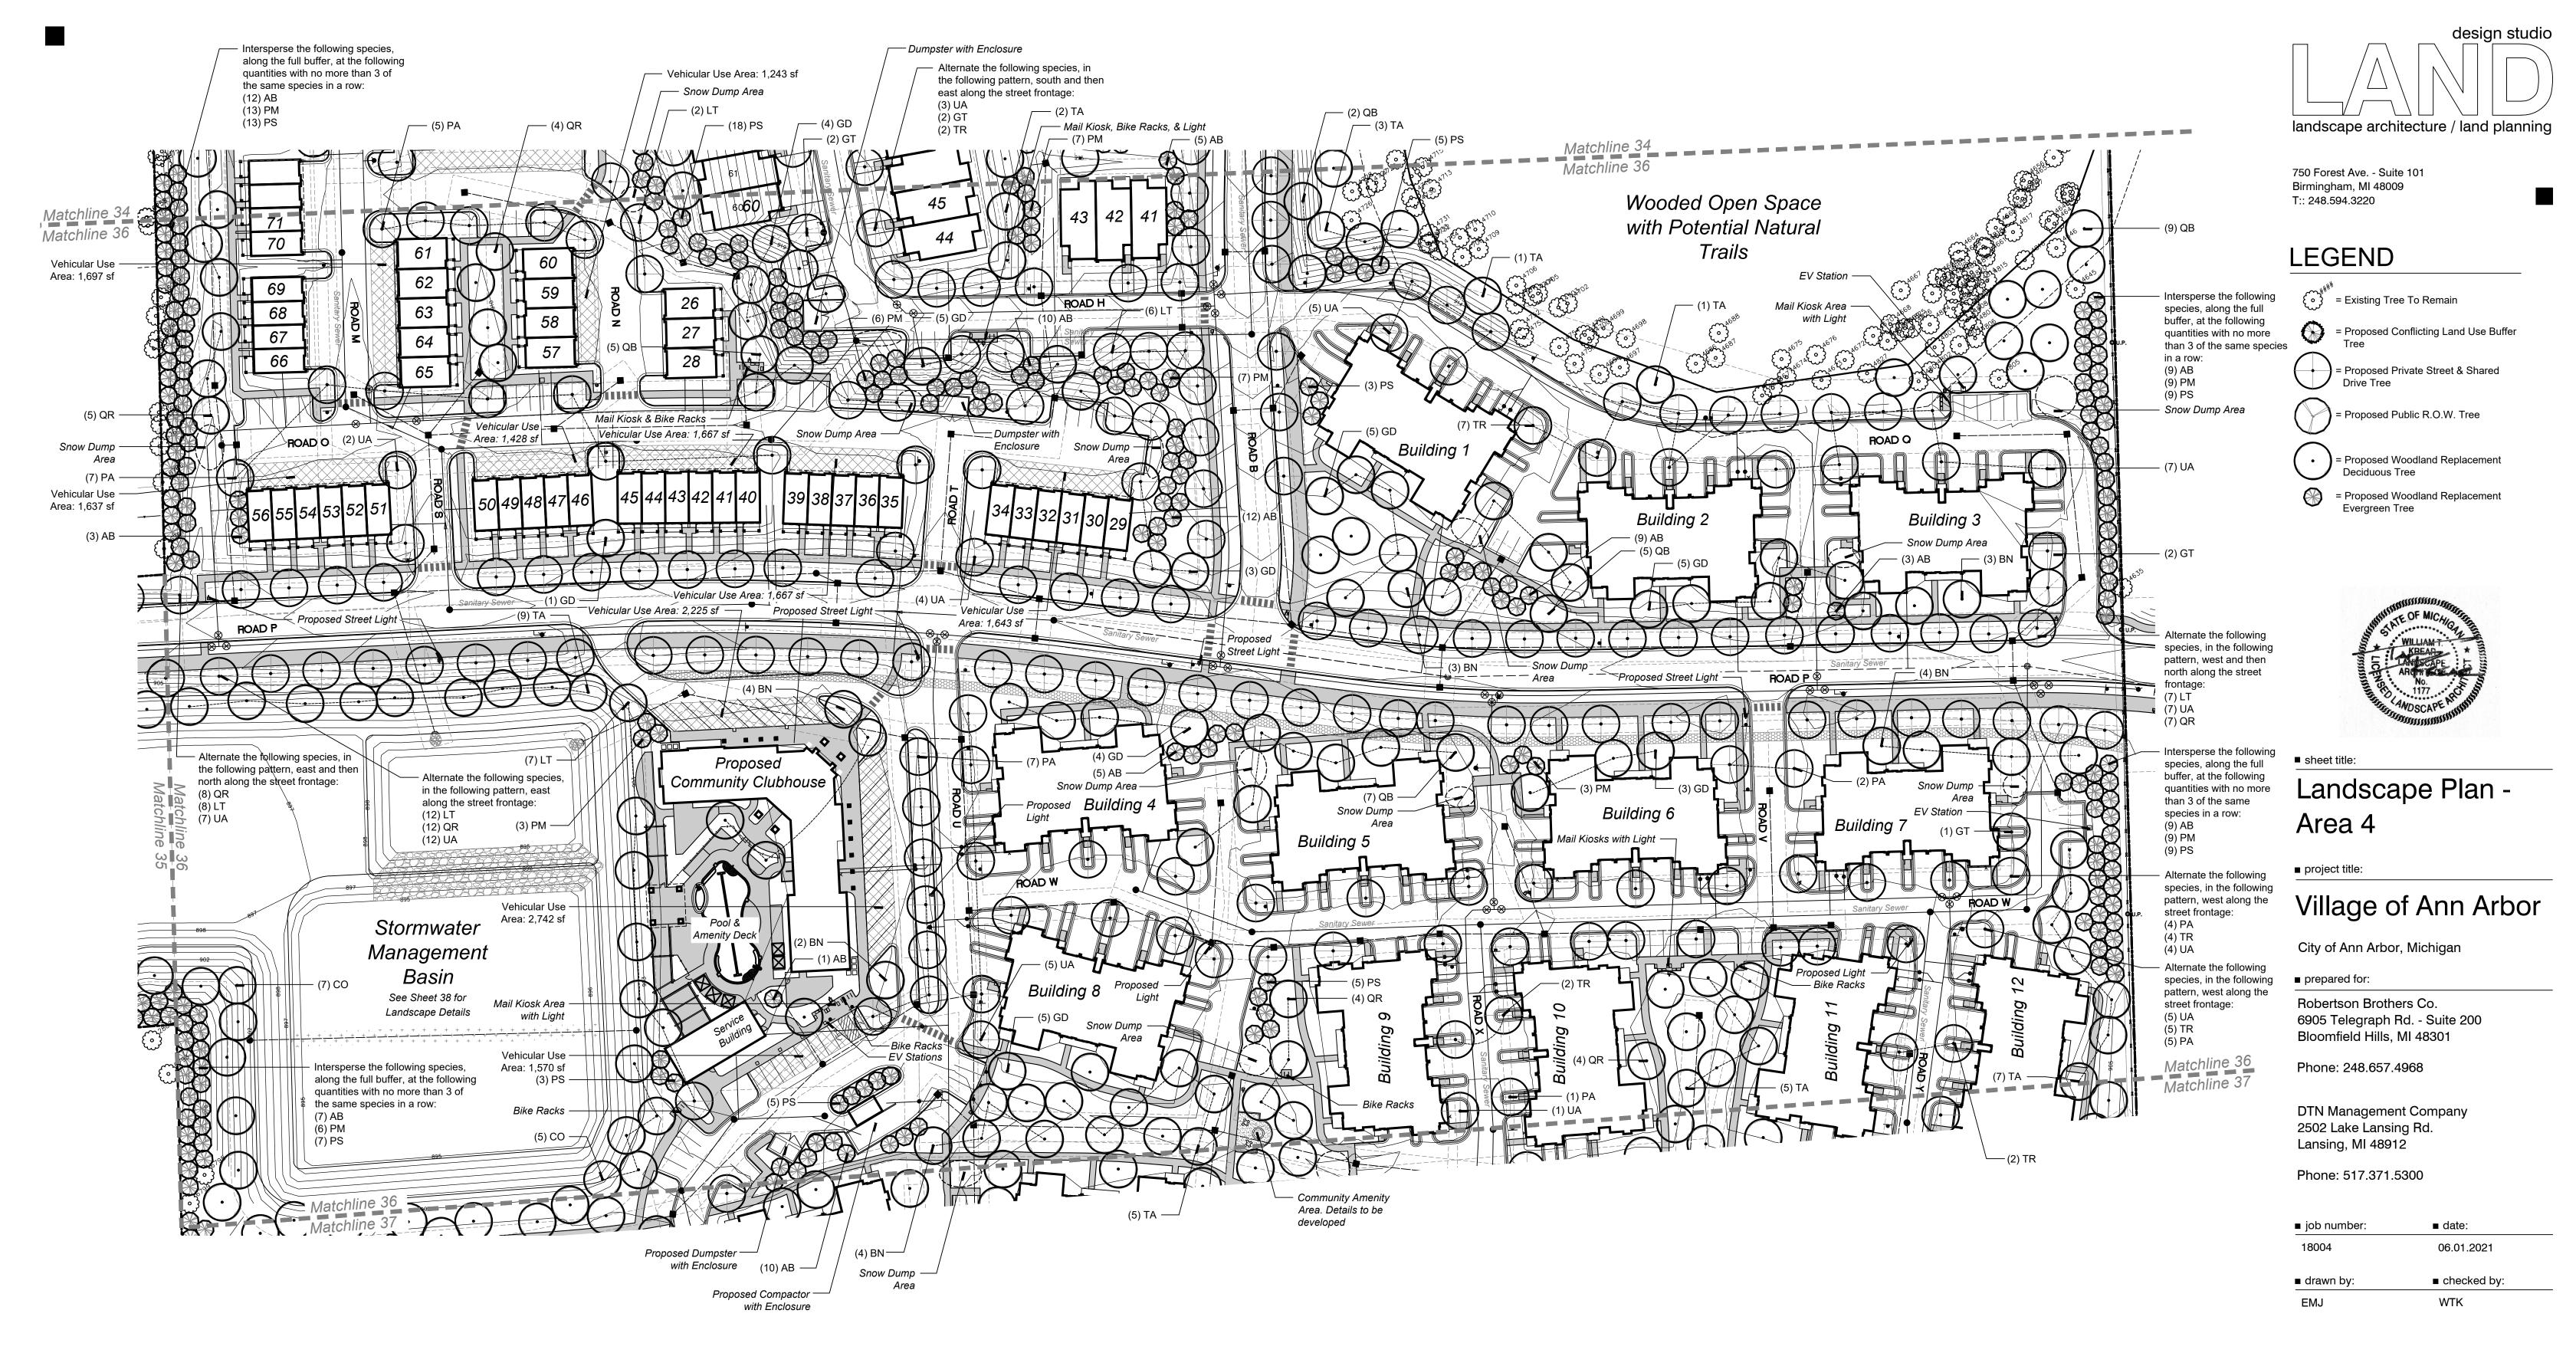

Plant Schedule This Sheet

| sym. | qty. | botanical name | common name | size | spacing | root |
|------|------|-------------------------------------|-------------------------------------|-----------|-----------|------|
| GD | 2 | Gymnocladus diocus | Kentucky Coffeetree | 3" cal. | per plans | B&I |
| GT | 7 | Gleditsia triacanthos var. Inermis | Thornless Honeylocust | 2.5" cal. | per plans | B&I |
| LT | 35 | Liriodendron tulipifera | Tulip Tree | 2.5" cal. | per plans | В& |
| PA | 31 | Platanus x acerifolia 'Exclamation' | Exclamation London Planetree | 2.5" cal. | per plans | В& |
| QB | 3 | Quercus bicolor | Swamp White Oak | 3" cal. | per plans | В& |
| QR | 27 | Quercus rubra | Red Oak | 2.5" cal. | per plans | В& |
| TR | 22 | Tilia americana 'Redmond' | Redmond Linden | 2.5" cal. | per plans | В& |
| UA | 62 | Ulmus americana 'Princeton' | Princeton American Elm | 2.5" cal. | per plans | В&1 |


| sym. | qty. | botanical name | common name | size | spacing | root |
|------|------|-------------------------|---------------------|---------|-----------|------|
| AB | 95 | Abies balsamea | Balsam Fir | 8' ht. | per plans | В&В |
| BN | 20 | Betula nigra | River Birch | 3" cal. | per plans | В&В |
| CO | 12 | Celtis occidentalis | Hackberry | 3" cal. | per plans | B&B |
| GD | 33 | Gymnocladus diocus | Kentucky Coffeetree | 3" cal. | per plans | B&B |
| LT | 7 | Liriodendron tulipifera | Tulip Tree | 3" cal. | per plans | B&B |
| PM | 63 | Picea mariana | Black Spruce | 8' ht. | per plans | B&B |
| PS | 77 | Pinus strobus | White Pine | 8' ht. | per plans | B&B |
| QB | 25 | Quercus bicolor | Swamp White Oak | 3" cal. | per plans | B&B |
| QR | 17 | Quercus rubra | Red Oak | 3" cal. | per plans | B&B |
| TA | 33 | Tilia americana | Basswood | 3" cal. | per plans | в&в |


General Landscape Notes

- Utility box locations are unknown at this time. Once the box locations are known they will be screened on 3 sides. See detail on Sheet 33.
- Disturbed areas shall be sodded or seeded.
- Landscape areas shall be irrigated.
- Snow shall be stored along streets. Storage shall not include detention areas or landscaped areas.
- Trees shall be planted a min. 5'-8' from utility leads. Trees shall be planted such that a
- 1:1 trench could be dug to access utility leads.
- Trees shall be planted a min. 10' from Water Main & Sanitary Sewer - All deciduous trees shall be planted a min. 15' o.c. Evergreen trees shall be planted a
- min. 12' o.c. - Trees shall be planted a min. 15' from fire hydrants
- Snow Storage Areas shall be a min. 15' from fire hydrants



| | ■ revisions: | |
|----|--------------|------------------|
| | 10.11.2021 | Per Municipal Re |
| | 01.20.2022 | Per Municipal Re |
| | 03.31.2022 | Per Municipal Re |
| | 06.15.2022 | Per Municipal Re |
| ١. | 08.22.2022 | Per PC Commen |

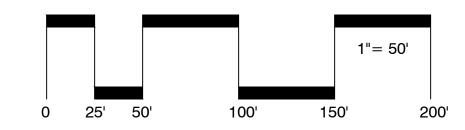

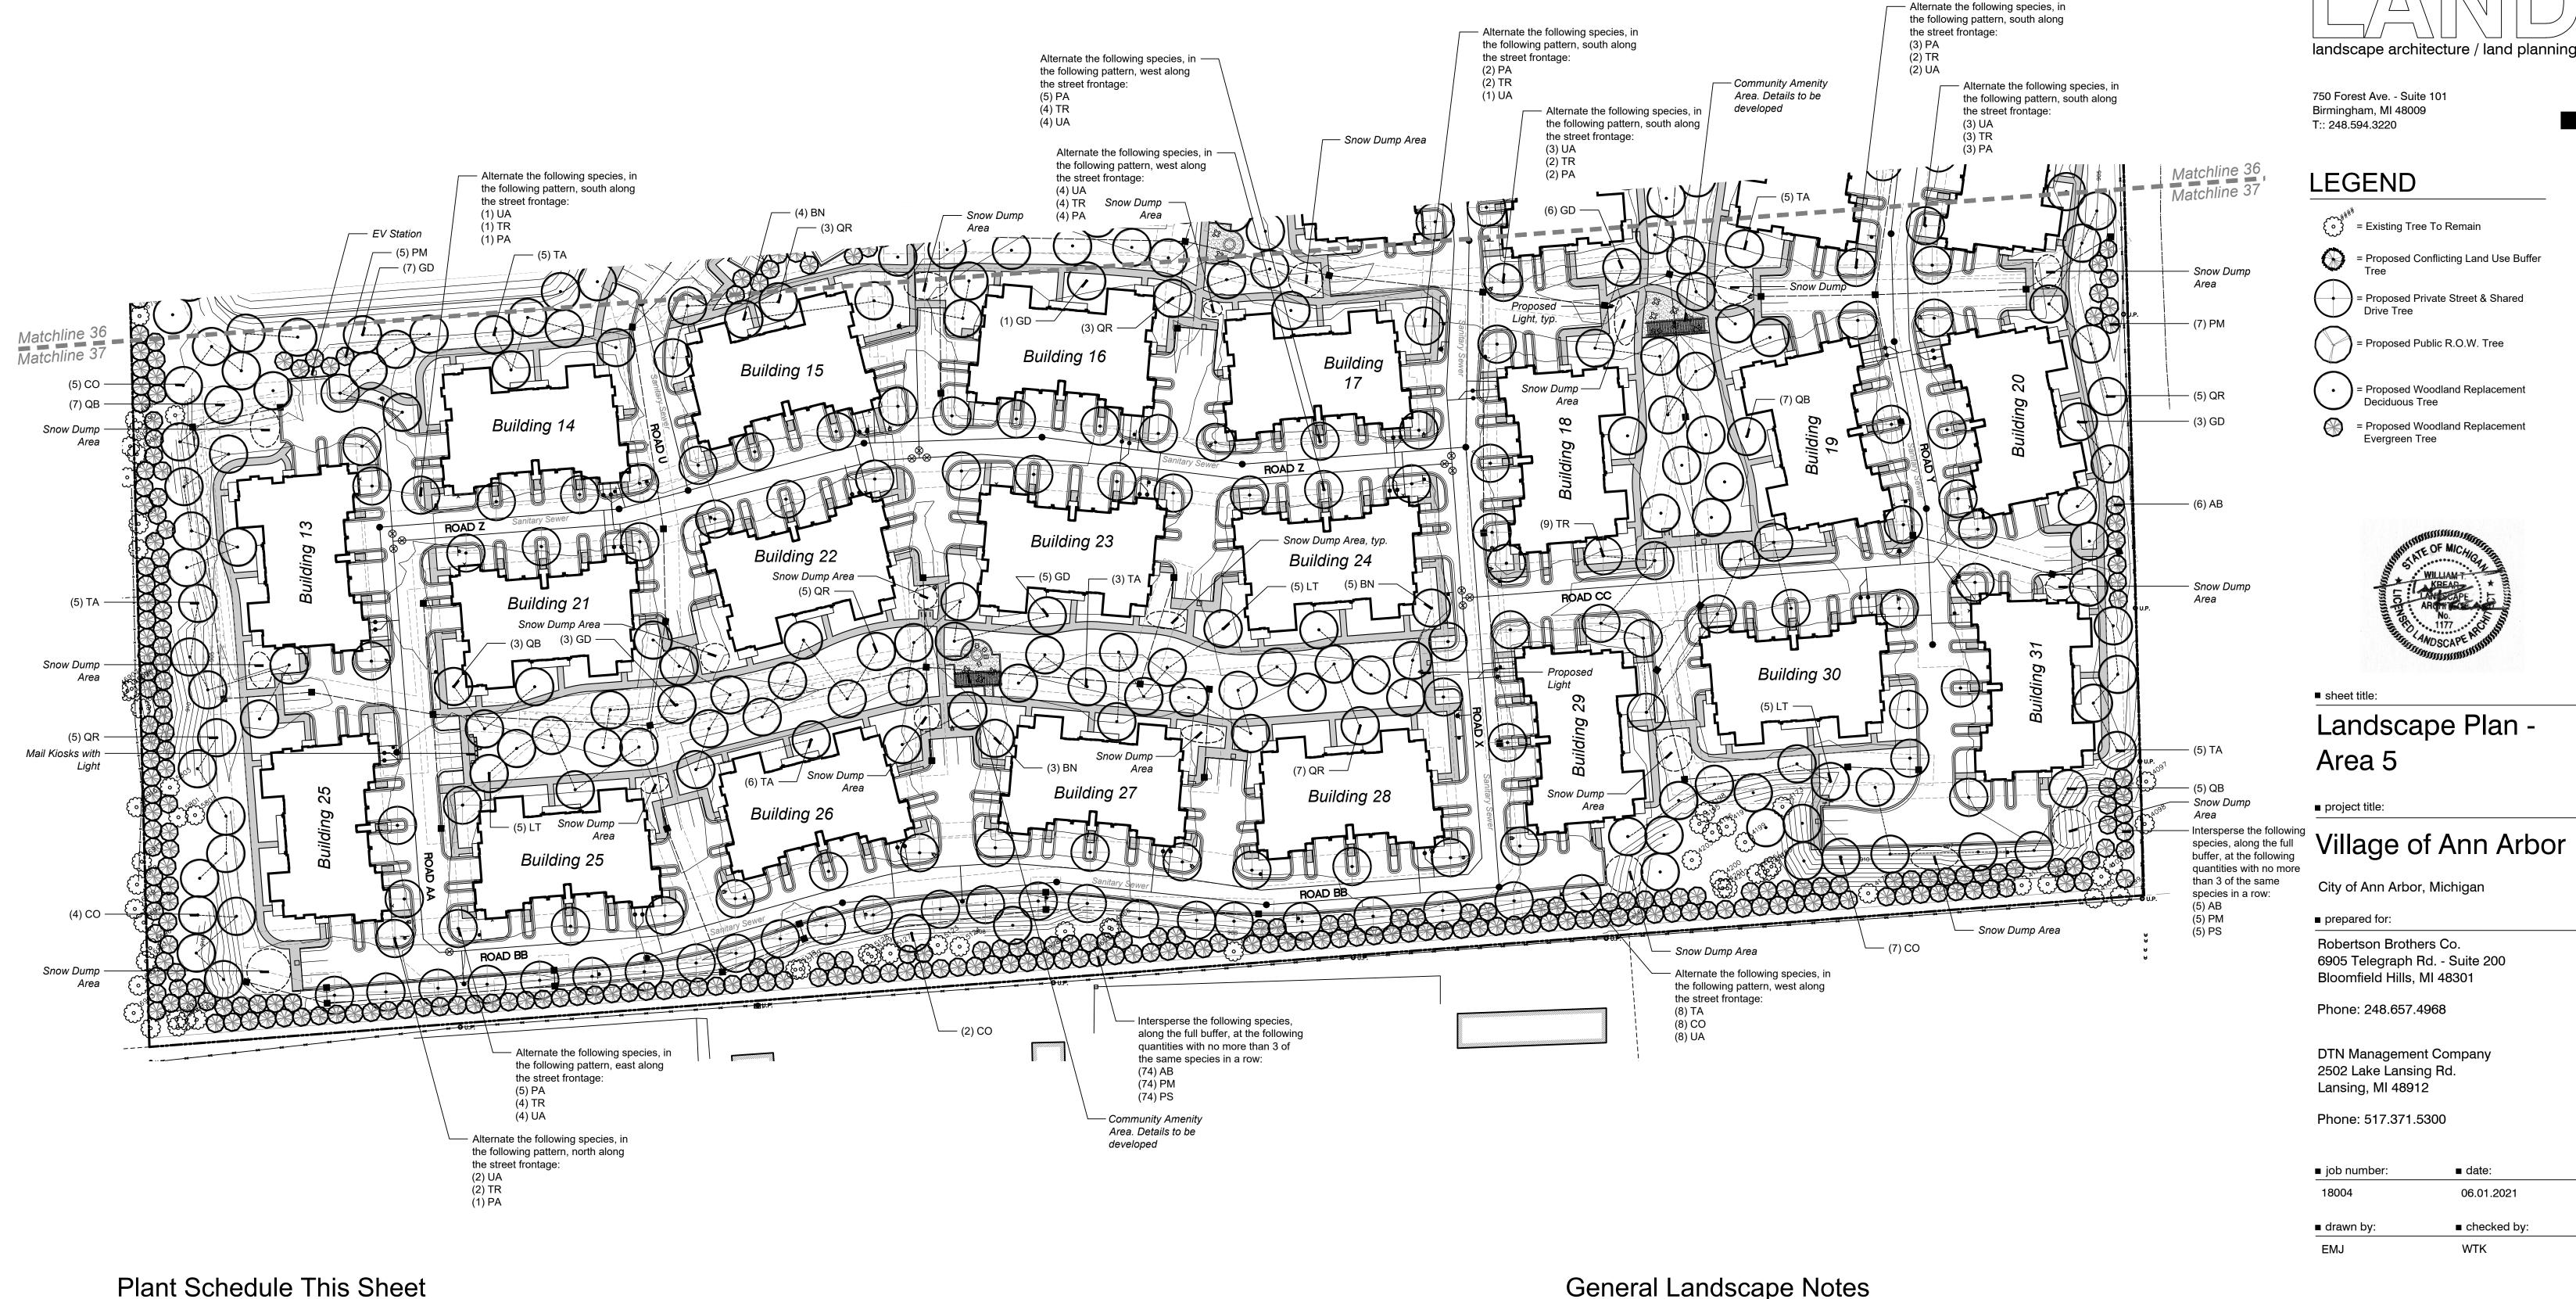

size spacing root

8' ht. per plans B&B

3" cal. per plans B&B

8' ht. per plans B&B

8' ht. per plans B&B

3" cal. per plans B&B

3" cal. per plans B&B

3" cal. per plans B&B

common name

Balsam Fir

River Birch

Hackberry

Tulip Tree

Black Spruce

Swamp White Oak

White Pine

Red Oak

Basswood

Kentucky Coffeetree

Woodland Replacement Trees

QR

Abies balsamea

Celtis occidentalis

Picea mariana

Pinus strobus

Quercus bicolor

Quercus rubra Tilia americana

Gymnocladus diocus


Liriodendron tulipifera

Betula nigra

botanical name


General Landscape Notes

- Utility box locations are unknown at this time. Once the box locations are known they
- will be screened on 3 sides. See detail on Sheet 33. - Disturbed areas shall be sodded or seeded.
- Landscape areas shall be irrigated.
- Snow shall be stored along streets. Storage shall not include detention areas or
- Trees shall be planted a min. 5'-8' from utility leads. Trees shall be planted such that a 1:1 trench could be dug to access utility leads.
- Trees shall be planted a min. 10' from Water Main & Sanitary Sewer
- All deciduous trees shall be planted a min. 15' o.c. Evergreen trees shall be planted a
- Trees shall be planted a min. 15' from fire hydrants

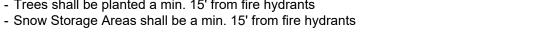



| | ■ revisions: | |
|----|--------------|----------------------|
| | 10.11.2021 | Per Municipal Review |
| | 01.20.2022 | Per Municipal Review |
| | 03.31.2022 | Per Municipal Review |
| | 06.15.2022 | Per Municipal Review |
| ٦. | 08.22.2022 | Per PC Comments |
| , | | |

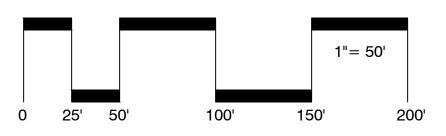



design studio

These drawings as instruments of service, remain the property of LAND Design Studio, PLLC. Any changes, publications or unauthorized use is prohibited unless expressly approved.

© LAND Design Studio, PLLC

Private Street & Shared Drive Trees

Celtis occidentalis

Quercus rubra

Tilia americana

Gymnocladus diocus

26 Platanus x acerifolia 'Exclamation'

Tilia americana 'Redmond'

Ulmus americana 'Princeton'

botanical name

common name

Exclamation London Planetree

Hackberry

Red Oak

Basswood

Redmond Linden

Princeton American Elm

Kentucky Coffeetree

size spacing root

2.5" cal. per plans B&B

3" cal. per plans B&B

2.5" cal. per plans B&B

3" cal. per plans B&B

2.5" cal. per plans B&B

2.5" cal. per plans B&B


2.5" cal. per plans B&B

sym. qty.

CO

GD

QR

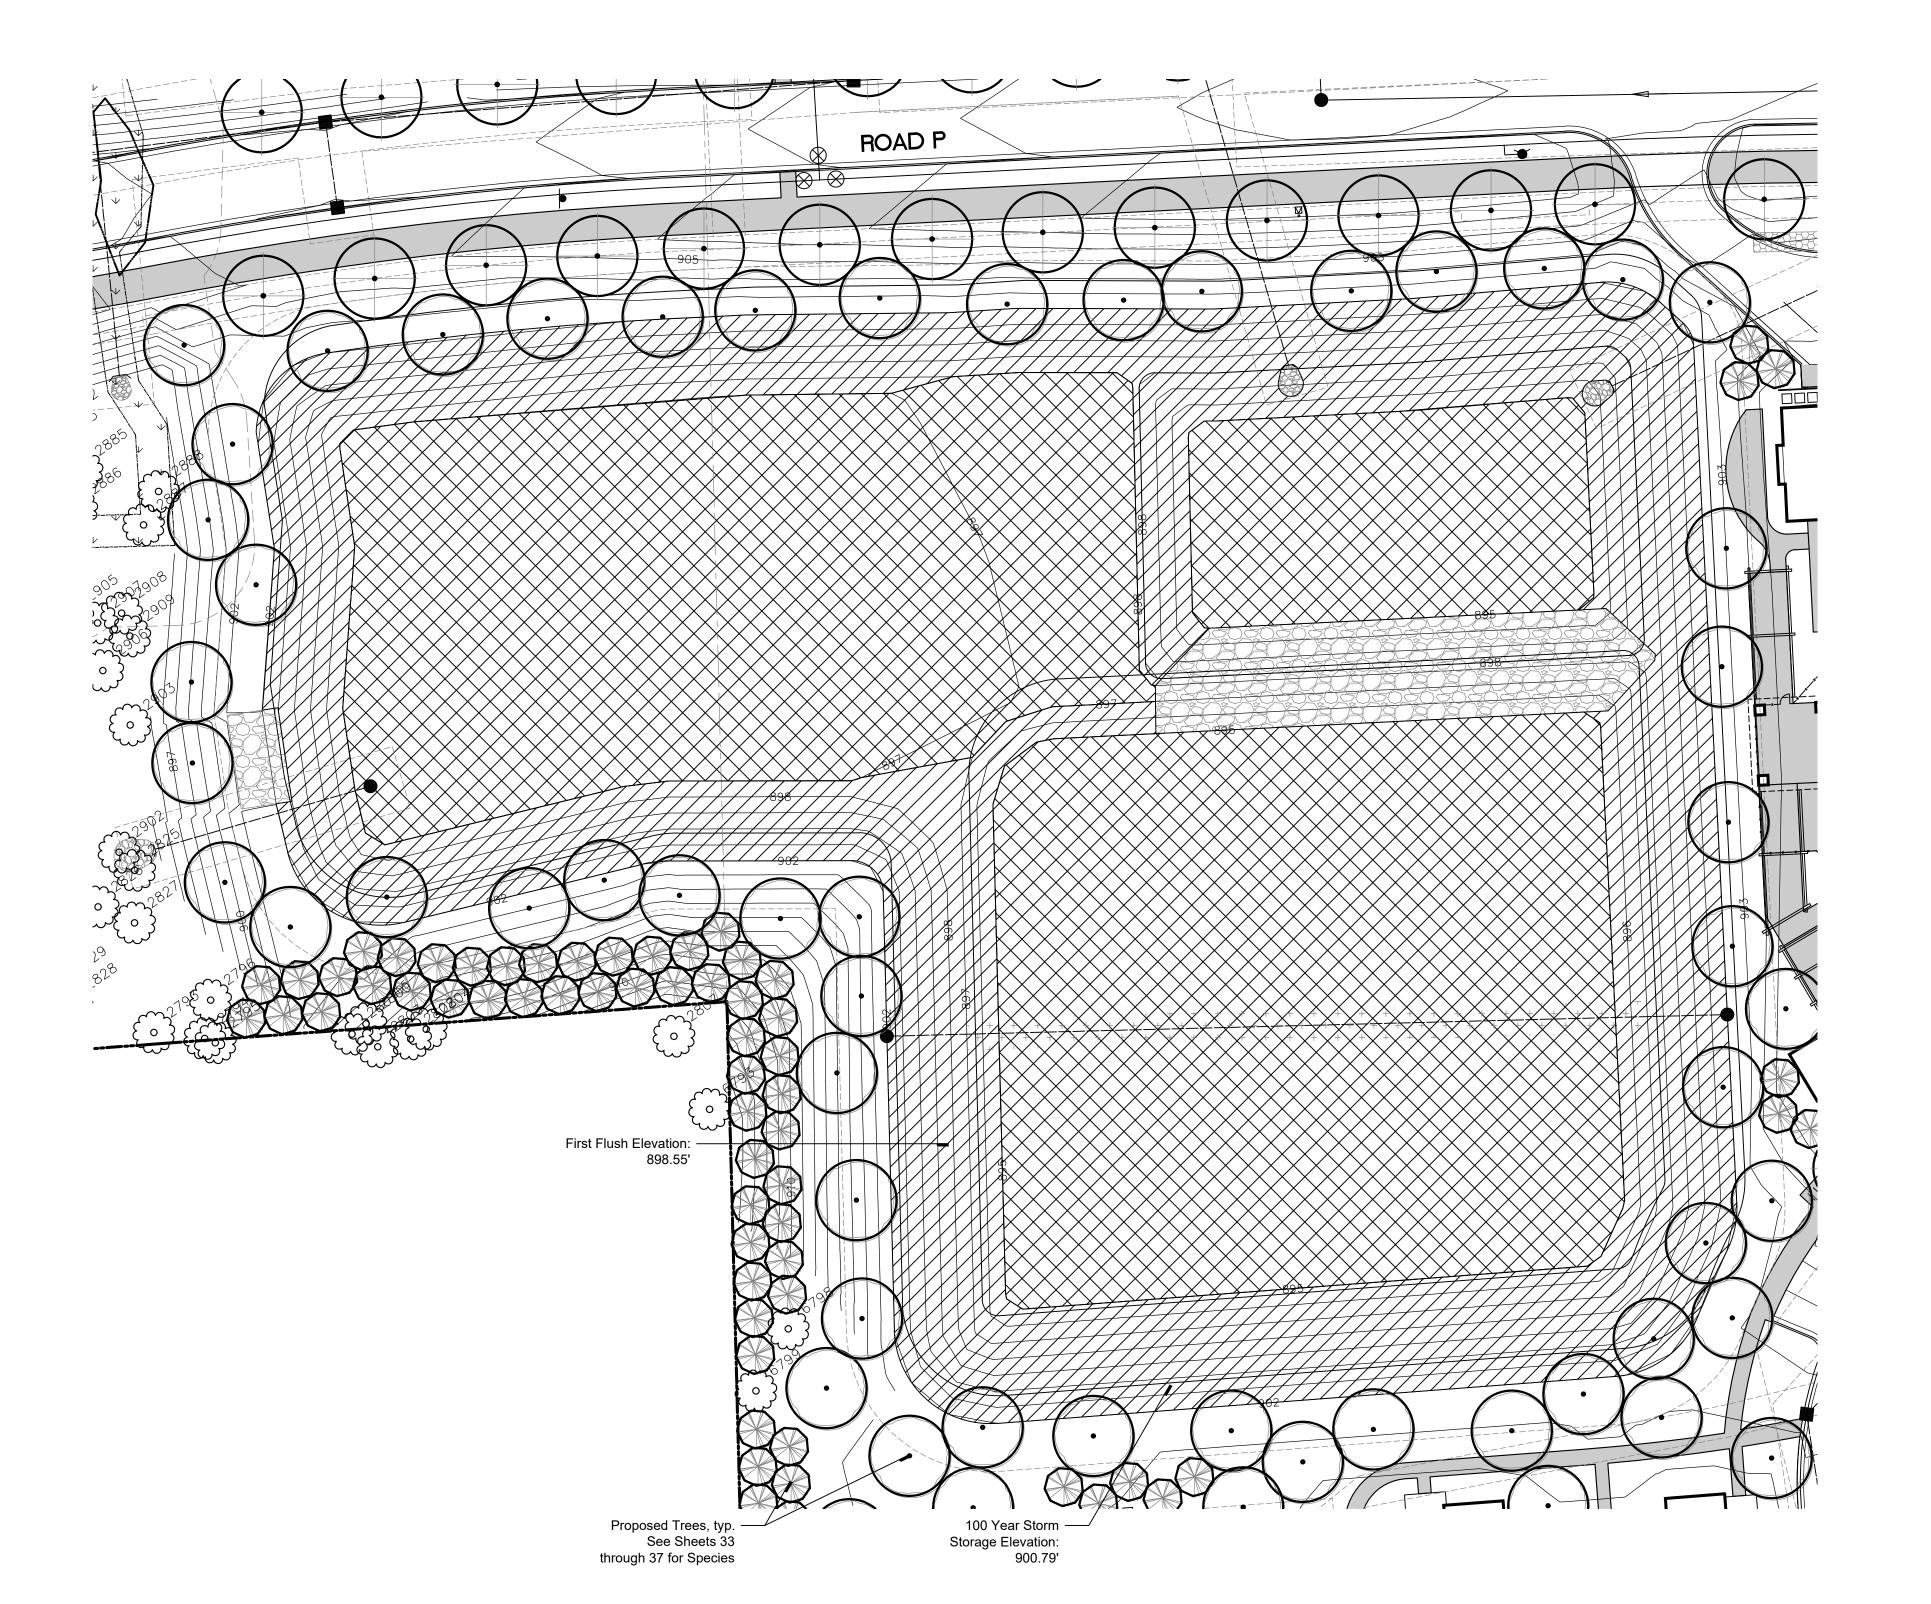

Infiltration Basin Summary

Slope Zone - 902' to Basin Floor Areas

45,748 s.f.

Application Rate: 40.0 lbs. / Ac. 42.00 lbs. of Storm Water Seed Mix

3"-6" of Composted Organic Material shall be placed in this area.

Seed Mix available from Nativescape - www.nativescapellc.com - 517.456.9696 - info@nativescapellc.com

Wet Meadow Plug Zone - Basin Floor Areas

70,919 s.f. Total
Plug Plant Schedule

| Live Plug | gs | | | |
|-----------|---------------------------|------------------|----------|-----------|
| qty. | botanical name | common name | spacing | Root |
| 2,533 | Acorus americanus | Sweet Flag | 24" o.c. | Live Plug |
| 2,533 | Asclepias incarnata | Swamp Milkweed | 24" o.c. | Live Plug |
| 2,533 | Campanula americana | Tall Bellflower | 24" o.c. | Live Plug |
| 2,533 | Eupatorium maculatum | Joe Pye Weed | 24" o.c. | Live Plug |
| 2,533 | Potamogeton pectinatus | Sago Pondweed | 24" o.c. | Live Plug |
| 2,533 | Sagittaria latifolia | Common Arrowhead | 24" o.c. | Live Plug |
| 2,533 | Silphium terebinthinaceum | Prairie Dock | 24" o.c. | Live Plug |

Landscape Contractor shall mix species of plugs together as installation occurs to ensure no area is overwhelmingly one species of plug.

Infiltration Basin Seed Mix

| 517-456-9696 | | | |
|-------------------------------|---|-----------|----------------|
| nfo@nativescapellc.c | <u>om</u> | | |
| Detention B | asin Mix | | |
| This mix contains at least | (10) of the Flowers, (4) of the Grasses | & Sedges. | |
| Common Name | Scientific Name | #/acre | Q |
| Temporary Grasses | 50% | 20 | |
| Seed Oats | Avena sattiva | 14.0 | 1 |
| Annual Rye | Lolium multiflorum | 6.0 | 6 |
| Native Grasses | 30% | 12 | |
| Big Bluestem Grass | Andropogon gerardii | 3.0 | ∃ 3 |
| Fringed Sedge | Carex crinita | 0.5 | 7 o |
| Fox Sedge | Carex vulpinoidea | 0.5 | [−] 0 |
| Canada Wild Rye | Elymus canadensis | 3.5 | 3 |
| Dark Green Bulrush | Scirpus atrovirens | 1.0 | 1 |
| Indian Grass | Sorghastrun nutans | 3.0 | 3 |
| Prairie Cord Grass | Spartina pectinata | 0.5 | _ o |
| Native Wildflowers | 20% | 8 | |
| Calico Aster | Aster laterifolius | 0.2 | 7 o |
| New England Aster | Aster novae-angliae | 0.3 | T 0 |
| Pale Indian Plantain | Cacalia atriplicifolia | 0.2 | 7 0 |
| Turtlehead | Chelone glabra | 0.2 | 0 |
| Joepye Weed | Eupatorium maculatum | 0.3 | 0 |
| Boneset | Eupatorium perfoliatum | 0.2 | 0 |
| Ox Eye Sunflower | Heliopsis helianthoides | 0.6 | 0 |
| Dense Blazingstar | Liatris spicata | 0.3 | 0 |
| Cardinal Flower | Lobelia cardinalis | 0.2 | 0 |
| Great Blue Lobelia | Lobelia siphilitica | 0.2 | 0 |
| Yellow Coneflower | Ratibita pinnata | 1.8 | 1 |
| Black-eyed Susan | Rudbeckia hirta | 2.0 | _ 2 |
| Green-headed Coneflow | | 0.2 | 0 |
| Cupplant | Silphium perfeliatum | | |
| Ohio Goldenrod | Solidago ohioensis | 0.2 | _ 0 |
| Riddell's Goldenrod | Solidago riddellii | 0.2 | 0 |
| Blue Vervain Culver's Root | Verbena hastata | 0.5 | 0 |
| | Veronicastrum virginicum | 0.2 | 0 |
| Ironw eed | Vernonia gigantea | 0.2 | 0 |

Notify Seed Supplier that Silphium perfoliatum (Cupplant) cannot be used in the specified seed mix due to being a Threatened

*Quantities are determined by availability of seed at the time of ordering and are subject to change. Species shown in the table, with the exception of Silphium perfoliatum, will not change

Infiltration Basin Notes

No chemicals are allowed in Stormwater Features

Invasive species may be treated with chemicals by a certified applicator. Mowing is allowed only twice

Soils must be amended with a composted organic material. Soils must be free of construction debris

At the time of plant and seed delivery, a WCWRC

quantity and species delivered will be reviewed on

wytychakc@washtenaw.org or 734.222.6813 to

or Buffer Zones with the following exception:

and subsoils. Soils must contain 20%-30%

Landscape Reviewer must be present. The

site. Contact Catie Wytychakc at

coordinate.

750 Forest Ave. - Suite 101 Birmingham, MI 48009 T:: 248.594.3220

LEGEND

= Existing Tree To Remain



= Proposed Conflicting Land Use Buffer

landscape architecture / land planning

design studio



= Proposed Public R.O.W. Tree



= Proposed Woodland Replacement Deciduous Tree



= Proposed Woodland Replacement Evergreen Tree



■ sheet title:

Stormwater Basin Landscape

project title:

Village of Ann Arbor

City of Ann Arbor, Michigan

prepared for:

Robertson Brothers Co. 6905 Telegraph Rd. - Suite 200 Bloomfield Hills, MI 48301

Phone: 248.657.4968

DTN Management Company 2502 Lake Lansing Rd. Lansing, MI 48912

Phone: 517.371.5300

■ job number:

| 18004 | 06.01.2021 | | | | |
|-------------|---------------|--|--|--|--|
| ■ drawn by: | ■ checked by: | | | | |
| EMJ | WTK | | | | |




| ١ | revisions: | |
|---|------------|----------------------|
| | 10.11.2021 | Per Municipal Review |
| | 01.20.2022 | Per Municipal Review |
| | 03.31.2022 | Per Municipal Review |
| | 06.15.2022 | Per Municipal Review |
| | 08.22.2022 | Per PC Comments |








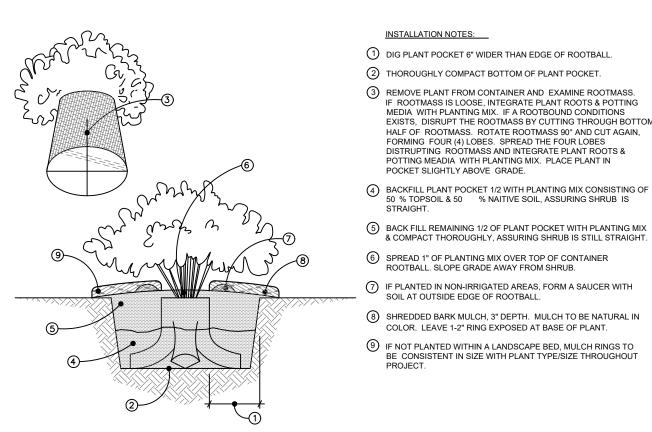

- (3) REMOVE PLANT FROM CONTAINER AND EXAMINE ROOTMASS IF ROOTMASS IS LOOSE, INTEGRATE PLANT ROOTS & POTTING MEDIA WITH PLANTING MIX. IF A ROOTBOUND CONDITIONS
 EXISTS, DISRUPT THE ROOTMASS BY CUTTING THROUGH BOTTOM HALF OF ROOTMASS. ROTATE ROOTMASS 90° AND CUT AGAIN, FORMING FOUR (4) LOBES. SPREAD THE FOUR LOBES DISTRUPTING ROOTMASS AND INTEGRATE PLANT ROOTS & POTTING MEADIA WITH PLANTING MIX. PLACE PLANT IN
- % TOPSOIL & 50 % NAITIVE SOIL, ASSURING SHRUB IS
- SPREAD 1" OF PLANTING MIX OVER TOP OF CONTAINER
- COLOR. LEAVE 1-2" RING EXPOSED AT BASE OF PLANT.
- (9) IF NOT PLANTED WITHIN A LANDSCAPE BED, MULCH RINGS TO

Shrub Planting Detail - Container

Scale: NTS

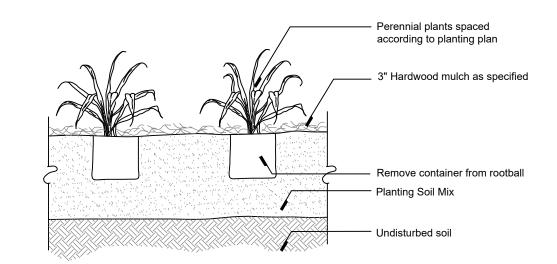


Perennial Planting Detail

1) DIG PLANT POCKET 12" WIDER THAN EDGE OF


INSTALLATION NOTES:

- (2) THOROUGHLY COMPACT BOTTOM OF PLANT POCKET. (3) REMOVE ALL TWINE FROM TOP OF ROOTBALL. EXAMINE TRUNK COLLAR & REMOVE EXCESS SOIL FROM TOP O ROOTBALL DOWN TO THE UPPER LEVEL OF THE ROOT SYSTEM. SET ROOTBALL WITH TOP 1/8 OF BALL ABOVE
- 4 PLACE BACKFILL UNDER & ALONGSIDE BASE OF BALL
- (5) BACKFILL PLANT POCKET 1/3 WITH PLANTING MIX CONSISTING OF 50 % TOPSOIL & 50 % NATIVE SOIL & COMPACT THOROUGHLY, ASSURING TREE IS STILL
- (6) BEFORE CONTINUING WITH BACKFILL, REMOVE TOP WIRE LOOPS, OR BEND DOWN UNTIL THEY TOUCH SIDE OF BALL. REMOVE EXCESS BURLAP.
- (7) BACKFILL PLANT POCKET SECOND 1/3 WITH PLANTING MIX & COMPACT THOROUGHLY, ASSURING TREE IS STILL
- (8) BACKFILL PLANT POCKET LAST 1/3 WITH PLANTING MIX &
- COMPACT THOROUGHLY, ASSURING TREE IS STILL STRAIGHT. SLOPE GRADE AWAY FROM TREE. (9) IF PLANTED IN NON-IRRIGATED AREAS, FORM A
- SAUCER WITH SOIL AT OUTSIDE EDGE OF ROOTBALL (10) SHREDDED BARK MULCH, 3" DEPTH, MULCH TO BE NATURAL IN COLOR. LEAVE 2-3" RING EXPOSED AT
- (1) MULCH RINGS TO BE CONSISTENT WITH PLANT TYPE/SIZE THROUGHOUT PROJECT & SHOULD EXTEND 6" BEYOND LOWEST BRANCH OF EVERGREEN TREES.
- (12) MINIMUM 2"x2"x60" HARDWOOD STAKES TO EXTEND INTO UNDISTURBED SOIL UNDER PLANT POCKET. STAKE LOCATIONS PER TREE TO BE CONSISTENT THROUGHOUT
- (3) 1" WIDE BELT LIKE NYLON, PLASTIC, OR OTHER ACCEPTABLE MATERIAL, NO WIRE OR HOSE TO BE USE

Evergreen Tree Planting Detail - 10' Ht. and Under

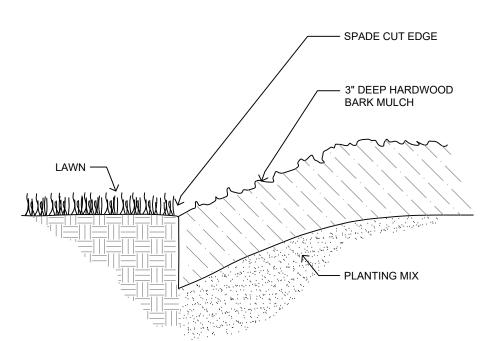

Spade Cut Edging Detail

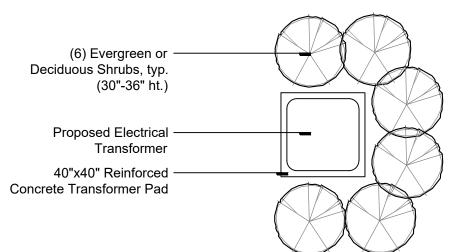


screened on a minimum of three Actual Pad and Plant Locations shall be determined in the field, based on actual construction, orientation, and desired screening

- Transformer Pad shall be

Optional Transformer Screening Detail

Scale: 1/4" = 1'

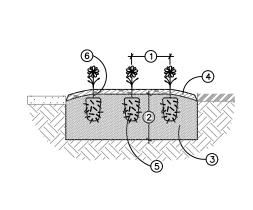

- INSTALLATION NOTES: 1 SEE DRAWING FOR PLANT (2) EXCAVATE BED TO A MINIMUM 6"
- DEPTH. BACKFILL WITH PREPARED PLANTING MIX.

3 PLANTING MIX TO CONSIST OF 50%

TOPSOIL & 50% LEAF COMPOST

- (4) SHREDDED BARK MULCH, 1" EPTH. MULCH TO BE NATURAL IN COLOR.
- 5 REMOVE ALL CONTAINERS. IF ROOTBOUND, DISRUPT ROOT PLUG (6) PLANT THE ANNUAL OR GROUND ASSURING THAT PLANTING MIX
 COVERS ENTIRE ROOT MASS OF
 PLANT MULCH INTO THE PLANTING MIX

Annual & Ground Cover Planting Detail

Landscape Notes

- Tree stakes, guy wires and tree wrap shall be removed after one year.
- All trees shall be planted no closer than 15' to fire hydrants. 3. All plant material shall be true to name and free from physical damage and
- 4. Plants shall be full, well-branched, and in a healthy, vigorous growing
- Plants shall be watered before and after planting is complete. All trees must be staked, fertilized, and mulched and shall be guaranteed to
- exhibit a normal growth cycle for at least one (1) full year following planting. All material shall conform to the guidelines established in the most recent
- edition of the American Standard for Nursery Stock. 8. Provide clean backfill soil, using material stockpiled on site. Soil shall be
- screened and free of any debris, foreign material, or stone. 9. "Agriform" tabs or similar slow-release fertilizer shall be added to the planting
- pits before being backfilled. 10. Amended planting mix shall consist of 1/3 screened topsoil, 1/3 sand, and 1/3
- 11. All plantings shall be mulched with shredded hardwood bark, spread to a
- minimum depth of 3". Mulch is to be free from debris and foreign material and shall contain no pieces of inconsistent size.
- 12. The Landscape Contractor shall be responsible for all work shown on the landscape drawings and specifications. 13. No substitutions or changes of location, or plant types shall be made without
- the approval of the Landscape Architect or Owner's representative. 14. The Landscape Architect shall be notified of any discrepancies between the
- plans and field conditions prior to installation. 15. The Landscape Contractor shall be responsible for maintaining all plant material in a vertical condition throughout the guaranteed period.
- 16. The Landscape Architect shall have the right at any stage of the installation to reject any work or material that does not meet the requirements of the plan and specifications, if requested by the owner.
- 17. The Contractor shall be responsible for checking plant quantities to ensure quantities on drawings and plant list are the same. In the event of a discrepancy, the quantities on the plans shall prevail.
- 18. The Landscape Contractor shall seed and mulch or sod (as indicated on plans) all areas disturbed during construction, throughout the contract limits.
- 19. A pre-emergent weed control agent, "Preen" or equal, shall be applied uniformly to all planting beds prior to mulching.
- 20. The Developer and Landscape Architect reserve the right to change location of plant material and alter plant species/variety at the time of installation based upon availability and quantity of material as well as site conditions. Materials will be of similar size, appearance and growth habit. All species deviations from the approved site plan must be approved by the City of Ann Arbor in writing prior to installation.
- 21. All Lawn areas shall be Seeded or Sodded

approved All Aluminum Construction

Decorative Mailbox - 4 Parcel CBU

City of Ann Arbor Notes

Continuing Care

Landscaping shall be kept in neat, orderly, and healthy growing condition, free from debris and refuse. All landscape material shall be maintained by a regular program or mowing, watering, weeding, feeding, and pruning. Pruning shall be minimal at the time of installation, only to remove dead or diseased branches. Subsequent pruning shall assure proper maturation of plants to achieve their approved purpose.

All dead or diseased plant material shall be removed and replaced within six (6) months after it dies, or in the next planting season, whichever occurs first.

This shall be accomplished by installation of an underground irrigation system to provide water for the landscape areas specified on the landscape plan.

Construct earth bed to required grade and trim. Prior to placement of topsoil or compost, harrow all earth beds to a minimum of 3" depth.

Beyond initial fertilization, all future fertilizer applications shall not contain phosphorus.

> 6 3 6 7 e 4 e 8

Decorative Mailbox - 8 Gang CBU

0 7

Manufacturer: Salsbury Industries

18300 Central Avenue

Carson, CA 90746

www.mailboxes.com

CBU 8 Doors & 2 Parcel Lockers

800.624.5269

3308BLK-U

2 Total

Quantity:

Includes

Pedestal

Includes

Pedestal

landscape architecture / land planning

design studio

750 Forest Ave. - Suite 101 Birmingham, MI 48009

LEGEND

T:: 248.594.3220



sheet title:

Landscape Details & Notes

project title:

Village of Ann Arbor

City of Ann Arbor, Michigan

prepared for:

Robertson Brothers Co. 6905 Telegraph Rd. - Suite 200 Bloomfield Hills, MI 48301

Phone: 248.657.4968

DTN Management Company 2502 Lake Lansing Rd. Lansing, MI 48912

Phone: 517.371.5300

| ■ job number: | ■ date: | | | | |
|---------------|------------|--|--|--|--|
| 18004 | 06.01.2021 | | | | |

checked by ■ drawn by **EMJ** WTK



■ revisions:

10.11.2021 Per Municipal Review 01.20.2022 Per Municipal Review 03.31.2022 Per Municipal Review 06.15.2022 Per Municipal Review 08.22.2022 Per PC Comments

sheet no.

39



Pedestal

Decorative Mailbox - 16 Gang CBU

Manufacturer: Salsbury Industries 18300 Central Avenue Carson, CA 90746 800.624.5269 www.mailboxes.com CBU 16 Doors & 2 Parcel Lockers 3316BLK-U

Black

Decorative Mailbox - 12 Gang CBU Manufacturer: Salsbury Industries

800.624.5269 www.mailboxes.com CBU 12 Doors & 1 Parcel Lockers 3312BLK-U

18300 Central Avenue

Carson, CA 90746

Black 10 Total Quantity:

23 Total Quantity:

Manufacturer: Salsbury Industries

18300 Central Avenue

Carson, CA 90746

www.mailboxes.com

800.624.5269

3304BLK-U


Black


8 Total


4 Parcel Lockers


These drawings as instruments of service, remain the property of LAND Design Studio. PLLC. Any changes, publications or unauthorized use is prohibited unless expressly approved.


© LAND Design Studio, PLLC

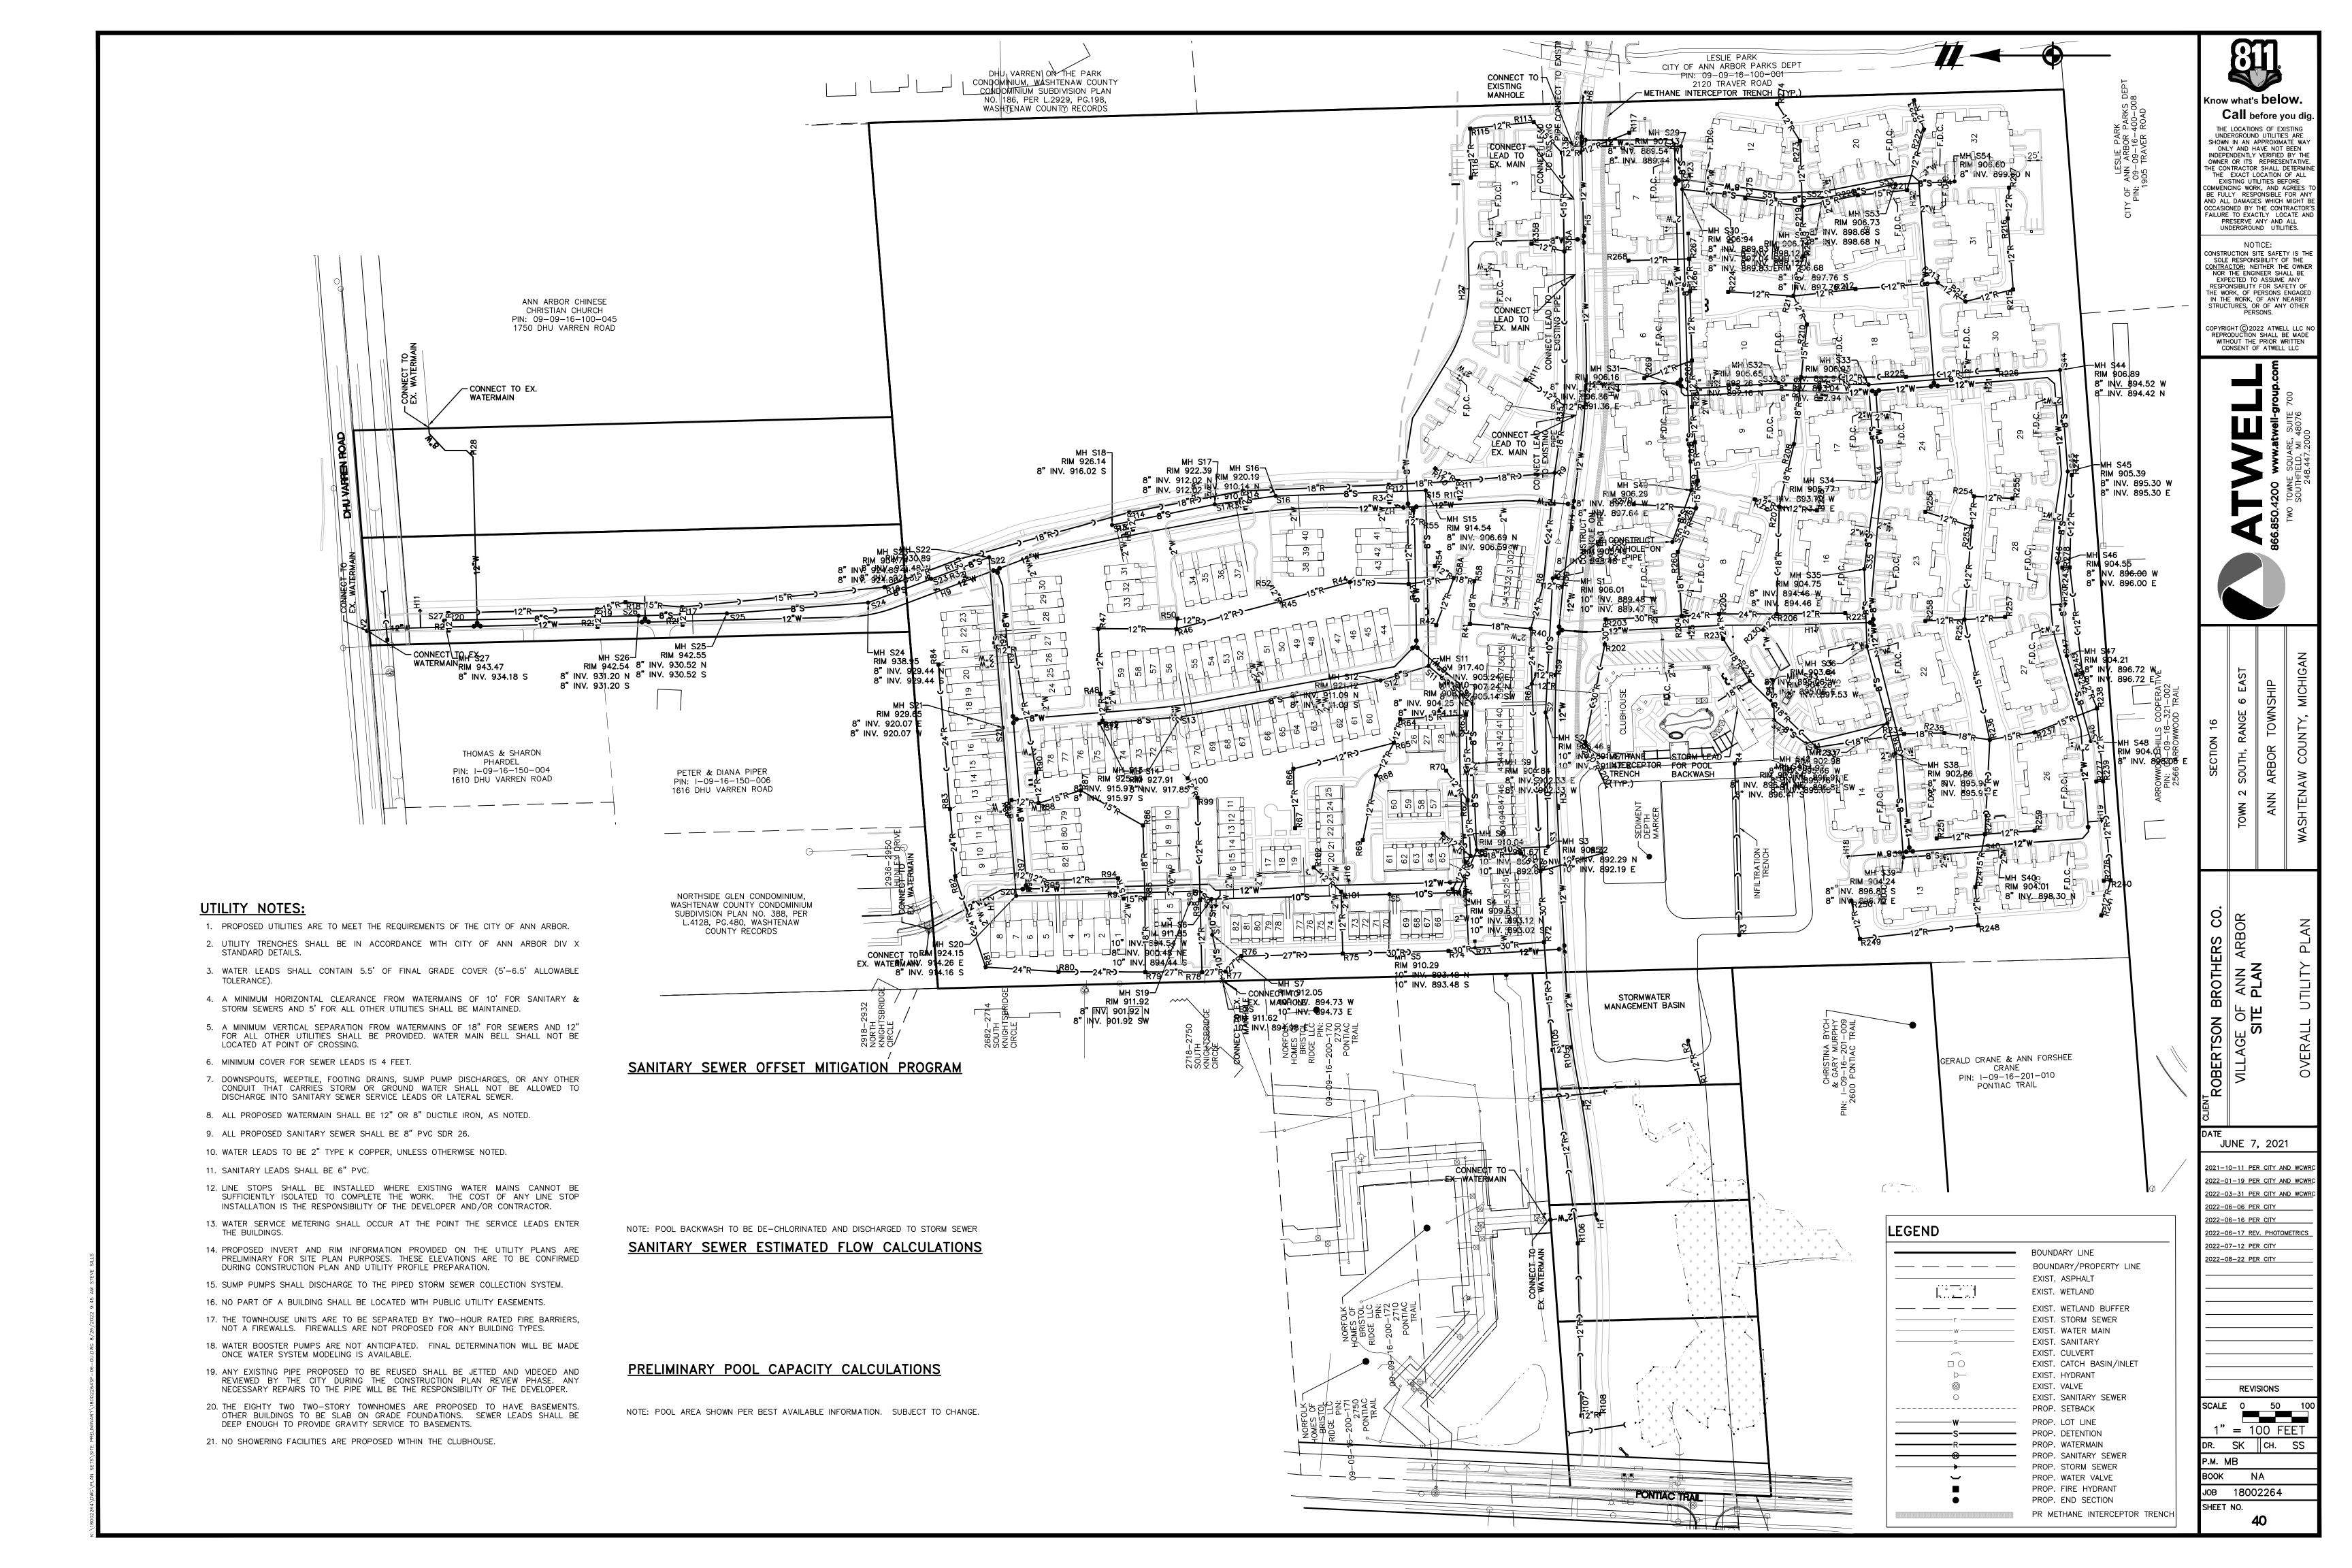


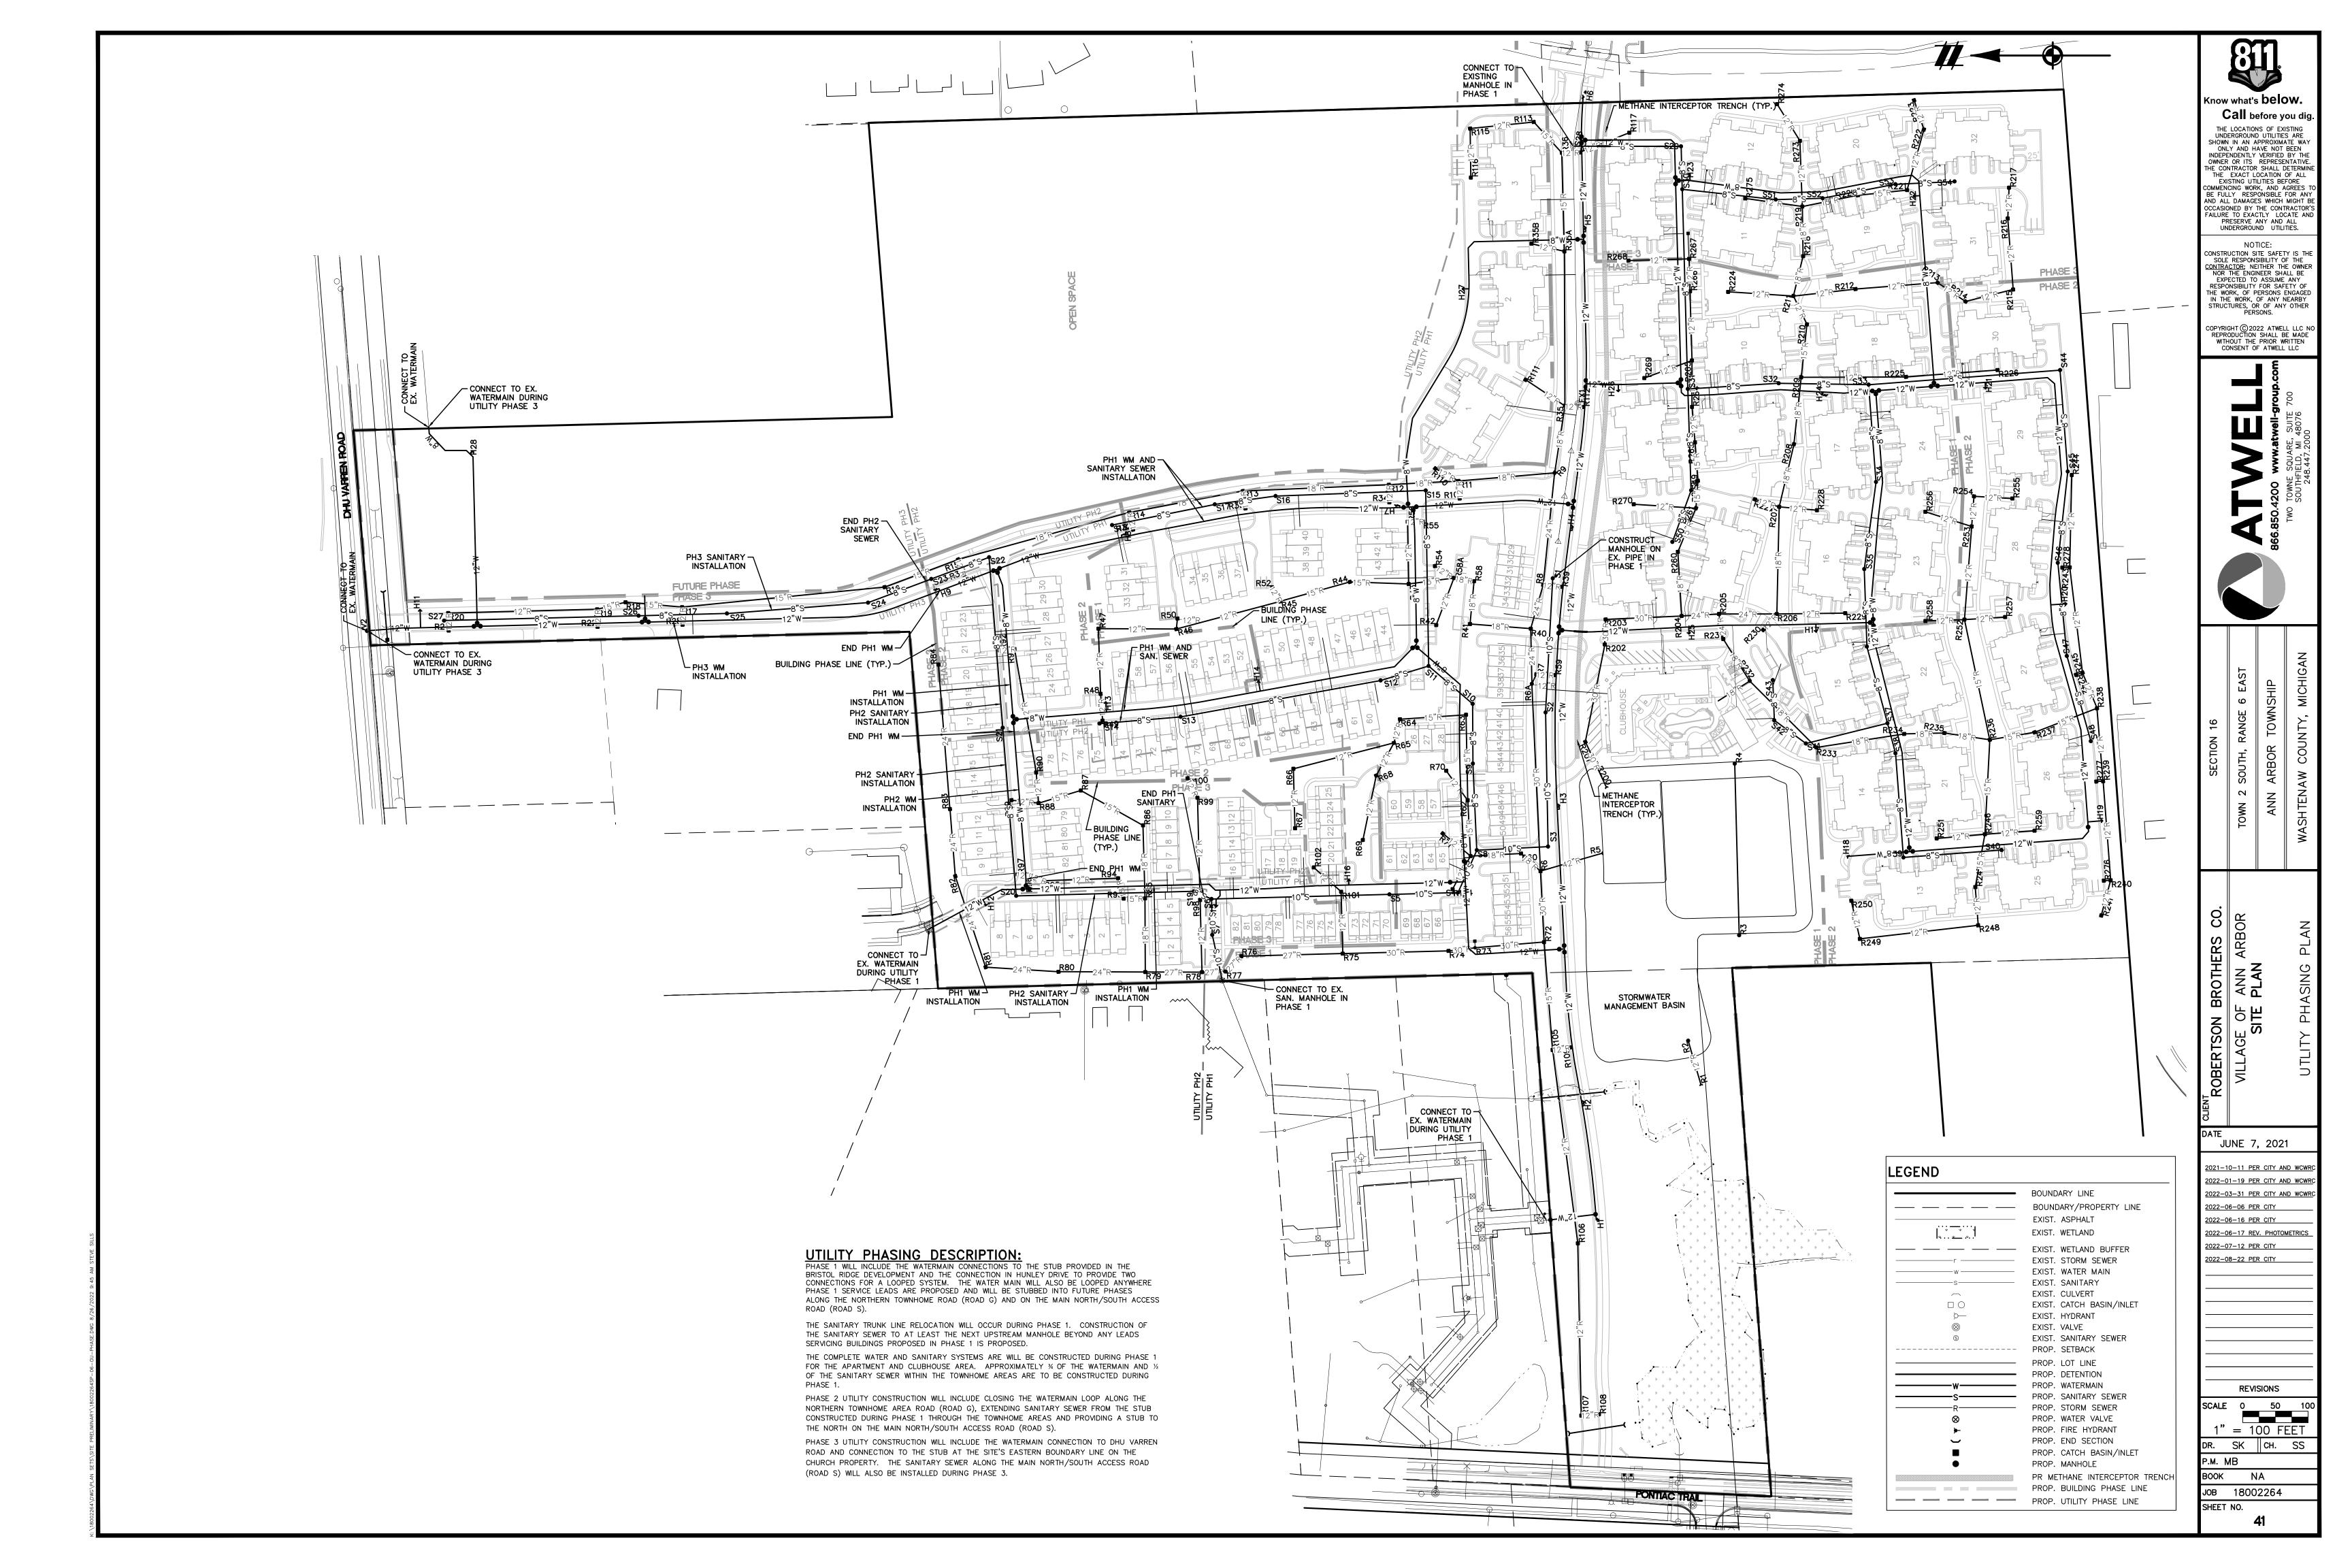


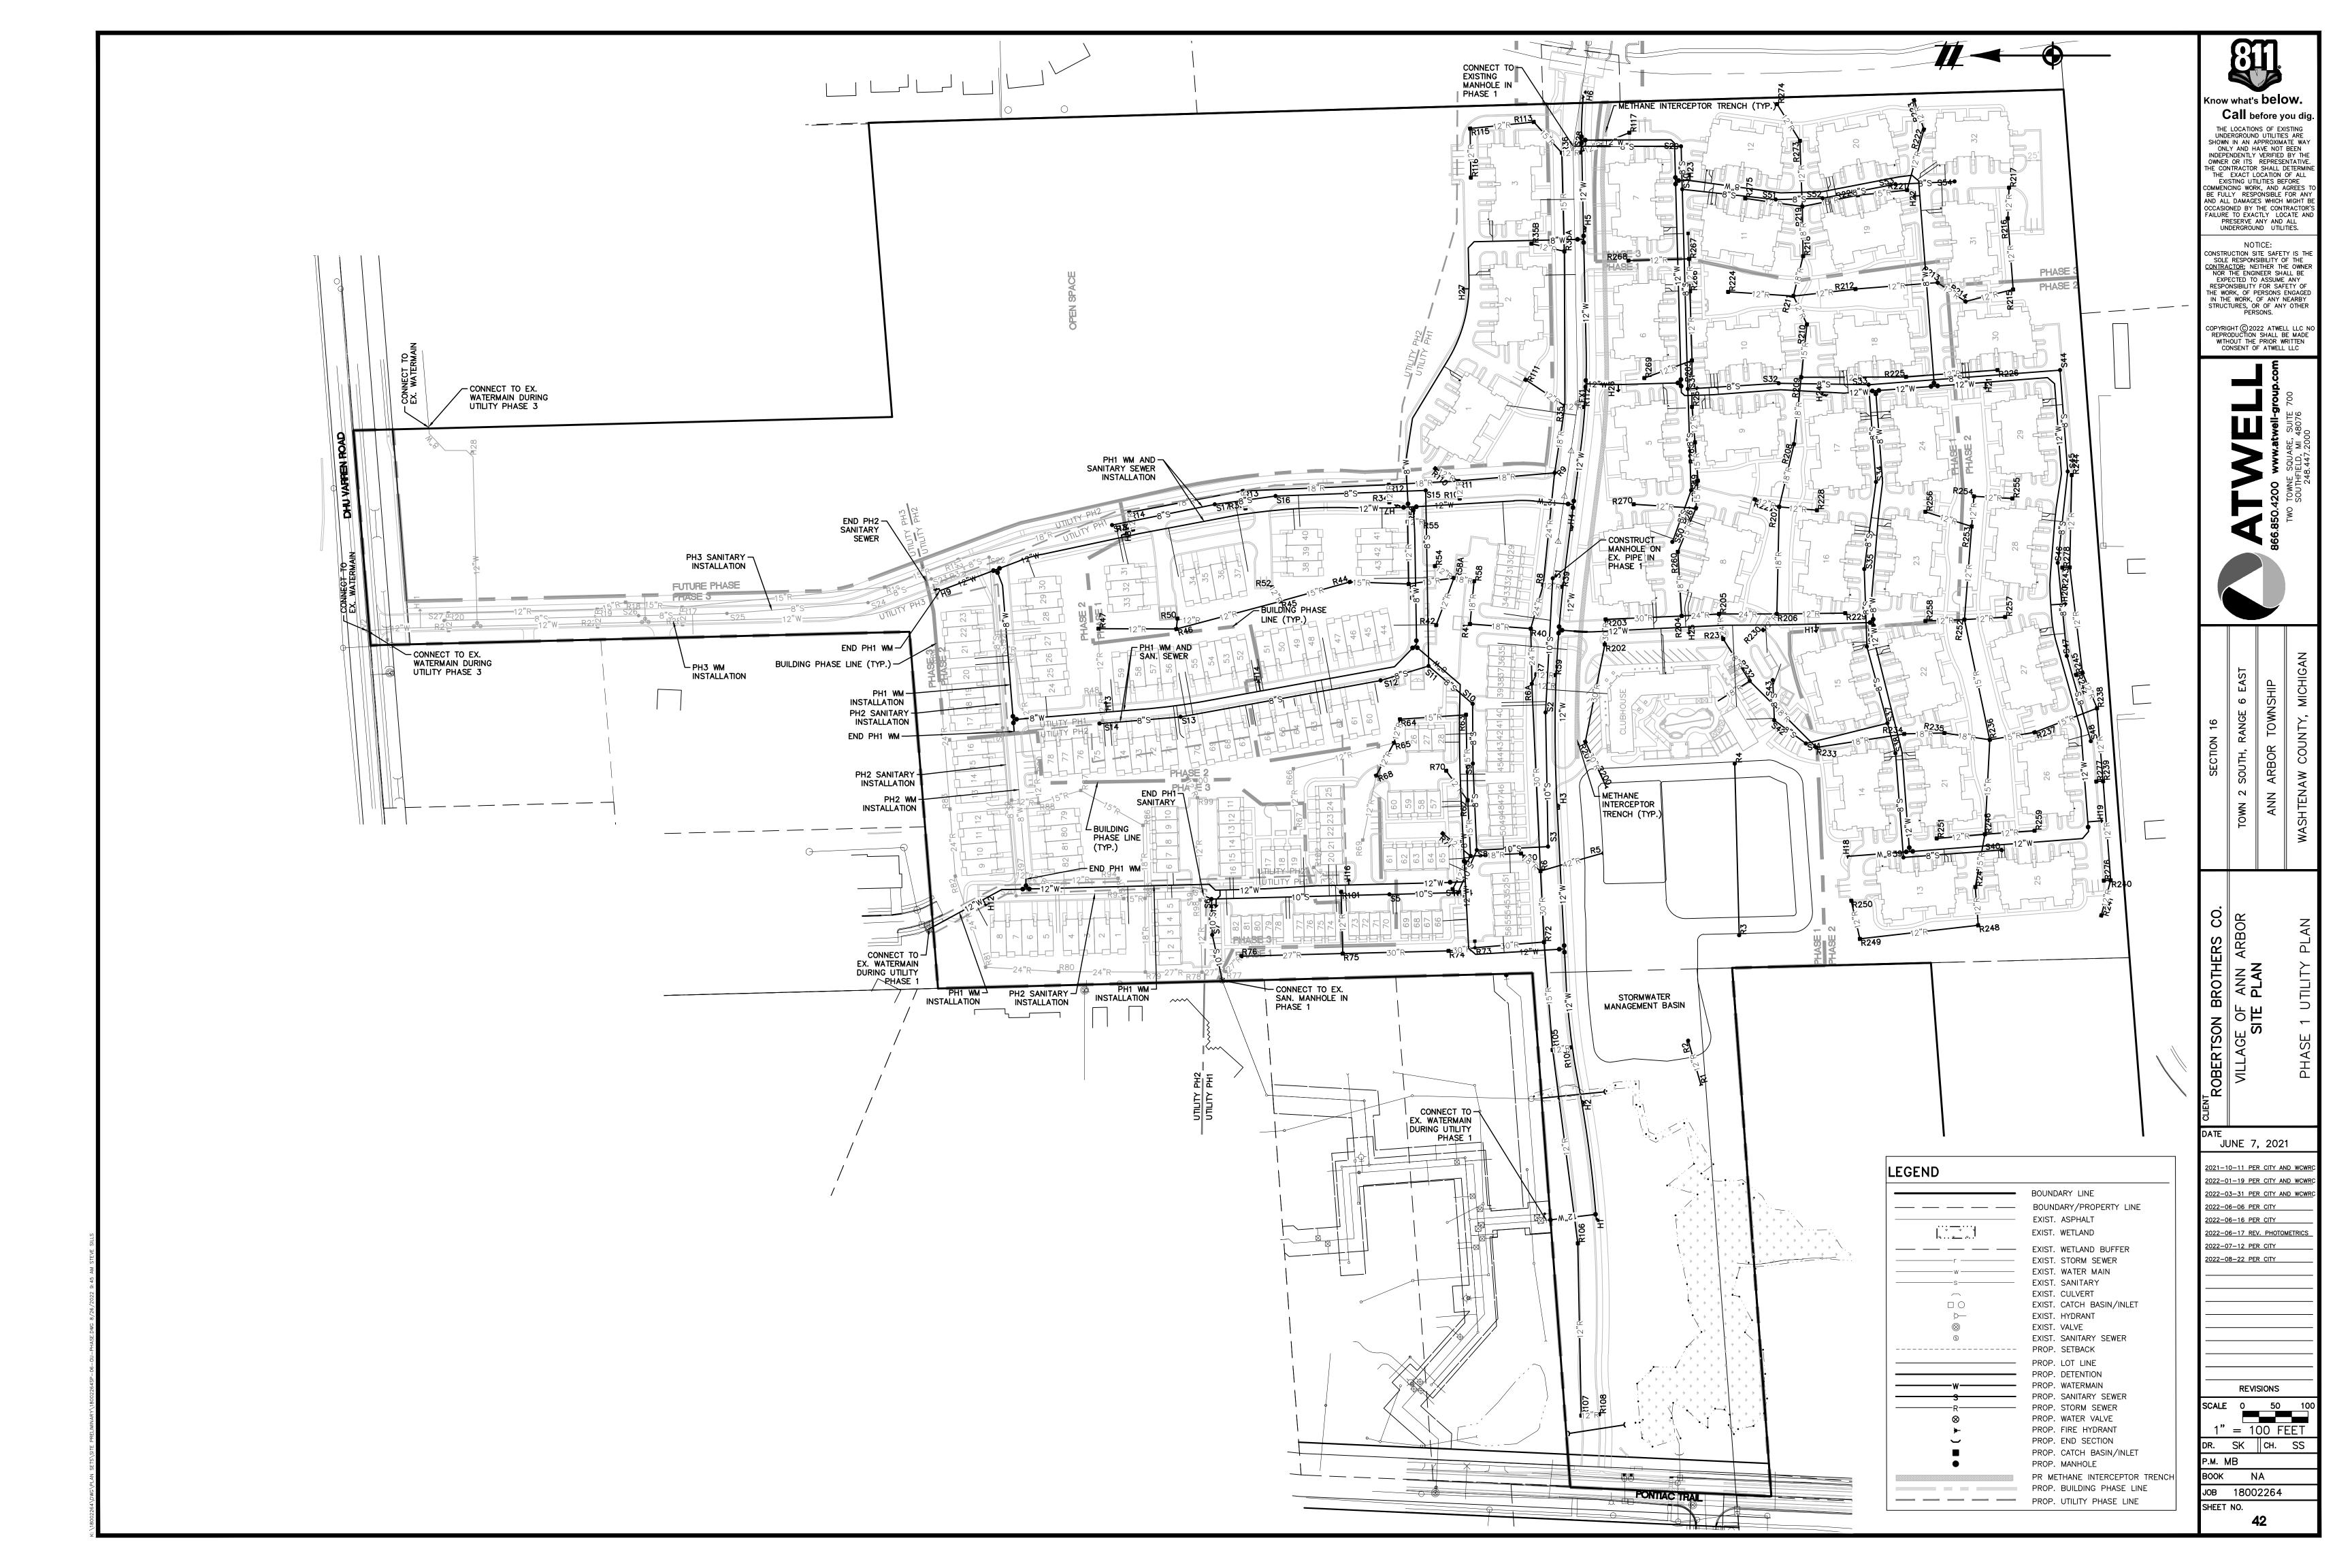

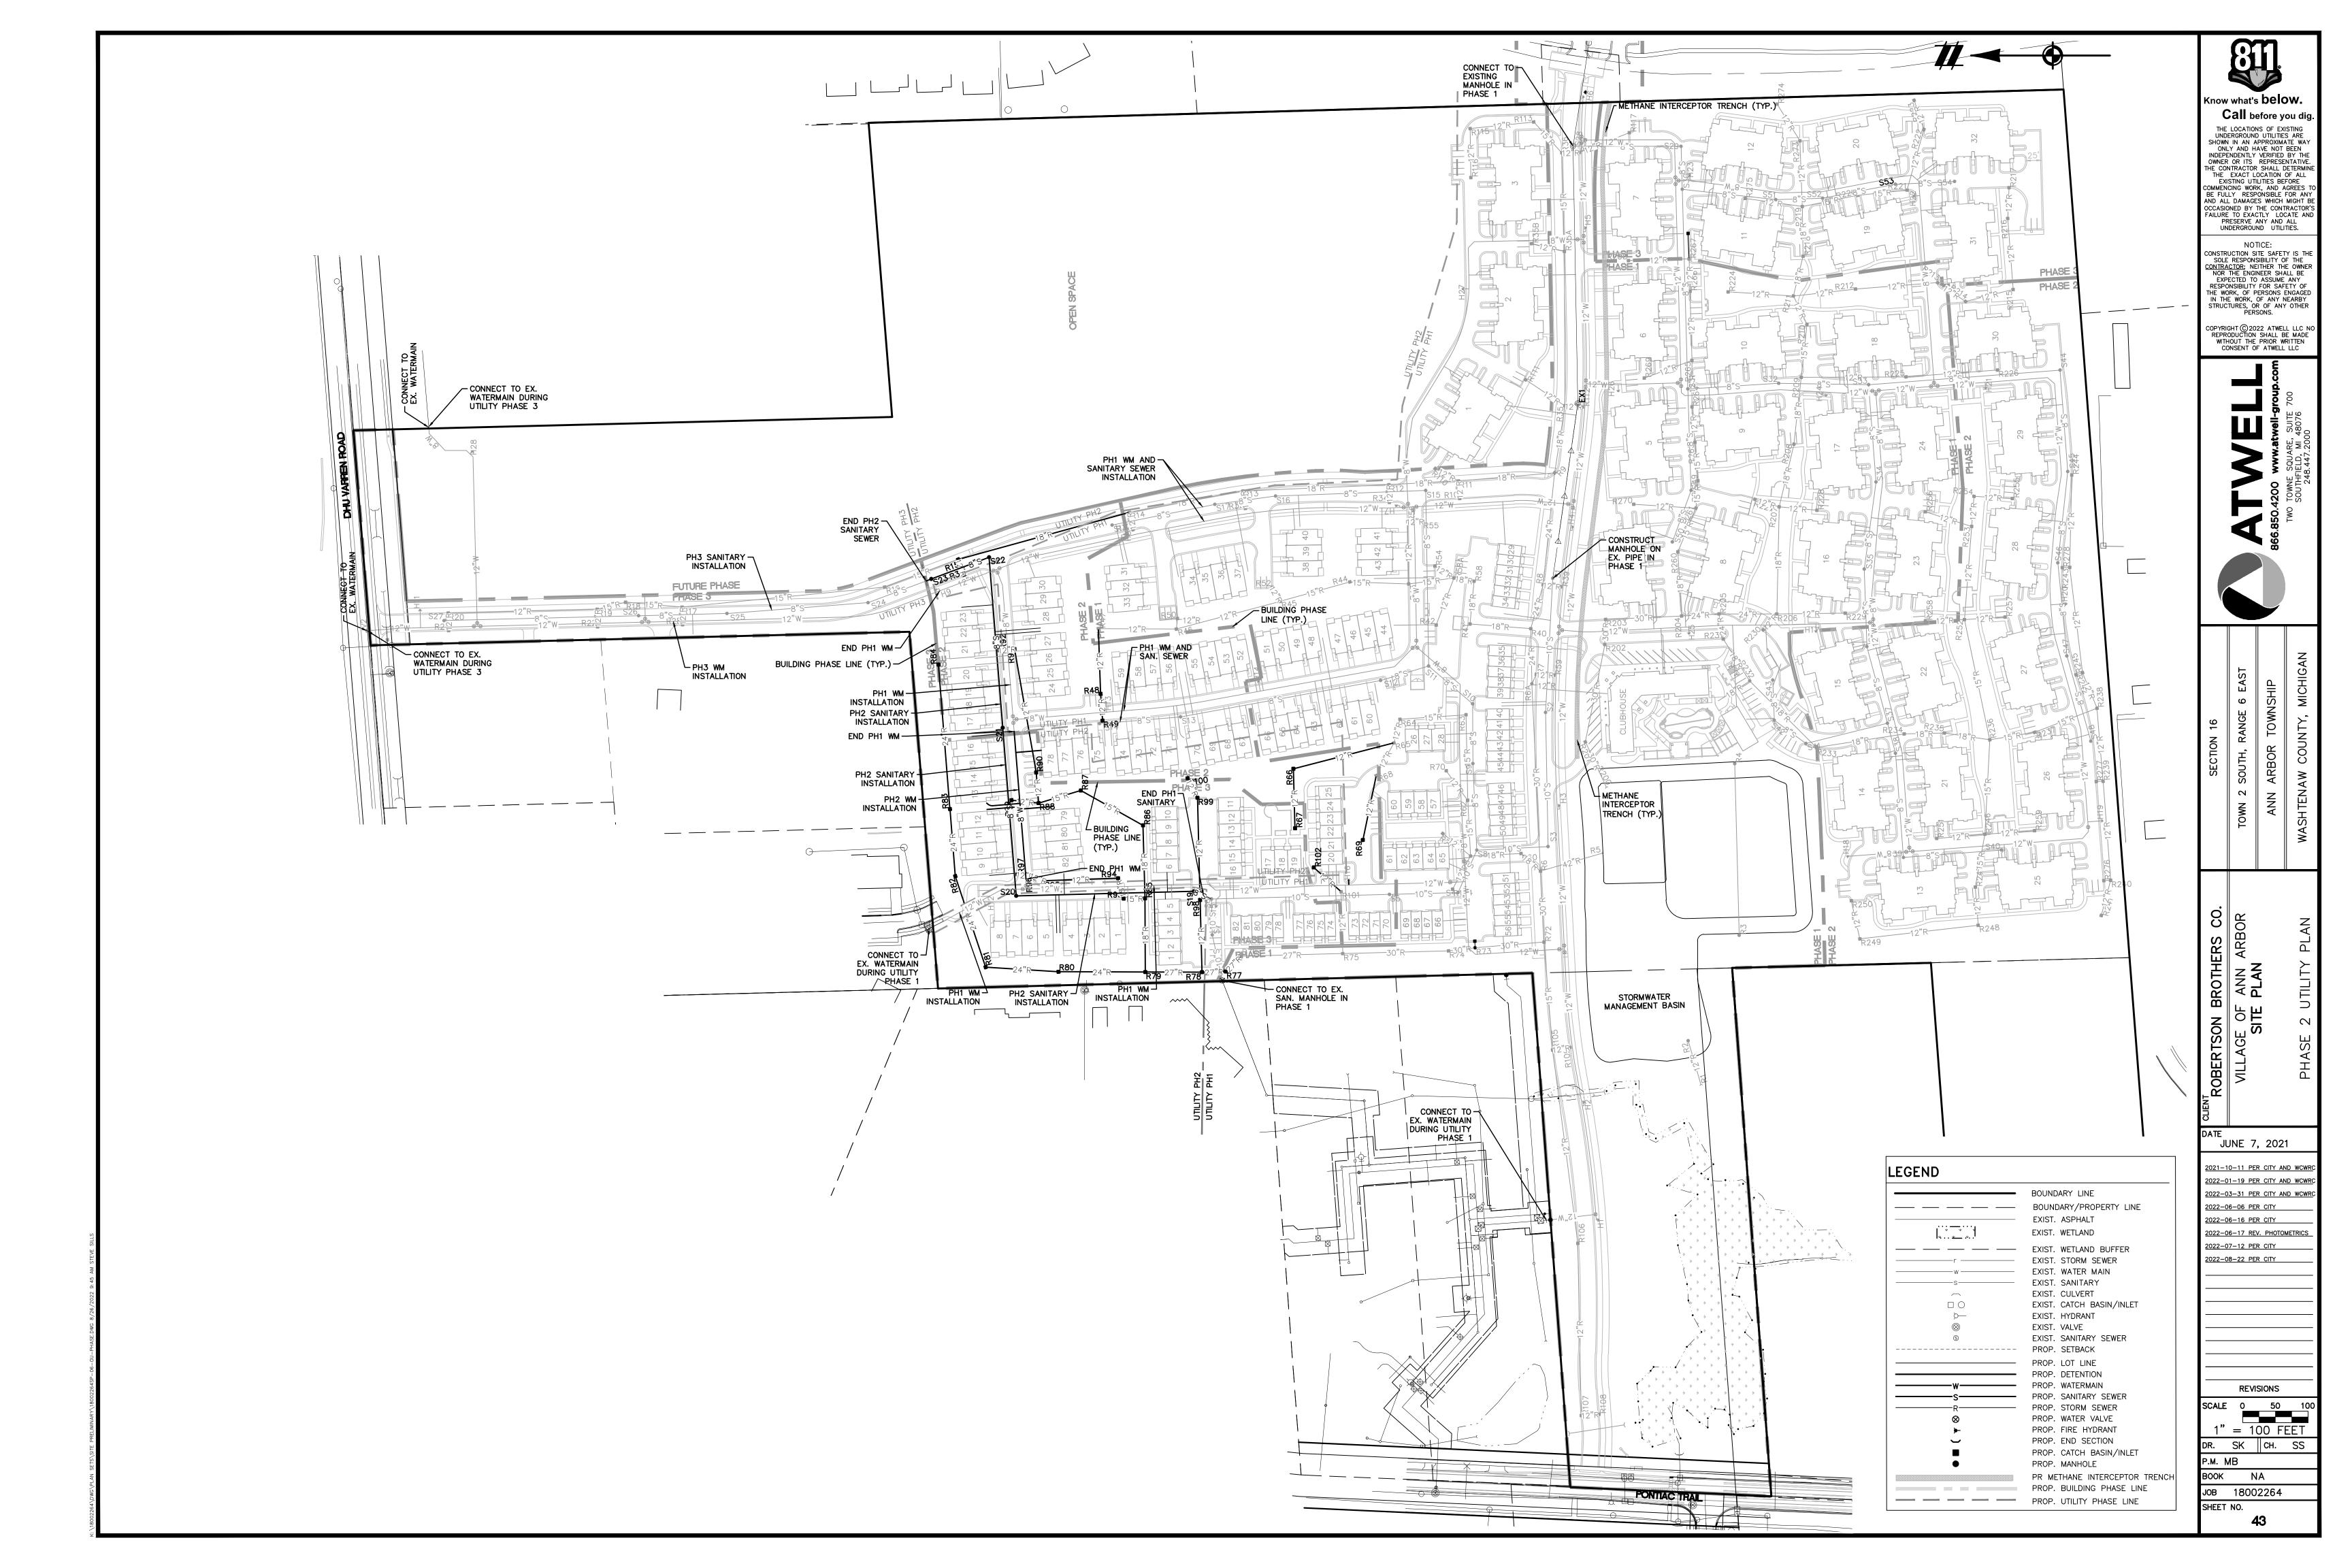


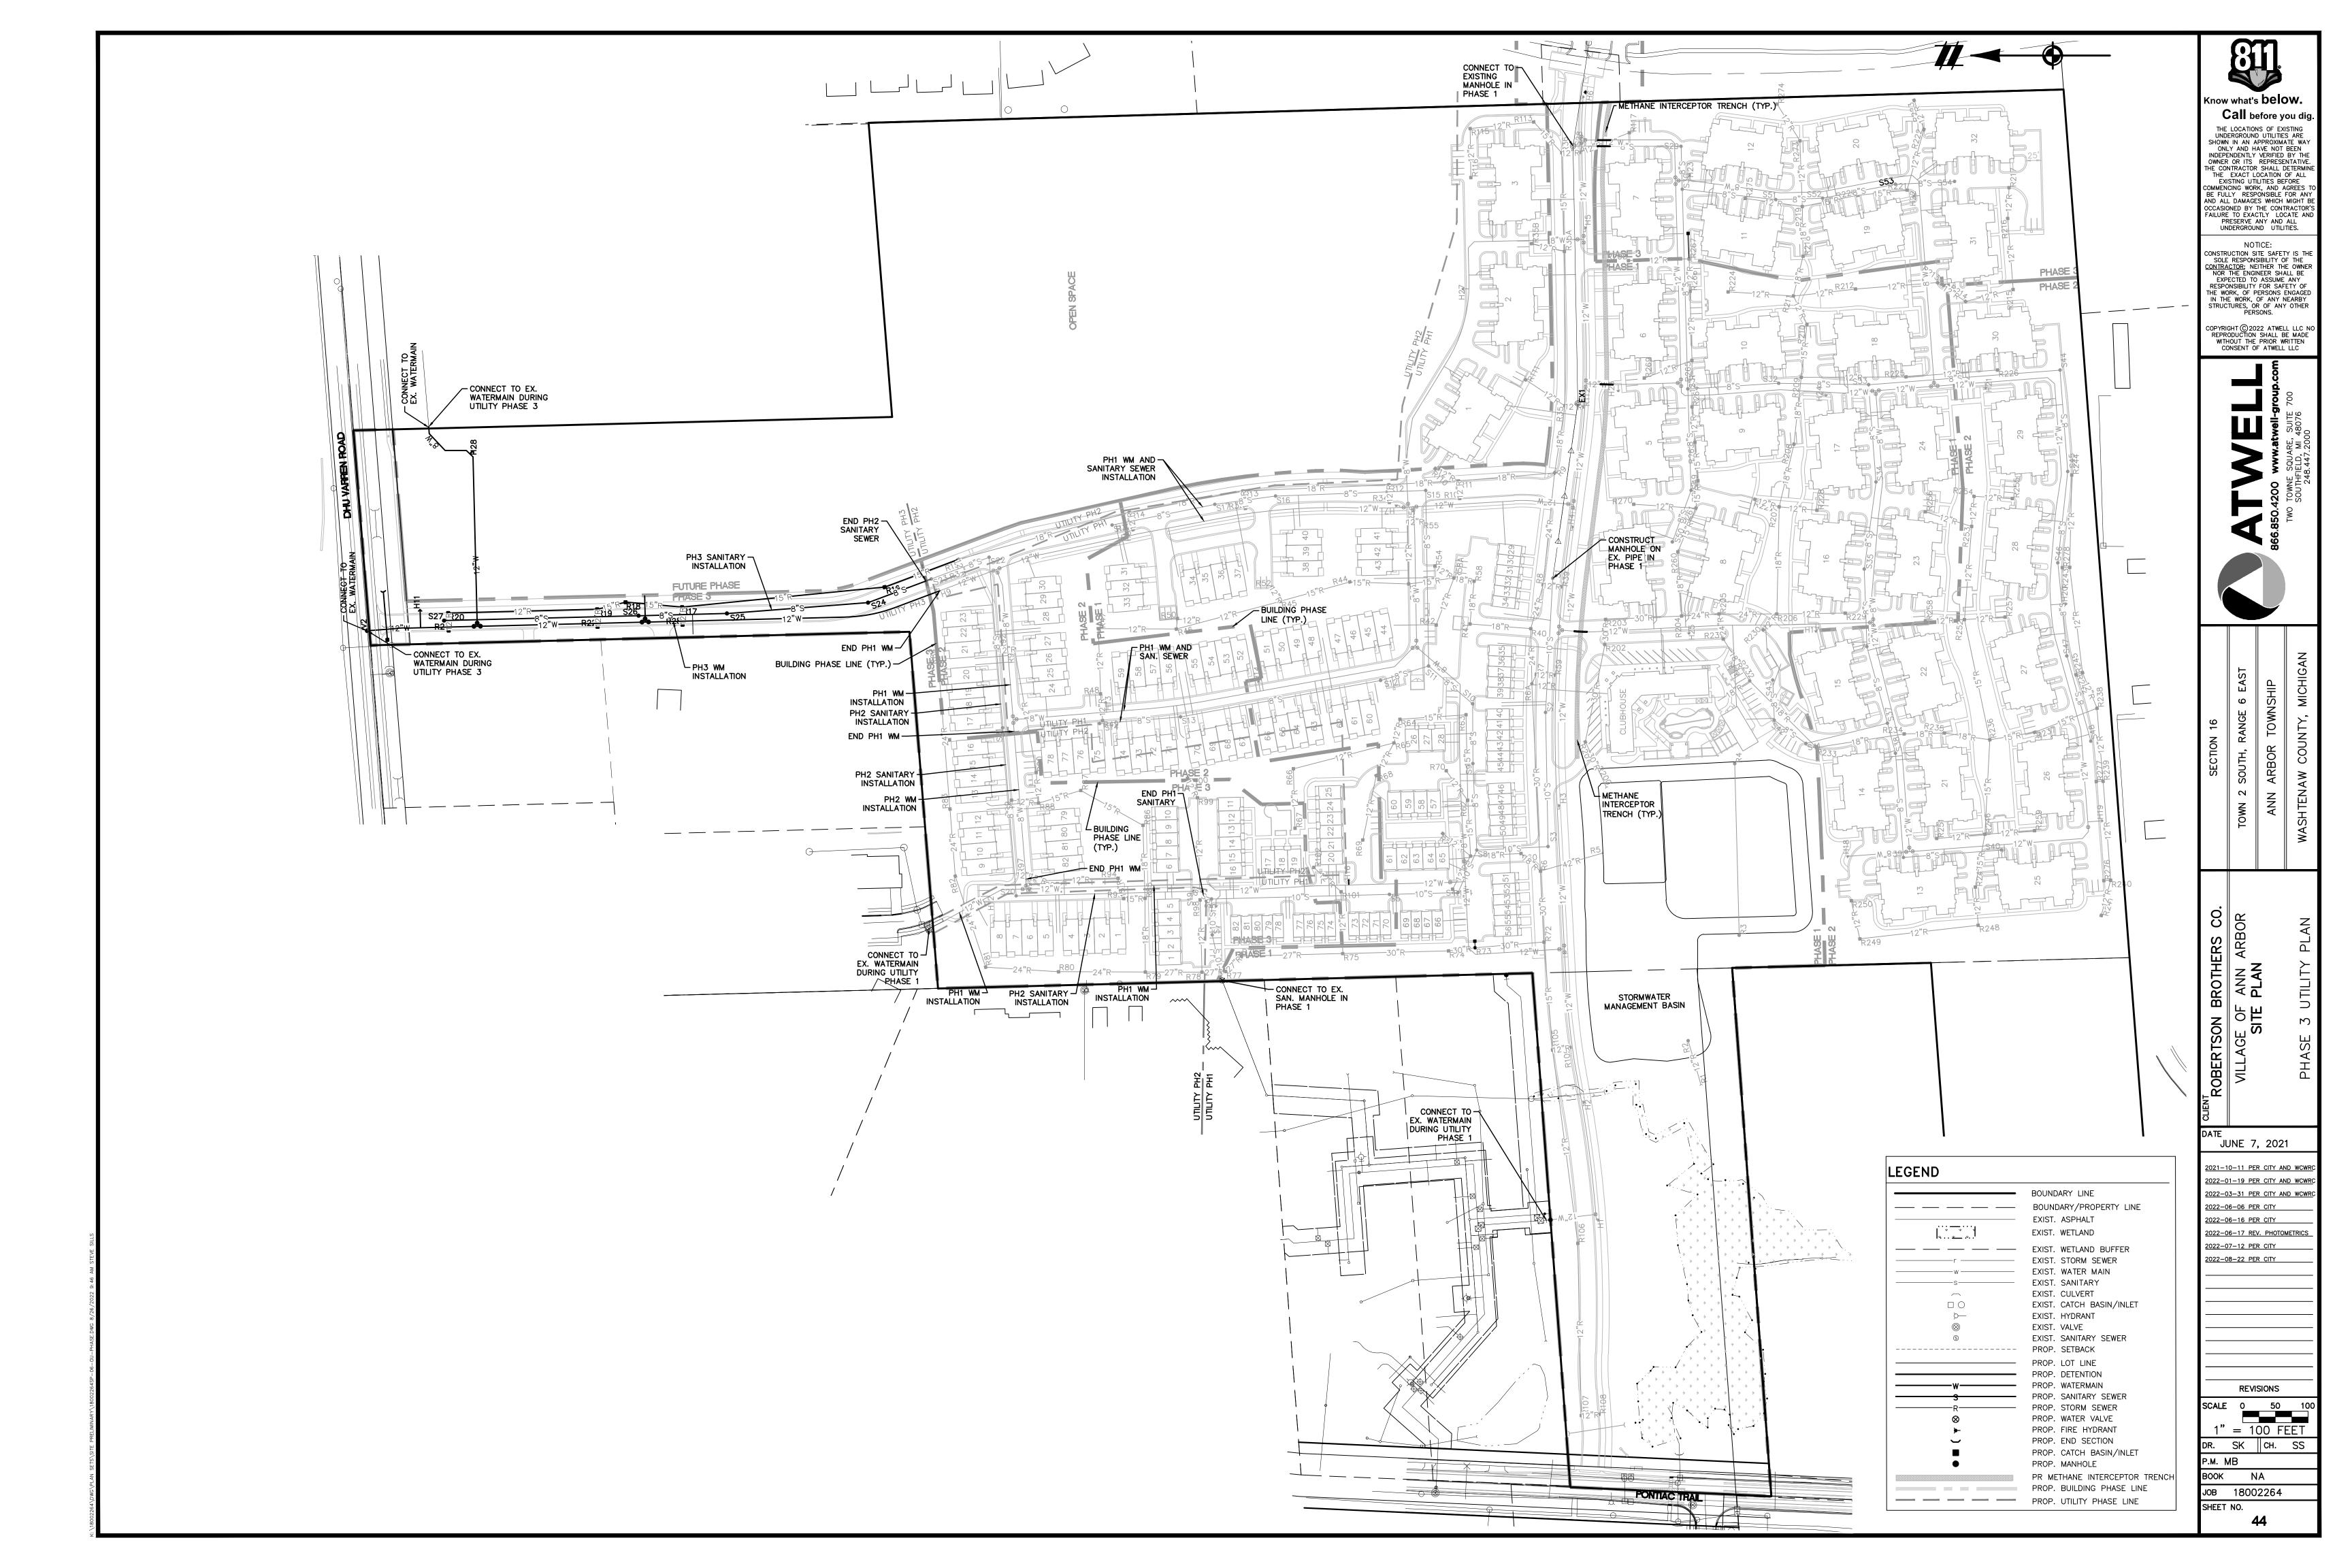

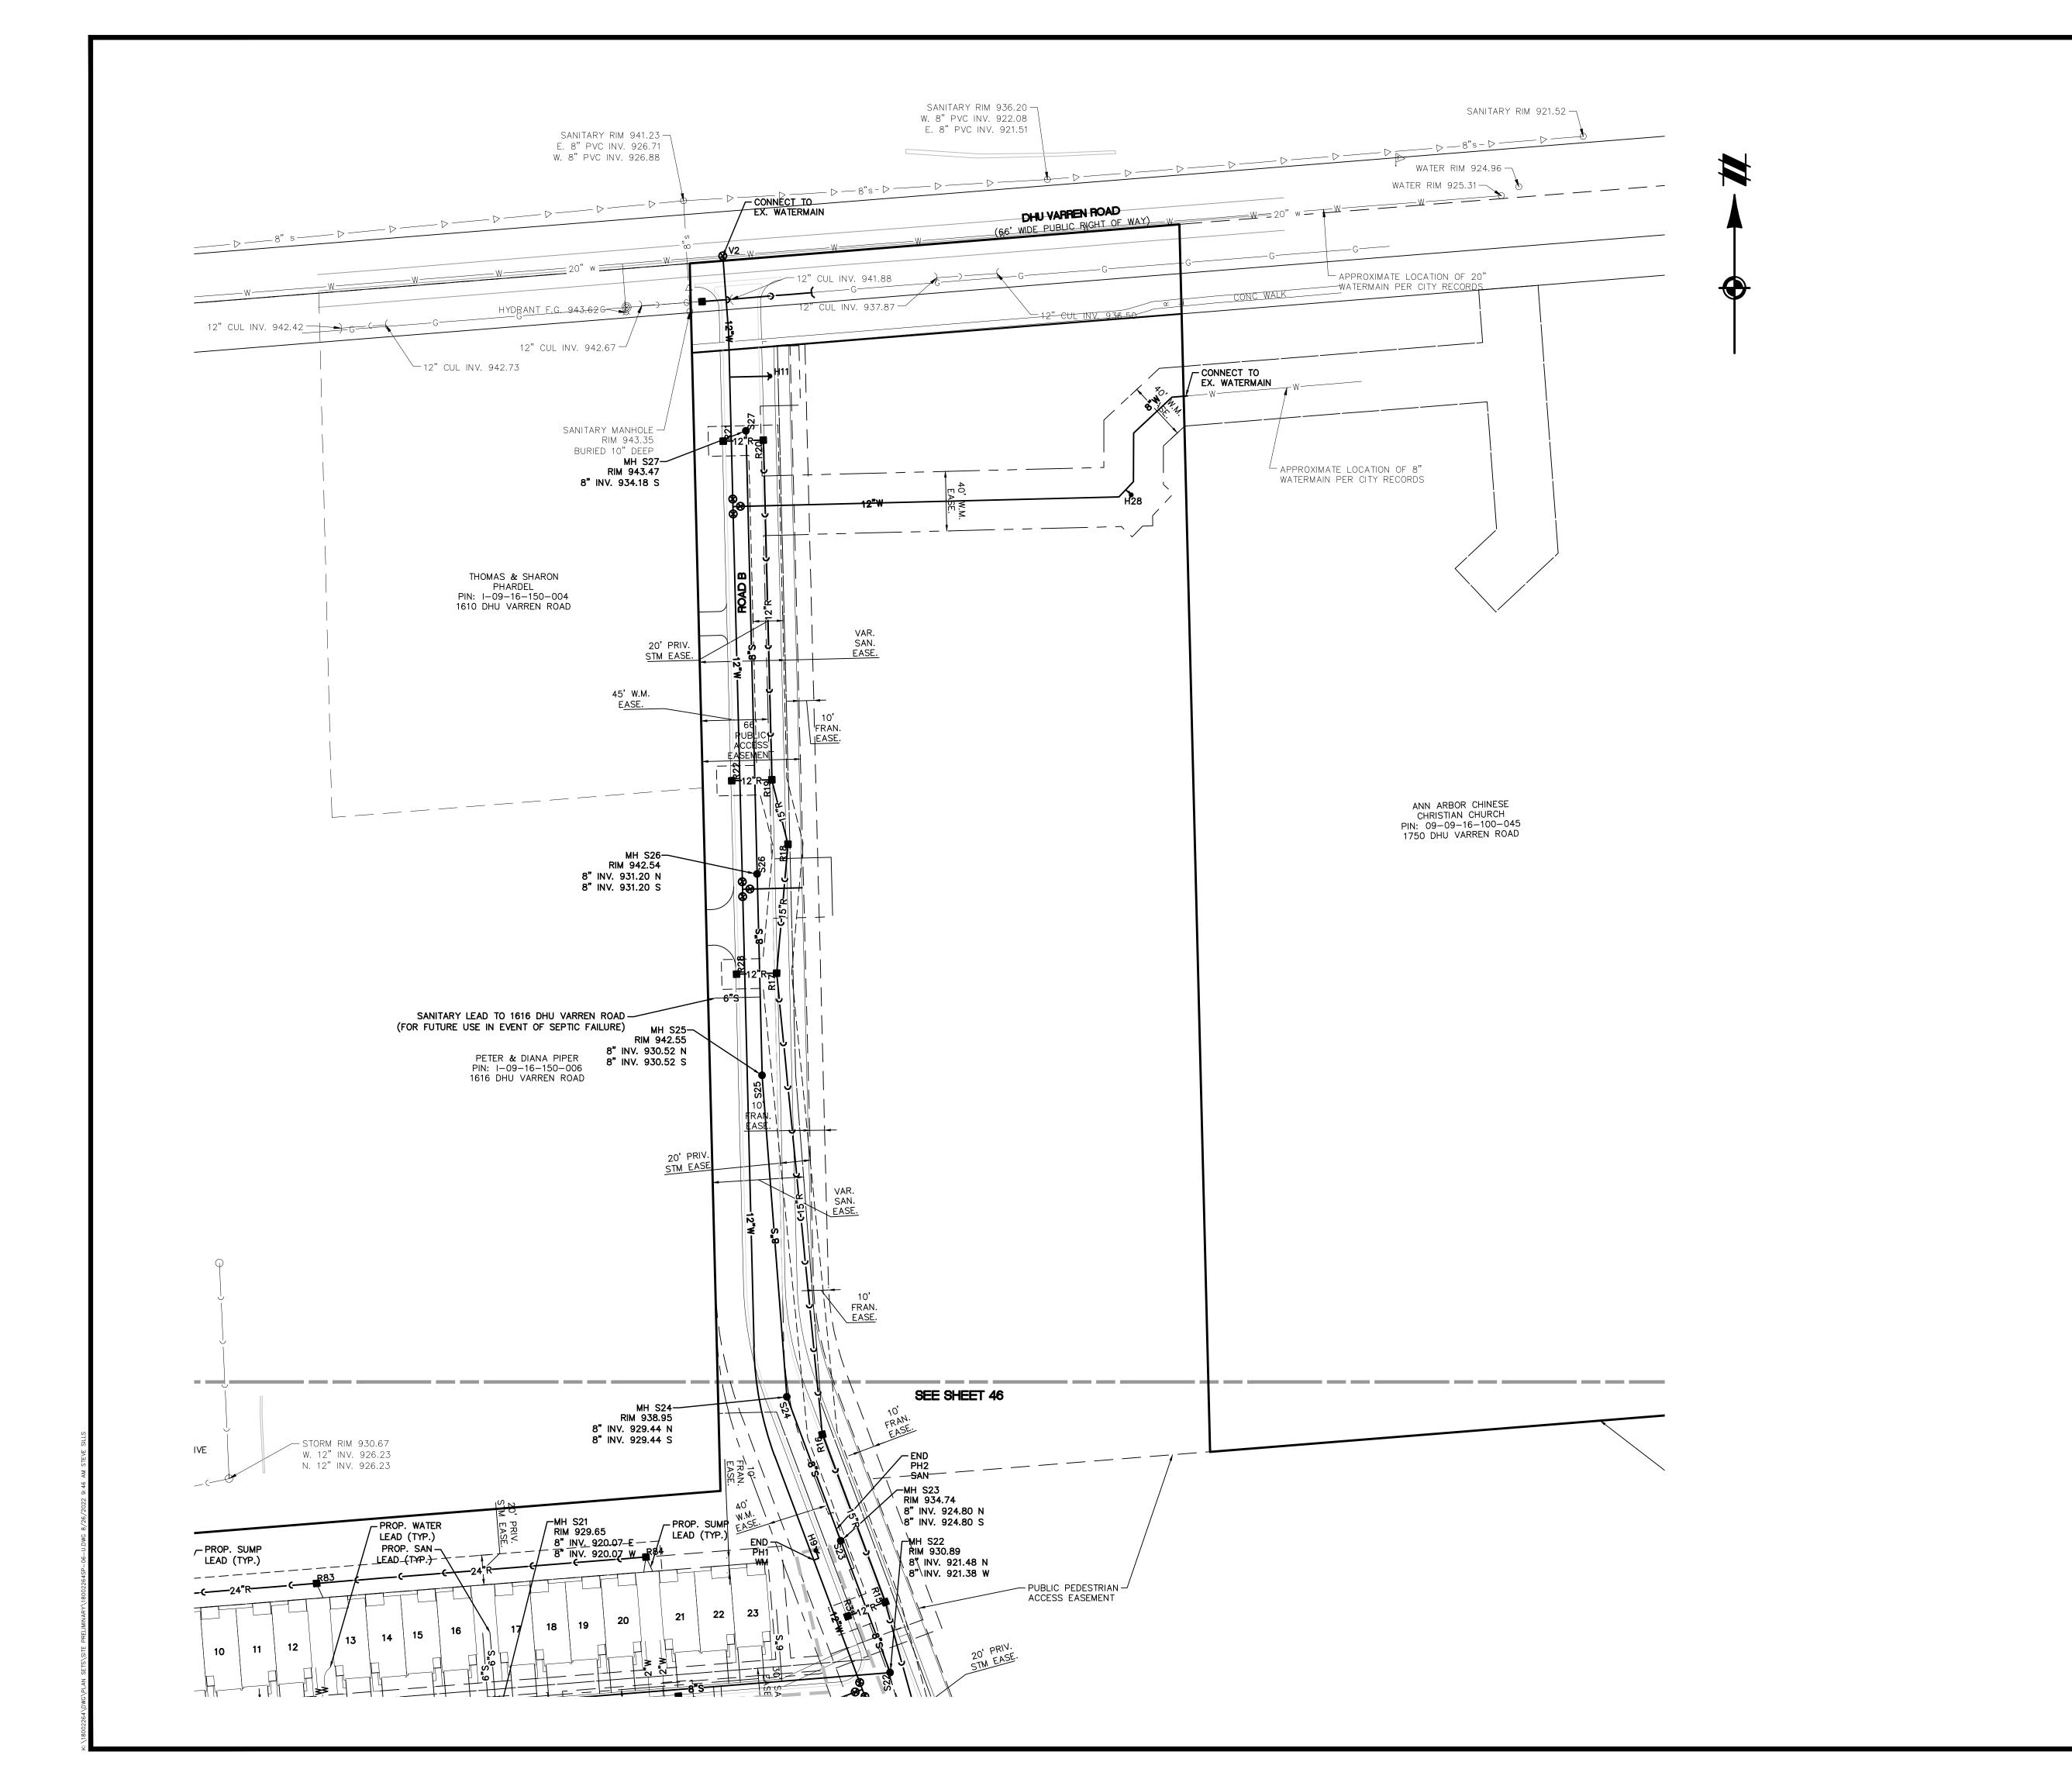

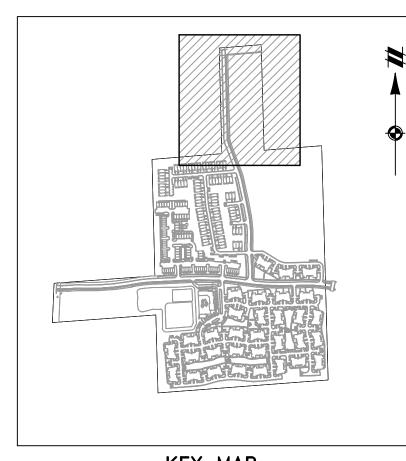

KEY MAP 1" = 750 FEET

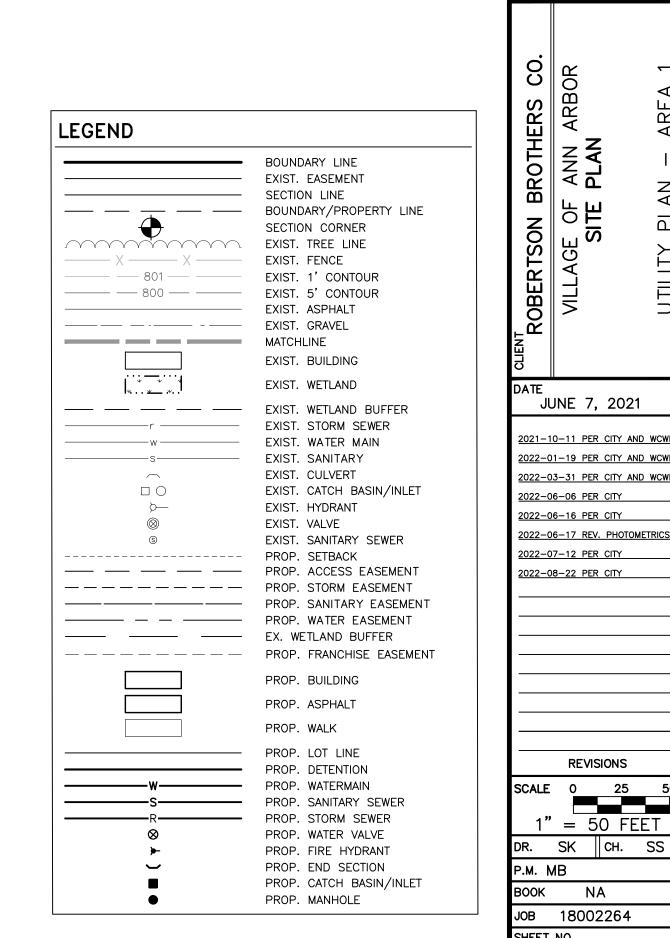

Know what's **below.**

Call before you dig. THE LOCATIONS OF EXISTING UNDERGROUND UTILITIES ARE SHOWN IN AN APPROXIMATE WAY ONLY AND HAVE NOT BEEN INDEPENDENTLY VERIFIED BY THE OWNER OR ITS REPRESENTATIVE. THE CONTRACTOR SHALL DETERMINE THE EXACT LOCATION OF ALL EXISTING UTILITIES BEFORE COMMENCING WORK, AND AGREES TO BE FULLY RESPONSIBLE FOR ANY AND ALL DAMAGES WHICH MIGHT BE COCCASIONED BY THE CONTRACTOR'S FAILURE TO EXACTLY LOCATE AND PRESERVE ANY AND ALL UNDERGROUND UTILITIES.

NOTICE:

CONSTRUCTION SITE SAFETY IS THE SOLE RESPONSIBILITY OF THE CONTRACTOR; NEITHER THE OWNER NOR THE ENGINEER SHALL BE EXPECTED TO ASSUME ANY RESPONSIBILITY FOR SAFETY OF THE WORK, OF PERSONS ENGAGED IN THE WORK, OF ANY NEARBY STRUCTURES, OR OF ANY OTHER PERSONS.

COPYRIGHT © 2022 ATWELL LLC NO REPRODUCTION SHALL BE MADE WITHOUT THE PRIOR WRITTEN CONSENT OF ATWELL LLC

JUNE 7, 2021 2021-10-11 PER CITY AND WCWR


2022-03-31 PER CITY AND WCWR 2022-06-06 PER CITY 2022-06-16 PER CITY


2022-06-17 REV. PHOTOMETRICS 2022-07-12 PER CITY 2022-08-22 PER CITY


REVISIONS 1" = 50 FEET


DR. SK CH. SS


P.M. MB BOOK NA JOB 18002264 SHEET NO.

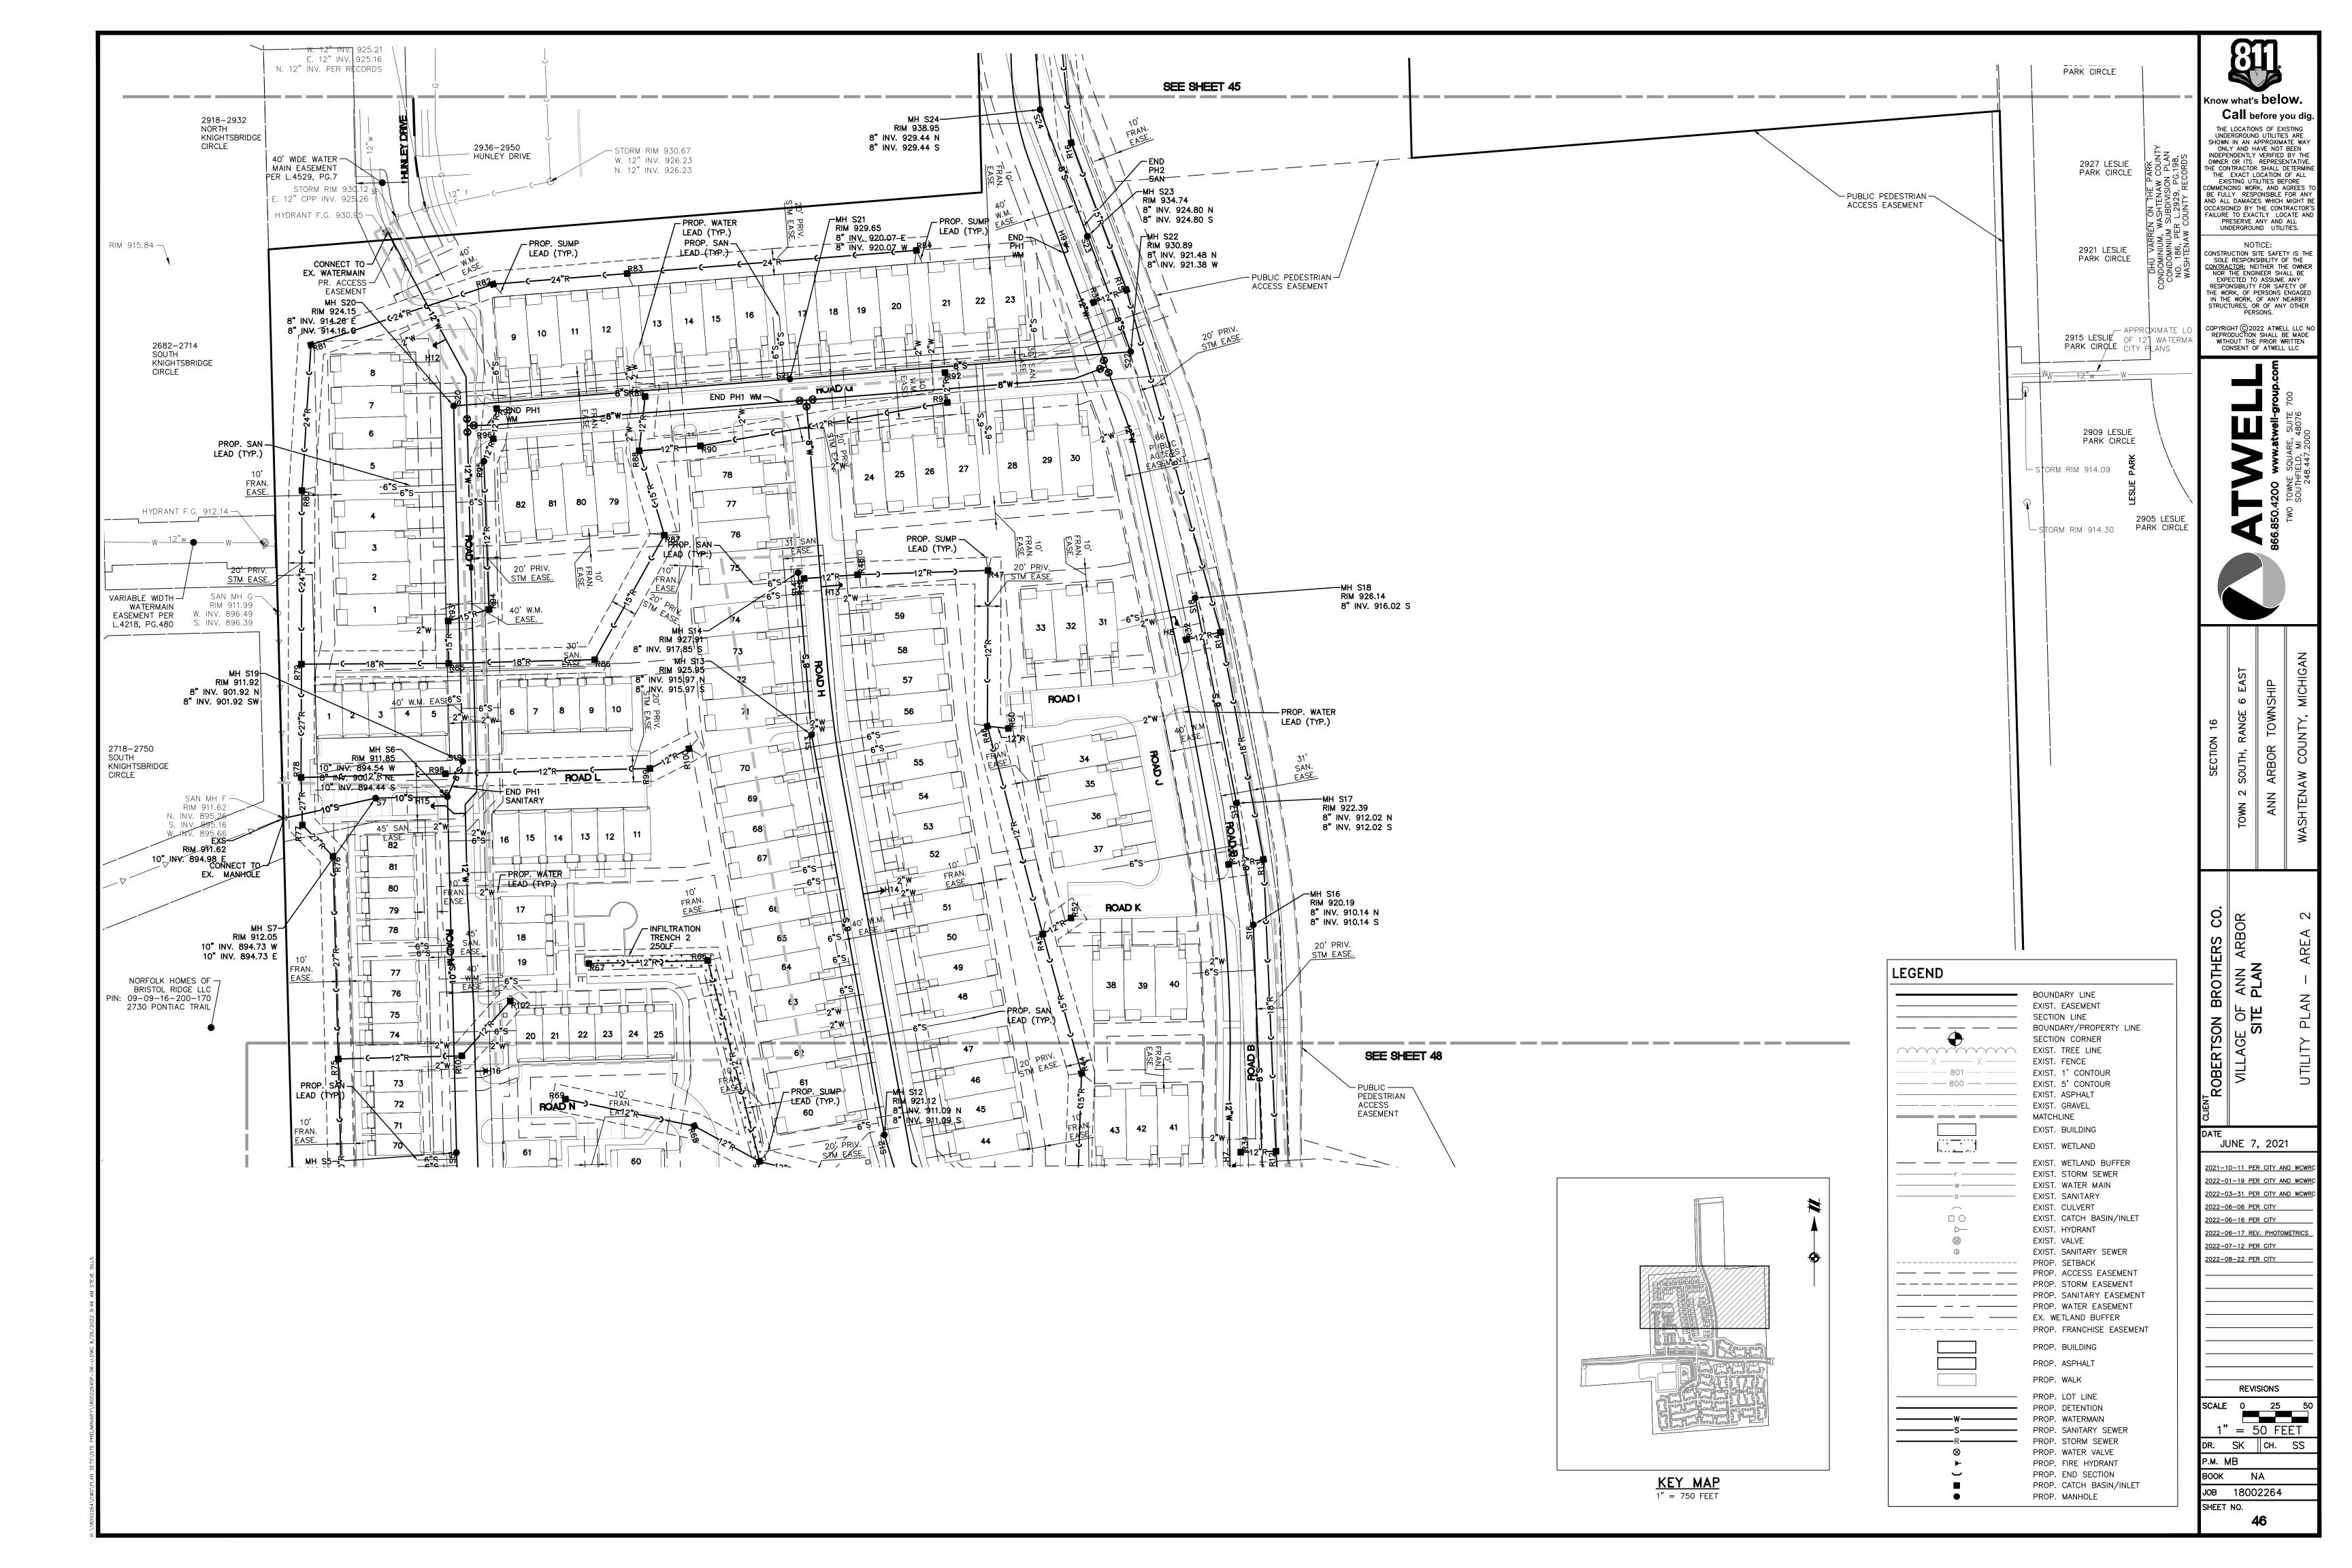


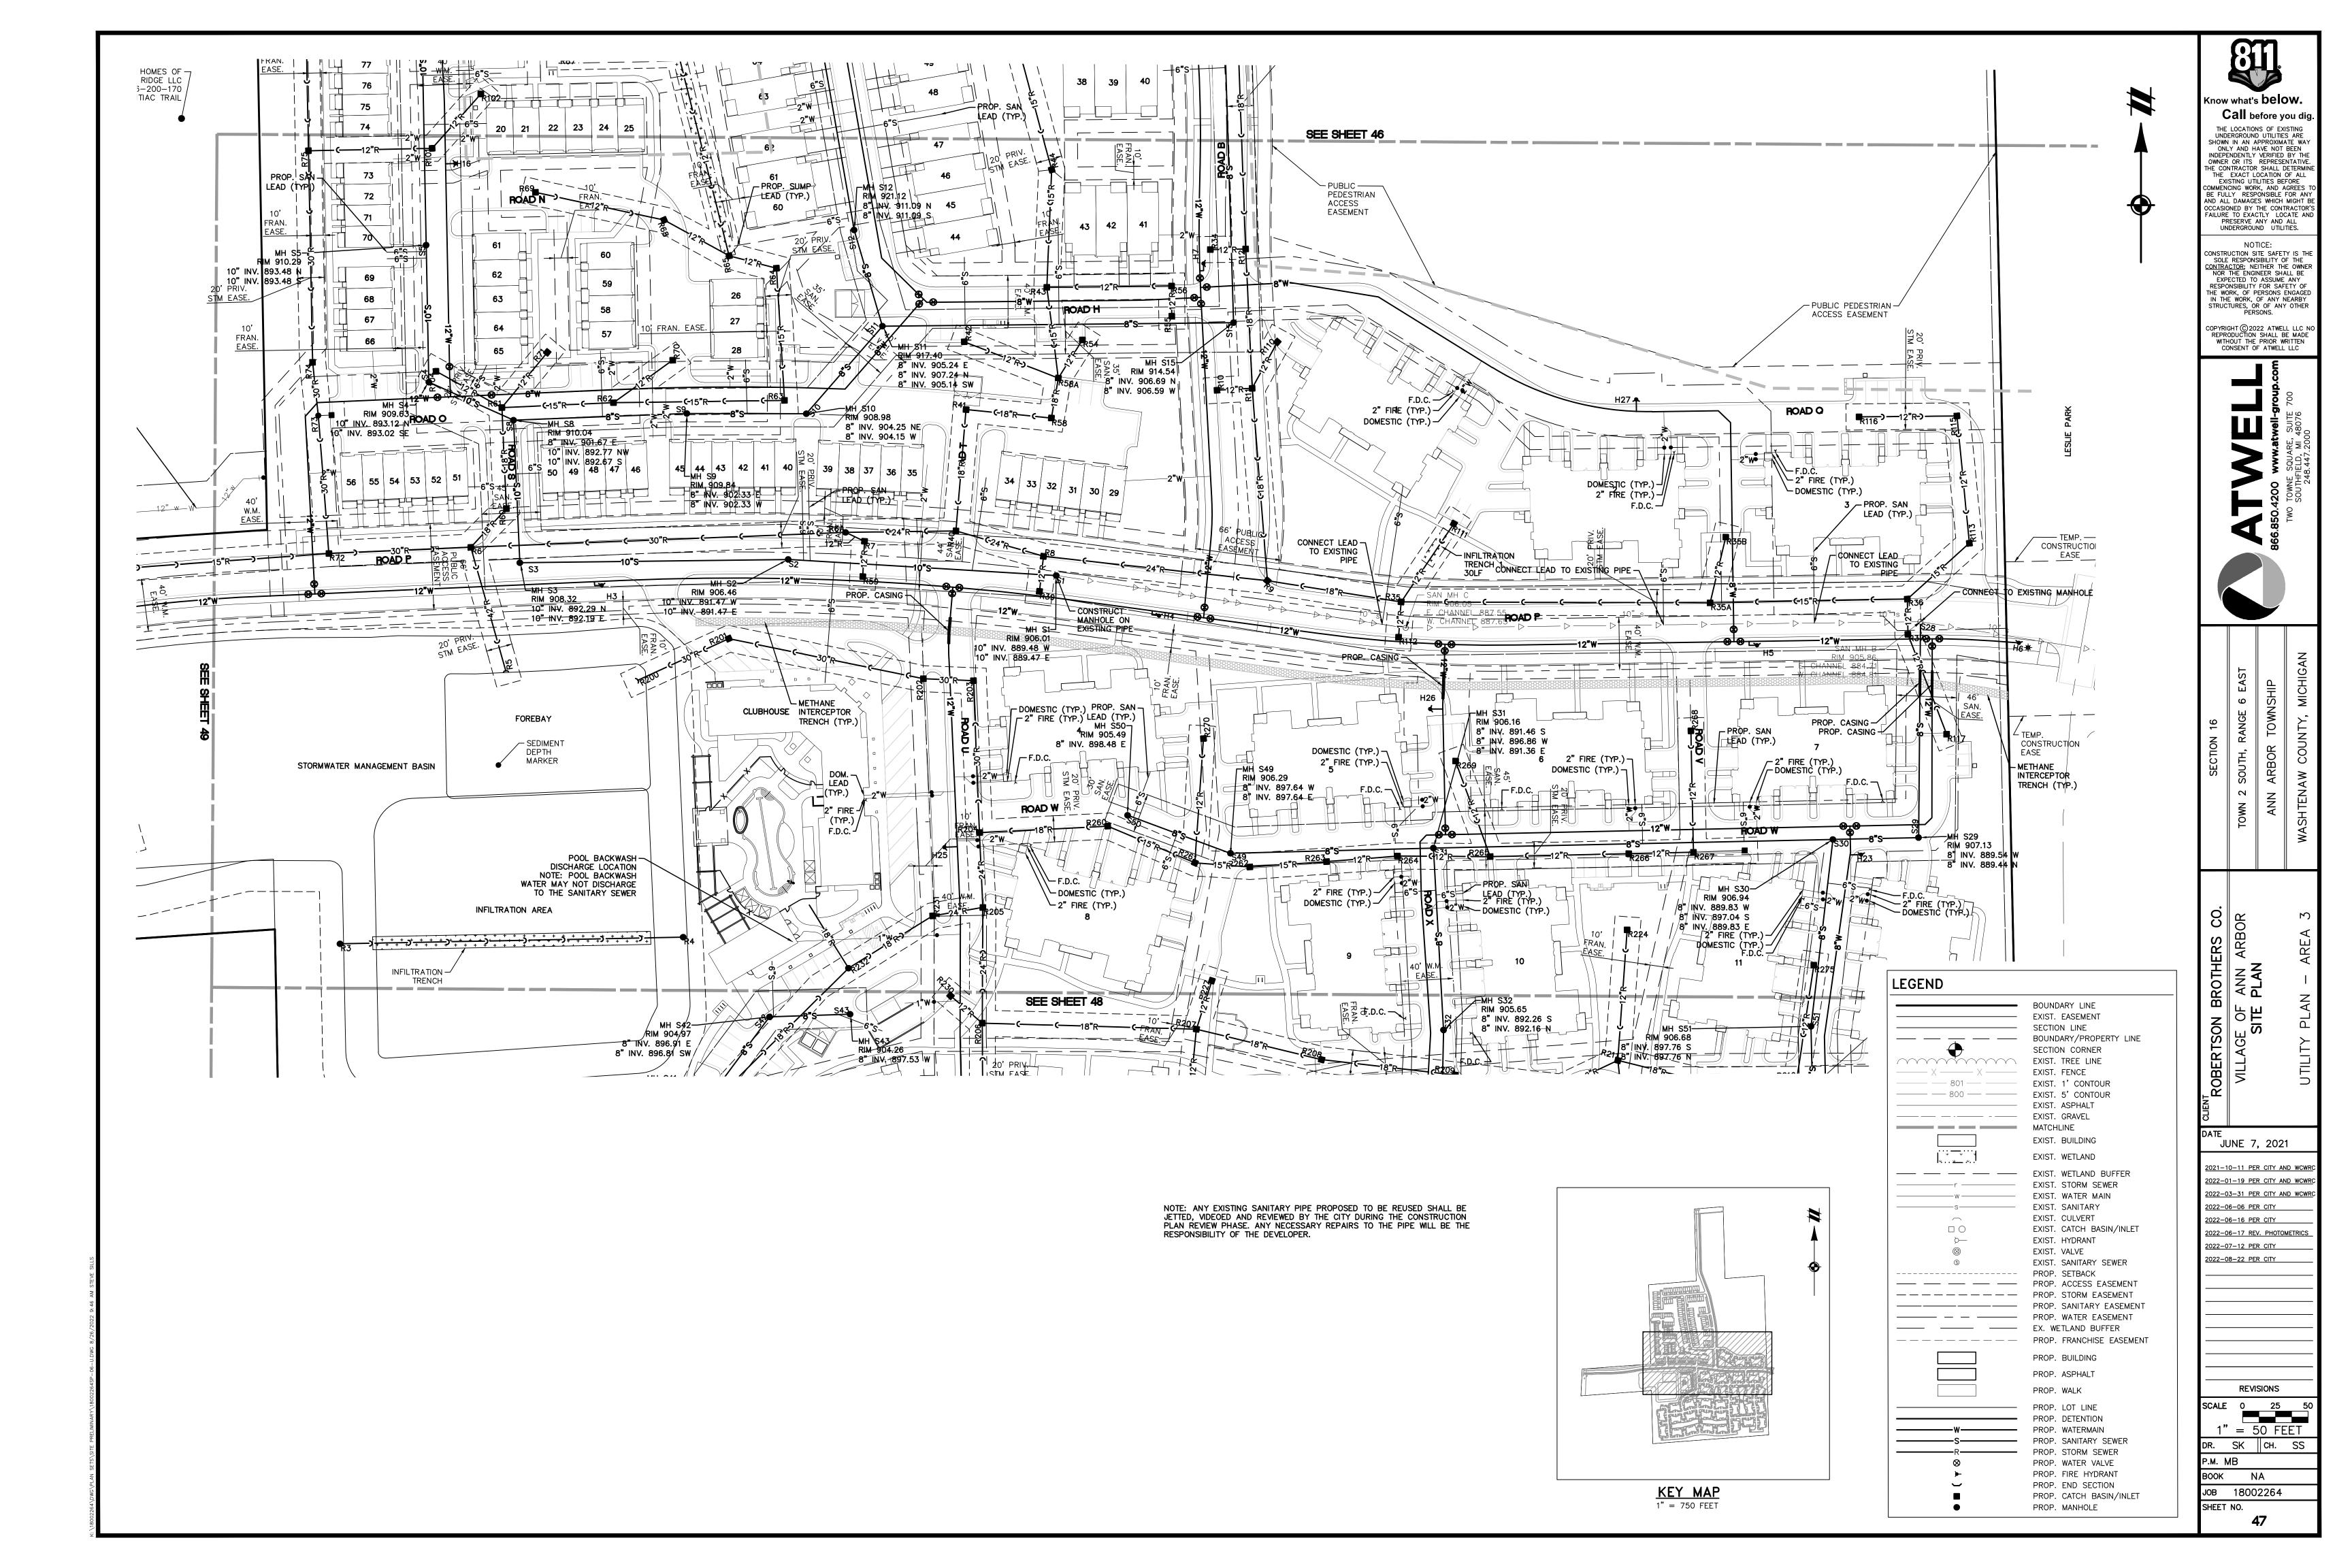


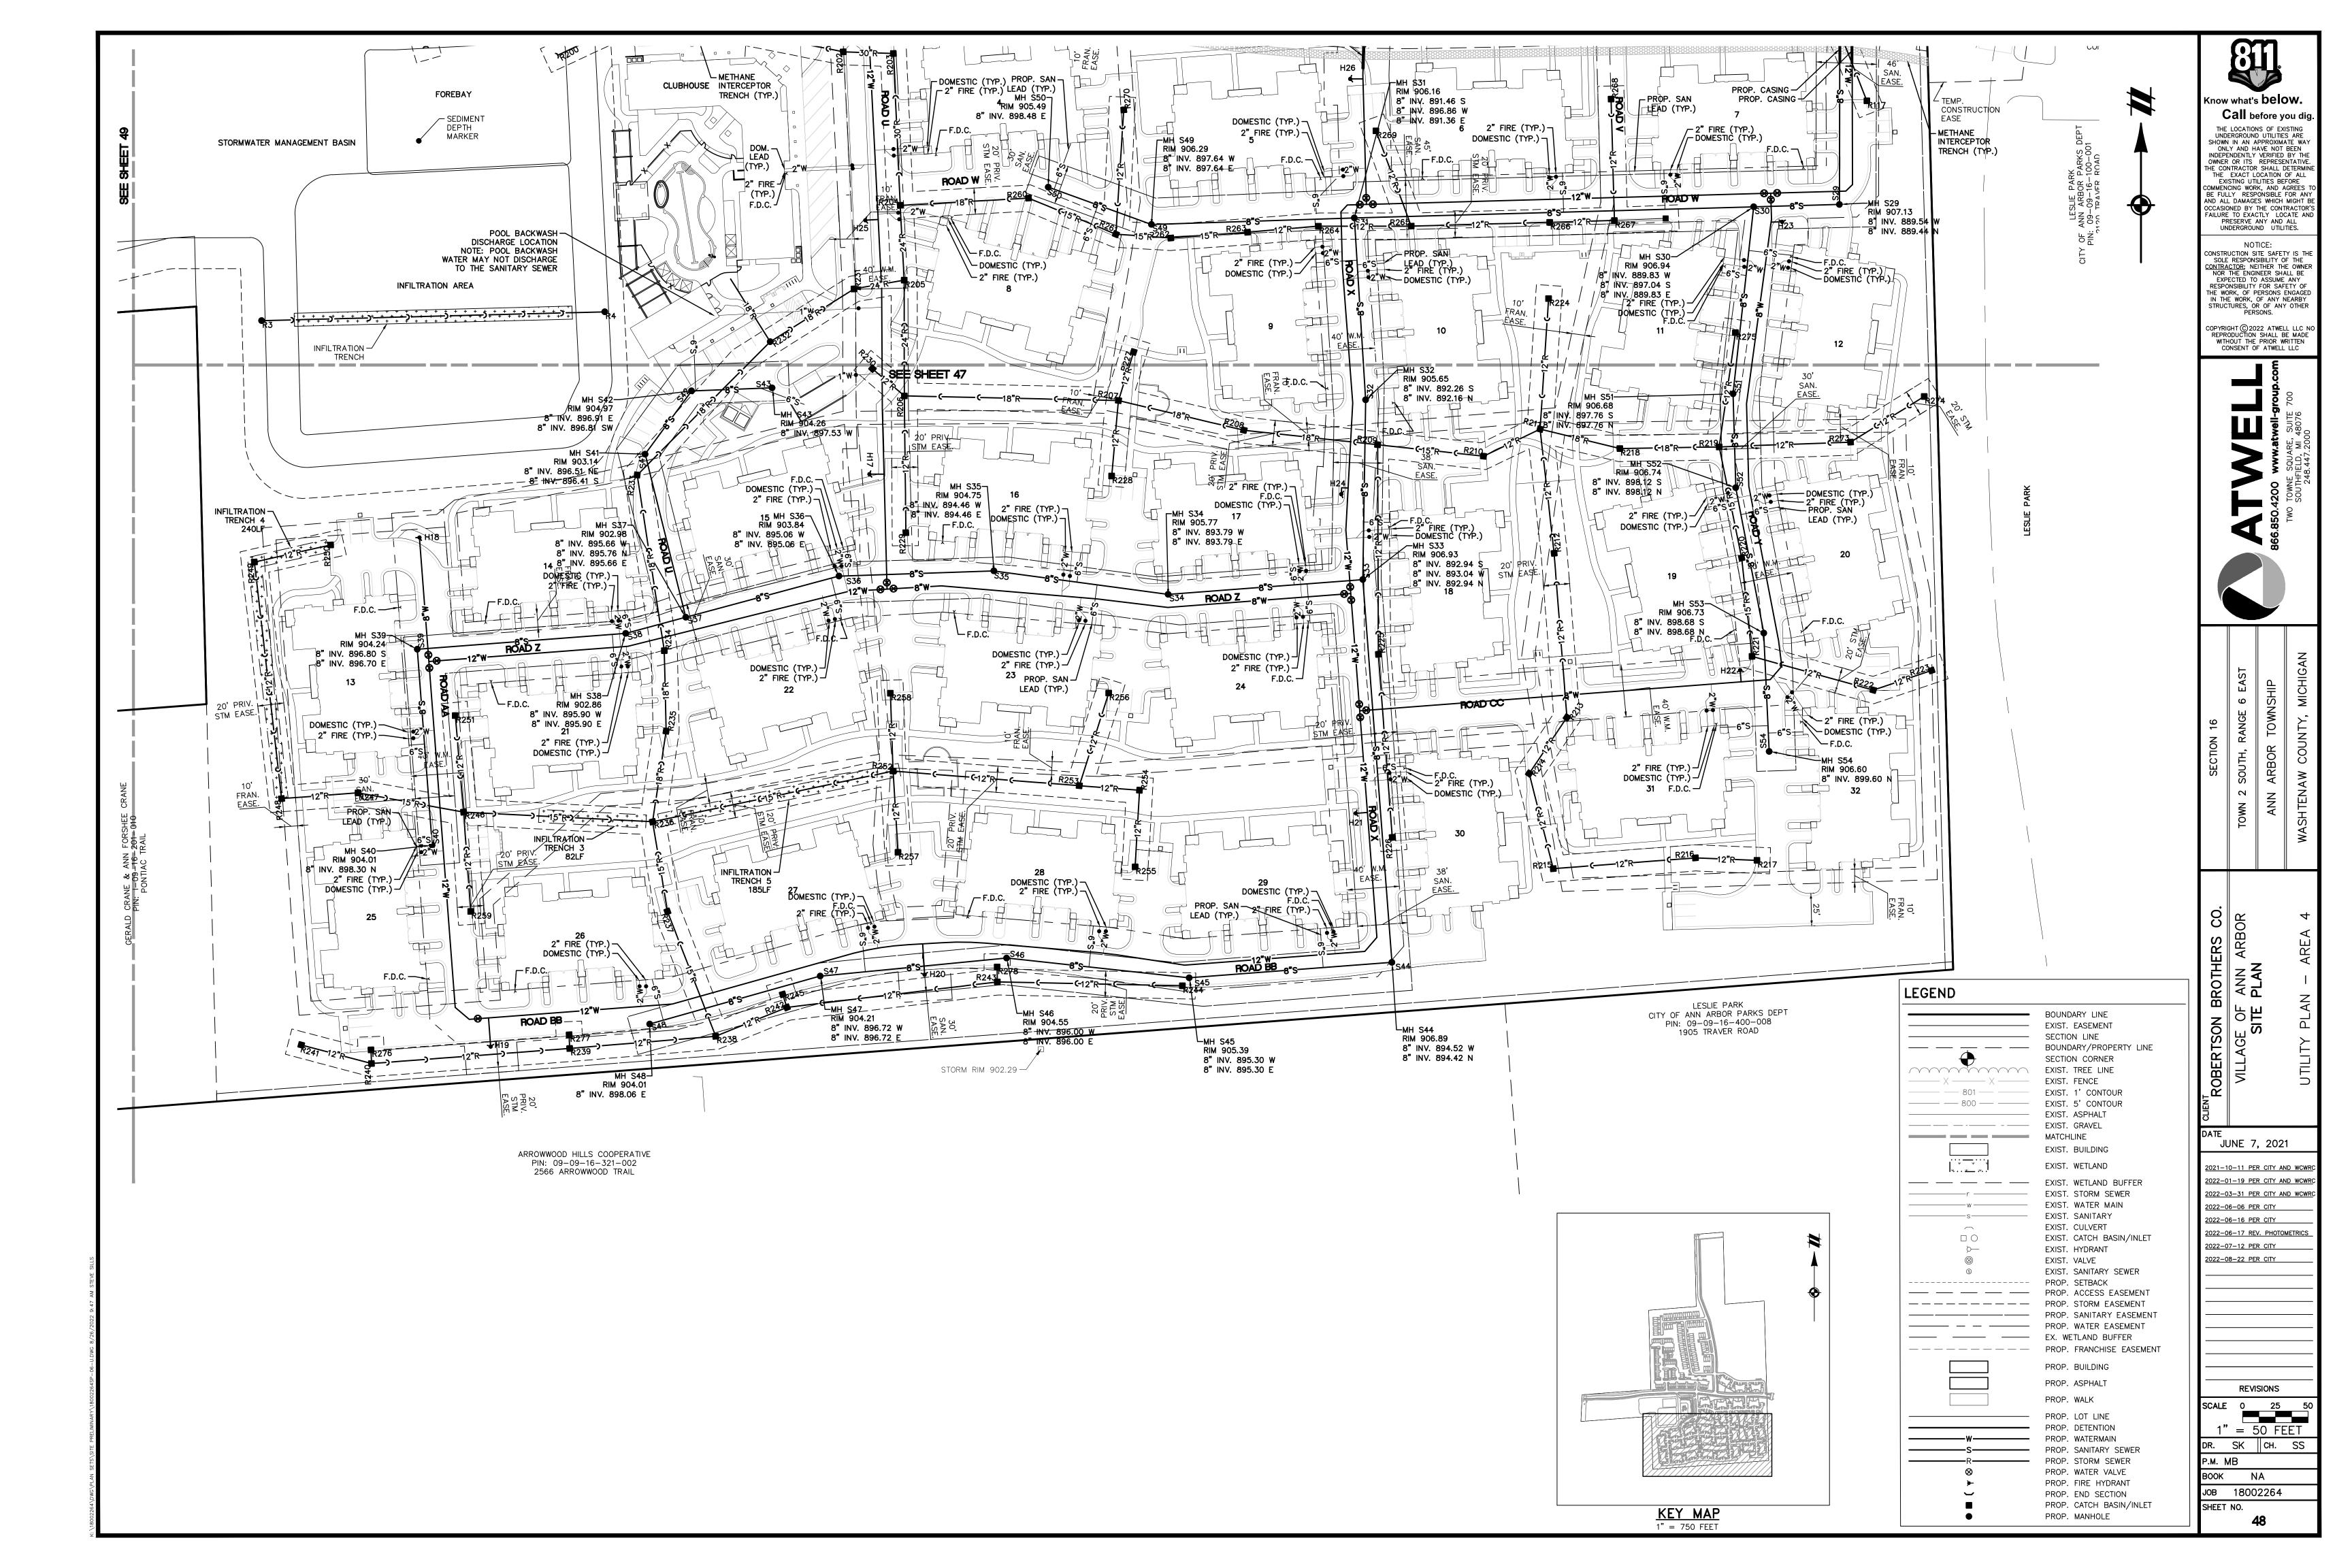


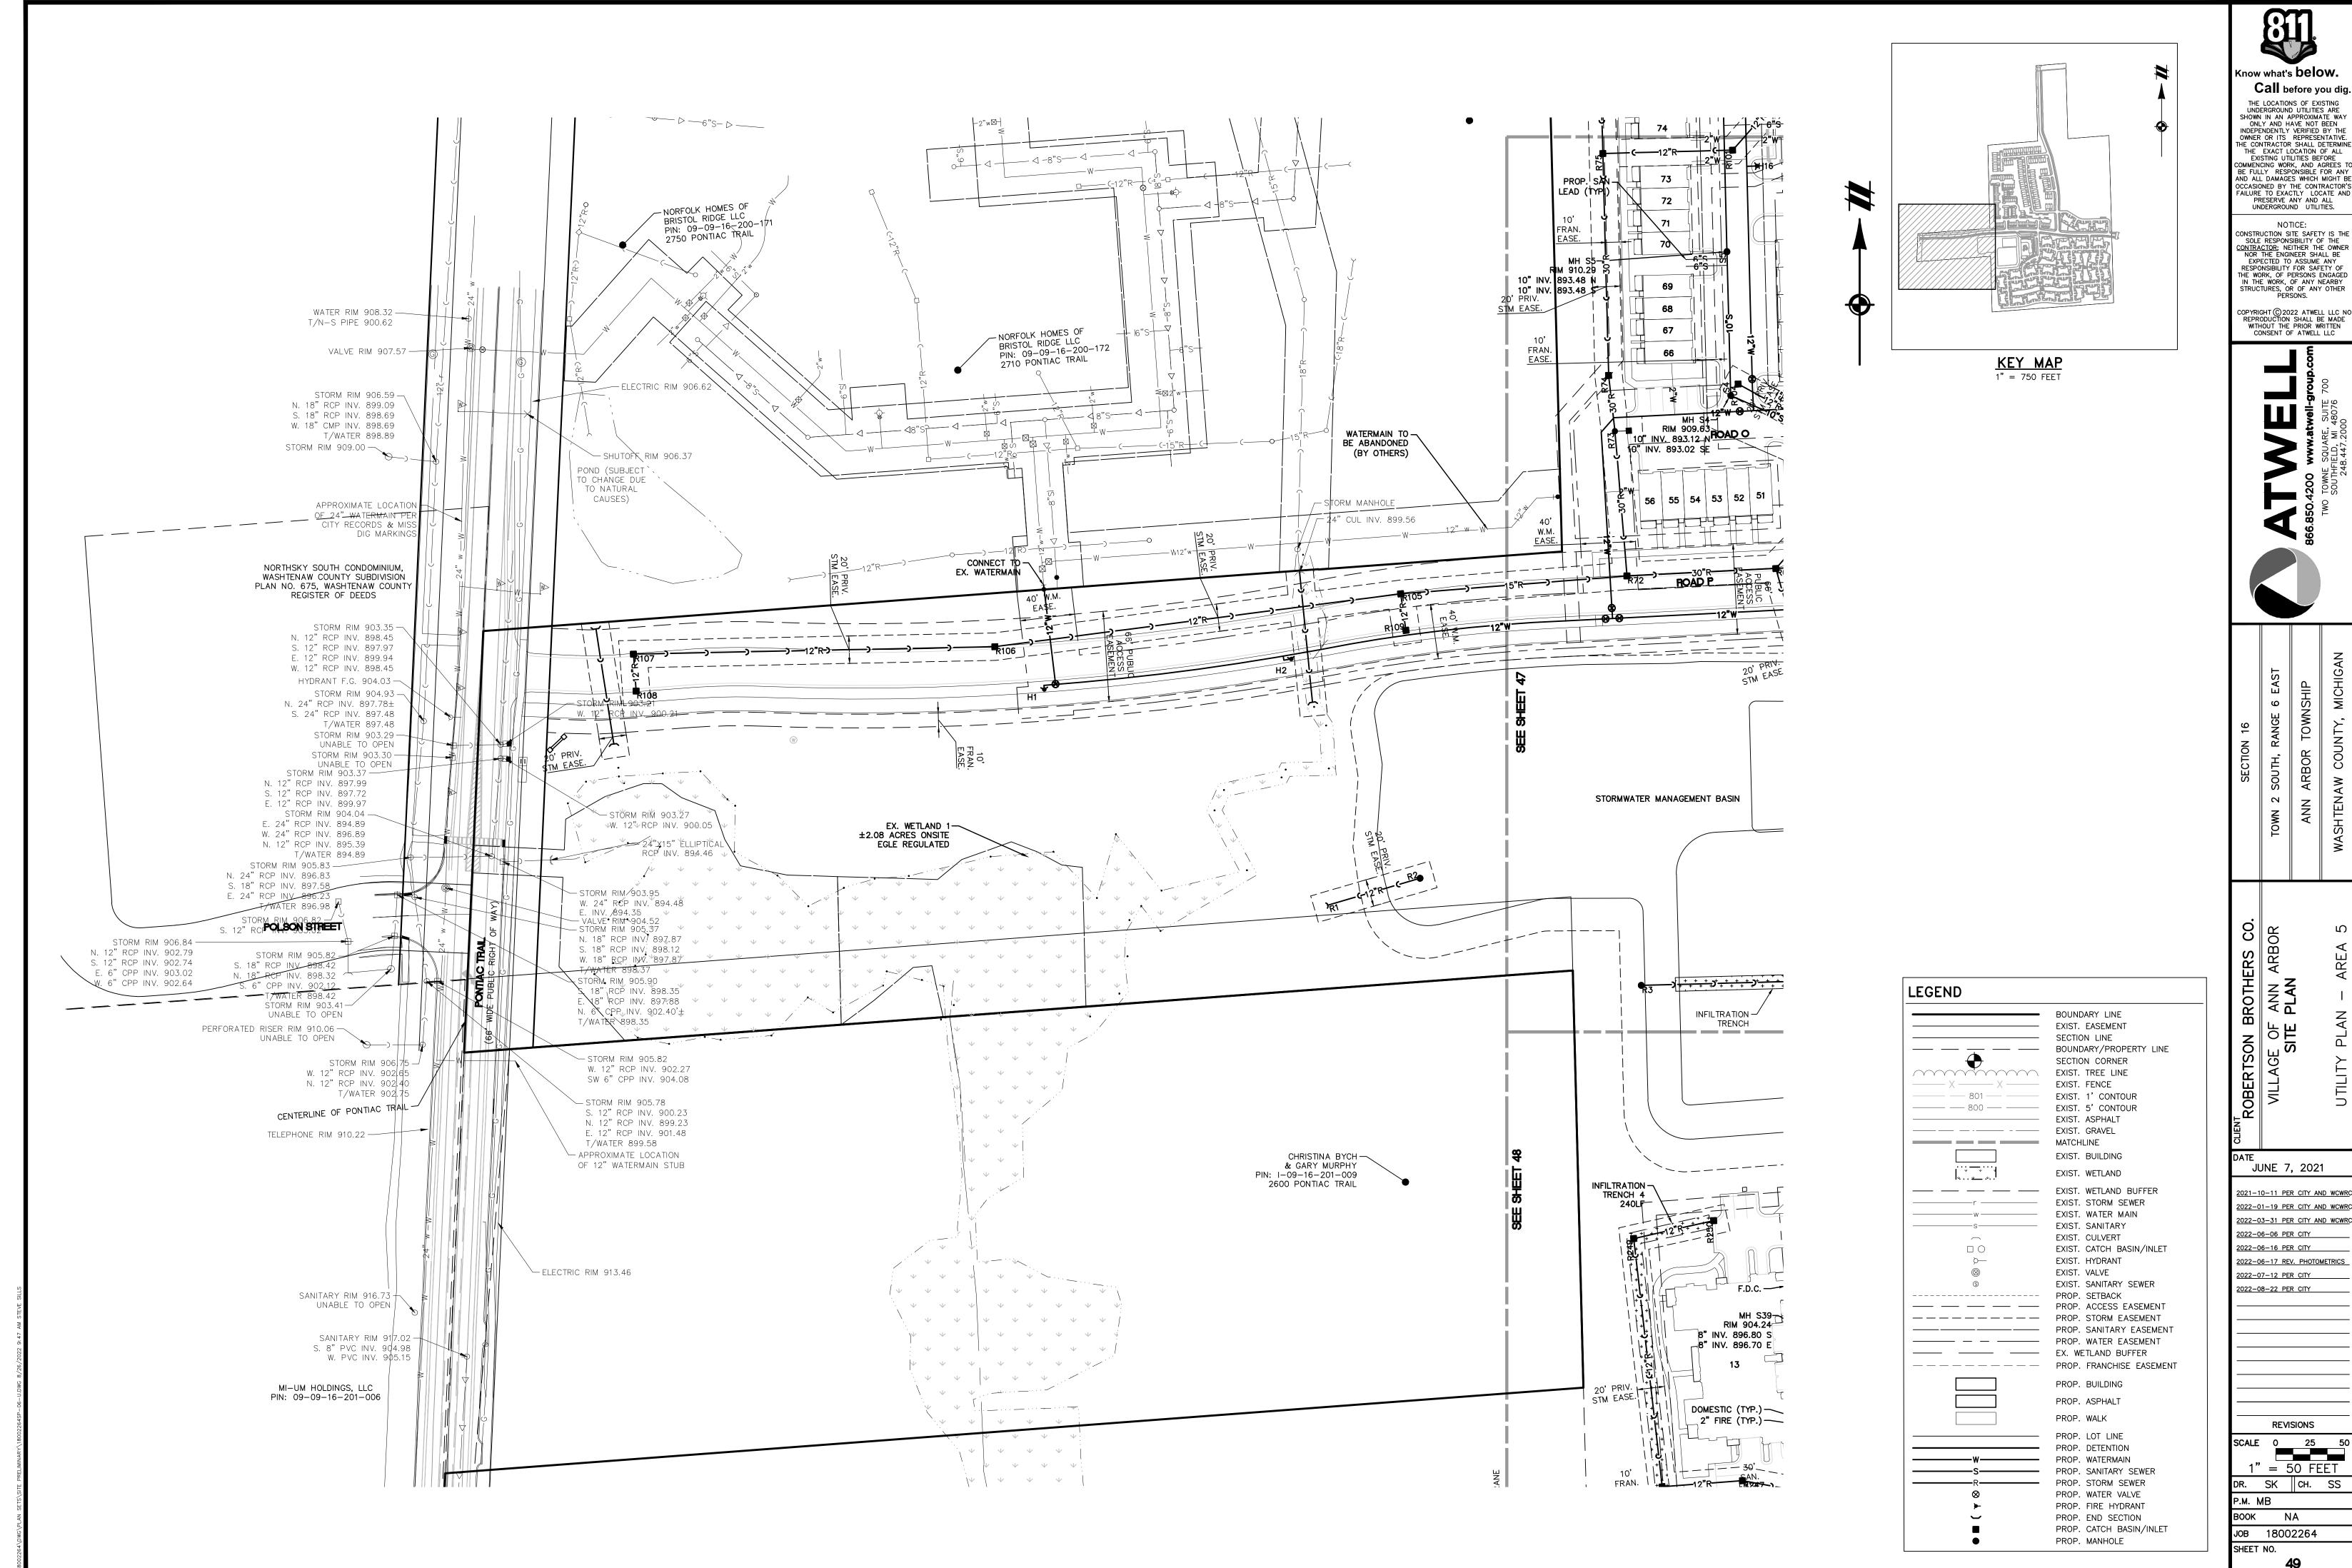

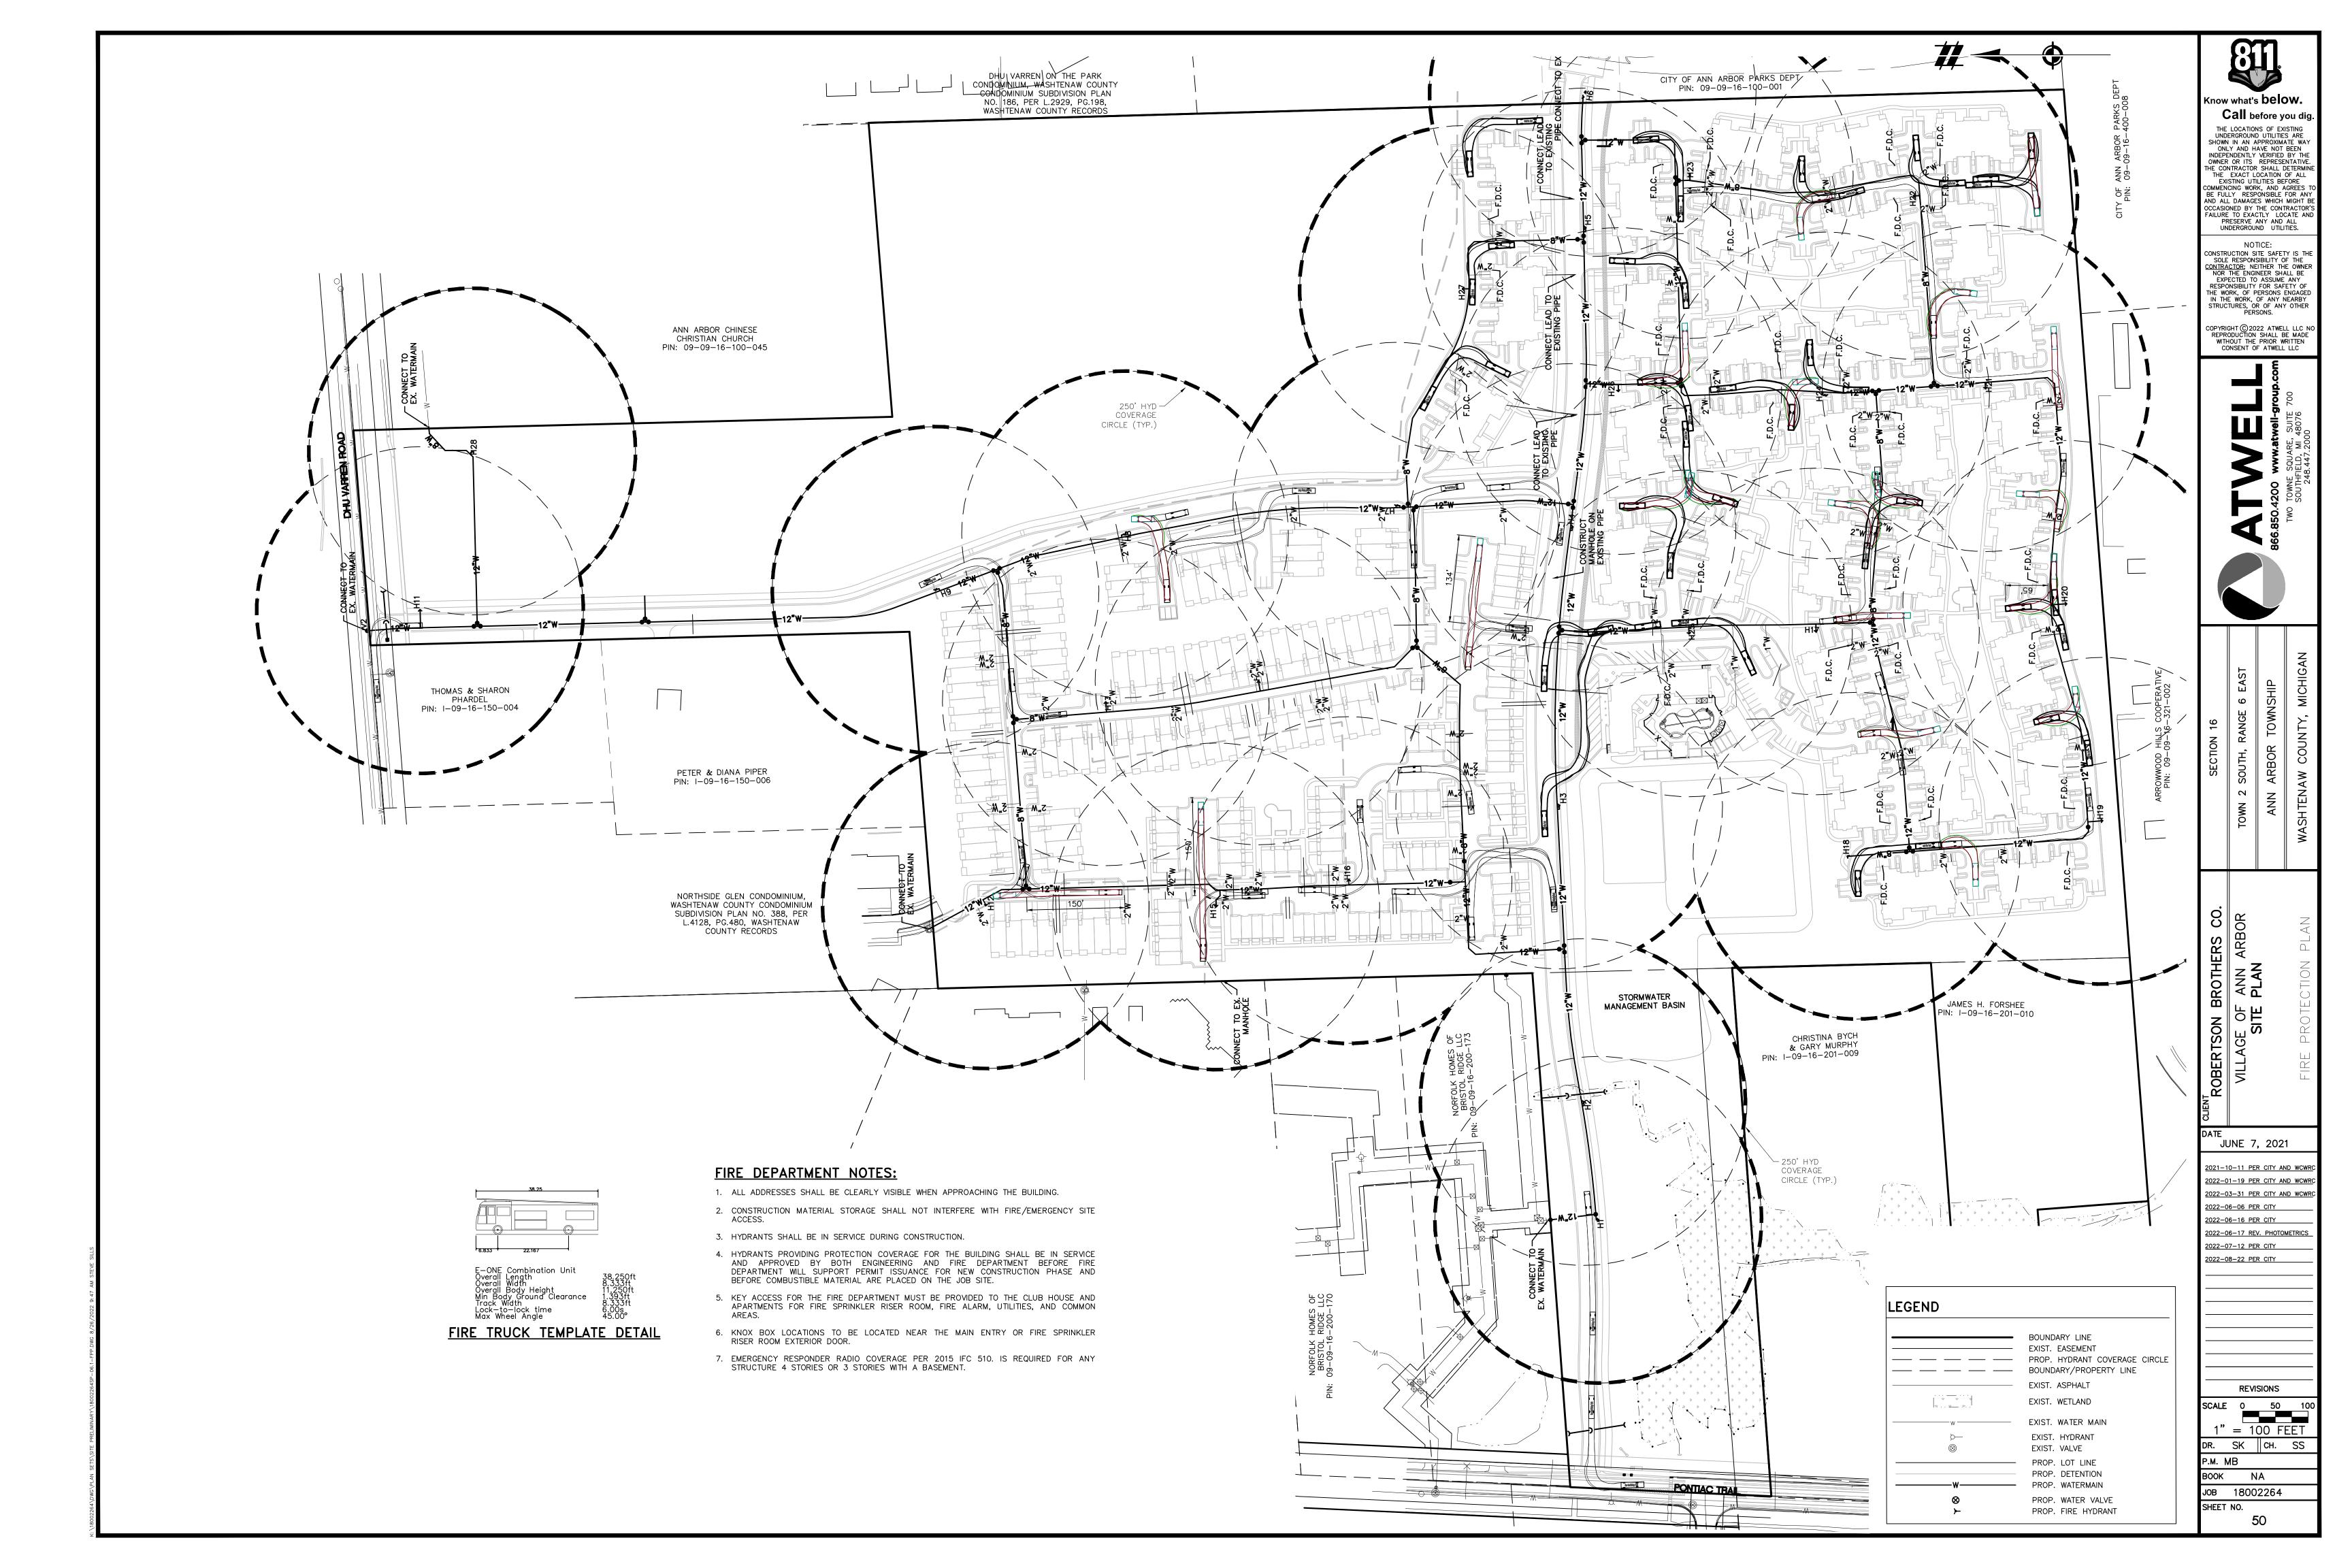


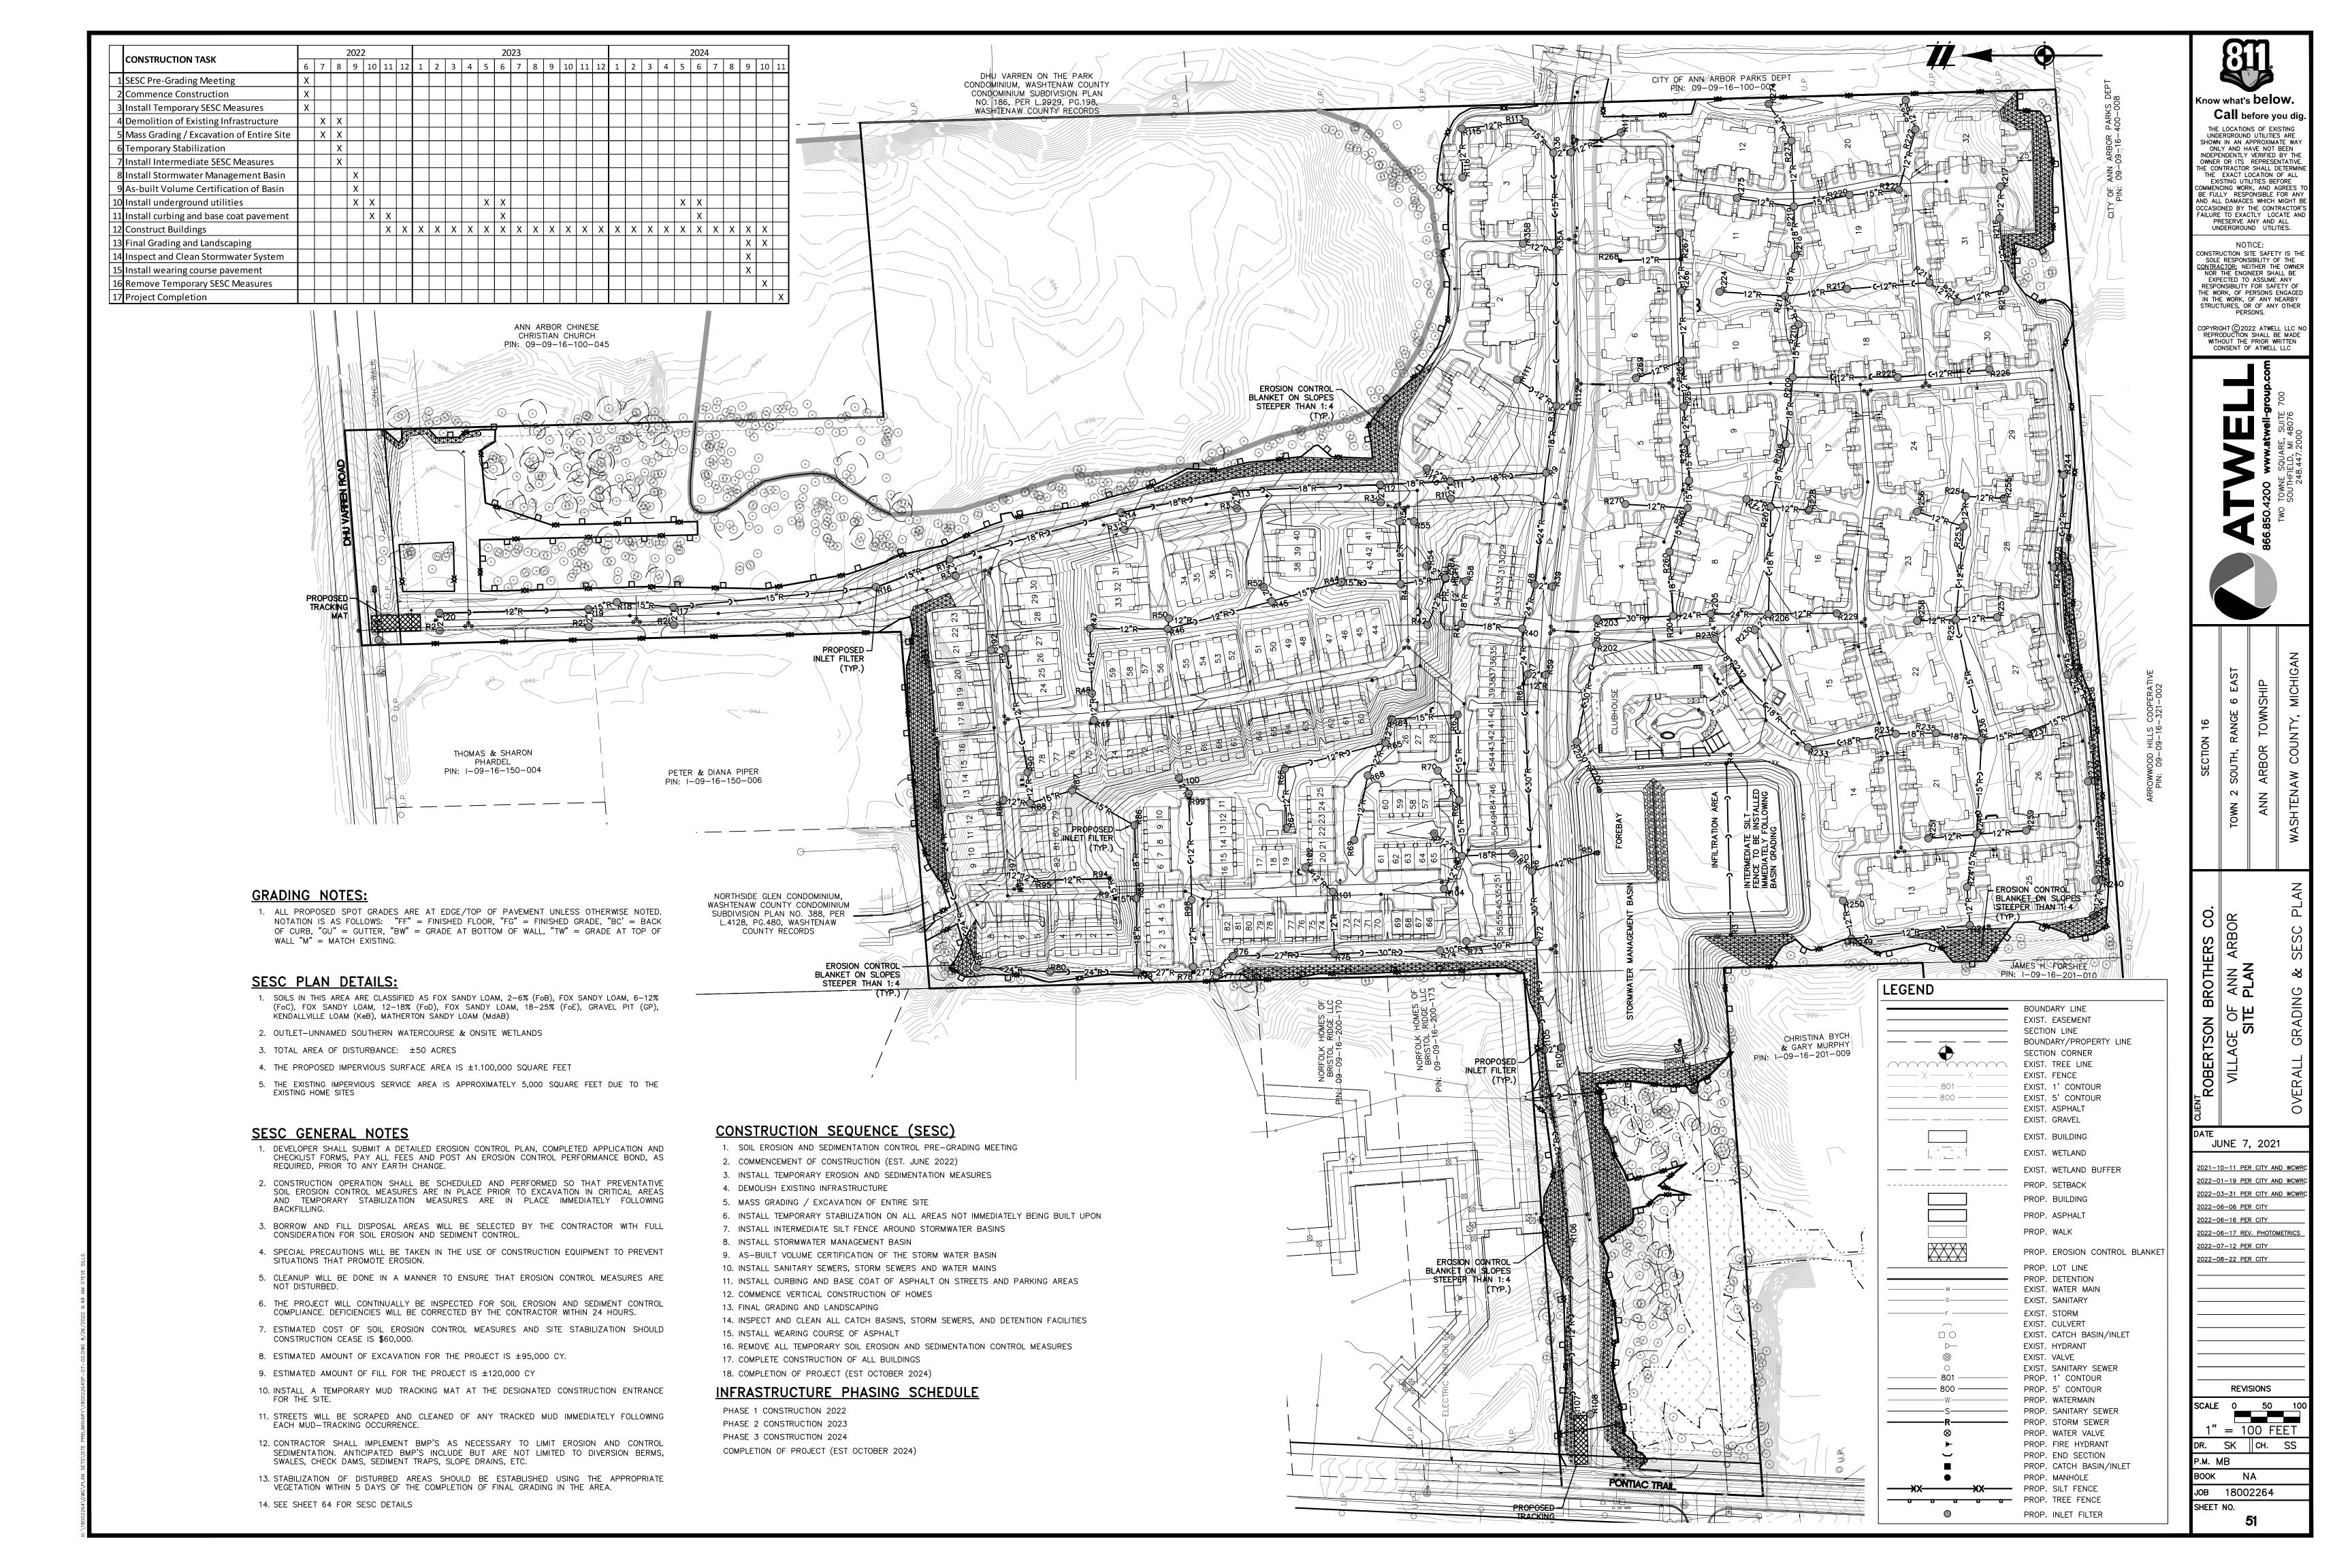

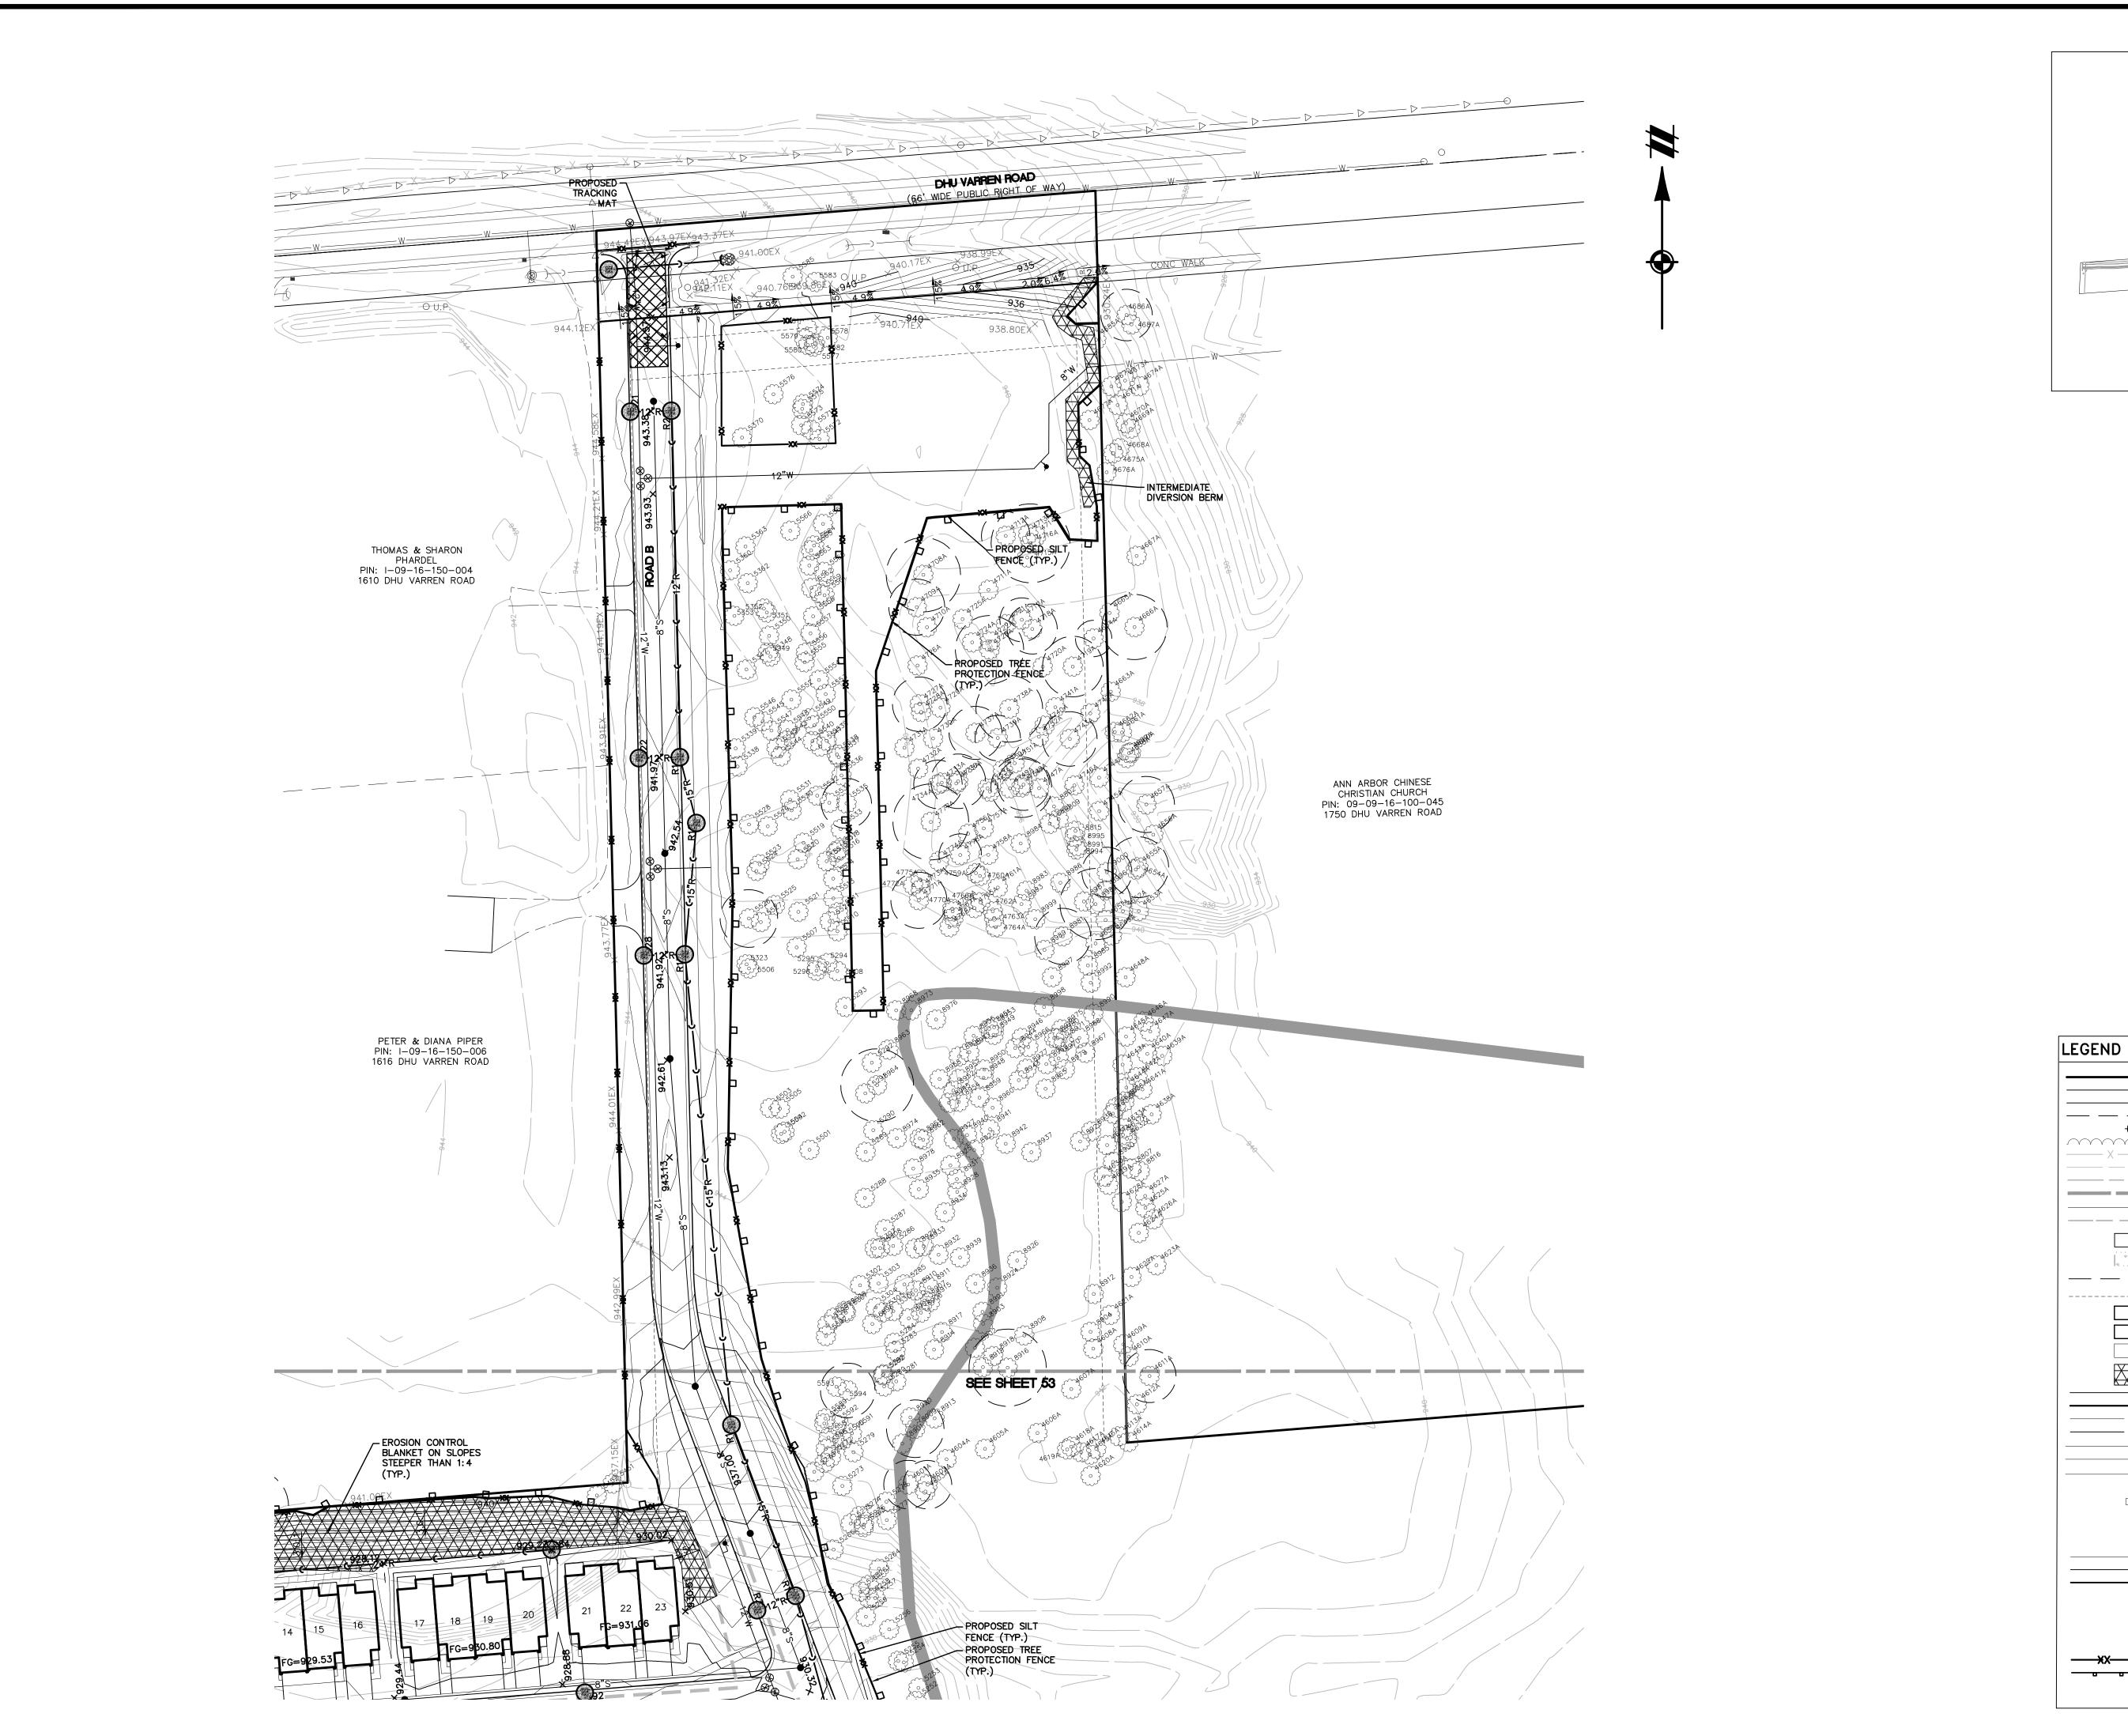

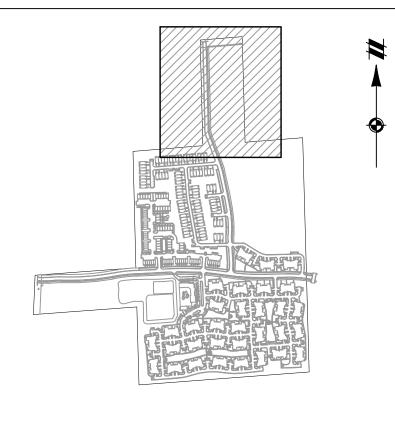



KEY MAP 1" = 750 FEET

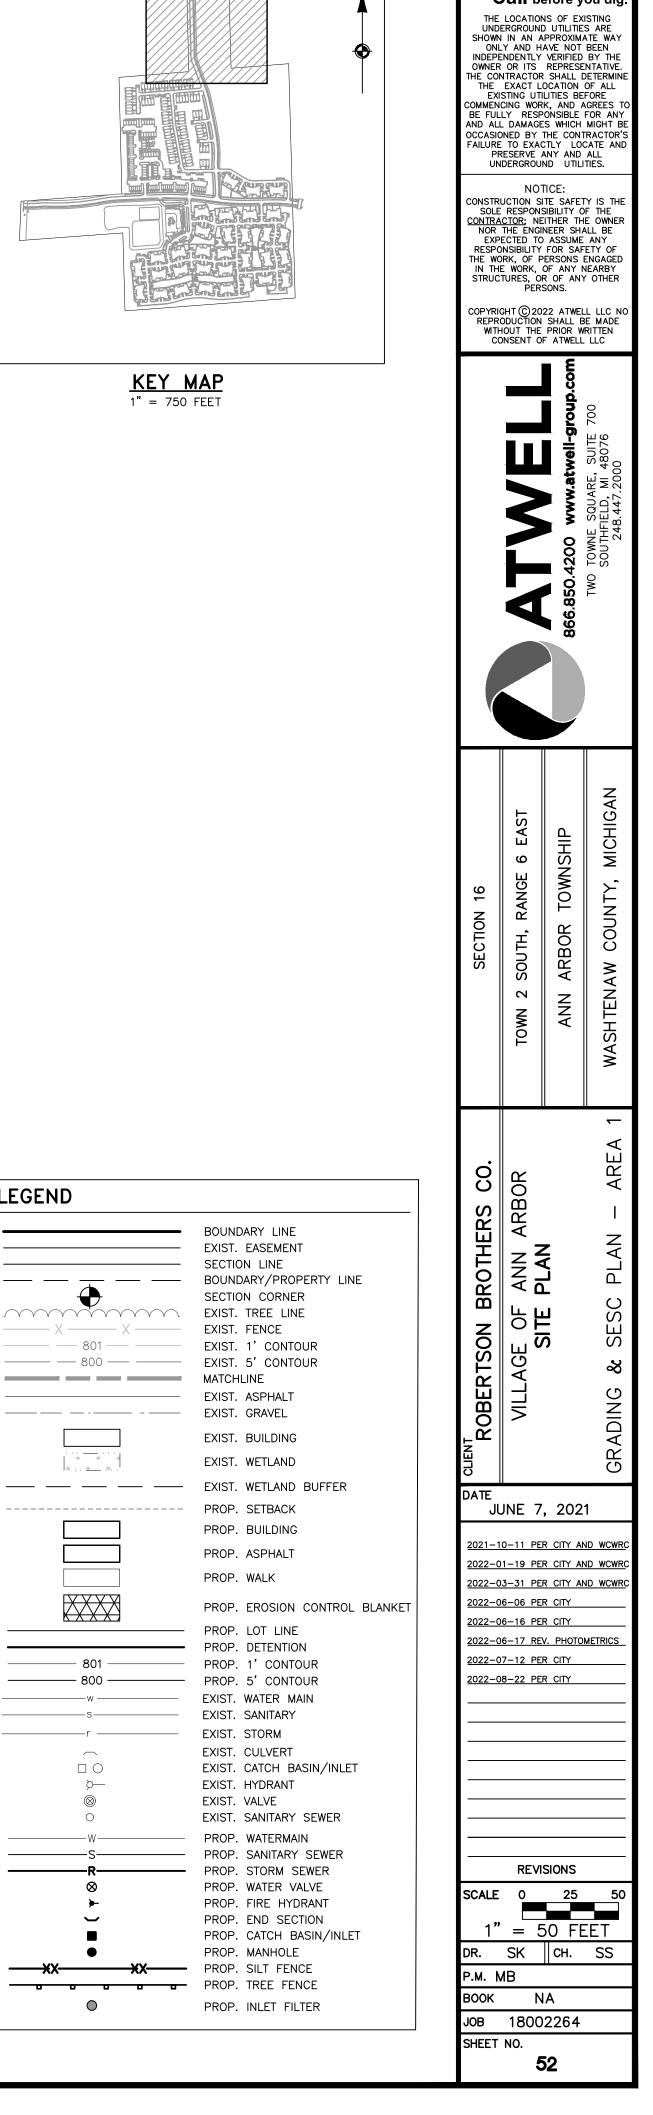



Know what's **below.**


Call before you dig.

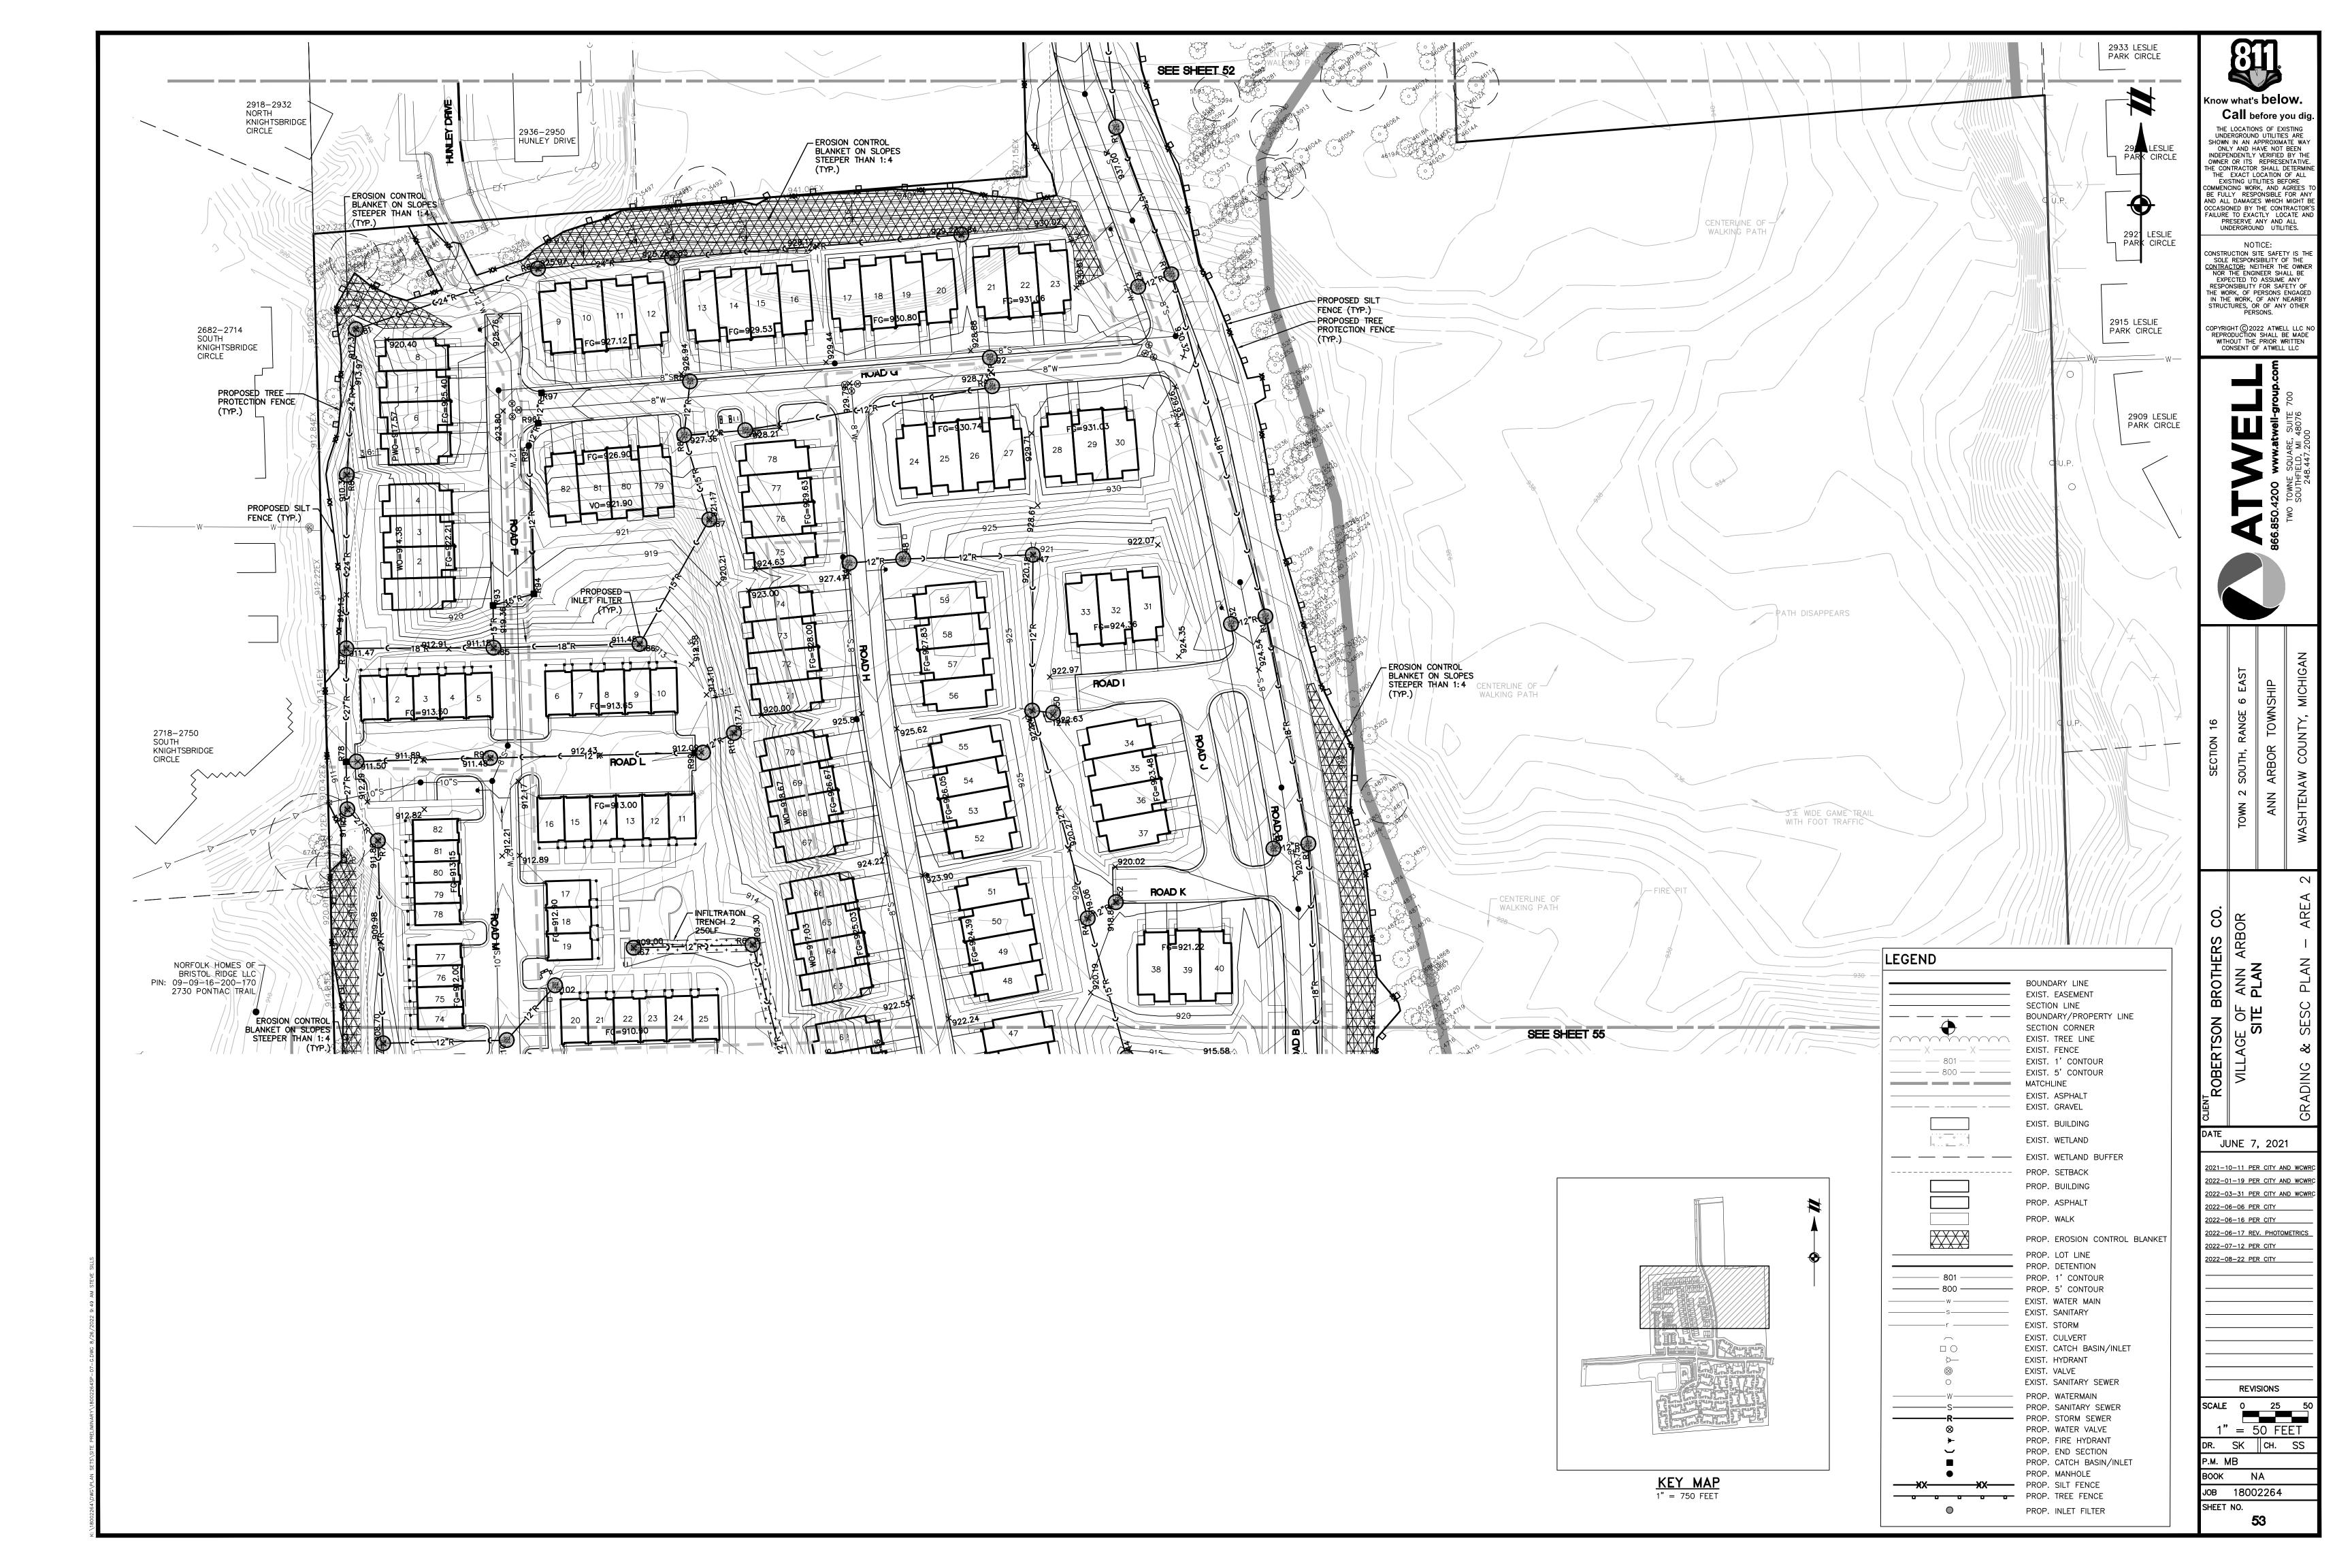

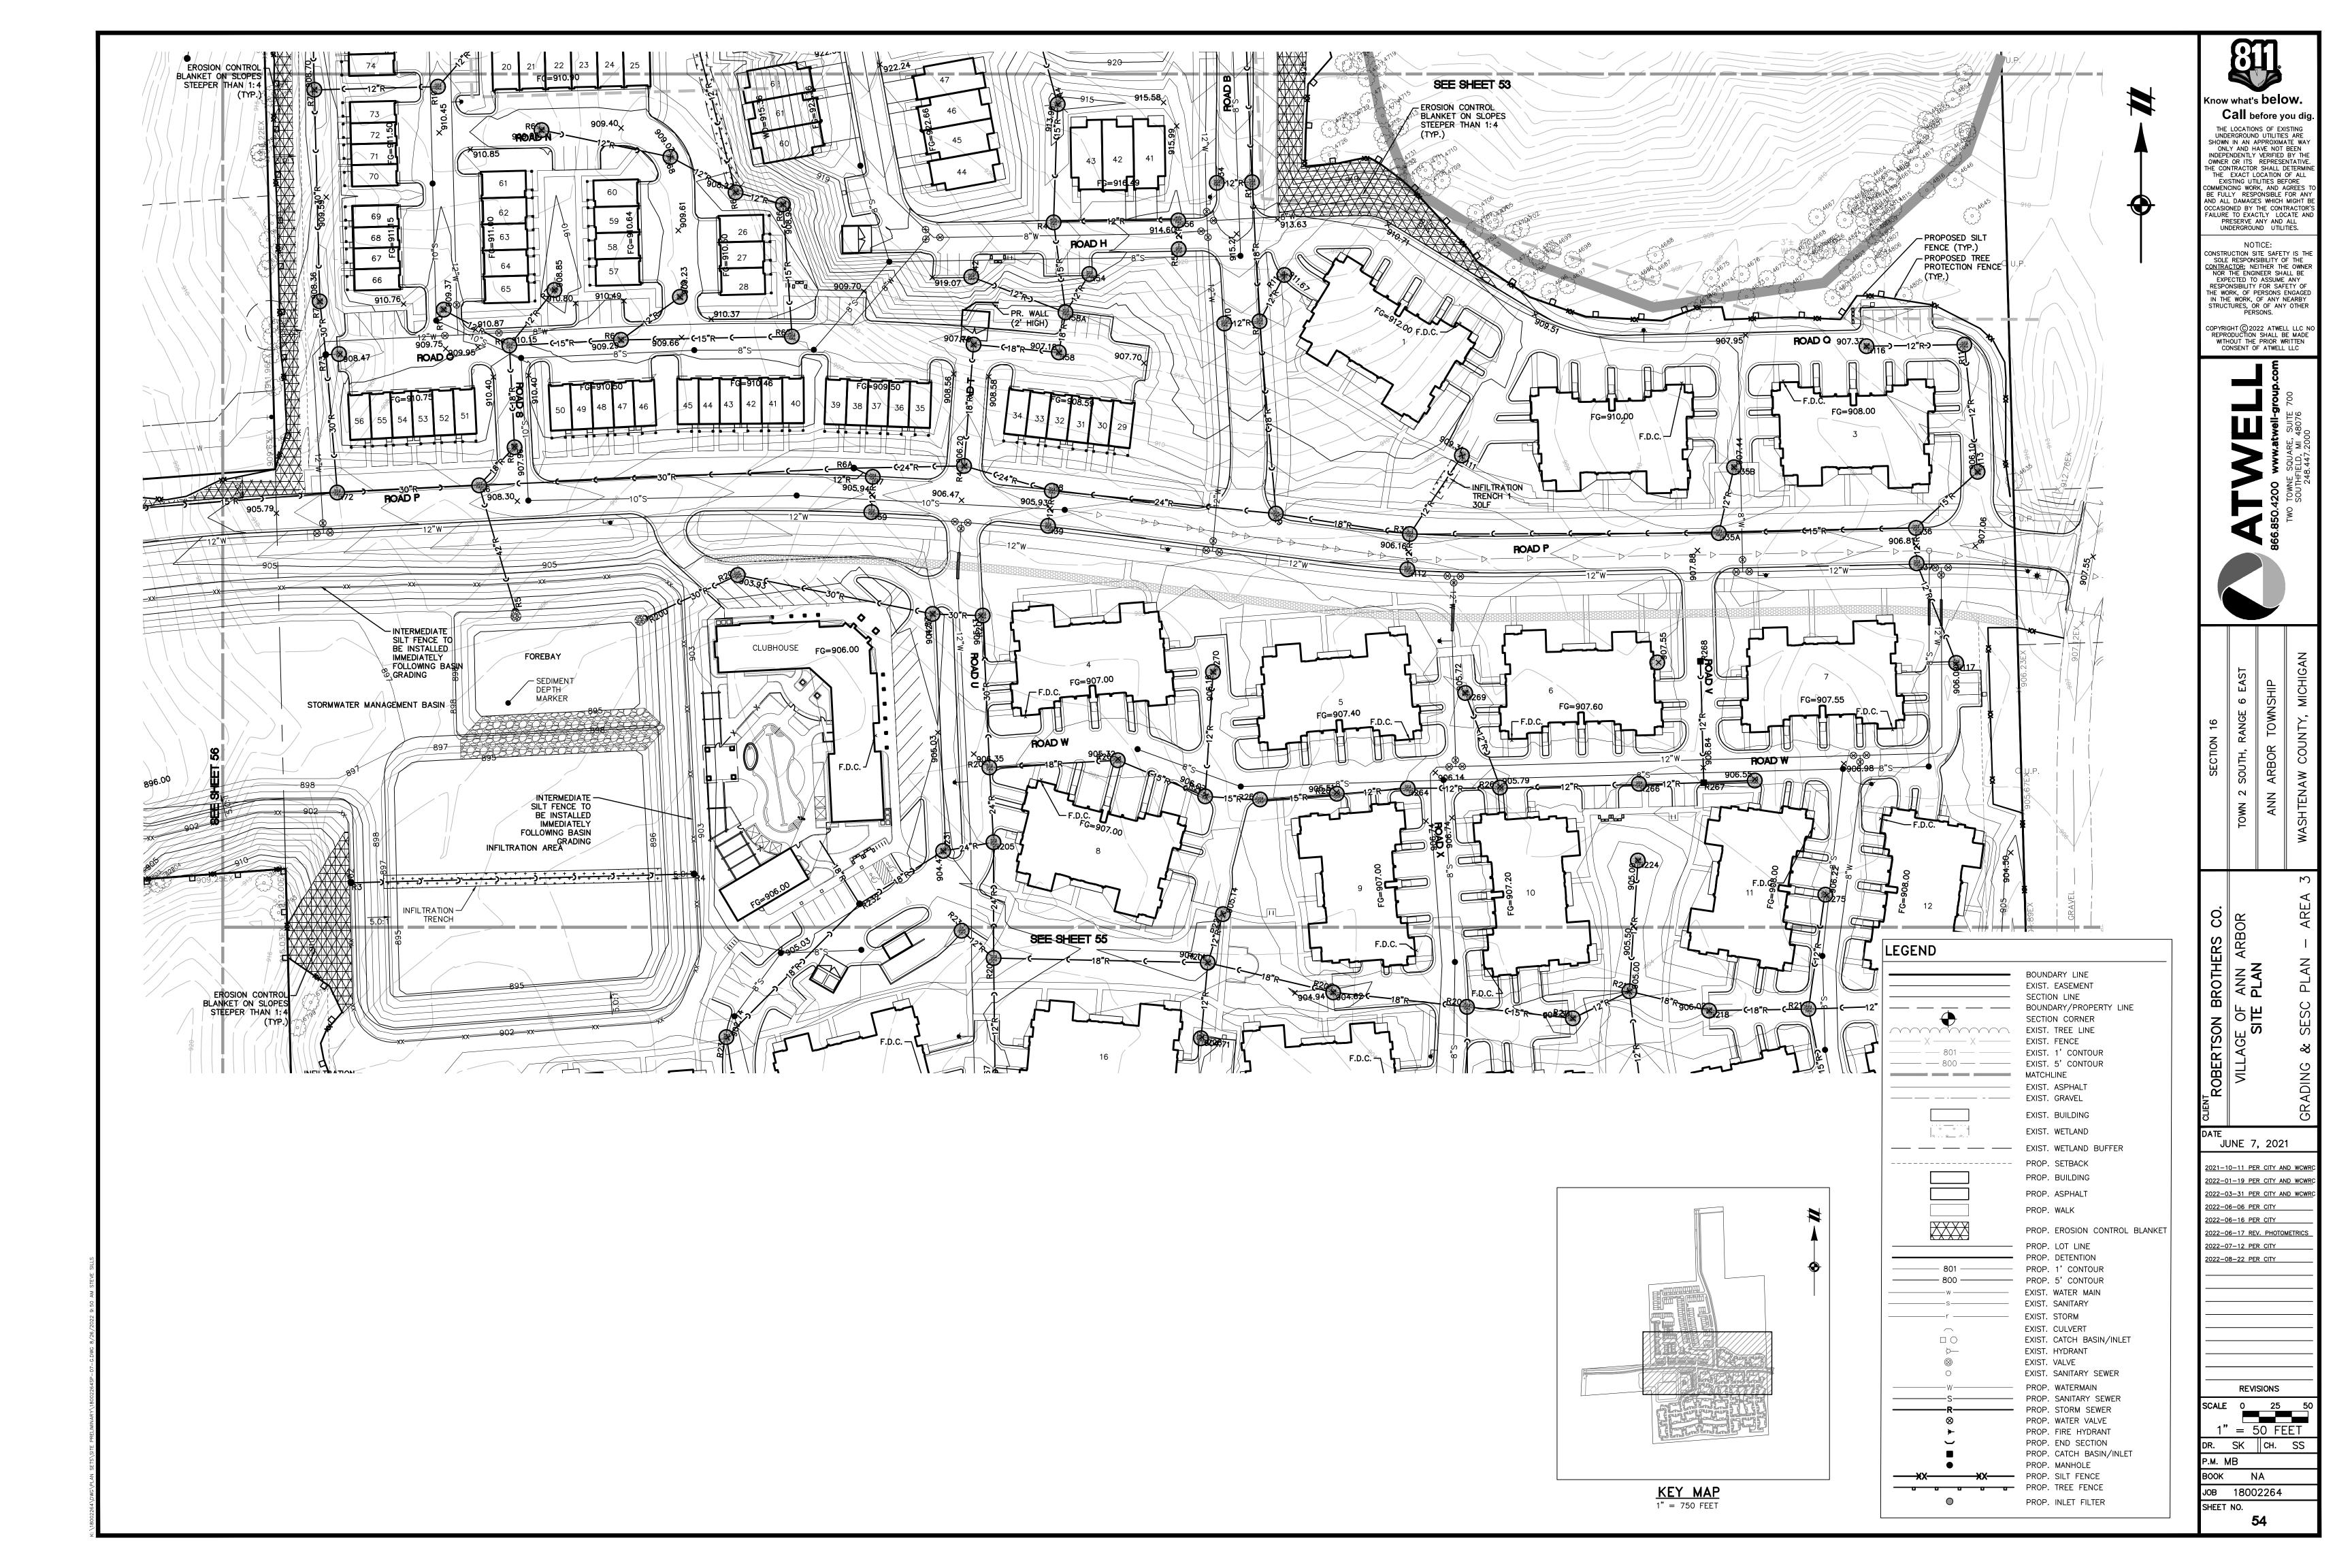


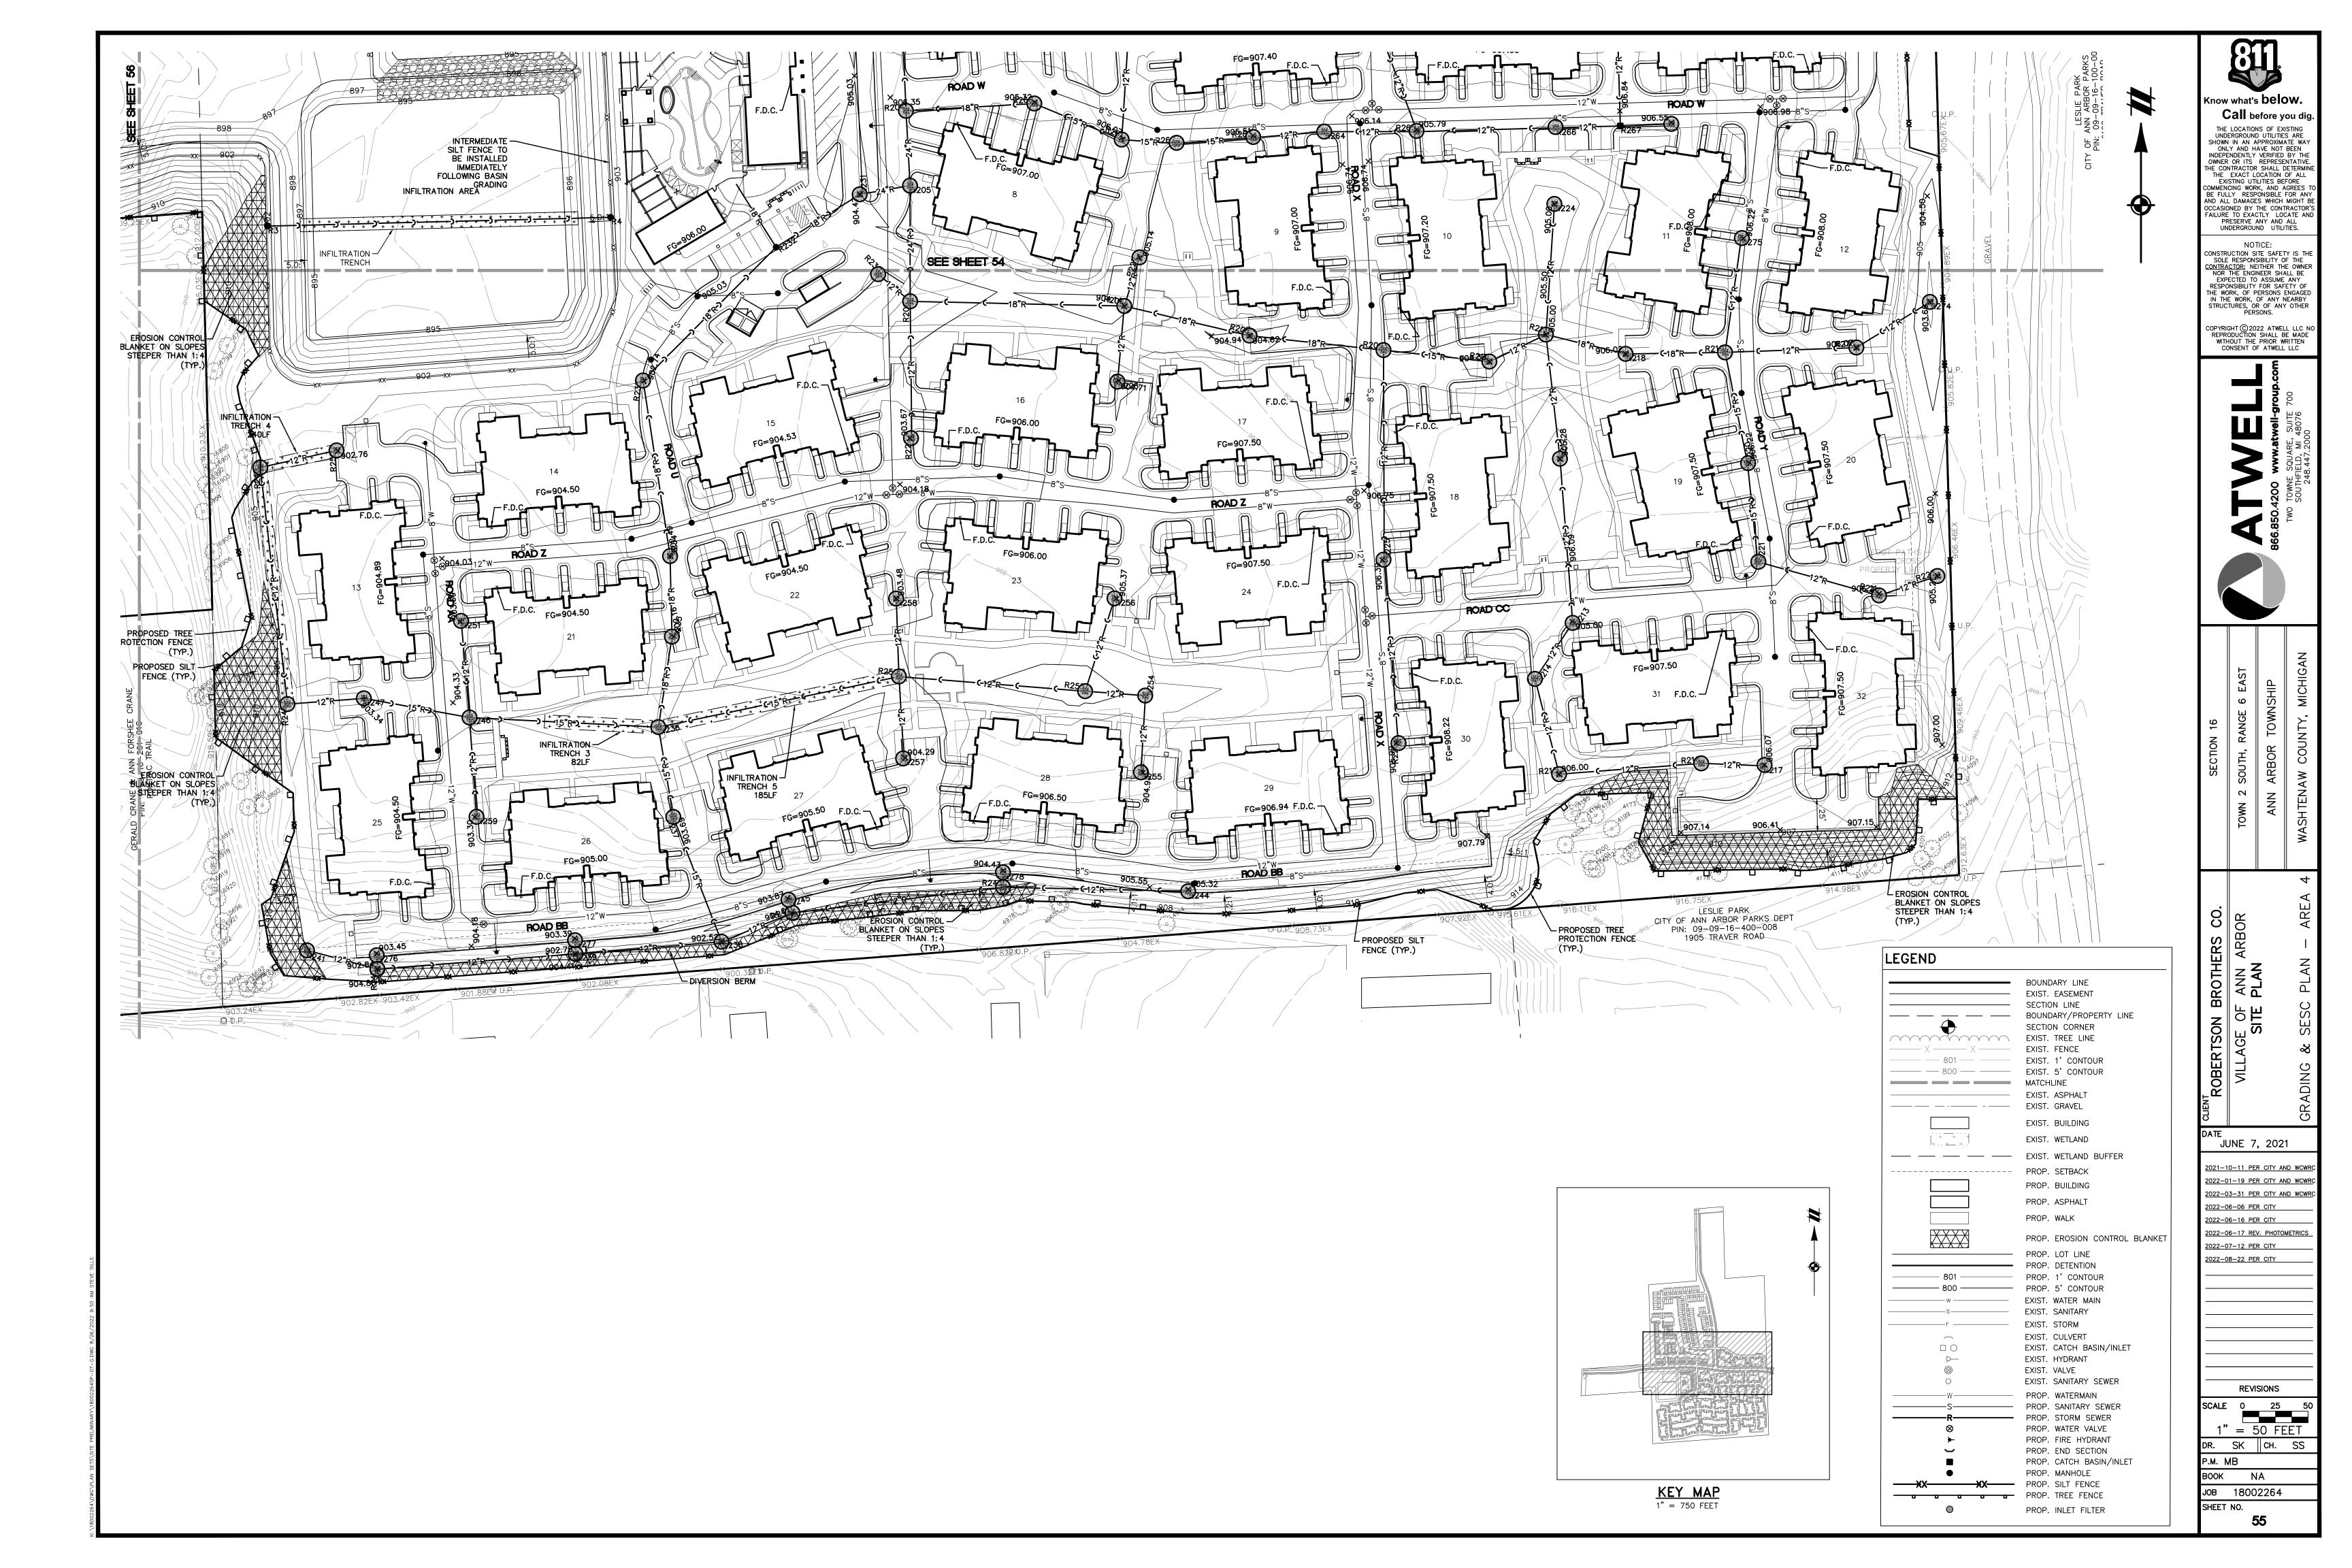


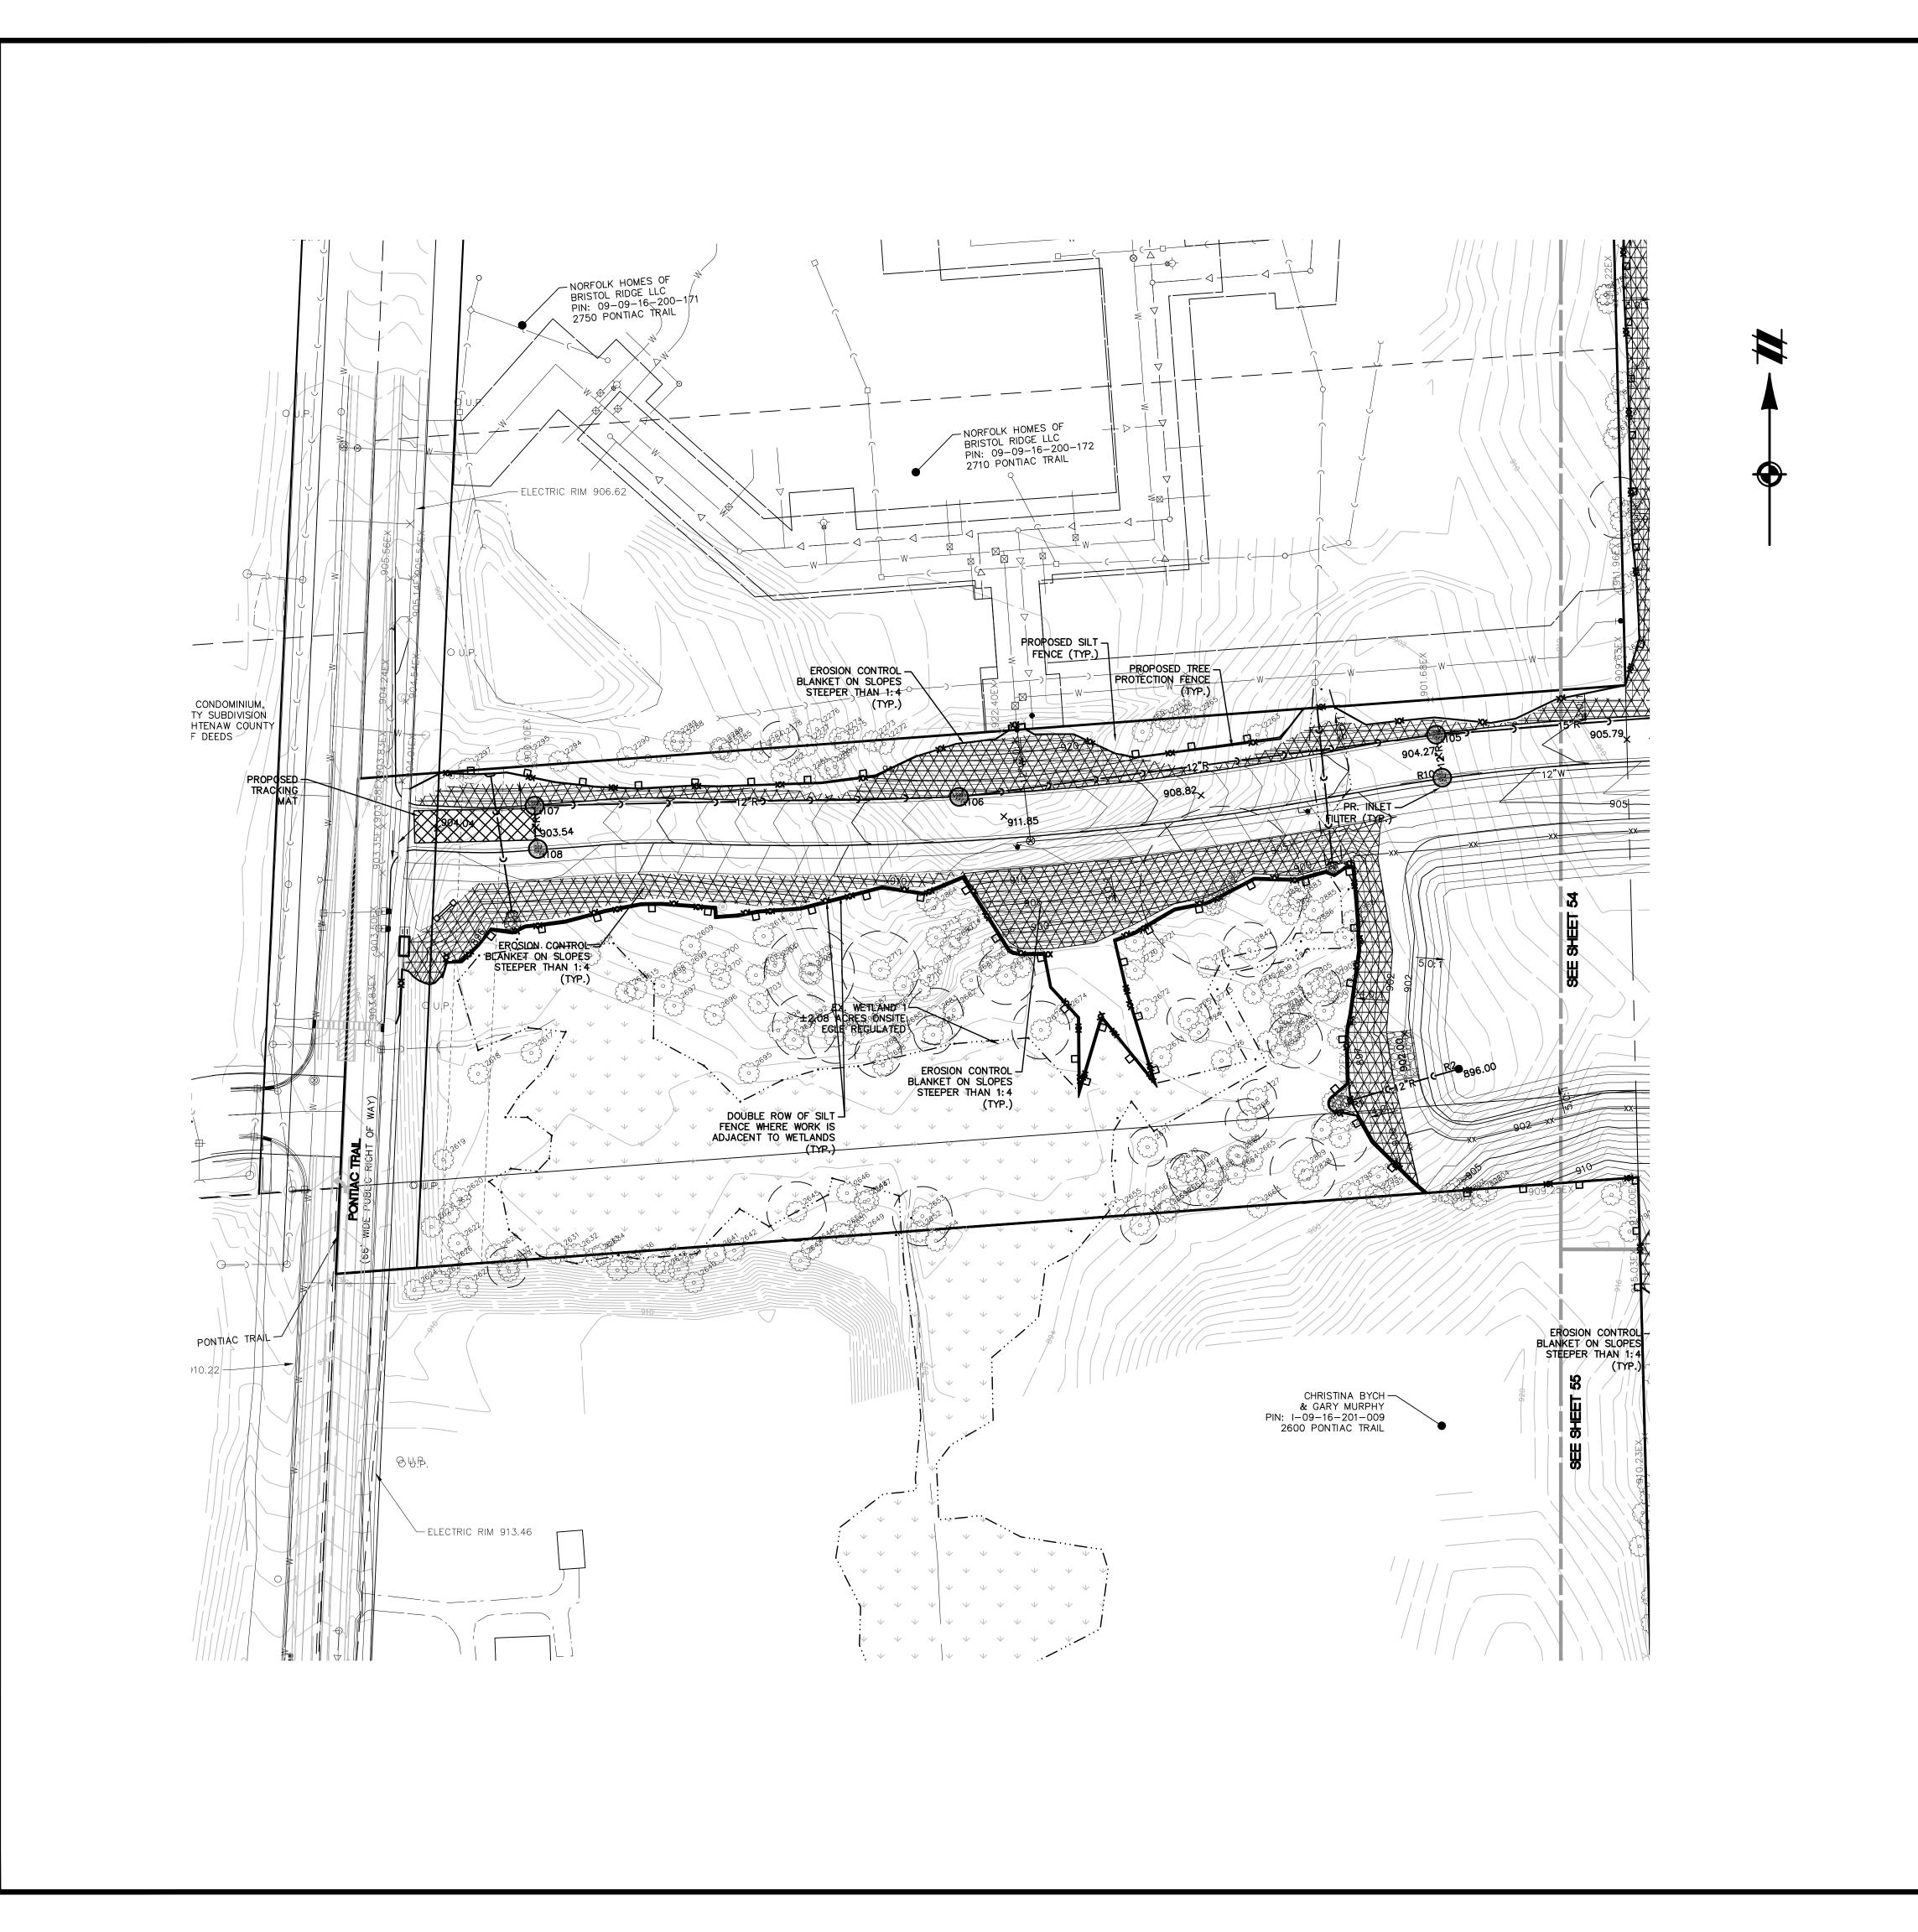

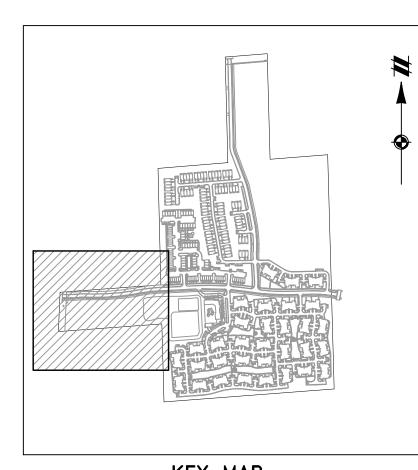

KEY MAP 1" = 750 FEET

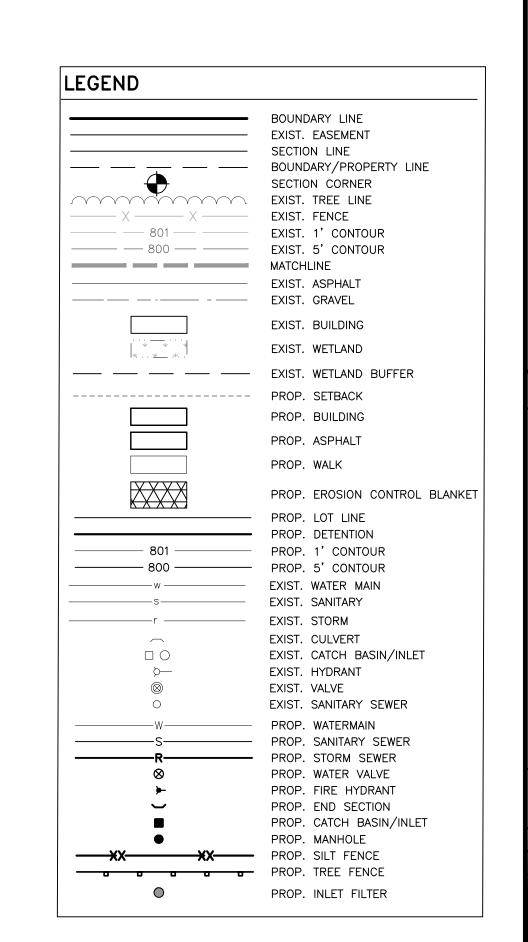

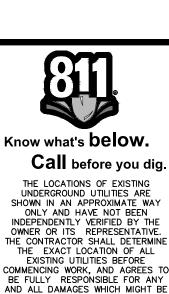

THE LOCATIONS OF EXISTING UNDERGROUND UTILITIES ARE SHOWN IN AN APPROXIMATE WAY ONLY AND HAVE NOT BEEN INDEPENDENTLY VERIFIED BY THE OWNER OR ITS REPRESENTATIVE. THE CONTRACTOR SHALL DETERMINE THE EXACT LOCATION OF ALL EXISTING UTILITIES BEFORE COMMENCING WORK, AND AGREES TO BE FULLY RESPONSIBLE FOR ANY AND ALL DAMAGES WHICH MIGHT BE COCCASIONED BY THE CONTRACTOR'S FAILURE TO EXACTLY LOCATE AND PRESERVE ANY AND ALL UNDERGROUND UTILITIES.

CONSTRUCTION SITE SAFETY IS THE SOLE RESPONSIBILITY OF THE CONTRACTOR; NEITHER THE OWNER NOR THE ENGINEER SHALL BE EXPECTED TO ASSUME ANY RESPONSIBILITY FOR SAFETY OF THE WORK, OF PERSONS ENGAGED IN THE WORK, OF ANY NEARBY STRUCTURES, OR OF ANY OTHER PERSONS.

COPYRIGHT © 2022 ATWELL LLC NO REPRODUCTION SHALL BE MADE WITHOUT THE PRIOR WRITTEN CONSENT OF ATWELL LLC

JUNE 7, 2021 2021-10-11 PER CITY AND WCWR


2022-01-19 PER CITY AND WCW 2022-03-31 PER CITY AND WCWR 2022-06-06 PER CITY 2022-06-16 PER CITY 2022-06-17 REV. PHOTOMETRICS 2022-07-12 PER CITY

2022-08-22 PER CITY


REVISIONS

1" = 50 FEETDR. SK CH. SS P.M. MB BOOK NA JOB 18002264 SHEET NO.



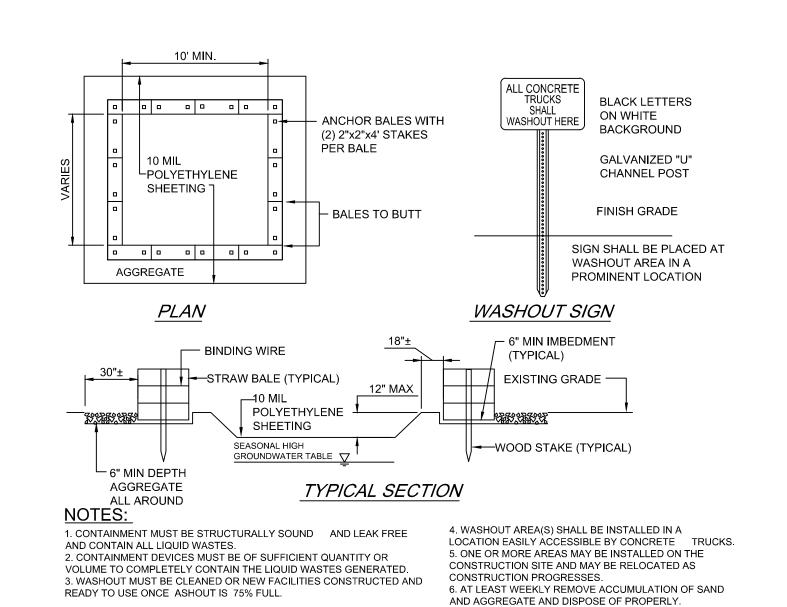

TEMPORARY STONE TRACKING MAT

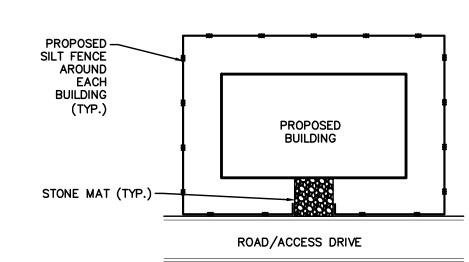

1. INSTALL STONE MUD MAT AT EACH BUILDING

- 2. INSTALL SILT FENCE SURROUND BUILDING
- 3. MAINTAIN SILT FENCE AND TRACKING MAT IN FUNCTIONING CONDITION THROUGHOUT
- CONSTRUCTION 4. STABILIZE GROUND BEFORE REMOVING SILT
- 5. REFER TO PLANS FOR ADDITIONAL SOIL
- EROSION CONTROL MEASURES

TYPICAL BUILDING S.E.S.C. EXHIBIT

COMPONENTS Annual Pond Outlet Infiltration Outflow Ditches **TASKS SCHEDULE** Storm Sewer Control and Cost & Rip-Rap System Swales | Structure Basins Inspect for sediment, Semi-Annually floatables, and debris 600.00 Removal of sediment, As Needed 1,400.00 floatables, and debris 300.00 Inspection for erosion Quarterly Re-establish permanent As needed 500.00 vegetation on eroded slopes 700.00 Replacement of stone As Needed Χ 400.00 Χ l-2 times per year Inspect Stormwater system components during wet Semi-Annually weather and compare to as-400.00 built plans Make adjustments as determined by annual As needed 500.00 inspection Total Cost= \$ 4,800.00 Note: Stormwater maintenance is the responsibility of the home owners association.

NOTE: "As Needed" refers to when sediment has accumulated to a maximum of one foot depth, visually apparent debris exists, or if either of the stormwater management basins do not drain within 48-72 hours after a rain event NOTE: No chemicals are allowed in stormwater features or buffer zones with the following exception:


Invasive species may be treated with chemicals by a certified applicator. NOTE: The Infiltaration basin shall be inspected following storms of 1" or more.


PERMANENT STORM WATER MAINTENANCE TASKS, SCHEDULE, & BUDGET DURING CONSTRUCTION THE CONTRACTOR IS RESPONSIBLE FOR MAINTENANCE OF THE STORMWATER SYSTEM, POST CONSTRUCTION THE HOMEOWNERS ASSOCIATION WILL BE RESPONSIBLE.

| TASKS | COMPONENTS | | | | | | | |
|--|-----------------------|------------------------------|----------------|--------------------------|---------------------------------|---------|--------------------------------------|---|
| | Storm Sewer System | Catch Basin Inlet Filters | I Silt Fence I | Ditches and Swales | Outflow Control Structure | Rip-Rap | Detention/ Infiltration Basins | SCHEDULE |
| Inspect for sediment, floatables, and debris | Х | х | х | х | х | Х | х | Weekly / Within 24 hrs after a Rair Event |
| Removal of sediment, floatables, and debris | Х | Х | Х | Х | Х | Х | Х | As Needed |
| Inspection for erosion | | | | х | х | Х | х | Weekly / Within 24 hrs after a Rain Event |
| Re-establish permanent vegetation on eroded slopes | | | | Х | х | Х | Х | As needed |
| Replacement of stone | | | | | X | | | At turnover |

STORM WATER MAINTENANCE TASKS AND SCHEDULE DURING CONSTRUCTION DURING CONSTRUCTION THE CONTRACTOR IS RESPONSIBLE FOR MAINTENANCE OF THE STORMWATER SYSTEM

CONCRETE WASHOUT AREA NO SCALE

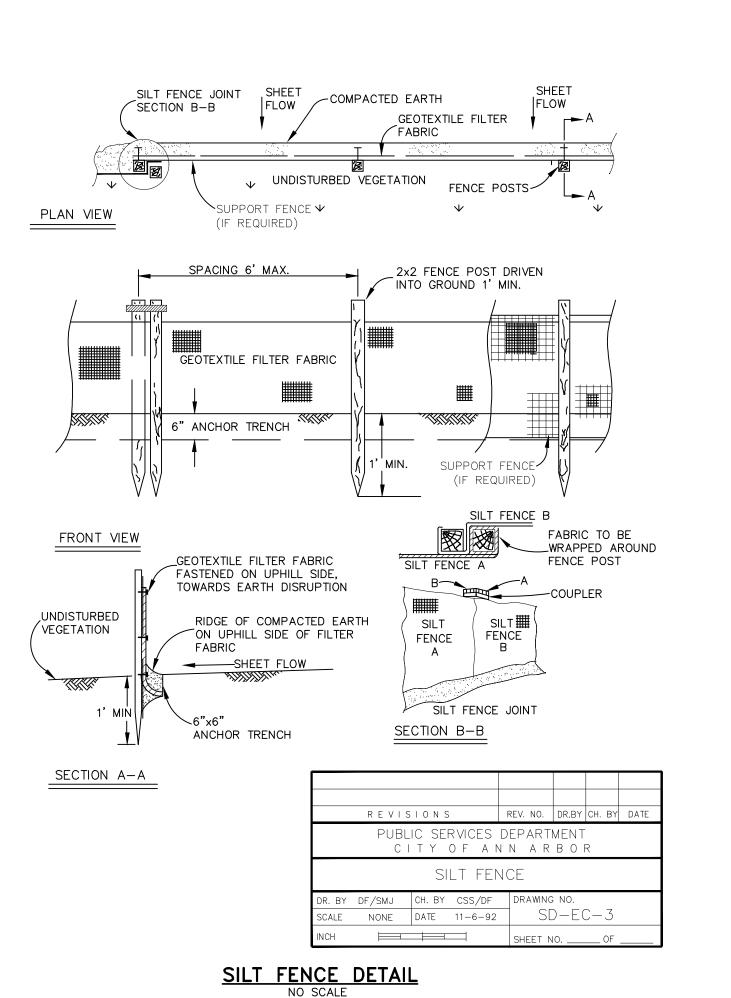

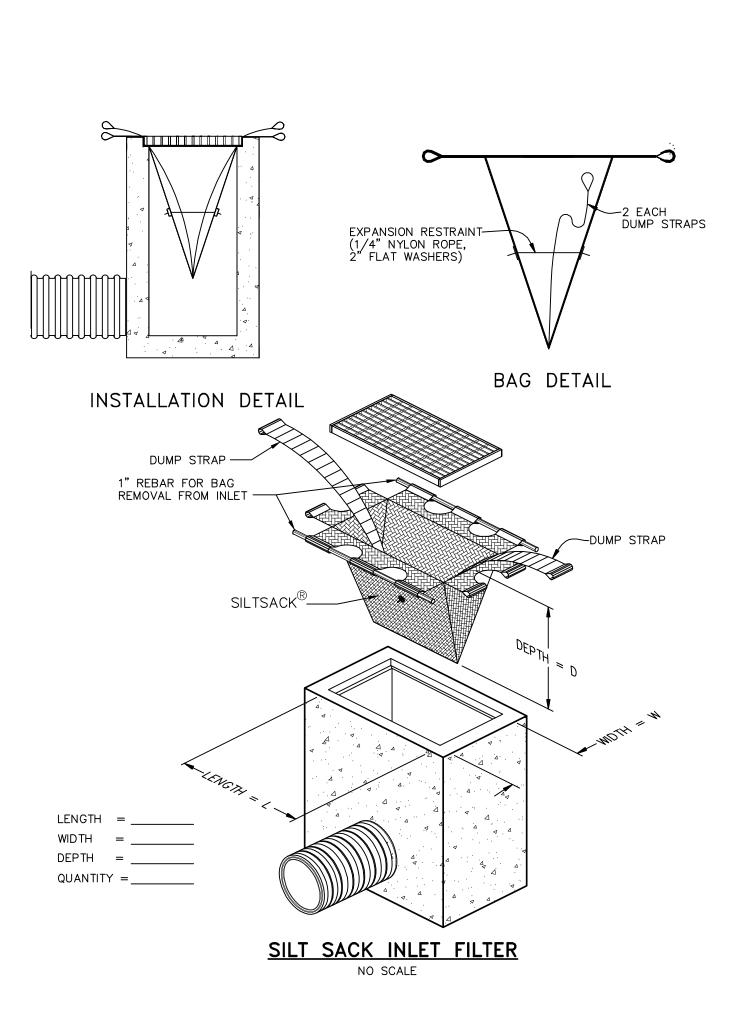



Call before you dig THE LOCATIONS OF EXISTING THE LOCATIONS OF EXISTING UNDERGROUND UTILITIES ARE SHOWN IN AN APPROXIMATE WAY ONLY AND HAVE NOT BEEN INDEPENDENTLY VERIFIED BY THE OWNER OR ITS REPRESENTATIVE. THE CONTRACTOR SHALL DETERMINI THE EXACT LOCATION OF ALL EXISTING UTILITIES BEFORE COMMENCING WORK, AND AGREES TO BE FULLY RESPONSIBLE FOR ANY AND ALL DAMAGES WHICH MIGHT RESPONSIBLE FOR ANY AND ALL DAMAGES WHICH PROPERTY WHICH ND ALL DAMAGES WHICH MIGHT I OCCASIONED BY THE CONTRACTOR' FAILURE TO EXACTLY LOCATE ANI PRESERVE ANY AND ALL UNDERGROUND UTILITIES.

NO IICL:

CONSTRUCTION SITE SAFETY IS THE SOLE RESPONSIBILITY OF THE CONTRACTOR; NEITHER THE OWNER NOR THE ENGINEER SHALL BE EXPECTED TO ASSUME ANY RESPONSIBILITY FOR SAFETY OF THE WORK, OF PERSONS ENGAGED IN THE WORK, OF ANY NEARBY STRUCTURES, OR OF ANY OTHER PERSONS.

COPYRIGHT © 2022 ATWELL LLC N REPRODUCTION SHALL BE MADE WITHOUT THE PRIOR WRITTEN CONSENT OF ATWELL LLC

JUNE 7, 2021

2021-10-11 PER CITY AND WCW 2022-01-19 PER CITY AND WCW 2022-03-31 PER CITY AND WCW 2022-06-06 PER CITY

2022-06-16 PER CITY 2022-06-17 REV. PHOTOMETRICS 2022-07-12 PER CITY


2022-08-22 PER CITY

REVISIONS

1" = 100 FEETSK CH. SS

P.M. MB BOOK NA JOB 18002264

SHEET NO.

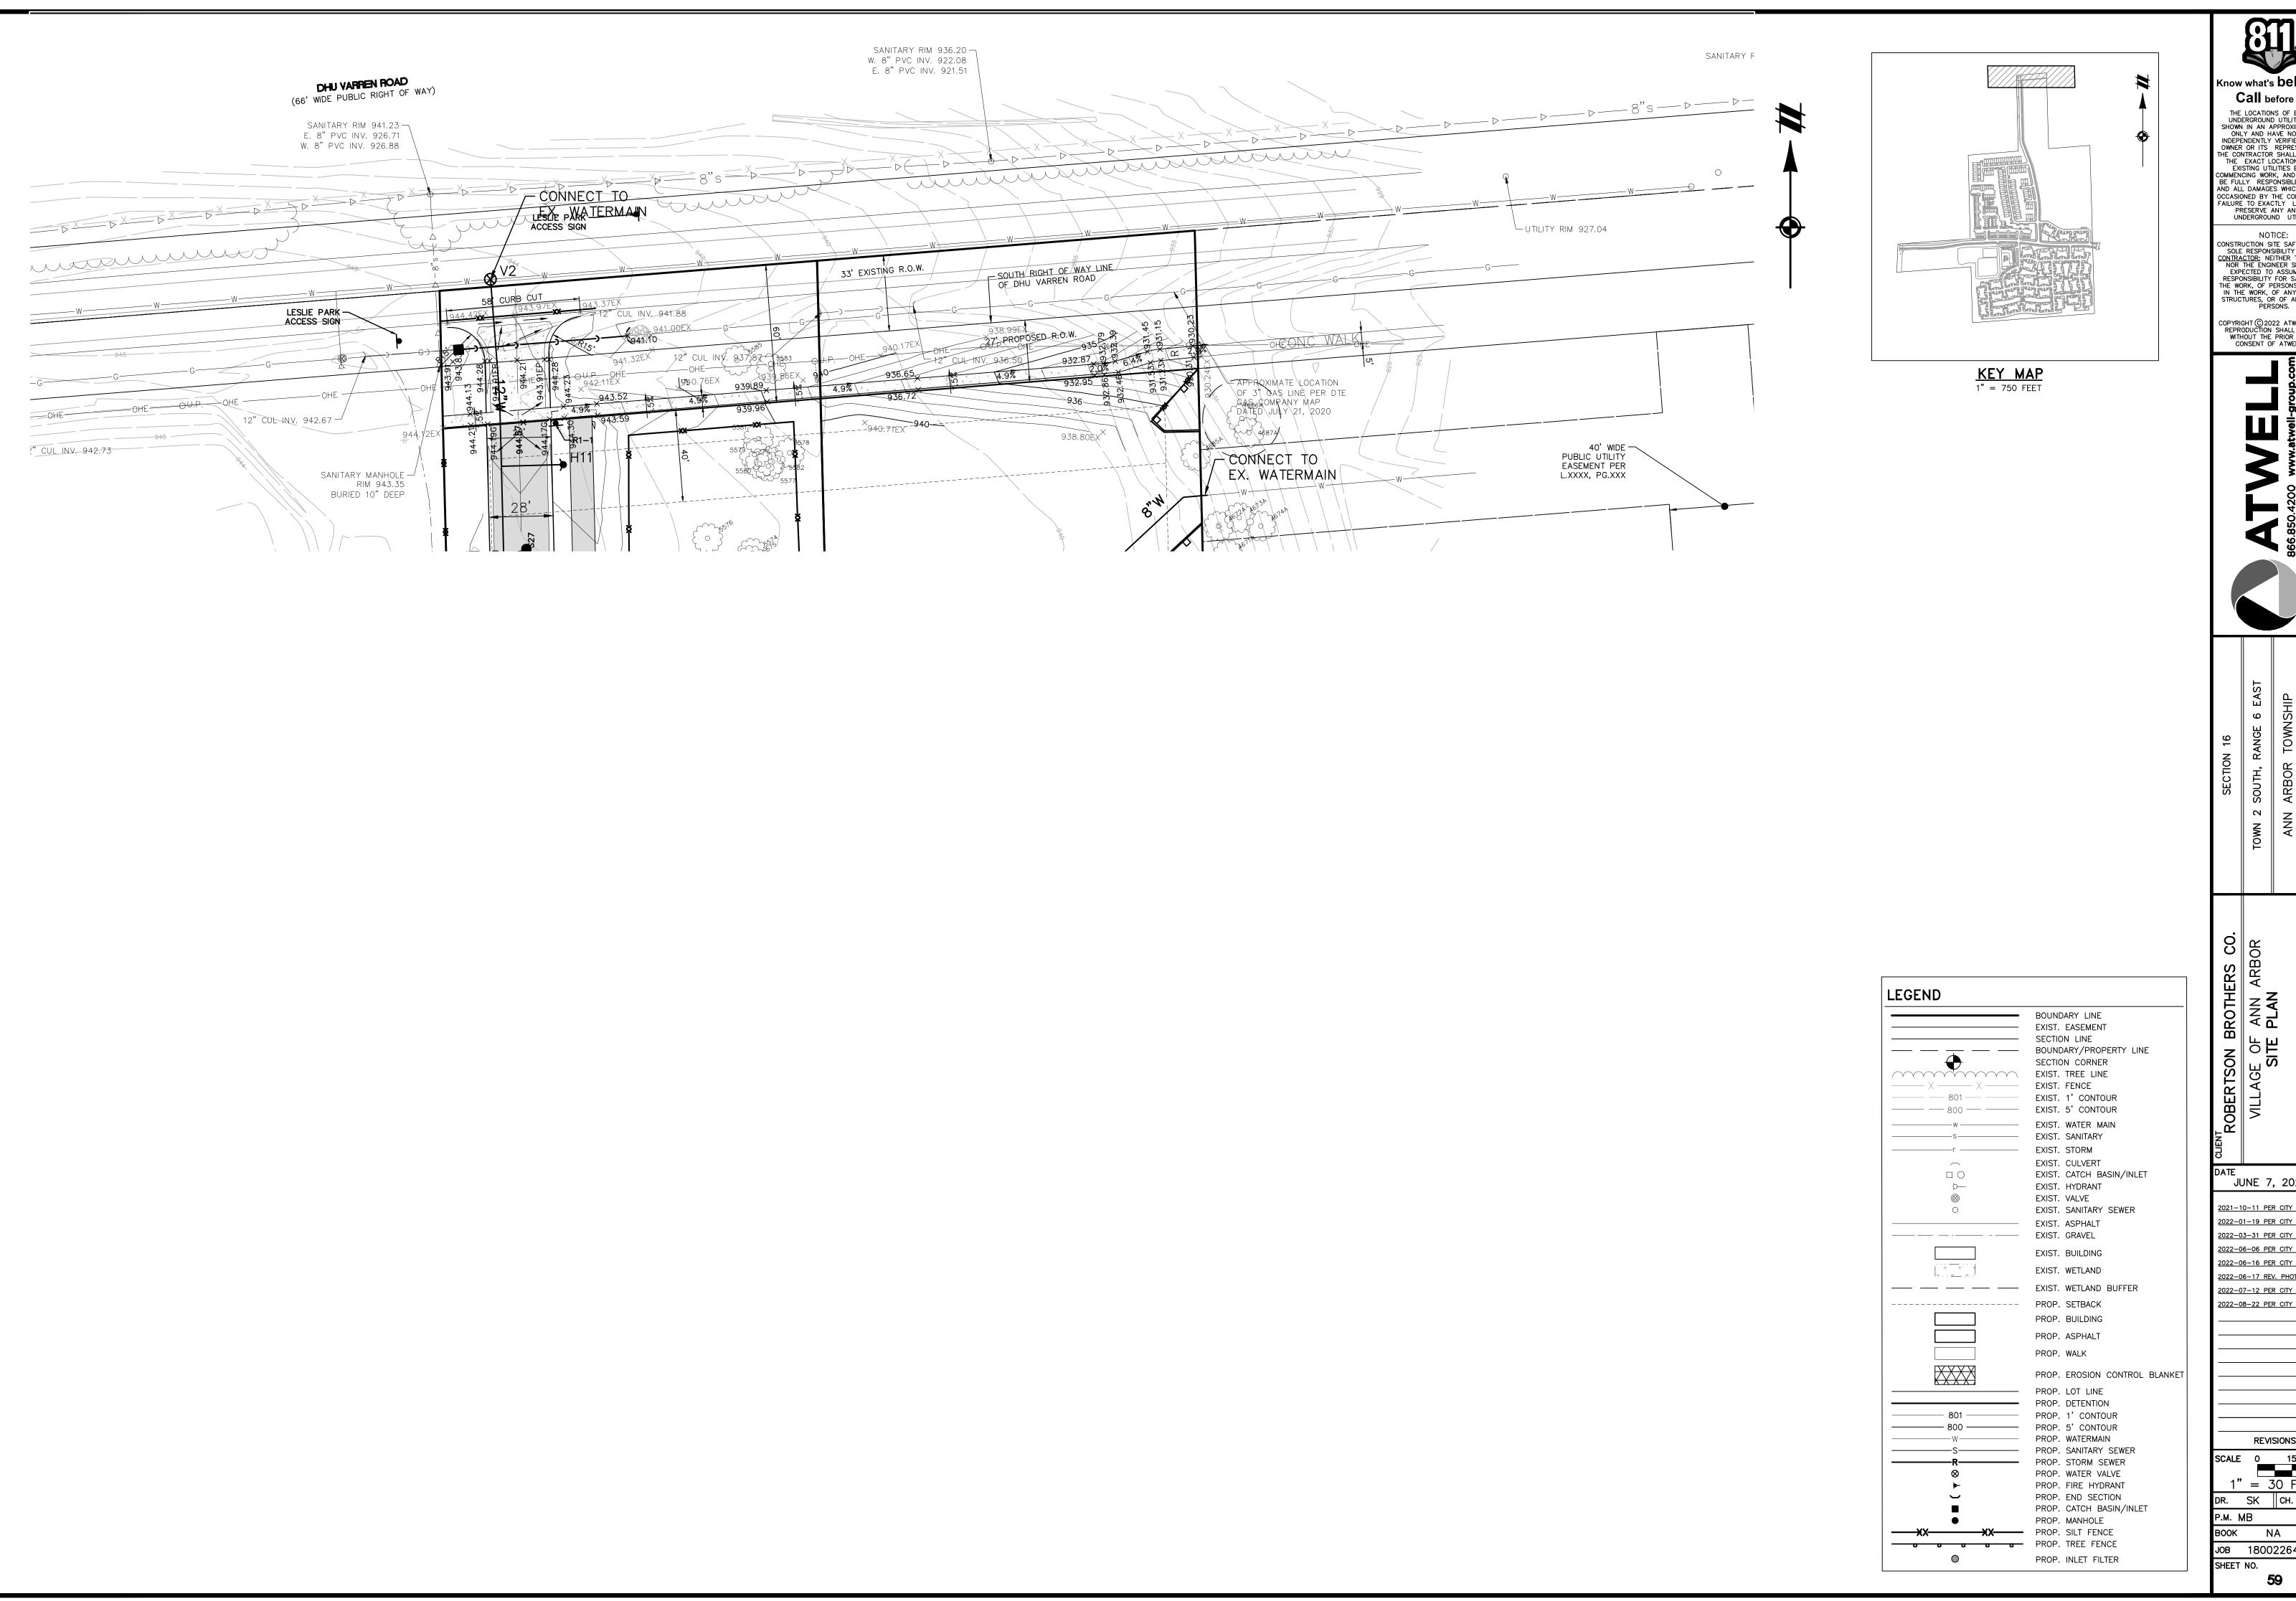

Know what's **below.** Call before you dig.

THE LOCATIONS OF EXISTING UNDERGROUND UTILITIES ARE SHOWN IN AN APPROXIMATE WAY ONLY AND HAVE NOT BEEN INDEPENDENTLY VERIFIED BY THE OWNER OR ITS REPRESENTATIVE. THE CONTRACTOR SHALL DETERMINE THE EXACT LOCATION OF ALL EXISTING UTILITIES BEFORE COMMENCING WORK, AND AGREES TO BE FULLY RESPONSIBLE FOR ANY AND ALL DAMAGES WHICH MIGHT BE COCCASIONED BY THE CONTRACTOR'S FAILURE TO EXACTLY LOCATE AND PRESERVE ANY AND ALL UNDERGROUND UTILITIES.

NOTICE:

CONSTRUCTION SITE SAFETY IS THE SOLE RESPONSIBILITY OF THE CONTRACTOR; NEITHER THE OWNER NOR THE ENGINEER SHALL BE EXPECTED TO ASSUME ANY RESPONSIBILITY FOR SAFETY OF THE WORK, OF PERSONS ENGAGED IN THE WORK, OF ANY NEARBY STRUCTURES, OR OF ANY OTHER PERSONS.

COPYRIGHT © 2022 ATWELL LLC NO REPRODUCTION SHALL BE MADE WITHOUT THE PRIOR WRITTEN CONSENT OF ATWELL LLC

JUNE 7, 2021 2021-10-11 PER CITY AND WCWRO


2022-01-19 PER CITY AND WCWR 2022-03-31 PER CITY AND WCWR 2022-06-06 PER CITY


2022-06-16 PER CITY 2022-06-17 REV. PHOTOMETRICS 2022-07-12 PER CITY 2022-08-22 PER CITY


REVISIONS

SCALE 0 15 30 1" = 30 FEET

DR. SK CH. SS JOB 18002264

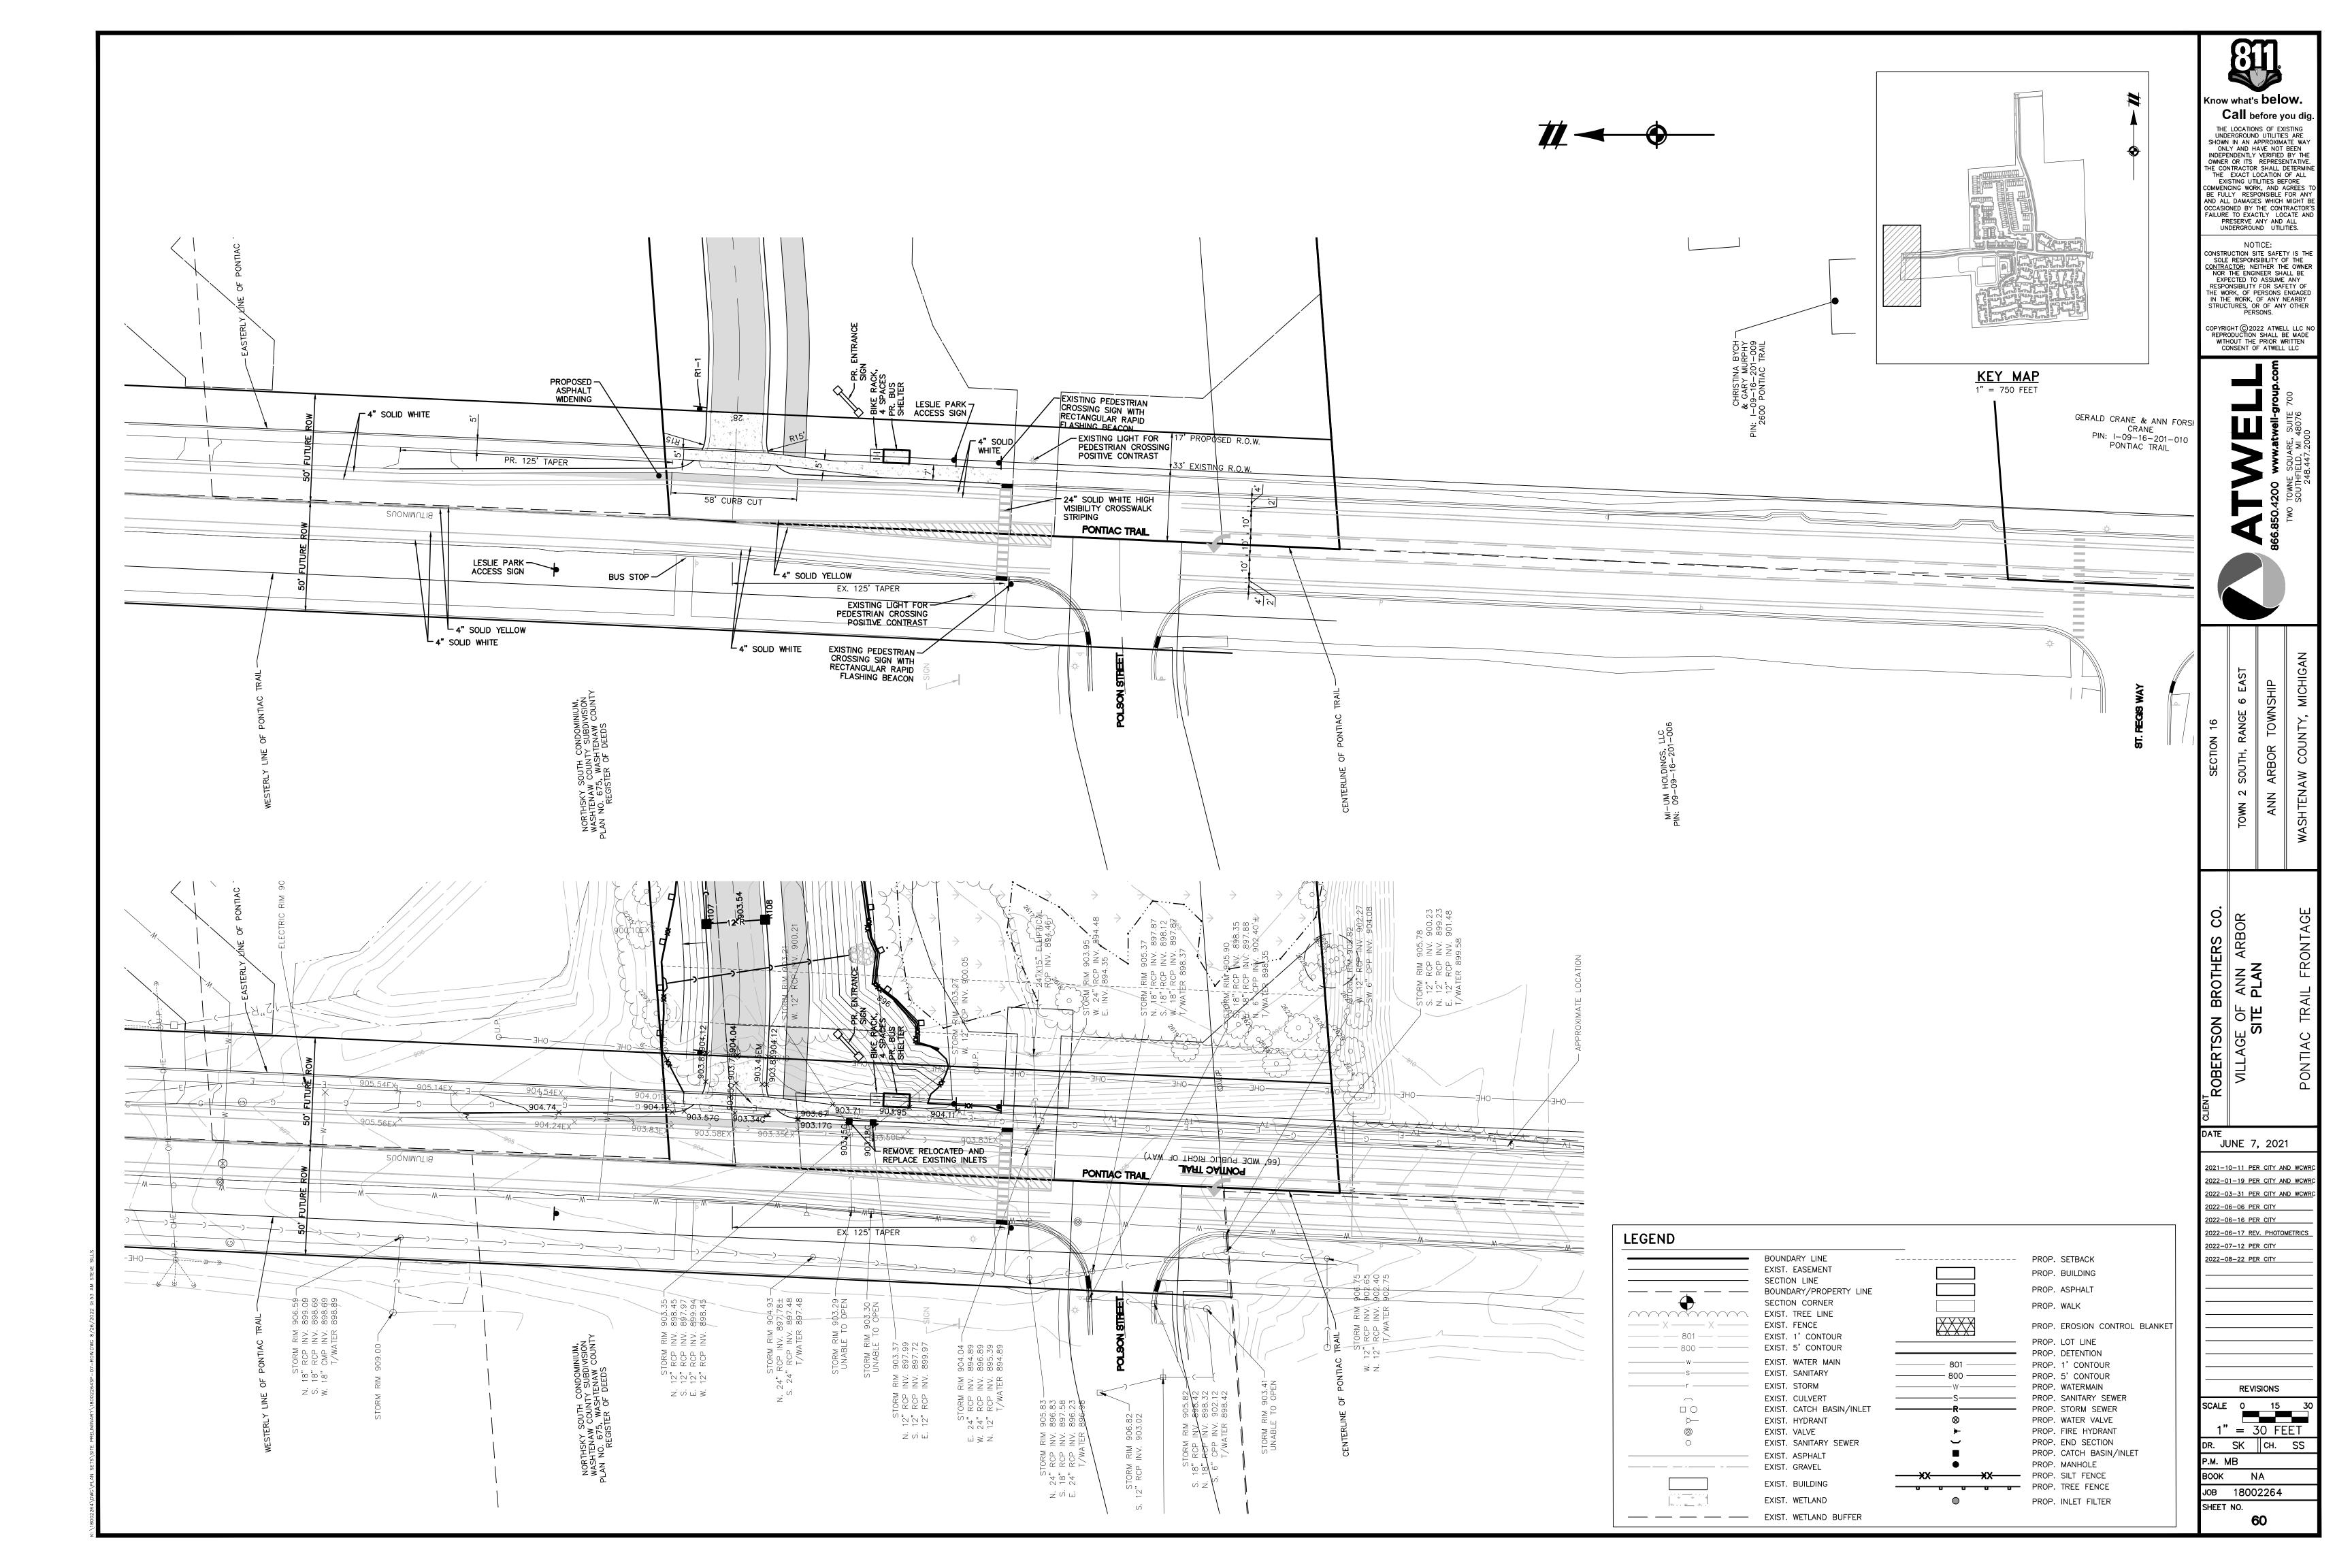


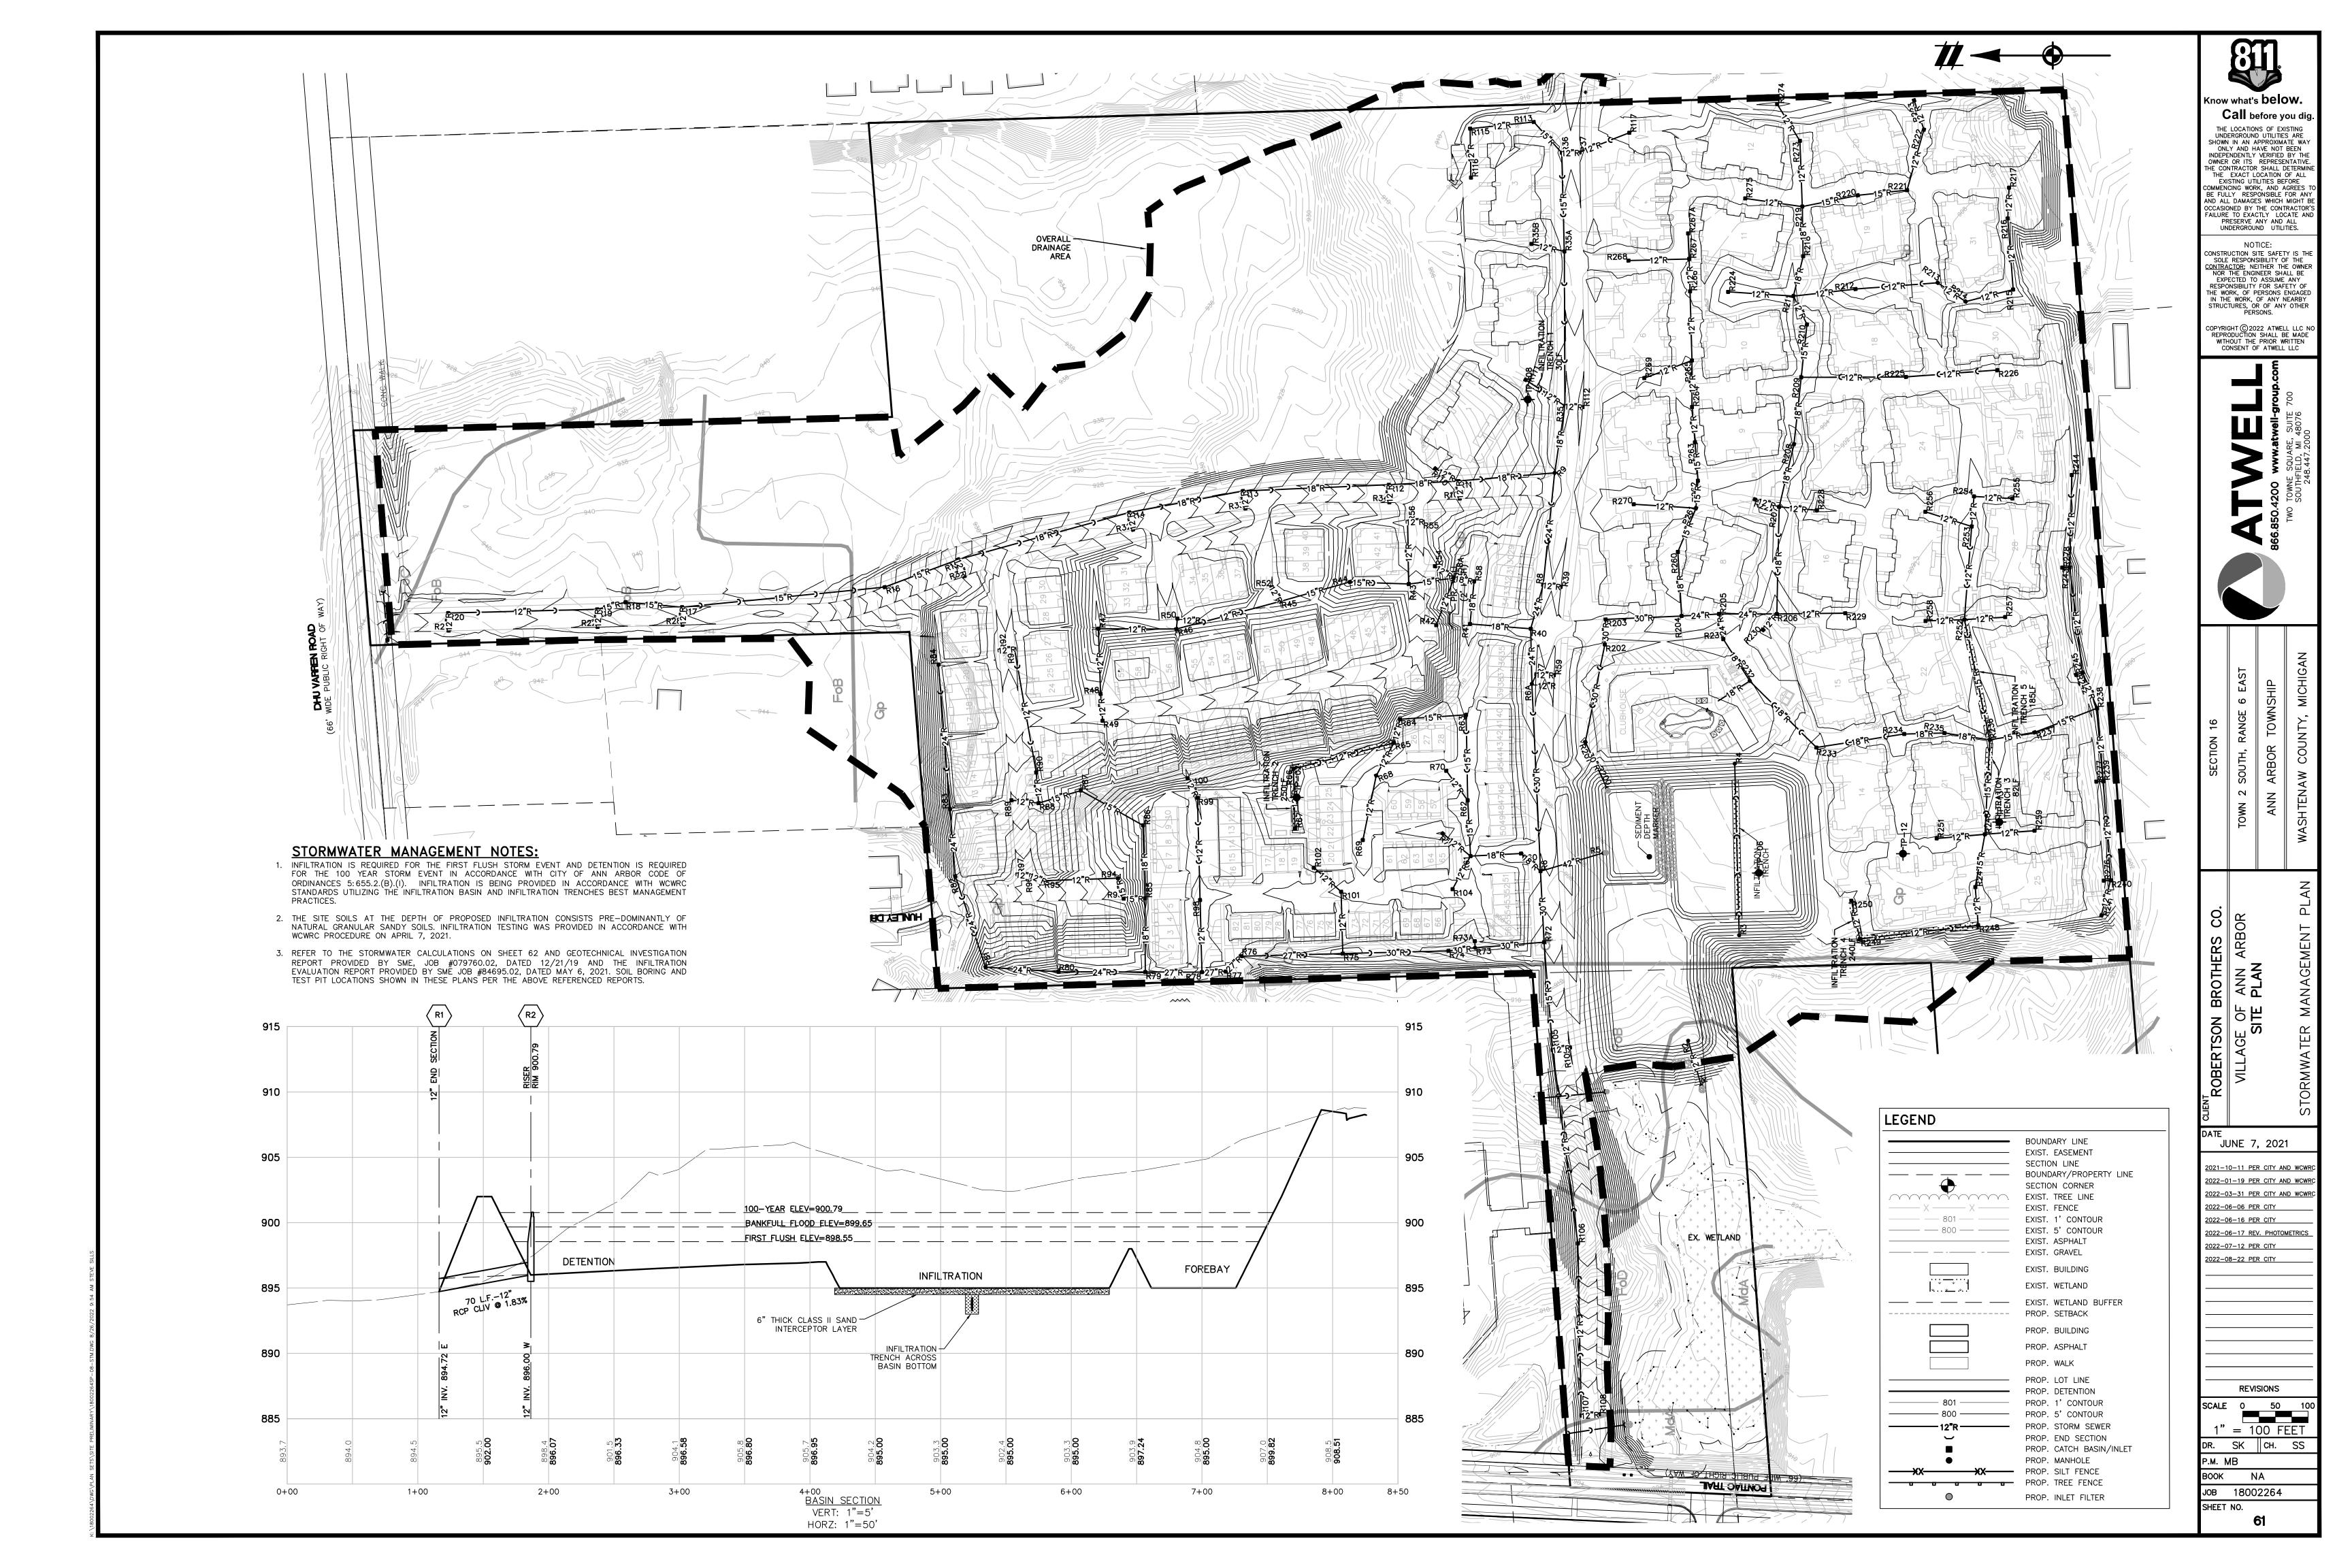


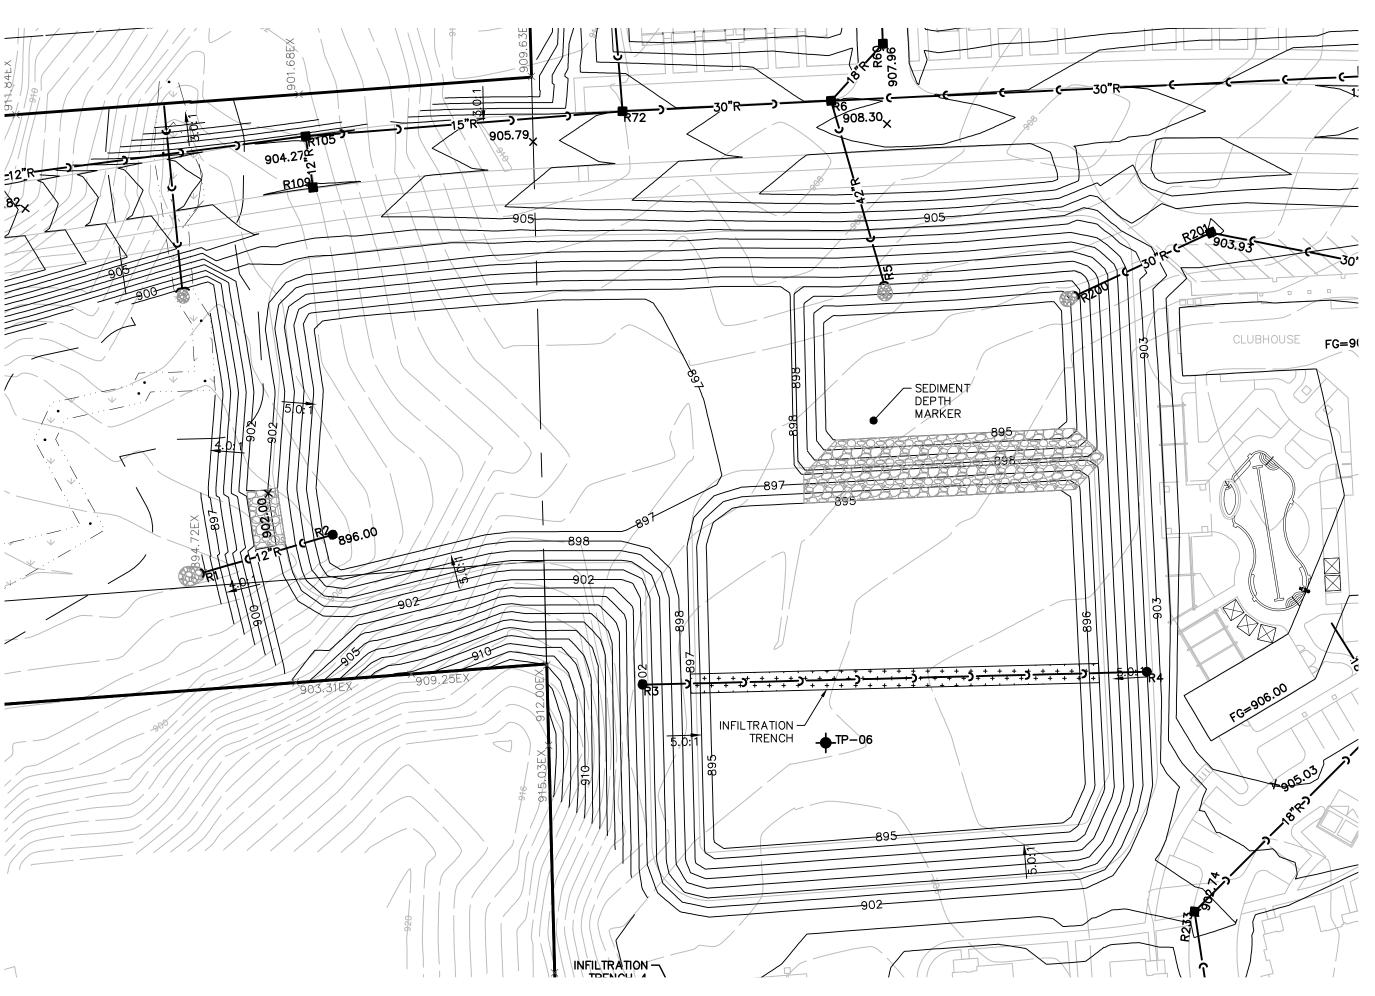

DETENTION NOTES:

1. POND BEING OVERSIZED FOR ANTICIPATION OF FUTURE DEVELOPMENT LOCATED AT NORTH END OF SITE NEAR DHU VARREN ROAD.

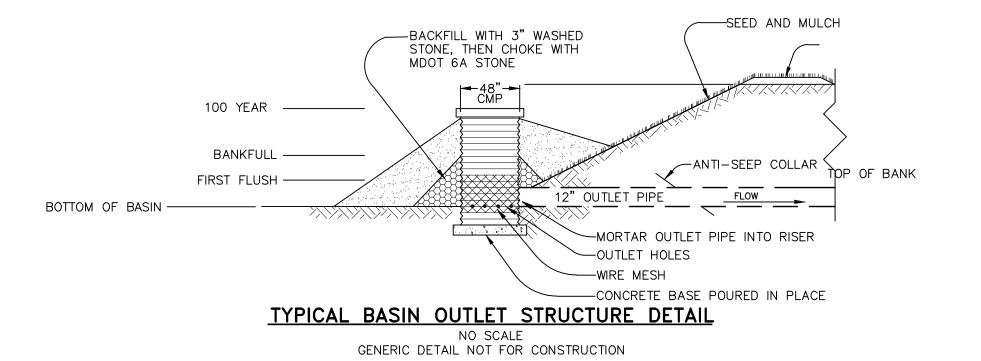

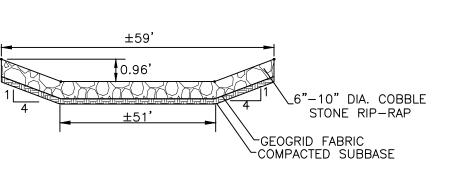

TYPICAL BASIN OVERFLOW WEIR

NO SCALE
GENERIC DETAIL NOT FOR CONSTRUCTION

DATE JUNE 7, 2021

Know what's **below. Call** before you dig.

THE LOCATIONS OF EXISTING
UNDERGROUND UTILITIES ARE
SHOWN IN AN APPROXIMATE WAY
ONLY AND HAVE NOT BEEN
INDEPENDENTLY VERIFIED BY THE
OWNER OR ITS REPRESENTATIVE.
THE CONTRACTOR SHALL DETERMINE
THE EXACT LOCATION OF ALL
EXISTING UTILITIES BEFORE
COMMENCING WORK, AND AGREES TO
BE FULLY RESPONSIBLE FOR ANY
AND ALL DAMAGES WHICH MIGHT BE
OCCASIONED BY THE CONTRACTOR'S
FAILURE TO EXACTLY LOCATE AND
PRESERVE ANY AND ALL
UNDERGROUND UTILITIES.

NO IICE:
CONSTRUCTION SITE SAFETY IS THE
SOLE RESPONSIBILITY OF THE
CONTRACTOR; NEITHER THE OWNER
NOR THE ENGINEER SHALL BE
EXPECTED TO ASSUME ANY
RESPONSIBILITY FOR SAFETY OF
THE WORK, OF PERSONS ENGAGED
IN THE WORK, OF ANY NEARBY
STRUCTURES, OR OF ANY OTHER
PERSONS.

COPYRIGHT © 2022 ATWELL LLC NO REPRODUCTION SHALL BE MADE WITHOUT THE PRIOR WRITTEN CONSENT OF ATWELL LLC

2021-10-11 PER CITY AND WCWR(
2022-01-19 PER CITY AND WCWR(
2022-03-31 PER CITY AND WCWR(
2022-06-06 PER CITY
2022-06-16 PER CITY

2022-06-17 REV. PHOTOMETRICS 2022-07-12 PER CITY 2022-08-22 PER CITY

REVISIONS

1" = 50 FEET


DR. SK CH. SS

P.M. MB

BOOK NA

JOB 18002264

SHEET NO.

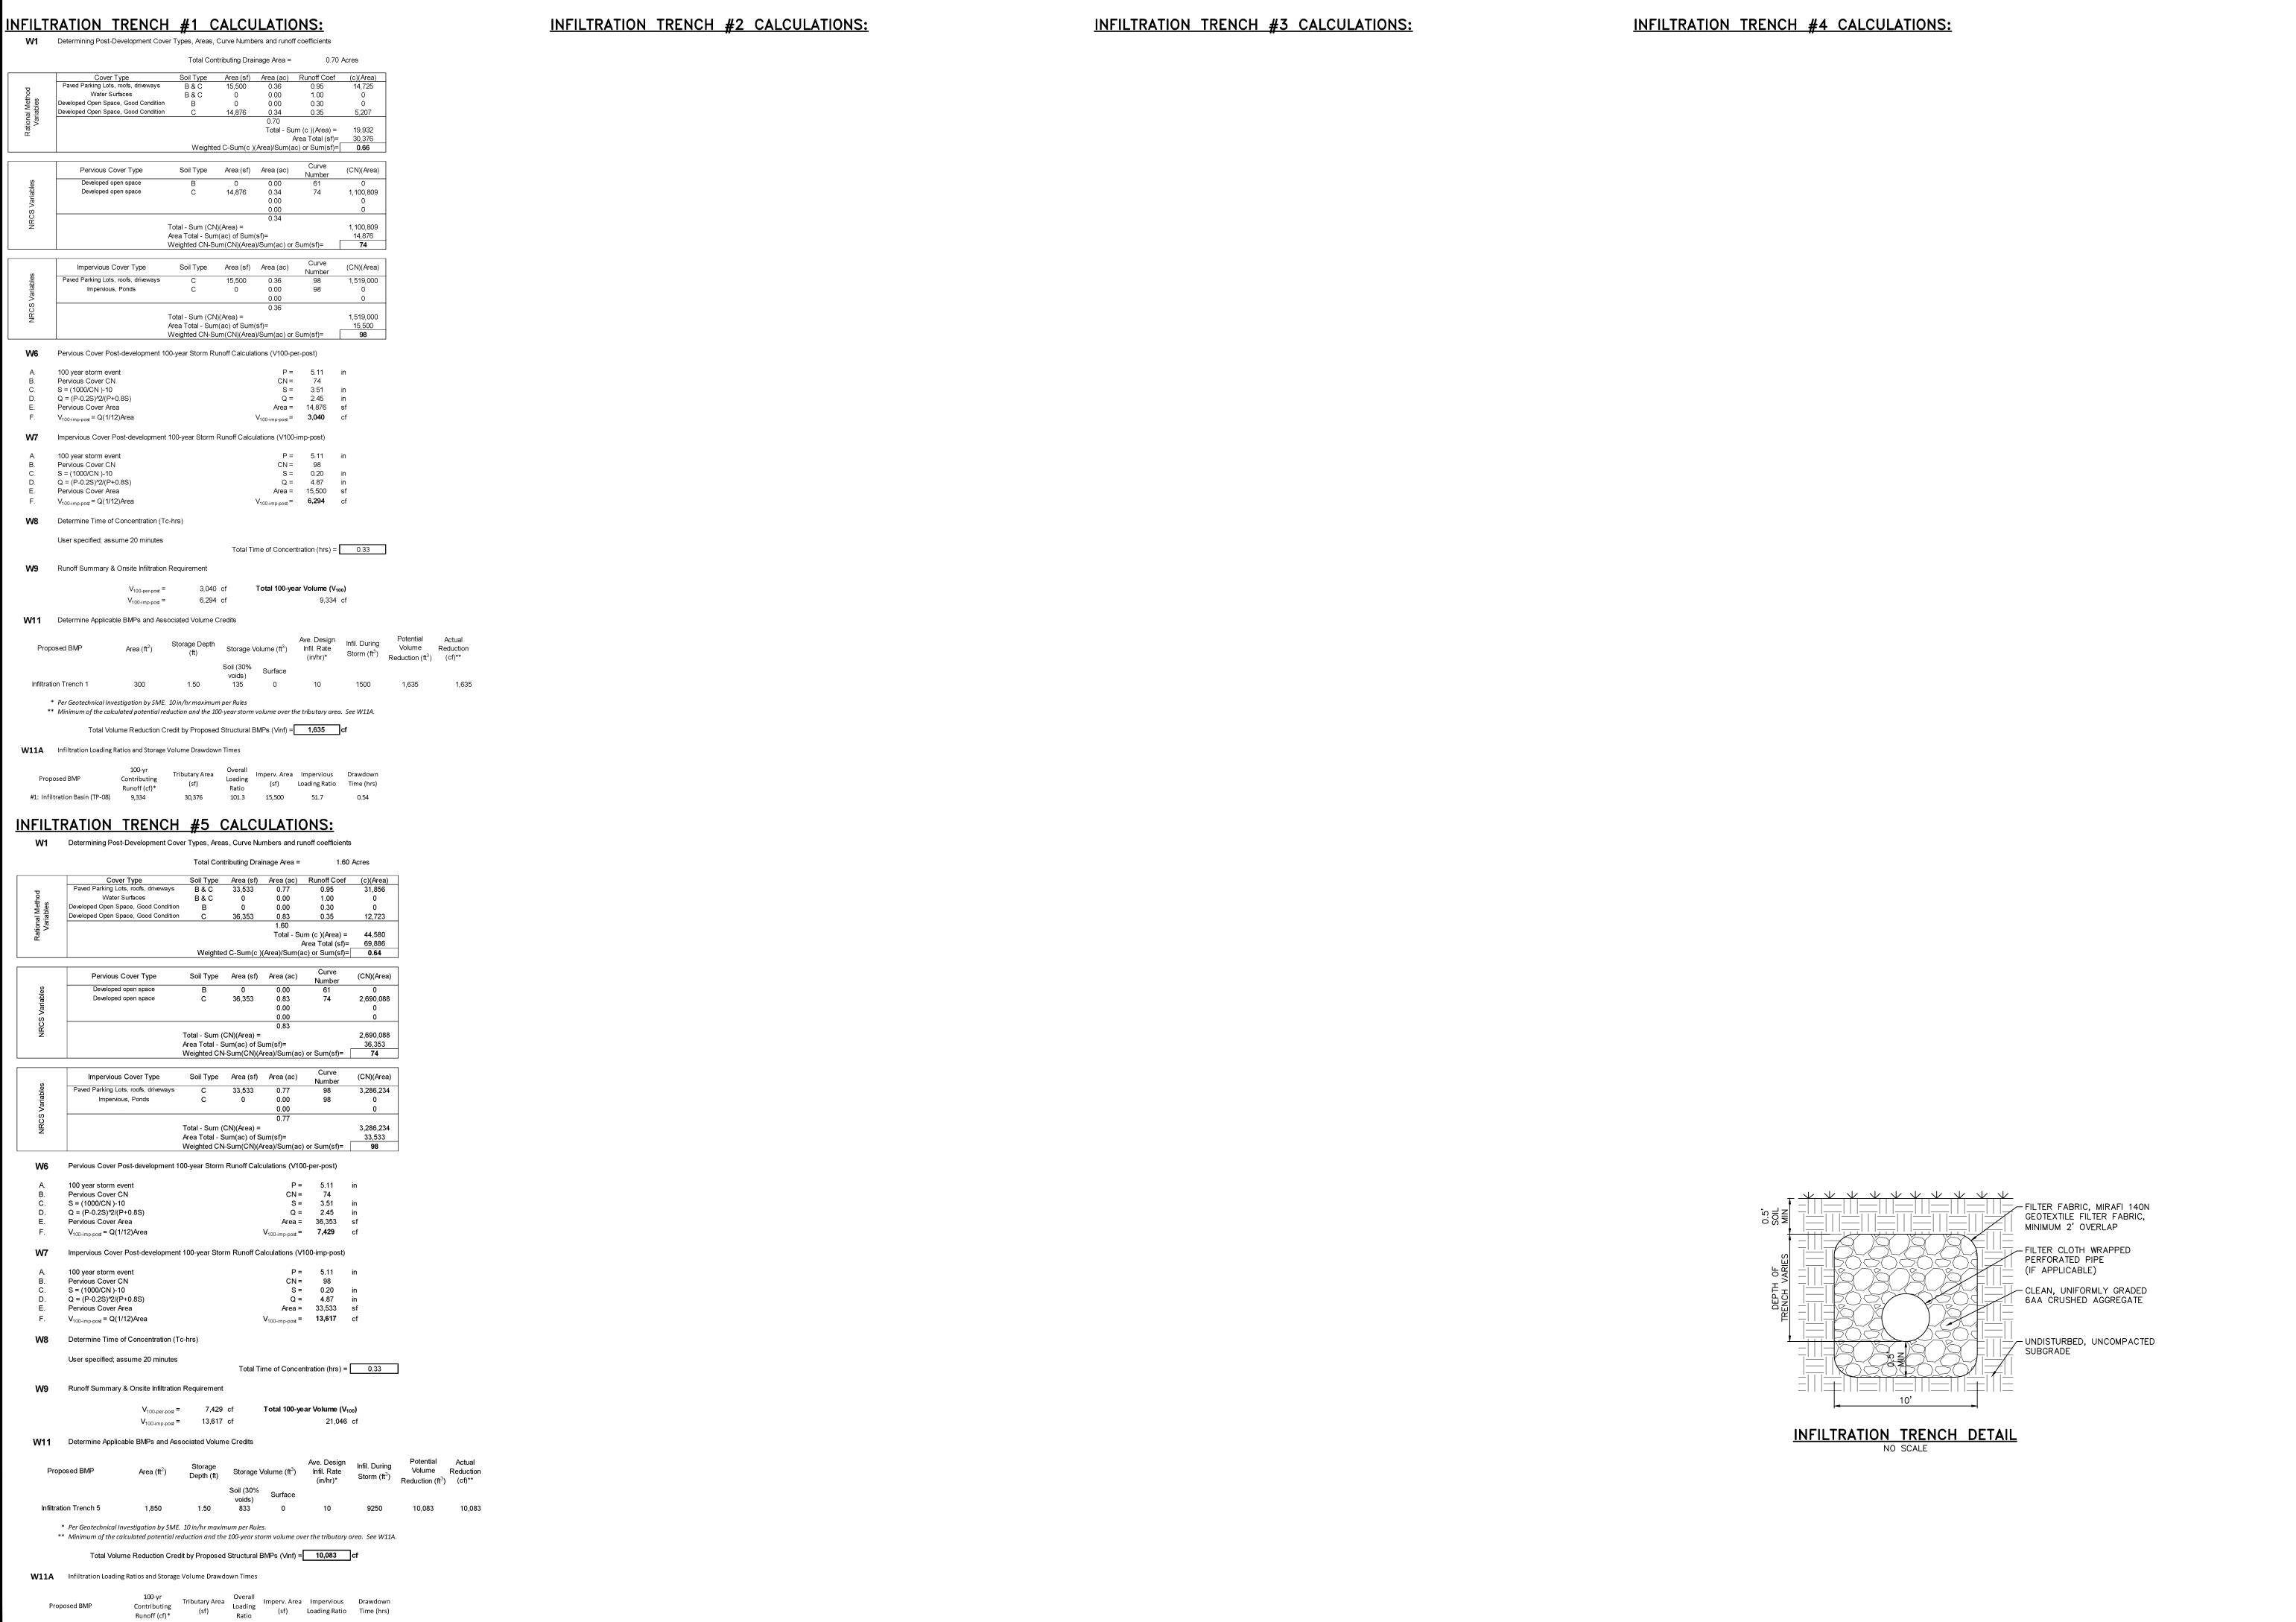

Runoff (cf)*

#1: Infiltration Basin (TP-13 21,046 69,886 37.8 33,533 18.1 0.54

Know what's **below.**

Call before you dig THE LOCATIONS OF EXISTING UNDERGROUND UTILITIES ARE
SHOWN IN AN APPROXIMATE WAY
ONLY AND HAVE NOT BEEN
INDEPENDENTLY VERIFIED BY THE
OWNER OR ITS REPRESENTATIVE. OWNER OR ITS REPRESENTATIVE.
THE CONTRACTOR SHALL DETERMIN
THE EXACT LOCATION OF ALL
EXISTING UTILITIES BEFORE
COMMENCING WORK, AND AGREES THE
BE FULLY RESPONSIBLE FOR ANY ND ALL DAMAGES WHICH MIGHT I OCCASIONED BY THE CONTRACTOR'S
FAILURE TO EXACTLY LOCATE AND
PRESERVE ANY AND ALL
UNDERGROUND UTILITIES.

CONSTRUCTION SITE SAFETY IS THE SOLE RESPONSIBILITY OF THE CONTRACTOR; NEITHER THE OWNER NOR THE ENGINEER SHALL BE EXPECTED TO ASSUME ANY RESPONSIBILITY FOR SAFETY OF THE WORK, OF PERSONS ENGAGED IN THE WORK, OF PERSONS ENGAGED IN THE WORK, OF PERSONS ENGAGED IN THE WORK, OF ANY NEARBY STRUCTURES, OR OF ANY OTHER PERSONS.

COPYRIGHT © 2022 ATWELL LLC NO REPRODUCTION SHALL BE MADE WITHOUT THE PRIOR WRITTEN CONSENT OF ATWELL LLC

ATION -

JUNE 7, 2021

2021-10-11 PER CITY AND WCWR 2022-01-19 PER CITY AND WCW 2022-03-31 PER CITY AND WCWR 2022-06-06 PER CITY


2022-06-16 PER CITY 2022-06-17 REV. PHOTOMETRICS 2022-07-12 PER CITY


2022-08-22 PER CITY


REVISIONS SCALE 0 --

NO SCALE DR. SK CH. SS P.M. MB


BOOK NA JOB 18002264 SHEET NO.

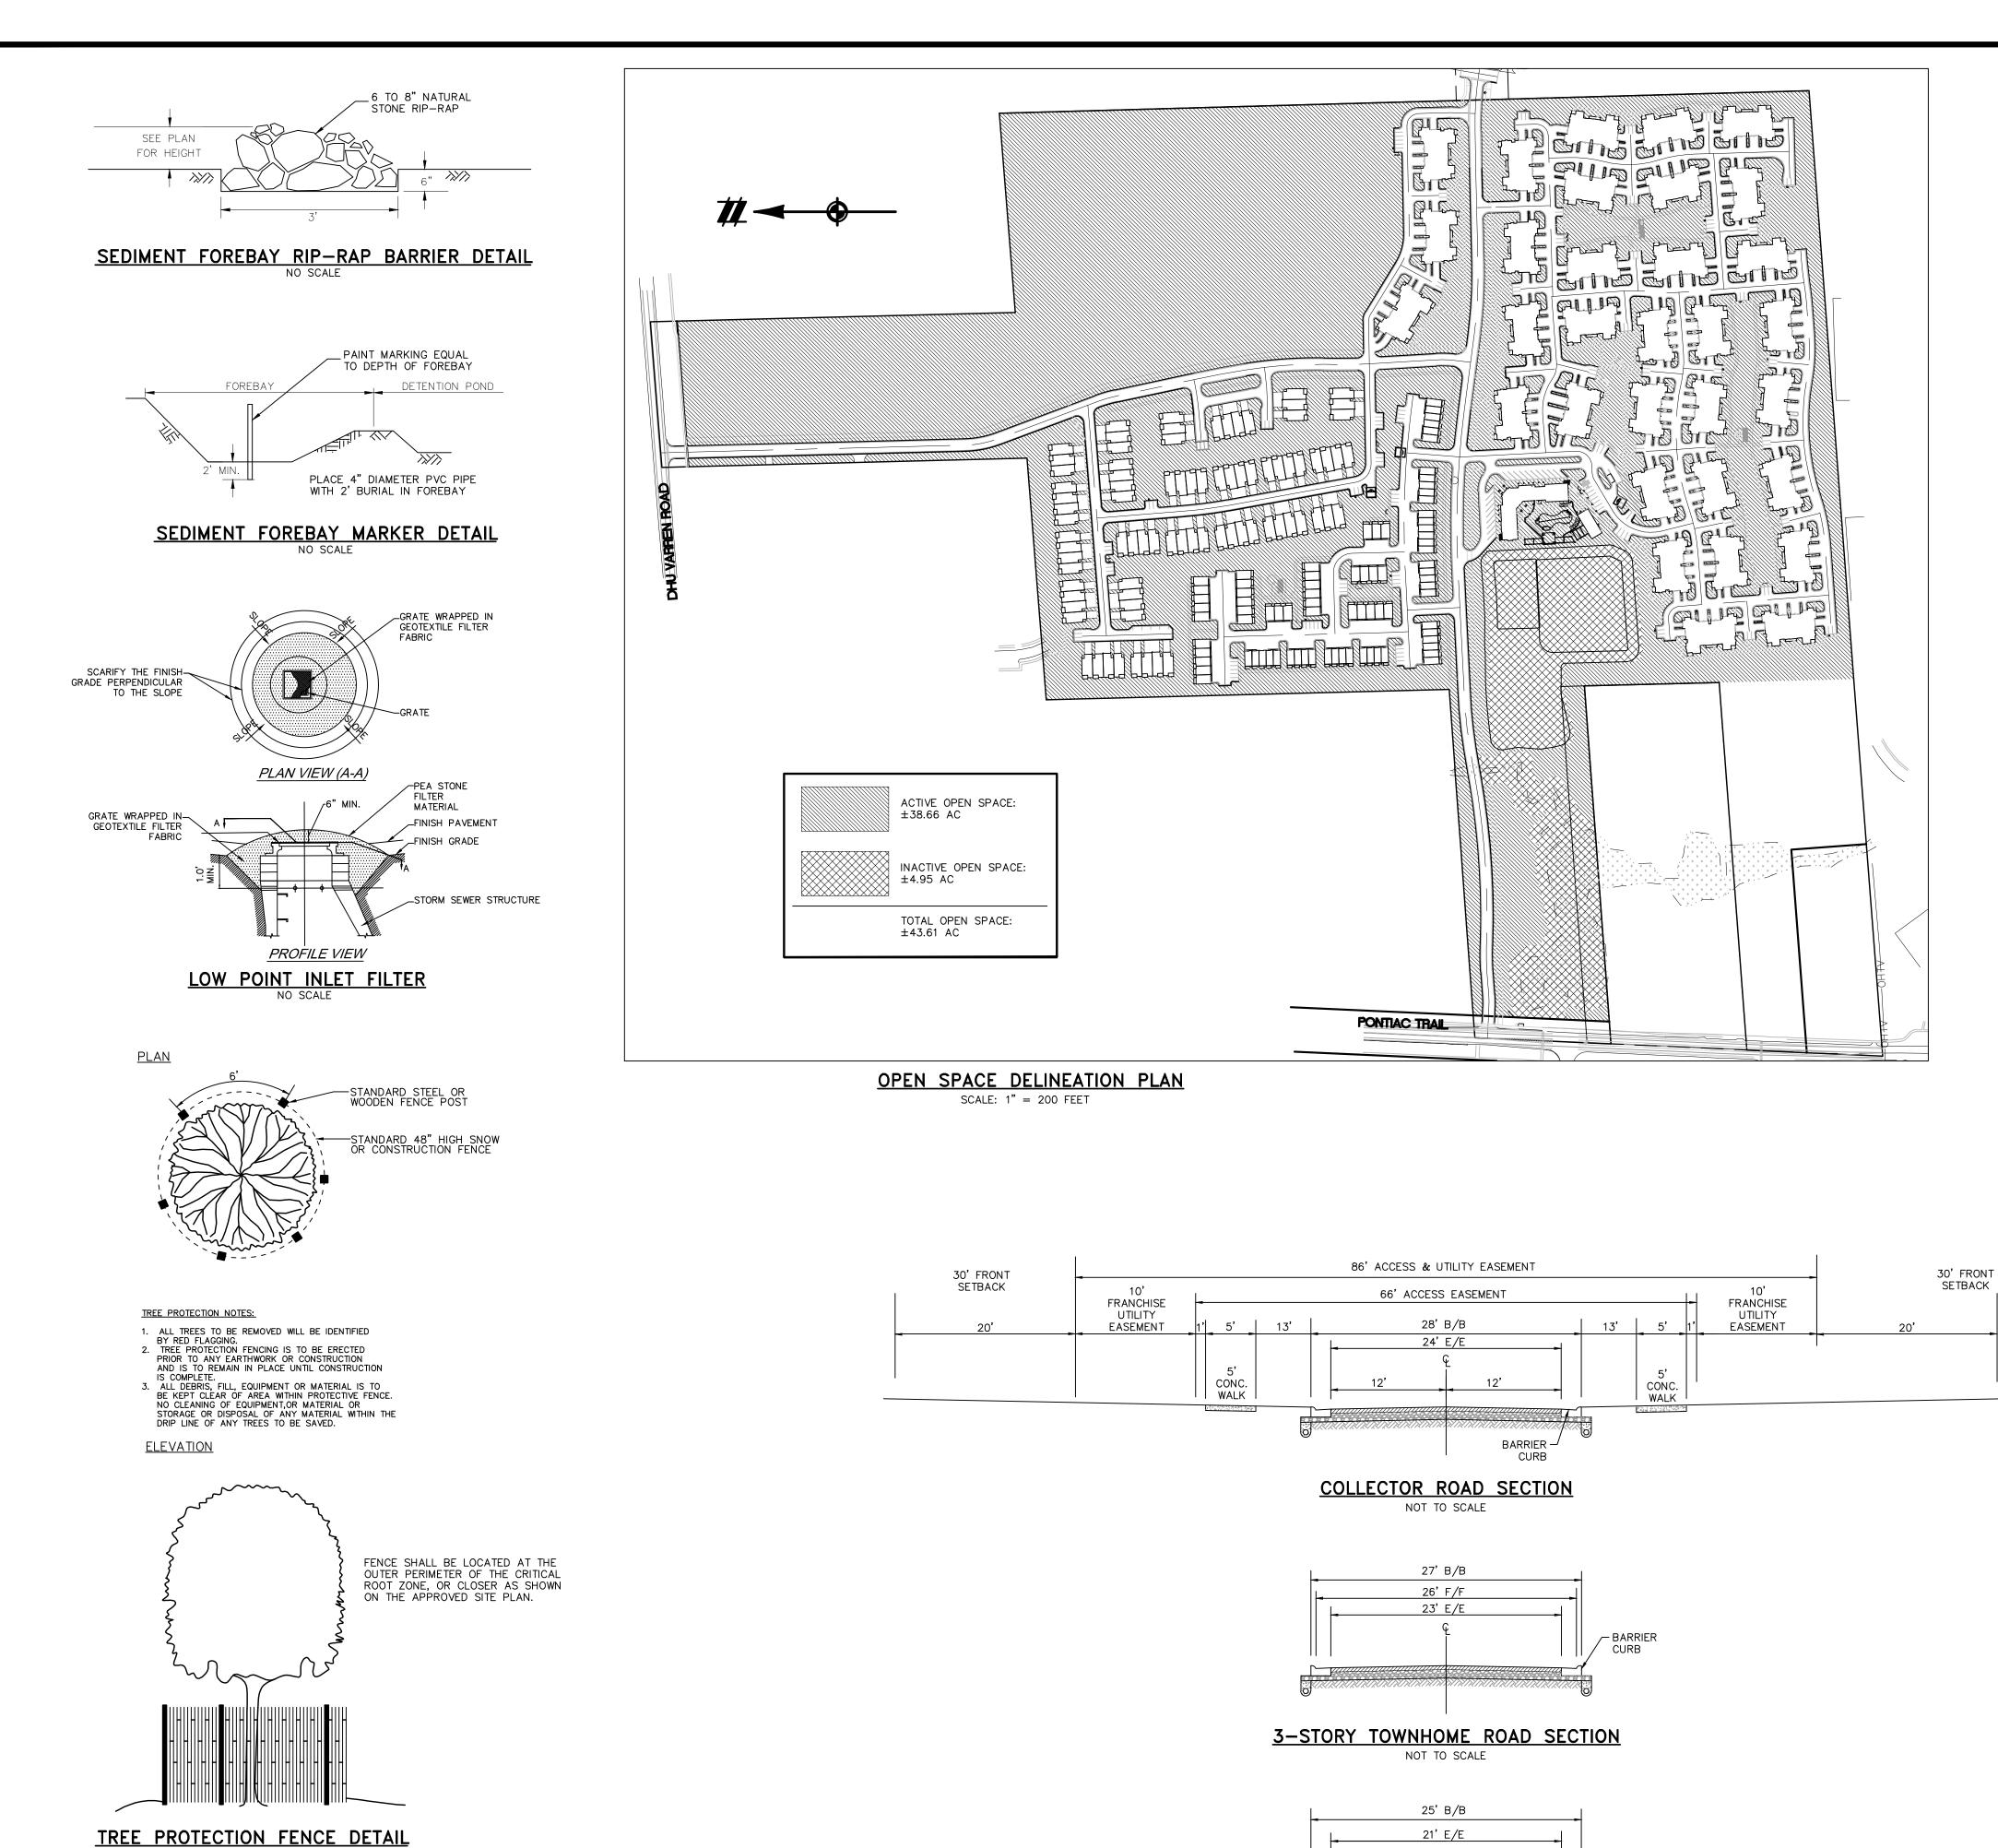

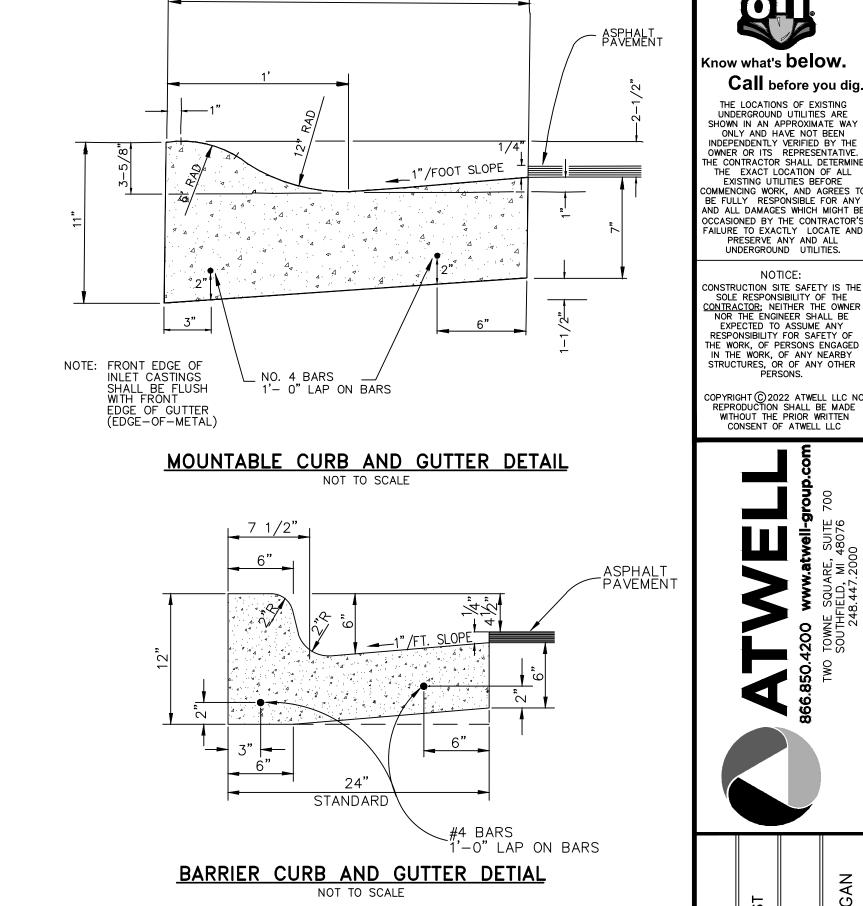

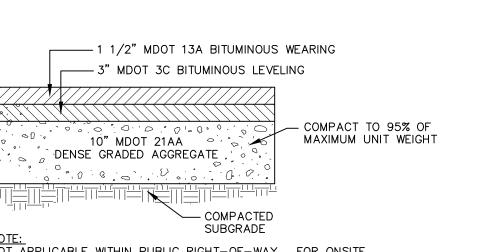

NOTE:
NOT APPLICABLE WITHIN PUBLIC RIGHT—OF—WAY. FOR ONSITE
USE ONLY. PAVEMENT WITHIN THE RIGHT OF WAY SHALL CONFORM TO CITY OF ANN ARBOR STANDARDS. **COLLECTOR ROAD PAVING SECTION** NO SCALE

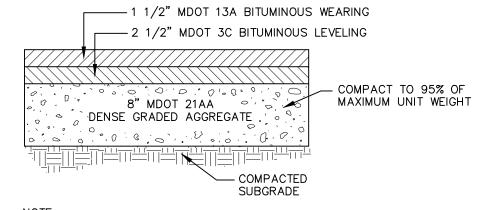

CITY OF ANN ARBOR STANDARDS. TOWNHOME, APARTMENT AND PARKING AREA PAVING SECTION

NOTE: NOT APPLICABLE WITHIN PUBLIC RIGHT—OF—WAY. FOR ONSITE USE ONLY. PAVEMENT WITHIN THE RIGHT OF WAY SHALL CONFORM TO

REVISIONS

JUNE 7, 2021

2021-10-11 PER CITY AND WCWR

2022-01-19 PER CITY AND WCW

2022-03-31 PER CITY AND WCWR

2022-06-06 PER CITY

2022-06-16 PER CITY 2022-06-17 REV. PHOTOMETRICS 2022-07-12 PER CITY

2022-08-22 PER CITY


NO SCALE SK CH. SS P.M. MB

BOOK NA JOB 18002264

SHEET NO. 64

2-STORY TOWNHOME AND APARTMENT ROAD SECTION NOT TO SCALE

/- MOUNTABLE CURB

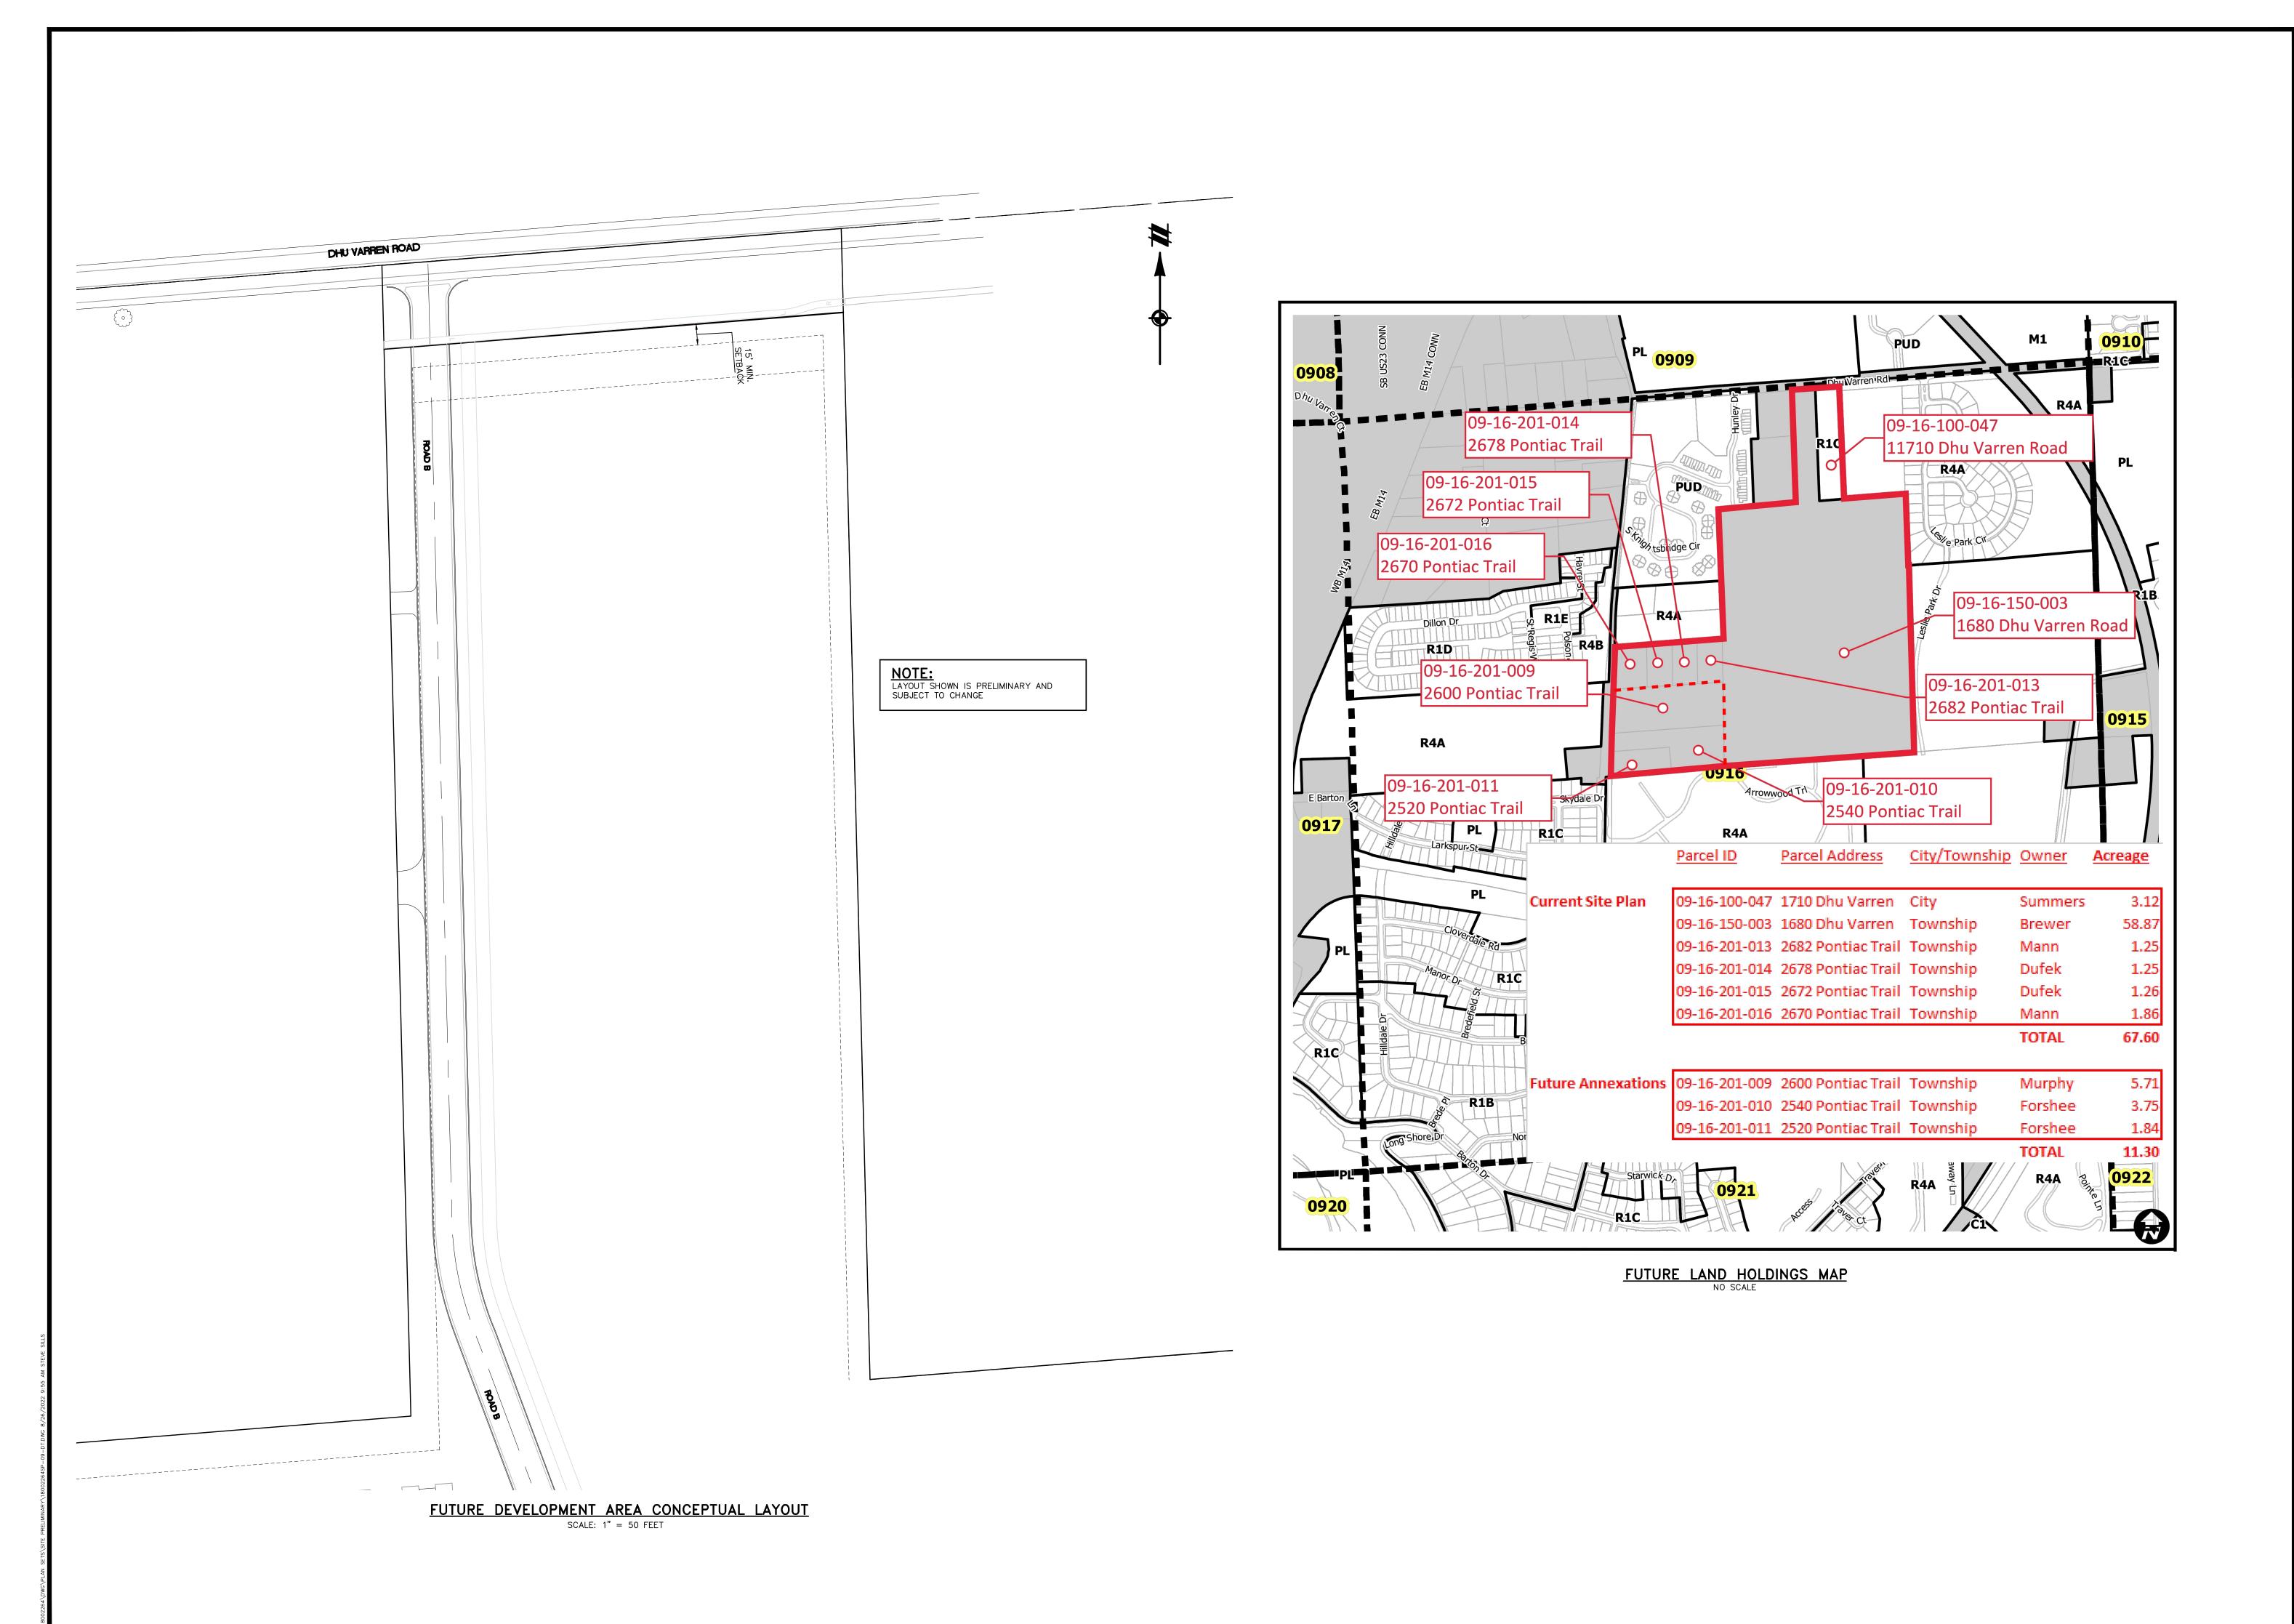

Know what's below.

THE LOCATIONS OF EXISTING UNDERGROUND UTILITIES ARE SHOWN IN AN APPROXIMATE WAY ONLY AND HAVE NOT BEEN INDEPENDENTLY VERIFIED BY THE OWNER OR ITS REPRESENTATIVE. THE CONTRACTOR SHALL DETERMINE THE EXACT LOCATION OF ALL EXISTING UTILITIES BEFORE COMMENCING WORK, AND AGREES TO BE FULLY RESPONSIBLE FOR ANY AND ALL DAMAGES WHICH MIGHT BE OCCASIONED BY THE CONTRACTOR'S FAILURE TO EXACTLY LOCATE AND PRESERVE ANY AND ALL UNDERGROUND UTILITIES.

NOTICE:

CONSTRUCTION SITE SAFETY IS THE SOLE RESPONSIBILITY OF THE CONTRACTOR; NEITHER THE OWNER NOR THE ENGINEER SHALL BE EXPECTED TO ASSUME ANY RESPONSIBILITY FOR SAFETY OF THE WORK, OF PERSONS ENGAGED IN THE WORK, OF ANY NEARBY STRUCTURES, OR OF ANY OTHER PERSONS.

COPYRIGHT © 2022 ATWELL LLC N REPRODUCTION SHALL BE MADE WITHOUT THE PRIOR WRITTEN CONSENT OF ATWELL LLC

866.850.4200 www.atwell-group.com
TWO TOWNE SQUARE, SUITE 700
SOUTHFIELD, MI 48076
248.447.2000

SECTION 16

N 2 SOUTH, RANGE 6 EAST

NN ARBOR TOWNSHIP

TENAW COUNTY, MICHIGAN

VILLAGE OF ANN ARBOR

SITE PLAN

STANDARD DETAILS 2

TE JUNE 7, 2021

2021-10-11 PER CITY AND WCWR 2022-01-19 PER CITY AND WCWR 2022-03-31 PER CITY AND WCWR 2022-06-06 PER CITY

2022-06-16 PER CITY 2022-06-17 REV. PHOTOMETI

2022-06-17 REV. PHOTOMETRICS 2022-07-12 PER CITY 2022-08-22 PER CITY

REVISIONS

SCALE 0 --

AS NOTED

DR. SK CH. SS


P.M. MB


P.M. MB

BOOK NA

JOB 18002264

SHEET NO.

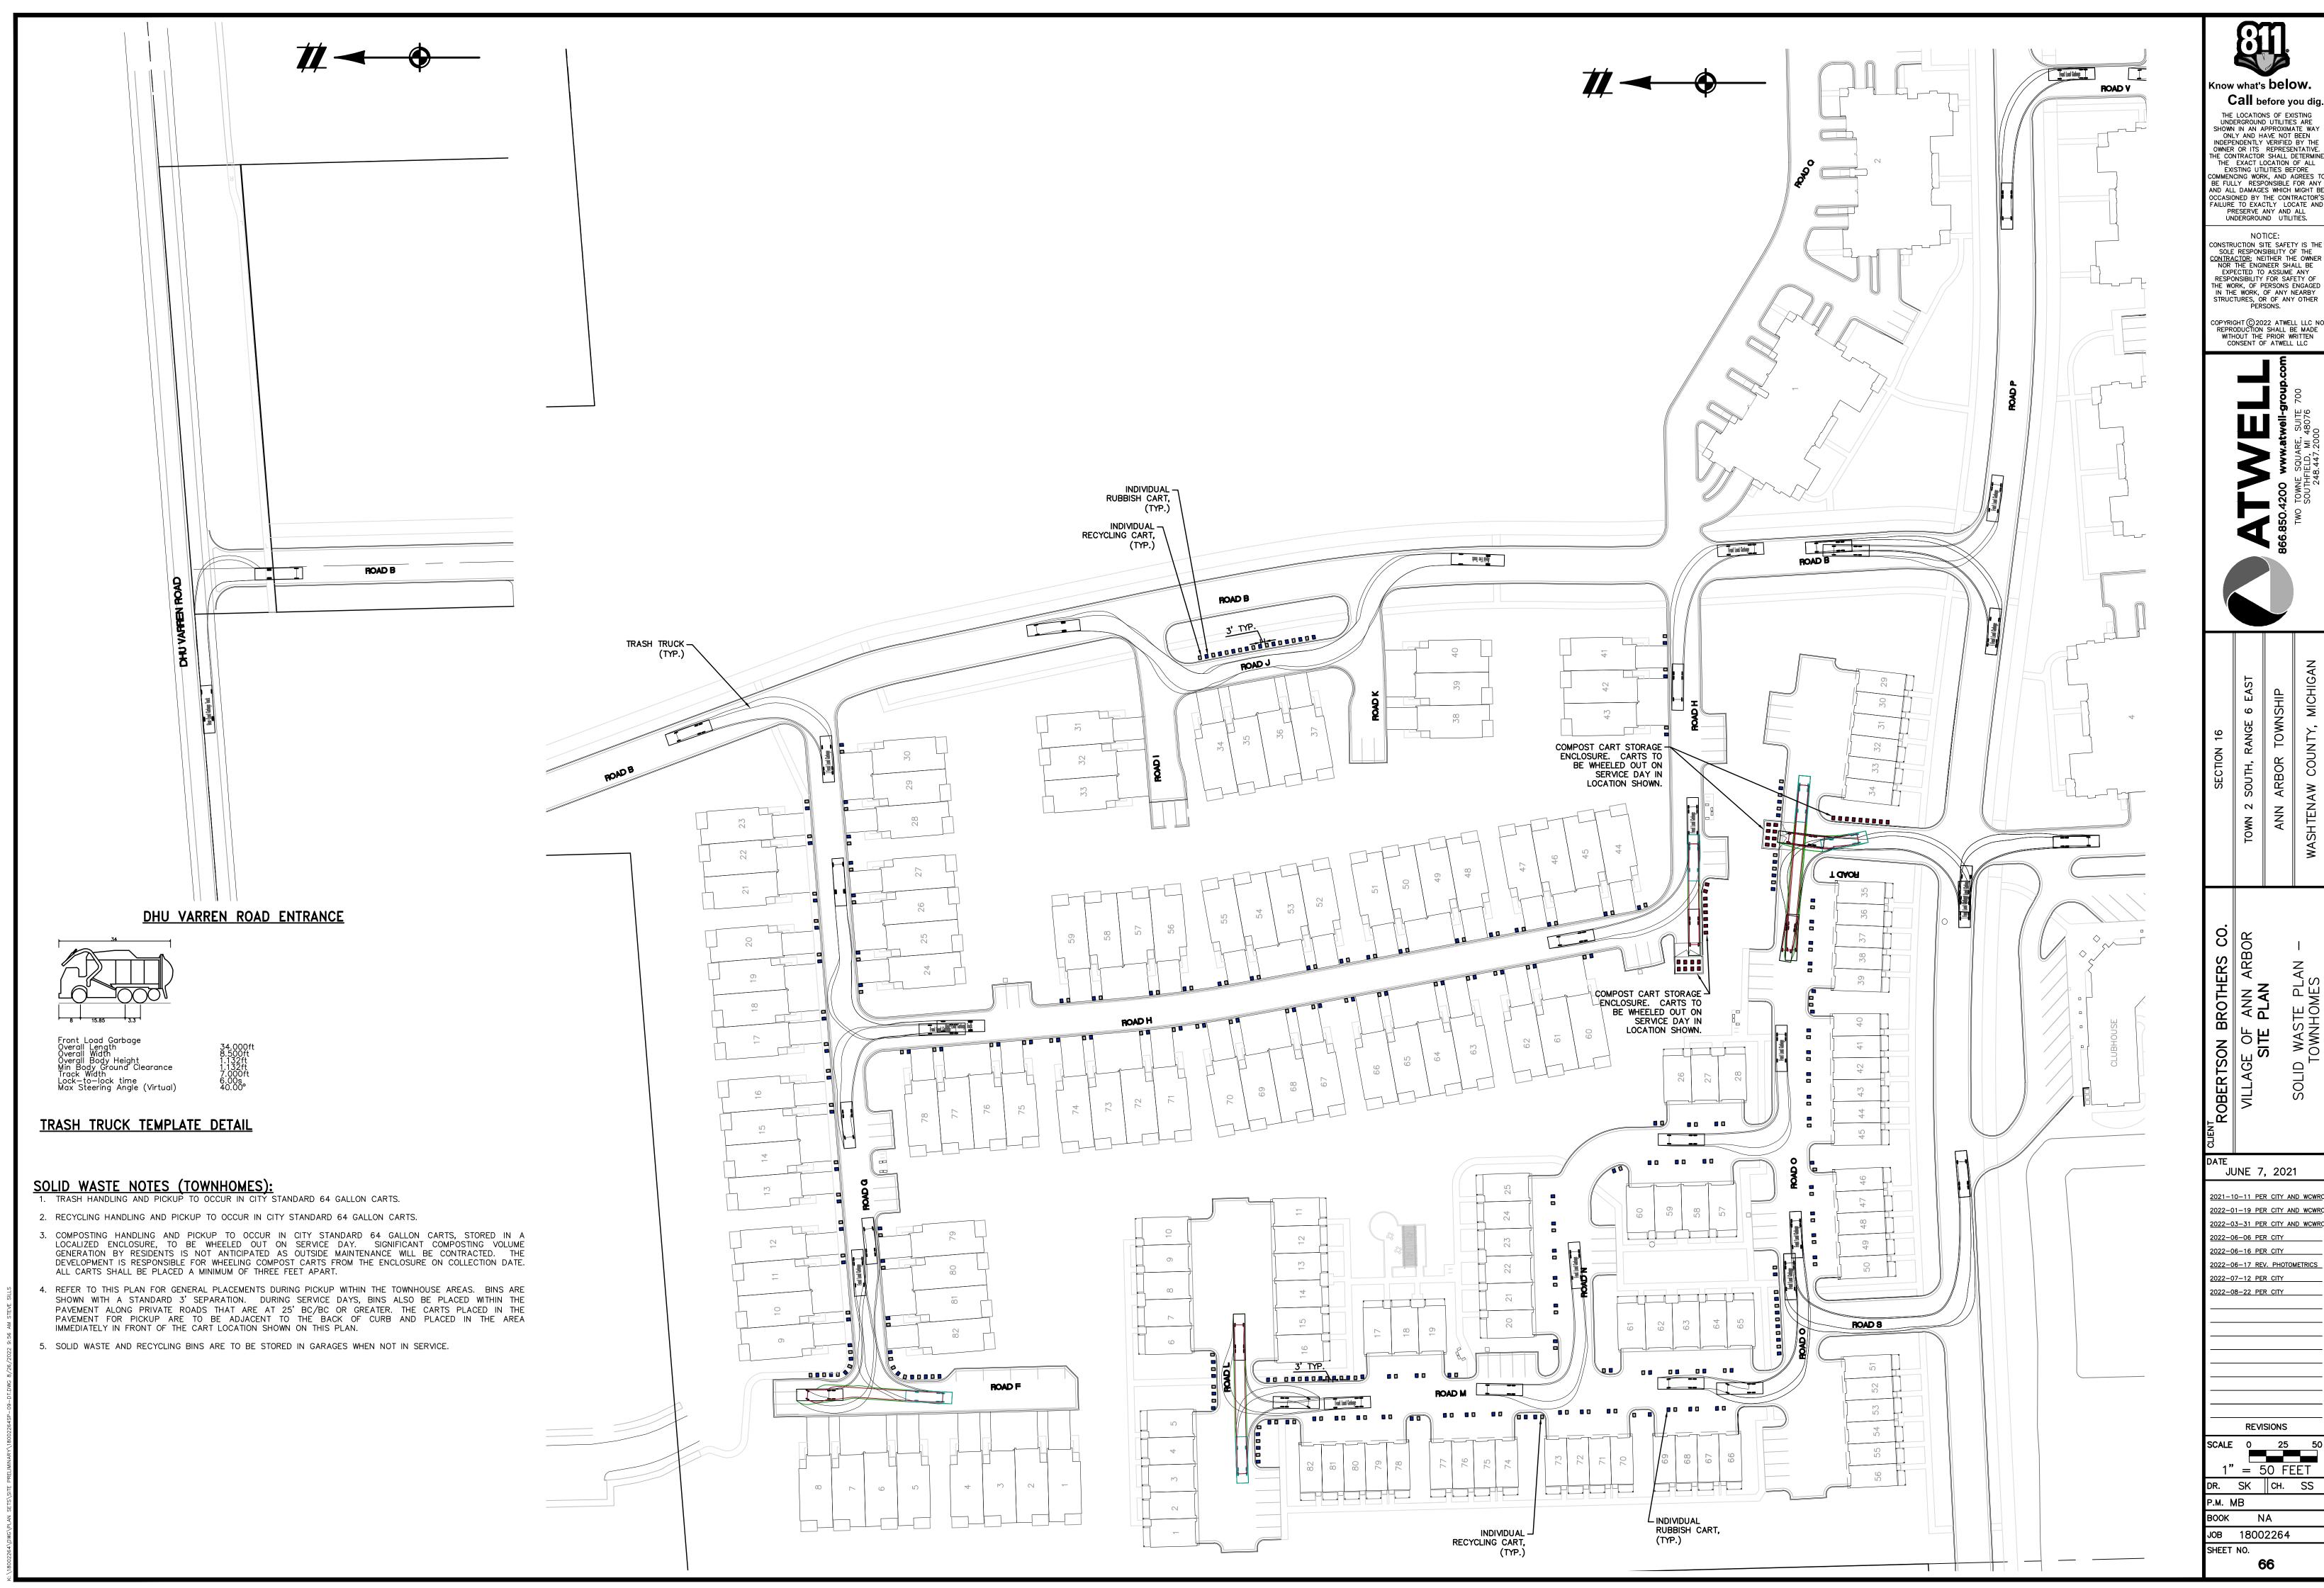

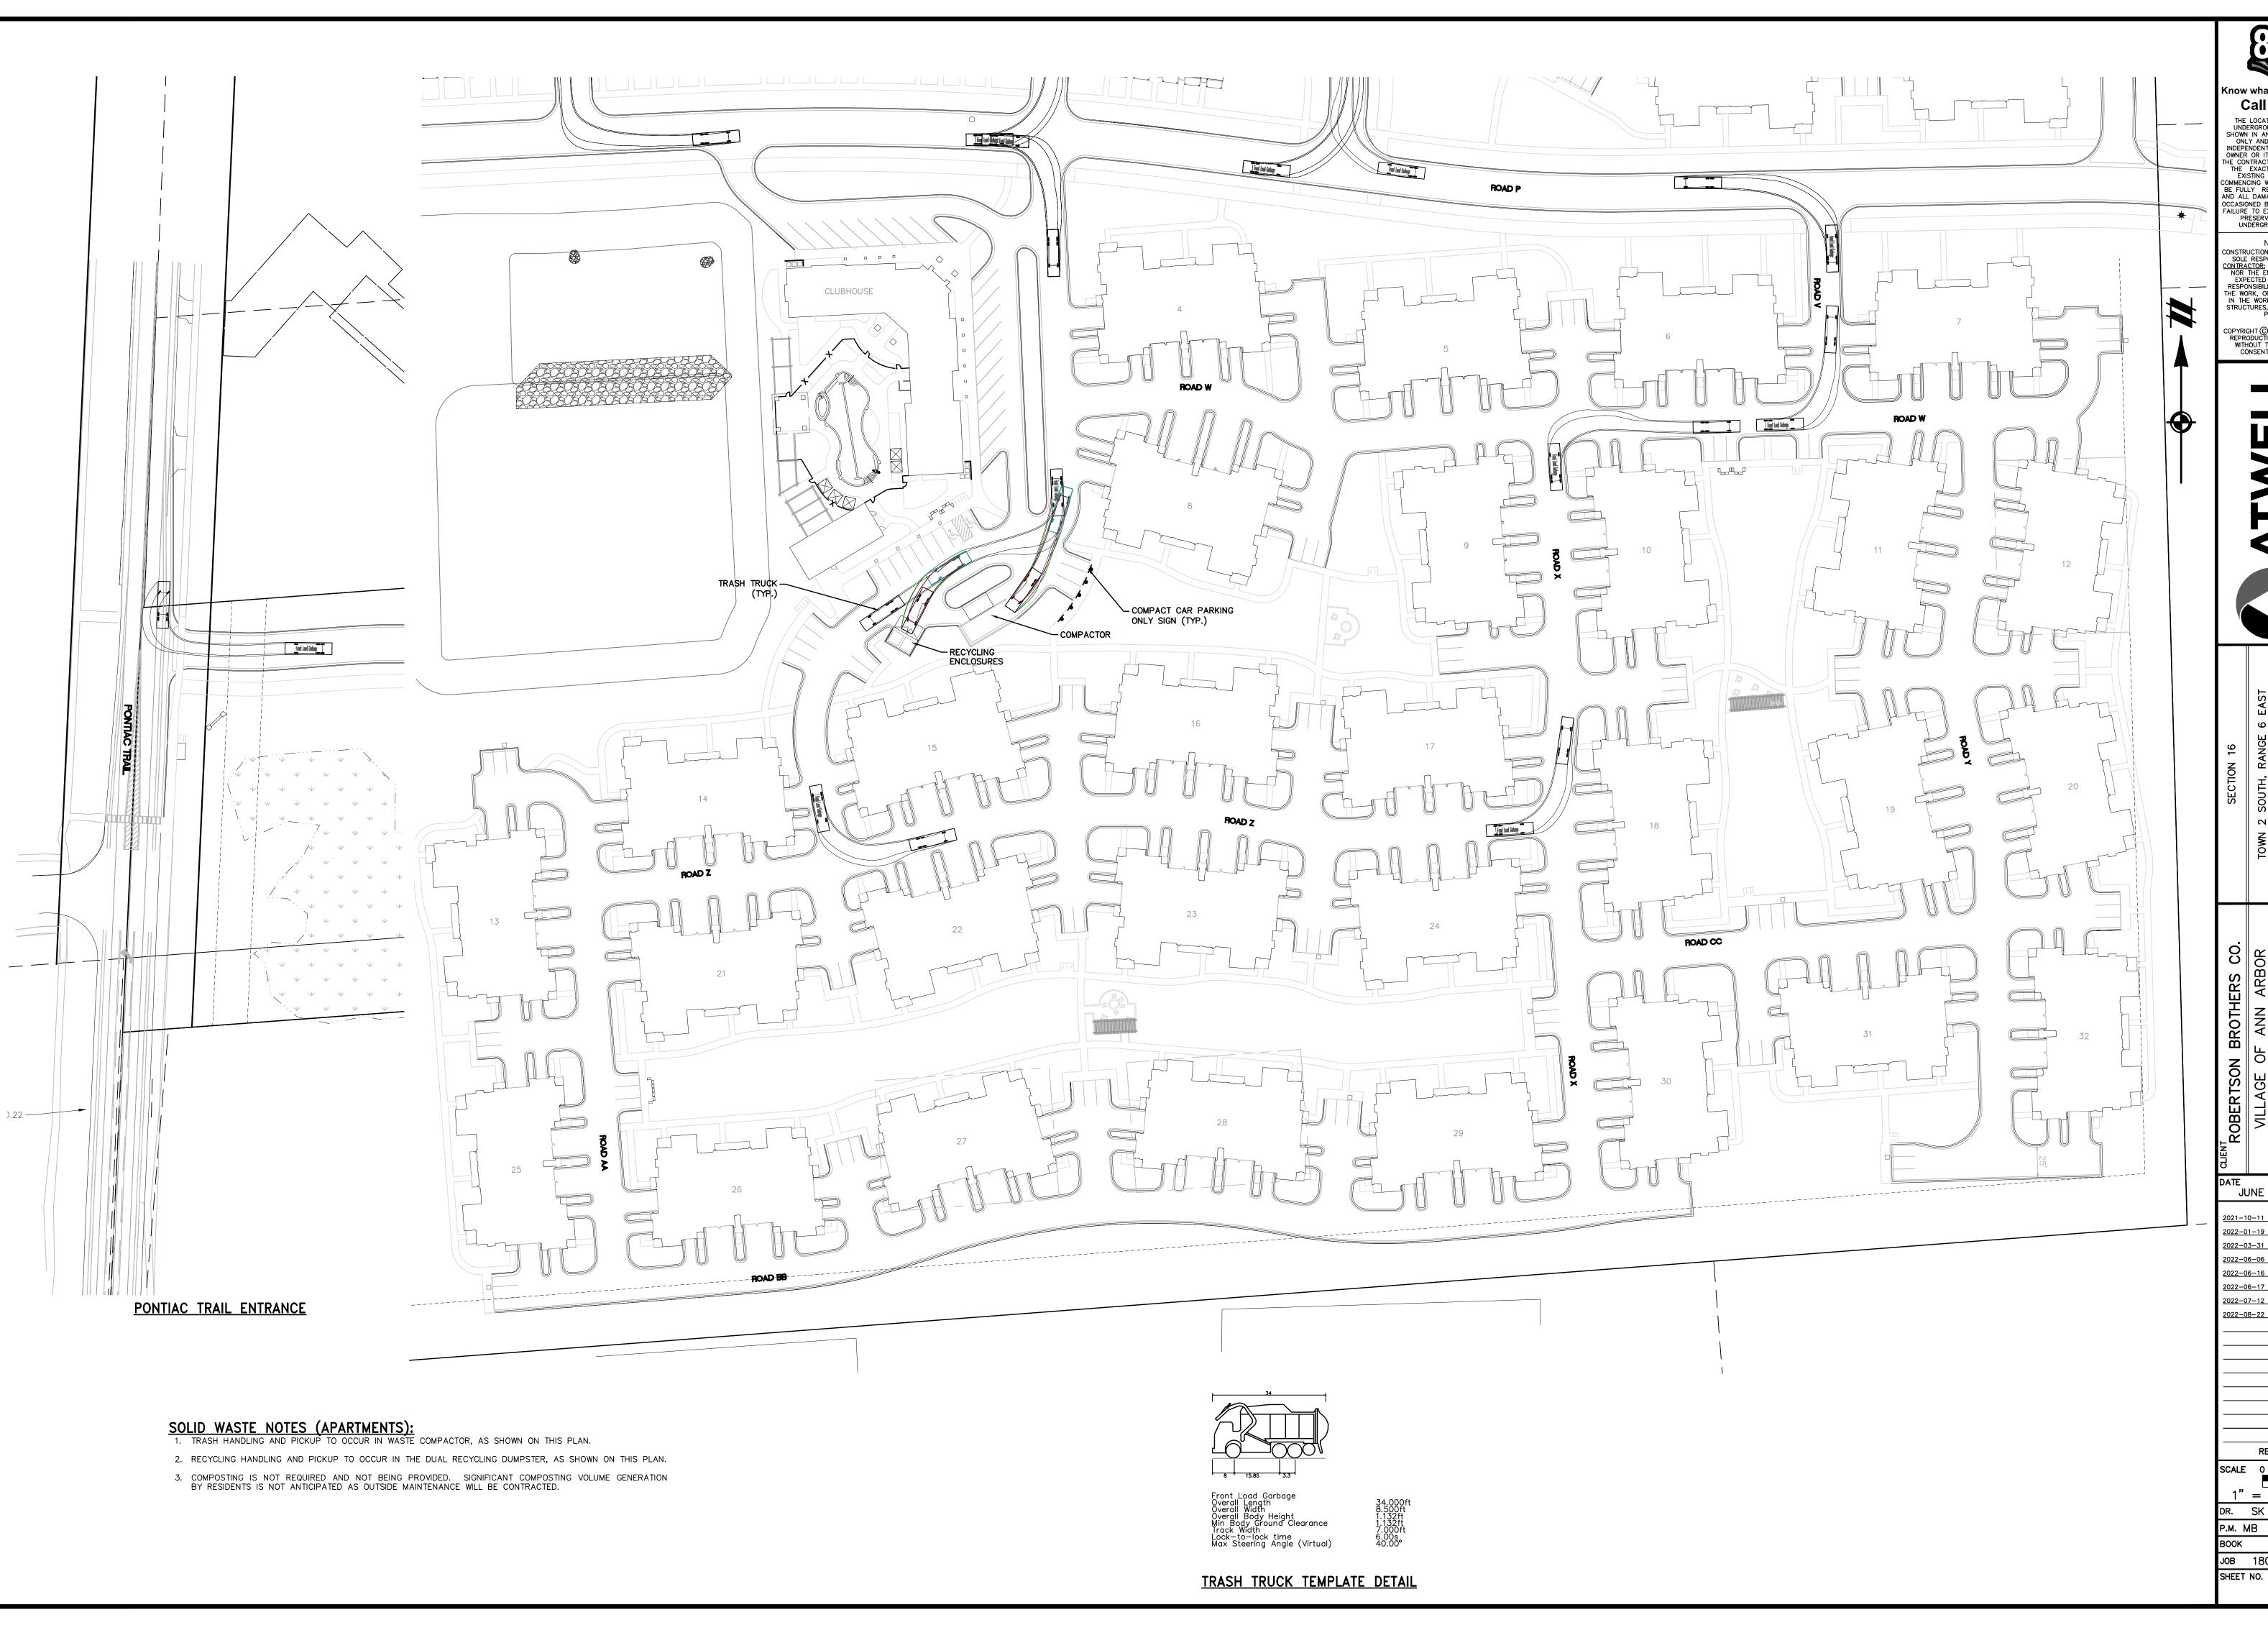

Know what's below. Call before you dig.

THE LOCATIONS OF EXISTING UNDERGROUND UTILITIES ARE SHOWN IN AN APPROXIMATE WAY ONLY AND HAVE NOT BEEN INDEPENDENTLY VERIFIED BY THE OWNER OR ITS REPRESENTATIVE. THE CONTRACTOR SHALL DETERMINE THE EXACT LOCATION OF ALL EXISTING UTILITIES BEFORE COMMENCING WORK, AND AGREES TO BE FULLY RESPONSIBLE FOR ANY AND ALL DAMAGES WHICH MIGHT BE OCCASIONED BY THE CONTRACTOR'S FAILURE TO EXACTLY LOCATE AND PRESERVE ANY AND ALL UNDERGROUND UTILITIES.

NO IICE:

CONSTRUCTION SITE SAFETY IS THE
SOLE RESPONSIBILITY OF THE
CONTRACTOR; NEITHER THE OWNER
NOR THE ENGINEER SHALL BE
EXPECTED TO ASSUME ANY
RESPONSIBILITY FOR SAFETY OF
THE WORK, OF PERSONS ENGAGED
IN THE WORK, OF ANY NEARBY
STRUCTURES, OR OF ANY OTHER
PERSONS.

COPYRIGHT © 2022 ATWELL LLC NO REPRODUCTION SHALL BE MADE WITHOUT THE PRIOR WRITTEN CONSENT OF ATWELL LLC

DATE JUNE 7, 2021

2021-10-11 PER CITY AND WCWR 2022-01-19 PER CITY AND WCW 2022-03-31 PER CITY AND WCW

2022-06-06 PER CITY 2022-06-16 PER CITY

2022-06-17 REV. PHOTOMETRICS 2022-07-12 PER CITY 2022-08-22 PER CITY

REVISIONS

1" = 100 FEET

DR. SK CH. SS

BOOK NA JOB 18002264

