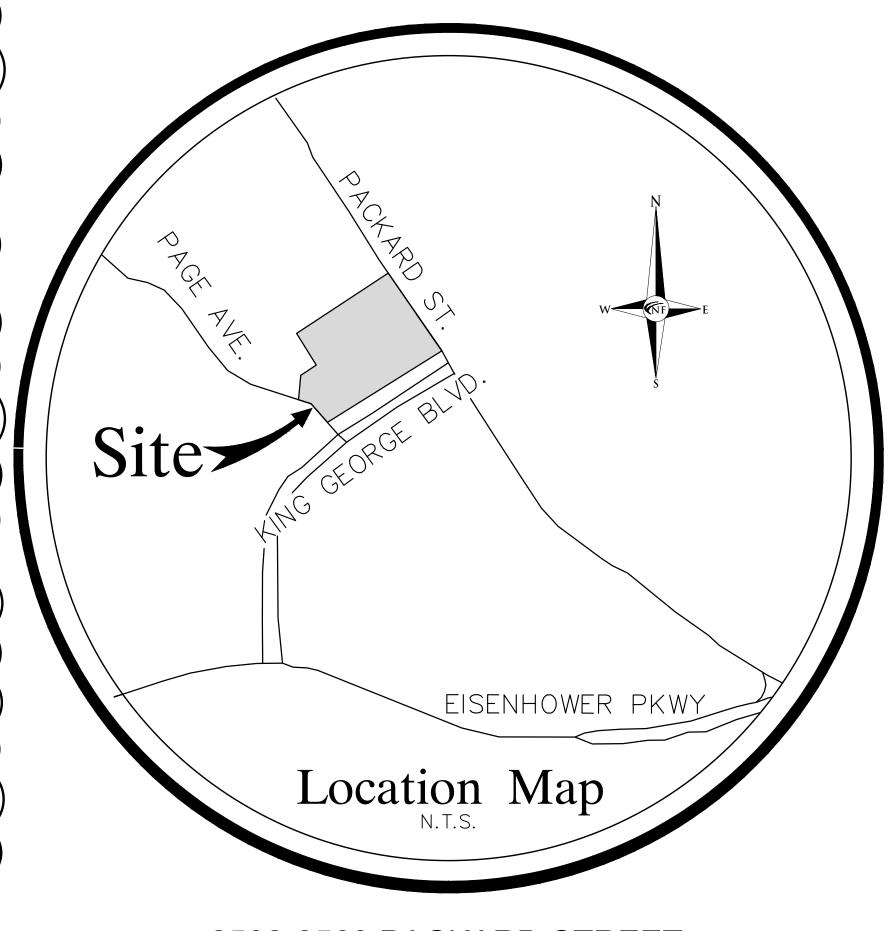
City of Ann Arbor, Washtenaw County, Michigan "THE GEORGE" Site Plan for Planning Commission

SITE DATA MATRIX COMPARISON CHART

		AMENDMENT #2	REQUIRED / PERMITTED	AMENDMENT #3	AMENDMENT #4	S.P. for P.C.
1	ZONING	C1B	C1B	C1B	C1B	C1B
	BUILDING TYPE	RETAIL / RESIDENTIAL	RETAIL / OFFICE / RESIDENTIAL	RETAIL / RESIDENTIAL	RETAIL / RESIDENTIAL	RESIDENTIAL
	GROSS LOT AREA	283,931 GSF (6.52 ACRES)	3,000 GSF (0.07 ACRES)	283,931 GSF (6.52 ACRES)	283,931 GSF (6.52 ACRES)	283,931 GSF (6.52 ACRES)
			3,000 GSF (0.07 ACKES)			
IV	IMPERVIOUS AREA	214,673	-	214,317	214,317	214,317
V	USEABLE OPEN SPACE	26,654	-	28745 GSF	28745 GSF	28745 GSF
VI	MAX UFA	128% OF LOT AREA (363,356 SF / 283,931 SF)	150% OF LOT AREA (283,931 SF X 1.5)	128% OF LOT AREA (363,356 SF / 283,931 SF)	128% OF LOT AREA (363,356 SF / 283,931 SF)	131% OF LOT AREA (371,956 SF / 283,931 SF)
VII	LOT WIDTH	456'	20'	456'	456'	456'
VII	LOT WIDTH		20			430
		363,356 GSF		363,356 GSF	363,356 GSF	371,956 GSF
VIII	BUILDING AREA	Covered Parking - 48,248 sf Retail - 23,462 sf	425,897 GSF	Covered Parking - 48,248 sf Retail - 23,462 sf	Covered Parking - 48,248 sf Retail - 23,462 sf	Covered Parking - 48,248 sf Residential - 318,056 sf (Amenity - 5,652
		Residential - 291,646 sf (Amenity - 5,652 sf)		sf)	Residential - 291,646 sf (Amenity - 5,652 sf)	sf)
		49'	50'	49'	49'	49¹
IX	HEIGHT	49' 4 STORY	4 STORY	49' 4 STORY	49' 4 STORY	49' 4 STORY
Х	MIN SETBACKS	4310111	4310KI	+310KI	+3101(1	431011
	FRONT (EAST)	10.41'	10' / 25'	10.41'	10.41'	10.41'
	SIDE (NORTH)	71.5'	0'	71.5'	71.5'	71.5'
	REAR (WEST)	65.5'	(30' plus 1 additional foot of setback for each additional 1 foot of building over 30 feet)	65.5'	65.5'	65.5'
	SIDE (SOUTH)	79'	48' (30' plus 1 additional foot of setback for each additional 1 foot of building over 30 feet)	79'	79'	79'
ΧI	PARKING - VEHICULAR	- 364 spaces Retail: - 96 spaces	- Minimum - 1 / 310 gsf = 76 spaces - Maximum - 1 / 265 gsf = 89 spaces	Residential: - 363 spaces Retail: - 96 spaces Total:	Residential: - 361 spaces Retail: - 96 spaces Total:	Residential: - 457 spaces Total: - 457 spaces
		- 460 spaces	- Minimum - 325	- 458 spaces	- 457 spaces	
	GARAGE	152	-	152	150	150
	EXTERIOR	308	-	306	307	307
	COMPACT SPACES	106	30% MAX - 136 MAX	108	108	108
	A COECCIDI E CDA CEC	13 SPACES	0.504.055 / 404.500.504.055	14 SPACES	15 SPACES	15 SPACES
	ACCESSIBLE SPACES	(Includes 2 minimum van spaces)	9 SPACES / 401-500 SPACES	(Includes 2 minimum van spaces)	(Includes 2 minimum van spaces)	(Includes 2 minimum van spaces)
XII	PARKING - BICYCLE	RESIDENTIAL - 56 SPACES 1 SPACE / 5 UNITS TYPE A - 50% / TYPE C - 50%	RESIDENTIAL - 50 SPACES 1 SPACE / 5 UNITS TYPE A - 50% / TYPE C - 50%	RESIDENTIAL - 56 SPACES 1 SPACE / 5 UNITS TYPE A - 50% / TYPE C - 50%	RESIDENTIAL - 56 SPACES 1 SPACE / 5 UNITS TYPE A - 50% / TYPE C - 50%	RESIDENTIAL - 69 SPACES 1 SPACE / 5 UNITS TYPE A - 50% / TYPE C - 50%
	3.3.022	RETAIL - 8 SPACES 1 SPACE / 3,000 SF OF AREA	RETAIL - 8 SPACES 1 SPACE / 3,000 SF OF AREA	RETAIL - 12 SPACES 1 SPACE / 3,000 SF OF AREA	RETAIL - 10 SPACES 1 SPACE / 3,000 SF OF AREA	CLASS A - 59 SPACES CLASS C - 10 SPACES



2502-2568 PACKARD STREET
PART OF THE SE. 1/4 OF SECTION 4, AND PART OF
THE NE 1/4 OF SECTION 9, T. 3 S, R. 6 E, CITY OF
ANN ARBOR, WASHTENAW COUNTY, MICHIGAN

Developer

Somerset Development 101 Crawfords Corner Rd. Holmdel, NJ 07733

Contact: Ken Gold Tel: 732.415-7171

Architect / Planner

Hobbs + Black Architects 100 N. State Street Ann Arbor, MI 48104

Contact:
Steve Dykstra
Tel: 734.663-4189

Civil Engineer

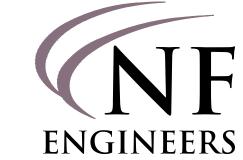
Nowak & Fraus Engineers 46777 Woodward Ave. City of Pontiac, MI 48342

Contact:
Andrew Wiseman
Tel: 248.332-7931

LEGAL DESCRIPTION:

OUTLOT A, SMOKLER HUTZEL SUBDIVISION, OF PART OF THE SOUTHEAST ONE-QUARTER (1/4) OF SECTION 4 AND PART OF THE NORTHEAST ONE-QUARTER (1/4) OF SECTION 9, TOWN 3 SOUTH, RANGE 6 EAST, CITY OF ANN ARBOR, WASHTENAW COUNTY, MICHIGAN, ACCORDING TO THE PLAT THEREOF AS RECORDED IN LIBER 17 OF PLATS, PAGES 41, 42 AND 43, WASHTENAW COUNTY RECORDS.





Issue Date: Mar. 11, 2022
Revised Date: Apr. 14, 2022
Revised Date: May 16, 2022
Revised Date: June 06, 2022
Revised Date: July 28, 2022

CIVIL ENGINEERS

LAND SURVEYORS

LAND PLANNERS

NOWAK & FRAUS ENGINEERS 46777 WOODWARD AVE.

TEL. (248) 332-7931

FAX. (248) 332-8257

SHEET INDEX:

SP-00	COVER SHEET
SP-01	ALTA / BOUNDARY & TOPOGRAPHIC SURVEY
SP-02	CONCEPTUAL DIMENSIONAL LAYOUT PLAN
SP-03	DIMENSIONAL LAYOUT PLAN
SP-04	MISCELLANEOUS SITE DETAILS
SP-05	EXISTING PAVING & GRADING PLAN
SP-06	EXISTING UTILITY PLAN
SP-07	CALCULATIONS & STORM DETENTION DETAILS
SP-08	STORM WATER MANAGEMENT PLAN
SP-09	SOIL EROSION & DRAINAGE AREAS PLAN
SP-10	FIRE PROTECTION PLAN
1 of 1	SITE PHOTOMETRIC PLAN - 2022
L1	EXISTING LANDSCAPE PLAN
L2	COURTYARD/POOL DETAILS
L3	PACKARD FRONTAGE/PLAZA AND OPEN SPACE DETAILS
L4	NATURAL FEATURES MITIGATION PLAN
L5	GENERAL LANDSCAPE NOTES AND DETAILS
L6	PARK AND FRONTAGE DETAILS
L7	BIOSWALE DETAILS
A 4 0 0	
A100	PROPOSED FIRST FLOOR PLAN PROPOSED LOFT PLAN
A101	
A321	EXISTING BUILDING ELEVATIONS - MARK UP EXISTING BUILDING ELEVATIONS - MARK UP
A322	
A323	PROPOSED PARTIAL BUILDING ELEVATIONS
A324	PROPOSED PARTIAL BUILDING ELEVATIONS

Project Description:

Currently the property is in the C1B Zone and consists of 249 residential rental apartments and approximately 23,000 square feet of vacant retail space. Somerset seeks to convert the vacant retail into 42 additional one-bedroom rental units. There will be no changes to the site plan and no increase to the parking count or distribution. The only de minimis change to the approved plan is the addition of 3 enclosed bicycle spaces.

The project consists of the construction of loft style residential units in the existing vacant first floor retail space at the north and south wings, and adjacent to the main entrance. As mentioned before, the proposed plan would add 42 new one-bedroom residential units. The first-level construction would total approximately 22,500 square feet and the loft/mezzanine level would total approximately 8,600 square feet.

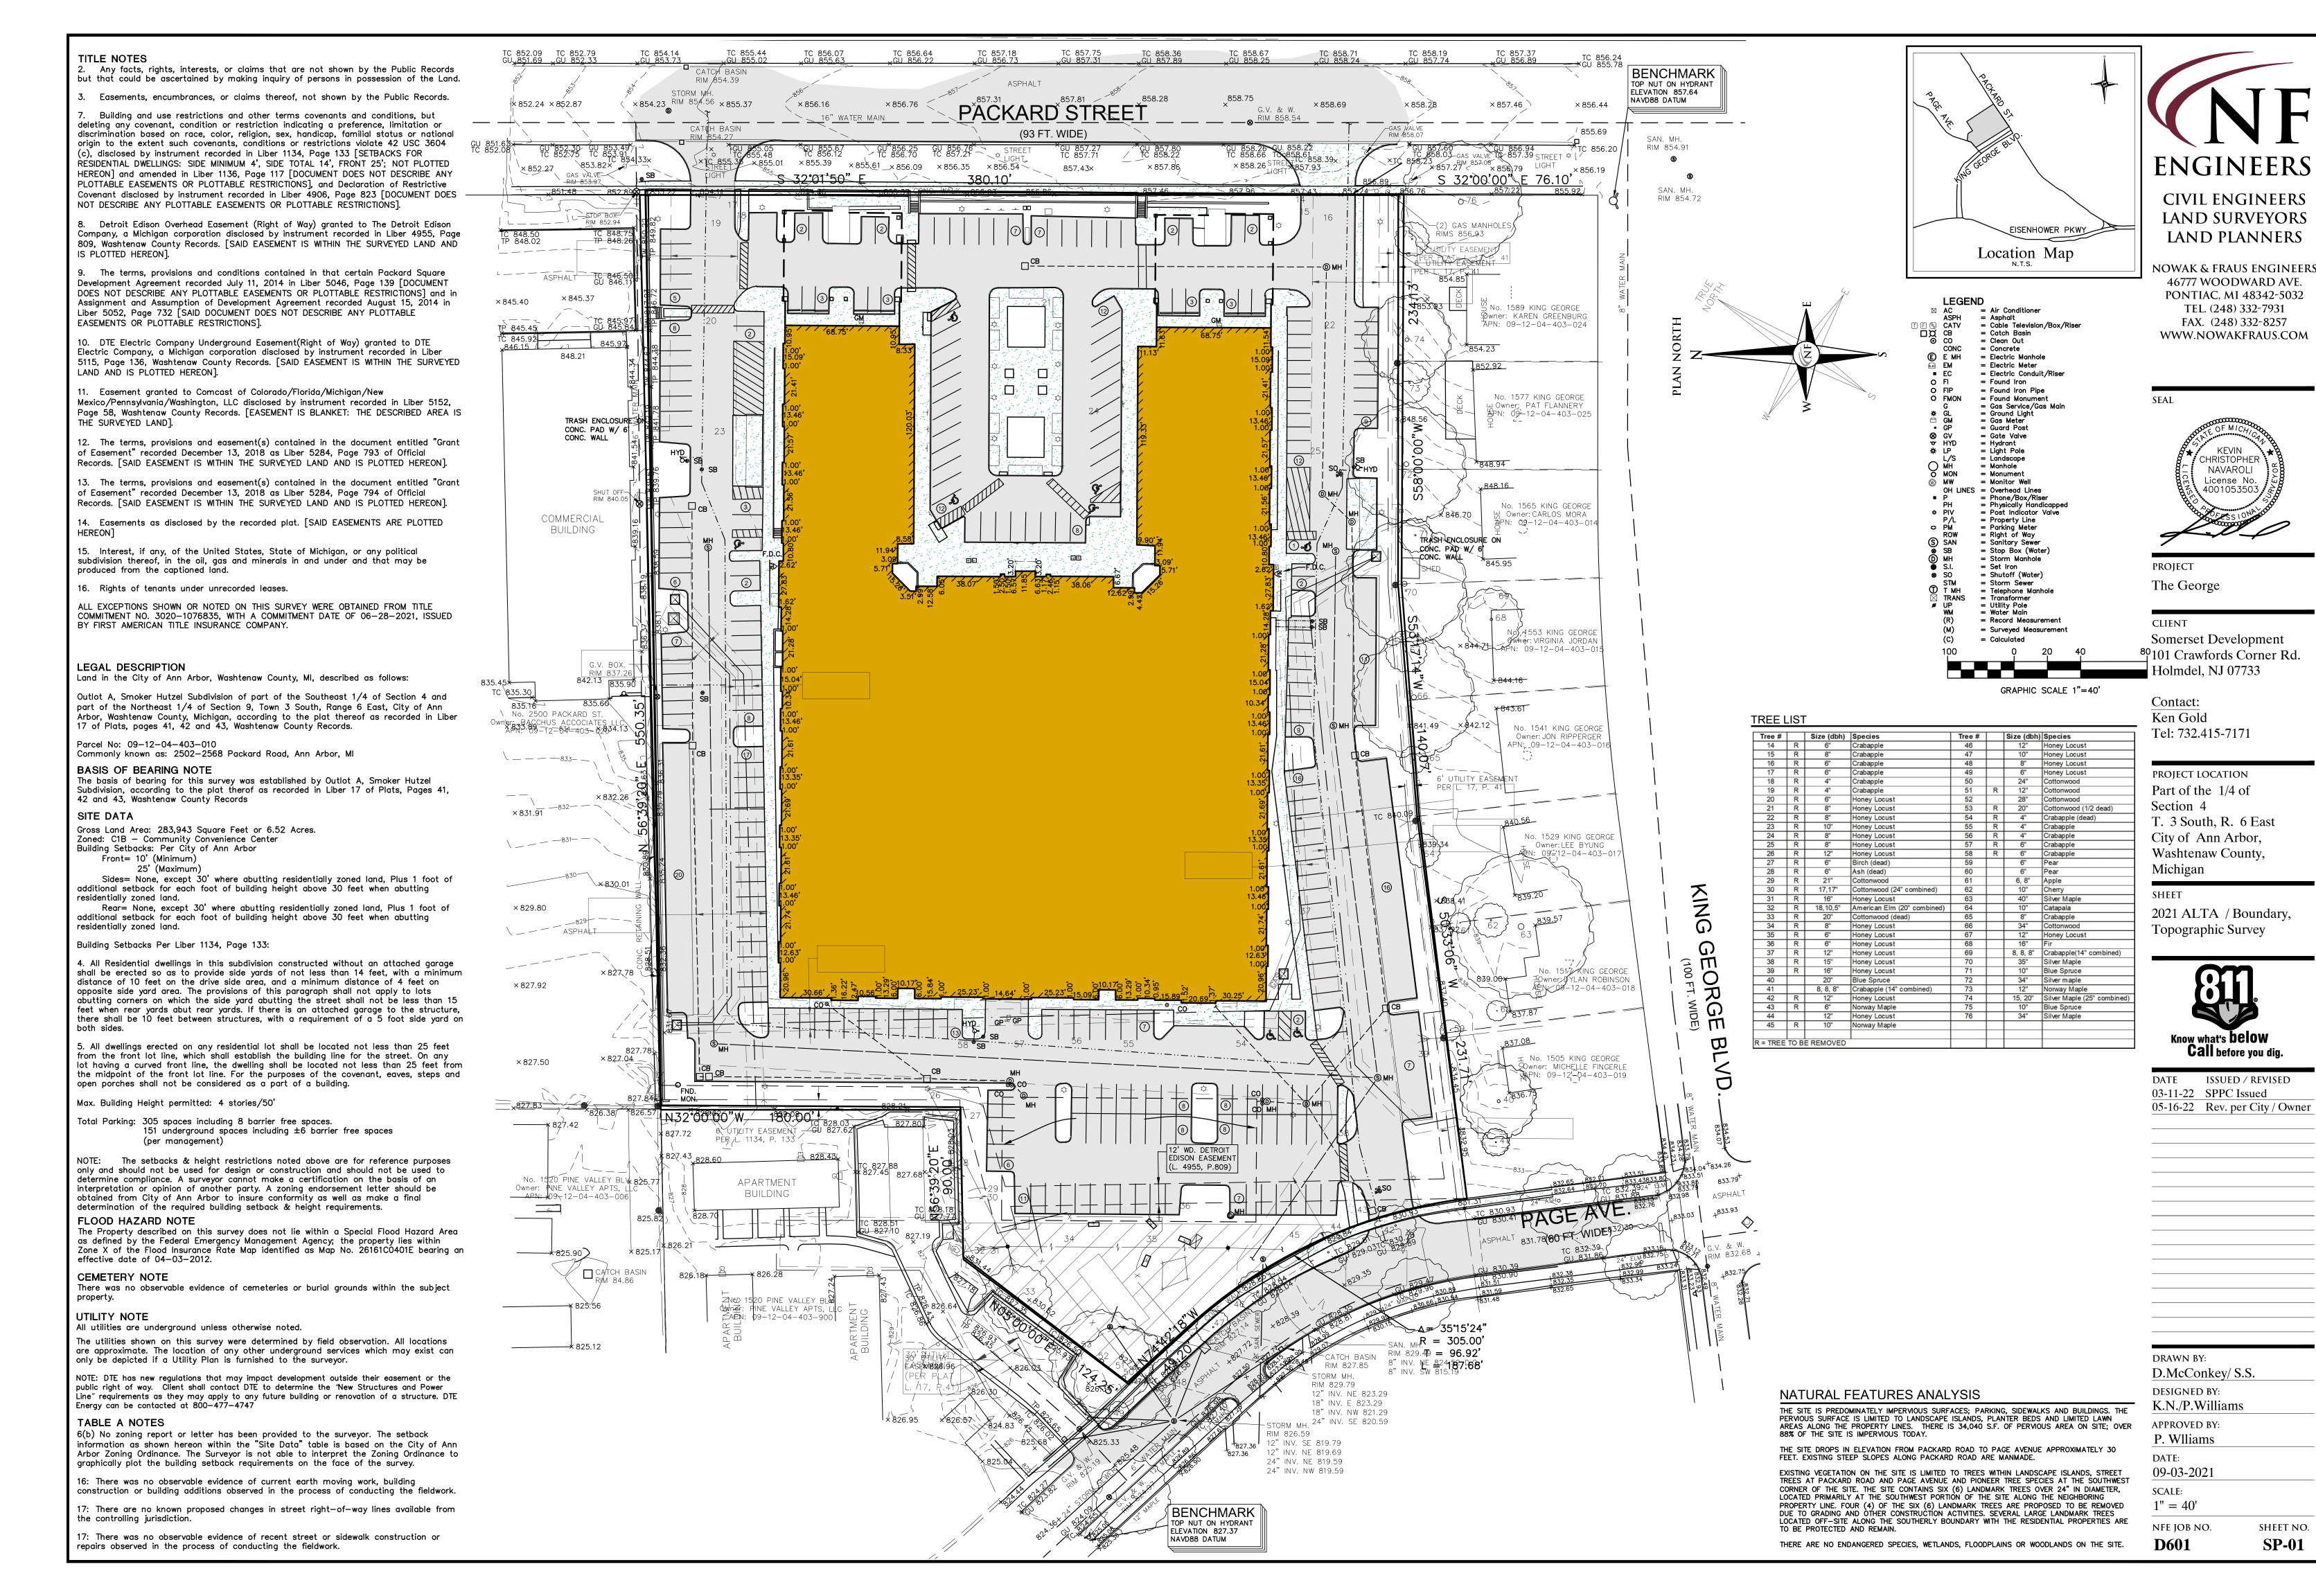
Each unit will have a private exterior entry for ingress/egress and existing parking spaces will be available to the units. Residential use has a lower parking requirement than the existing retail use, so no additional parking spaces are required. The two additional enclosed bicycle spaces would be provided in the north and south wings.

New entry doors, canopies, and glazing would be added in place of the storefront glazing at the existing retail front elevations. New openings at the existing retail rear elevations will be added, with entry doors, canopies and glazing similar to the fronts.

The existing trash enclosure located on the north side of the building is proposed to be relocated to the north side of the driveway to reduce noise and refuse activity around the proposed residential apartments.

Community Analysis per UDC Chapter 55:

- i) Impact of proposed Development on public schools: No impact
- ii) Relationship of intended use to neighboring uses: No change
- iii) Impact of adjacent uses on proposed development or Special Exception Use: N/A
- iv) Impact of proposed Development on the air and water quality, and on existing Natural Features of the Site and neighboring Sites: No additional impact
- v) Impact of the proposed use on historic Sites or structures which are located within a historic district or listed on the National Register of Historic Places: N/A
- Traffic Statement: Conversion of 23,462 square feet of existing retail space to 42 proposed residential units will significantly reduce the number of trips per hour generated, therefore a new transportation analysis has not been provided.
- vii) Public sidewalk maintenance statement: All public sidewalk fronting the property on Paige and Packard shall be maintained and kept free of snow, ice and debris
- viii) Additional information for Site Plans: Natural Features General Descriptions and Impacts: N/A



TEL. (248) 332-7931

FAX. (248) 332-8257

KEVIN

CHRISTOPHER

NAVAROLI

License No.

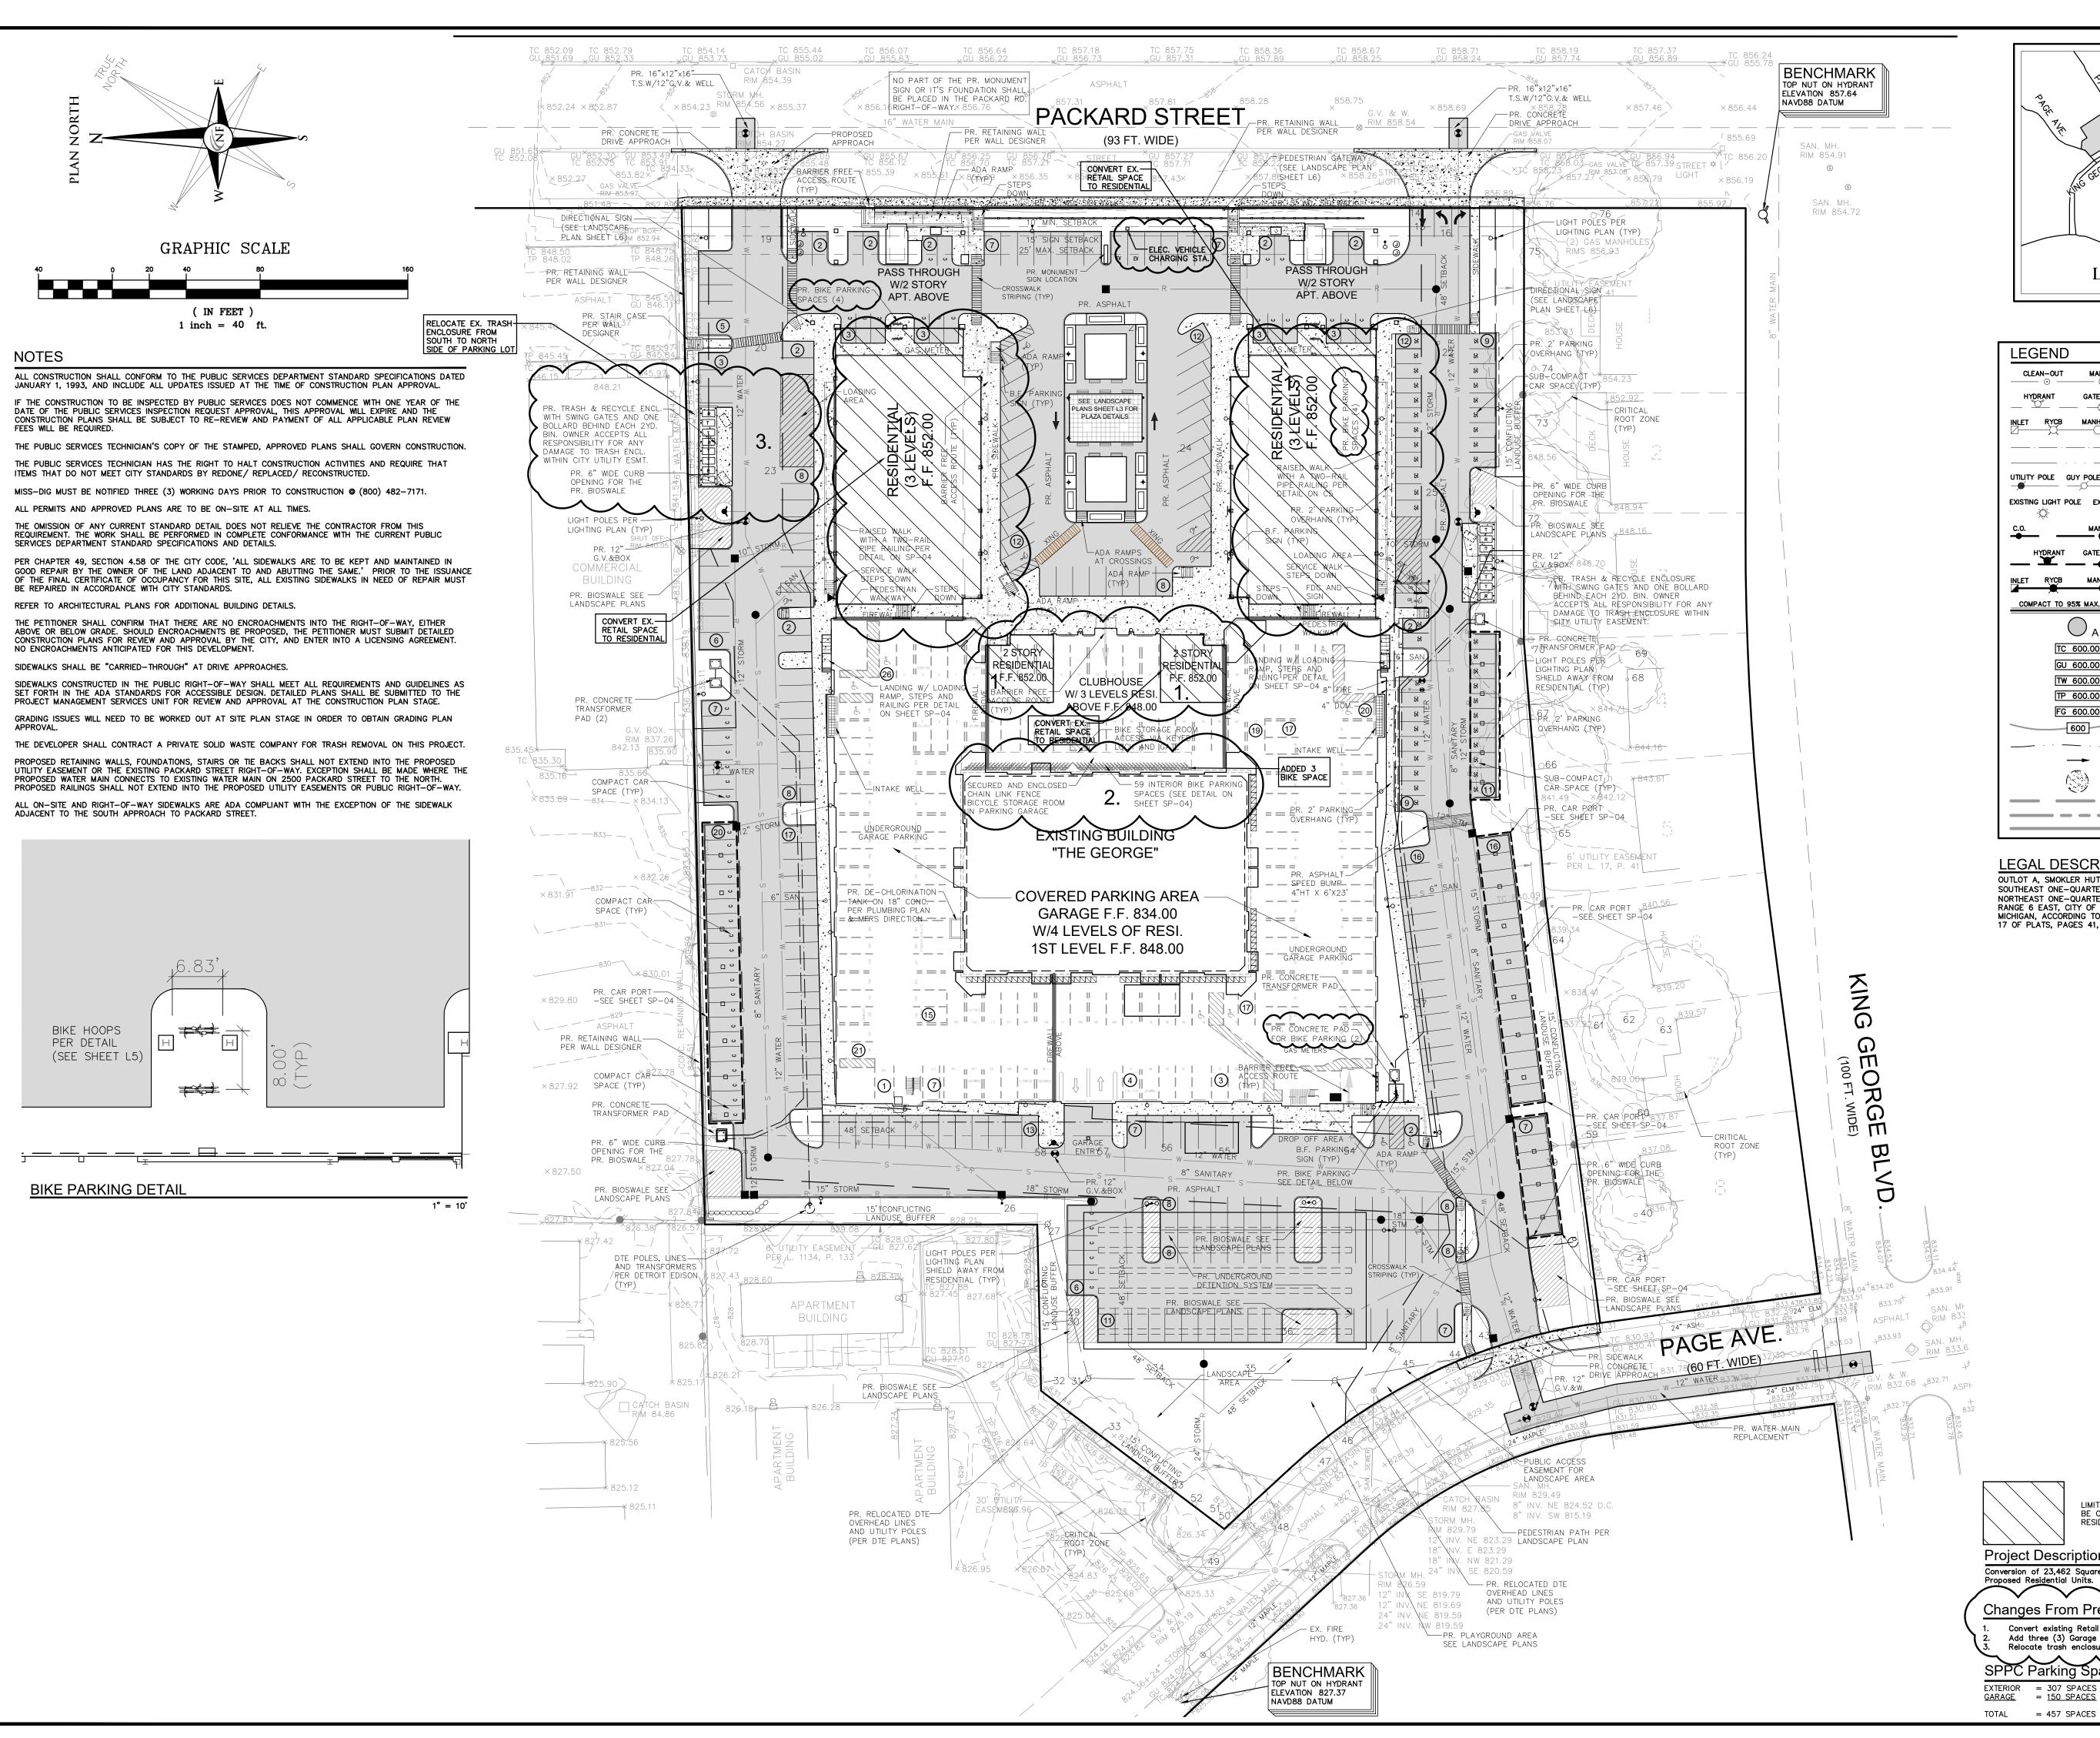
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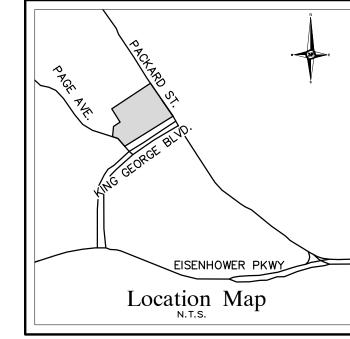
Know what's **below**

Call before you dig.

SHEET NO.

SP-01





LEGEND

CLEAN-OUT

MANHOLE

MANHOLE CB

— — — EXISTING WATER MAIN

---- EXISTING BURIED CABLES

PR. SANITARY SEWER

PROPOSED WATER MAIN

COMPACT TO 95% MAX. DENSITY PR. SAND BACKFILL

DRAINAGE AREA LIMITS

PROPOSED SILT FENCE

OUTLOT A, SMOKLER HUTZEL SUBDIVISION, OF PART OF THE

RANGE 6 EAST, CITY OF ANN ARBOR, WASHTENAW COUNTY,

SOUTHEAST ONE-QUARTER (1/4) OF SECTION 4 AND PART OF THE

MICHIGAN, ACCORDING TO THE PLAT THEREOF AS RECORDED IN LIBER

17 OF PLATS, PAGES 41, 42 AND 43, WASHTENAW COUNTY RECORDS.

NORTHEAST ONE-QUARTER (1/4) OF SECTION 9, TOWN 3 SOUTH,

MANHOLE CB PROPOSED STORM SEWER

UTILITY CROSSING

PR. TOP OF CURB ELEVATION

PROPOSED GUTTER ELEVATION

PR. TOP OF WALK ELEVATION

PR. TOP OF PAVEMENT ELEV.

PROPOSED FINISH GRADE

PR. DRAINAGE DIRECTION

PROPOSED INLET FILTER

LIMITS OF SOIL DISRUPTION

PROPOSED CONTOUR

PROPOSED SWALE

GATE VALVE

UTILITY POLE GUY POLE GUY WIRE

EXISTING LIGHT POLE EXISTING SIGN

TC 600.00

GU 600.00

TW 600.00

TP 600.00

FG 600.00

600

 \longrightarrow

LEGAL DESCRIPTION

- .

EXISTING SANITARY SEWER

EXISTING STORM SEWER

EXISTING GAS MAIN

ENGINEERS **CIVIL ENGINEERS** LAND SURVEYORS LAND PLANNERS

> **NOWAK & FRAUS ENGINEERS** 46777 WOODWARD AVE. PONTIAC, MI 48342-5032 TEL. (248) 332-7931 FAX. (248) 332-8257 WWW.NOWAKFRAUS.COM

SEAL EXISTING OVERHEAD LINES PATRICK J WILLIAMS ENGINEER NO. PROJECT

The George

CLIENT Somerset Development 101 Crawfords Corner Rd. Holmdel, NJ 07733

Contact: Ken Gold Tel: 732.415-7171

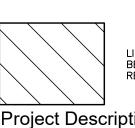
PROJECT LOCATION Part of the 1/4 of Section 4 T. 3 South, R. 6 East City of Ann Arbor, Washtenaw County, Michigan

SHEET

Conceptual Dimensional Layout Plan



DATE ISSUED / REVISED 03-11-22 SPPC Issued 05-16-22 Rev. per City / Owner 05-16-22 Rev. per City / Owner 07-28-22 Clouded EV and Bike Parking Locations



LIMIT OF EXISTING BUILDING SPACE PROPOSED TO BE CONVERTED FROM RETAIL USE TO RESIDENTIAL USE.

Project Description: Conversion of 23,462 Square Feet of Existing Retail Space to 42

Changes From Previously Approved Site Plan: Convert existing Retail Space to Residential Space Add three (3) Garage Bike Parking Spaces Relocate trash enclosure to north side of parking

SPPC Parking Spaces Provided: EXTERIOR = 307 SPACES INCLUDING 8 BARRIER FREE SPACES GARAGE = 150 SPACES INCLUDING 7 BARRIER FREE SPACES APPROVED BY: P. Wlliams DATE: March 11, 2022 SCALE:

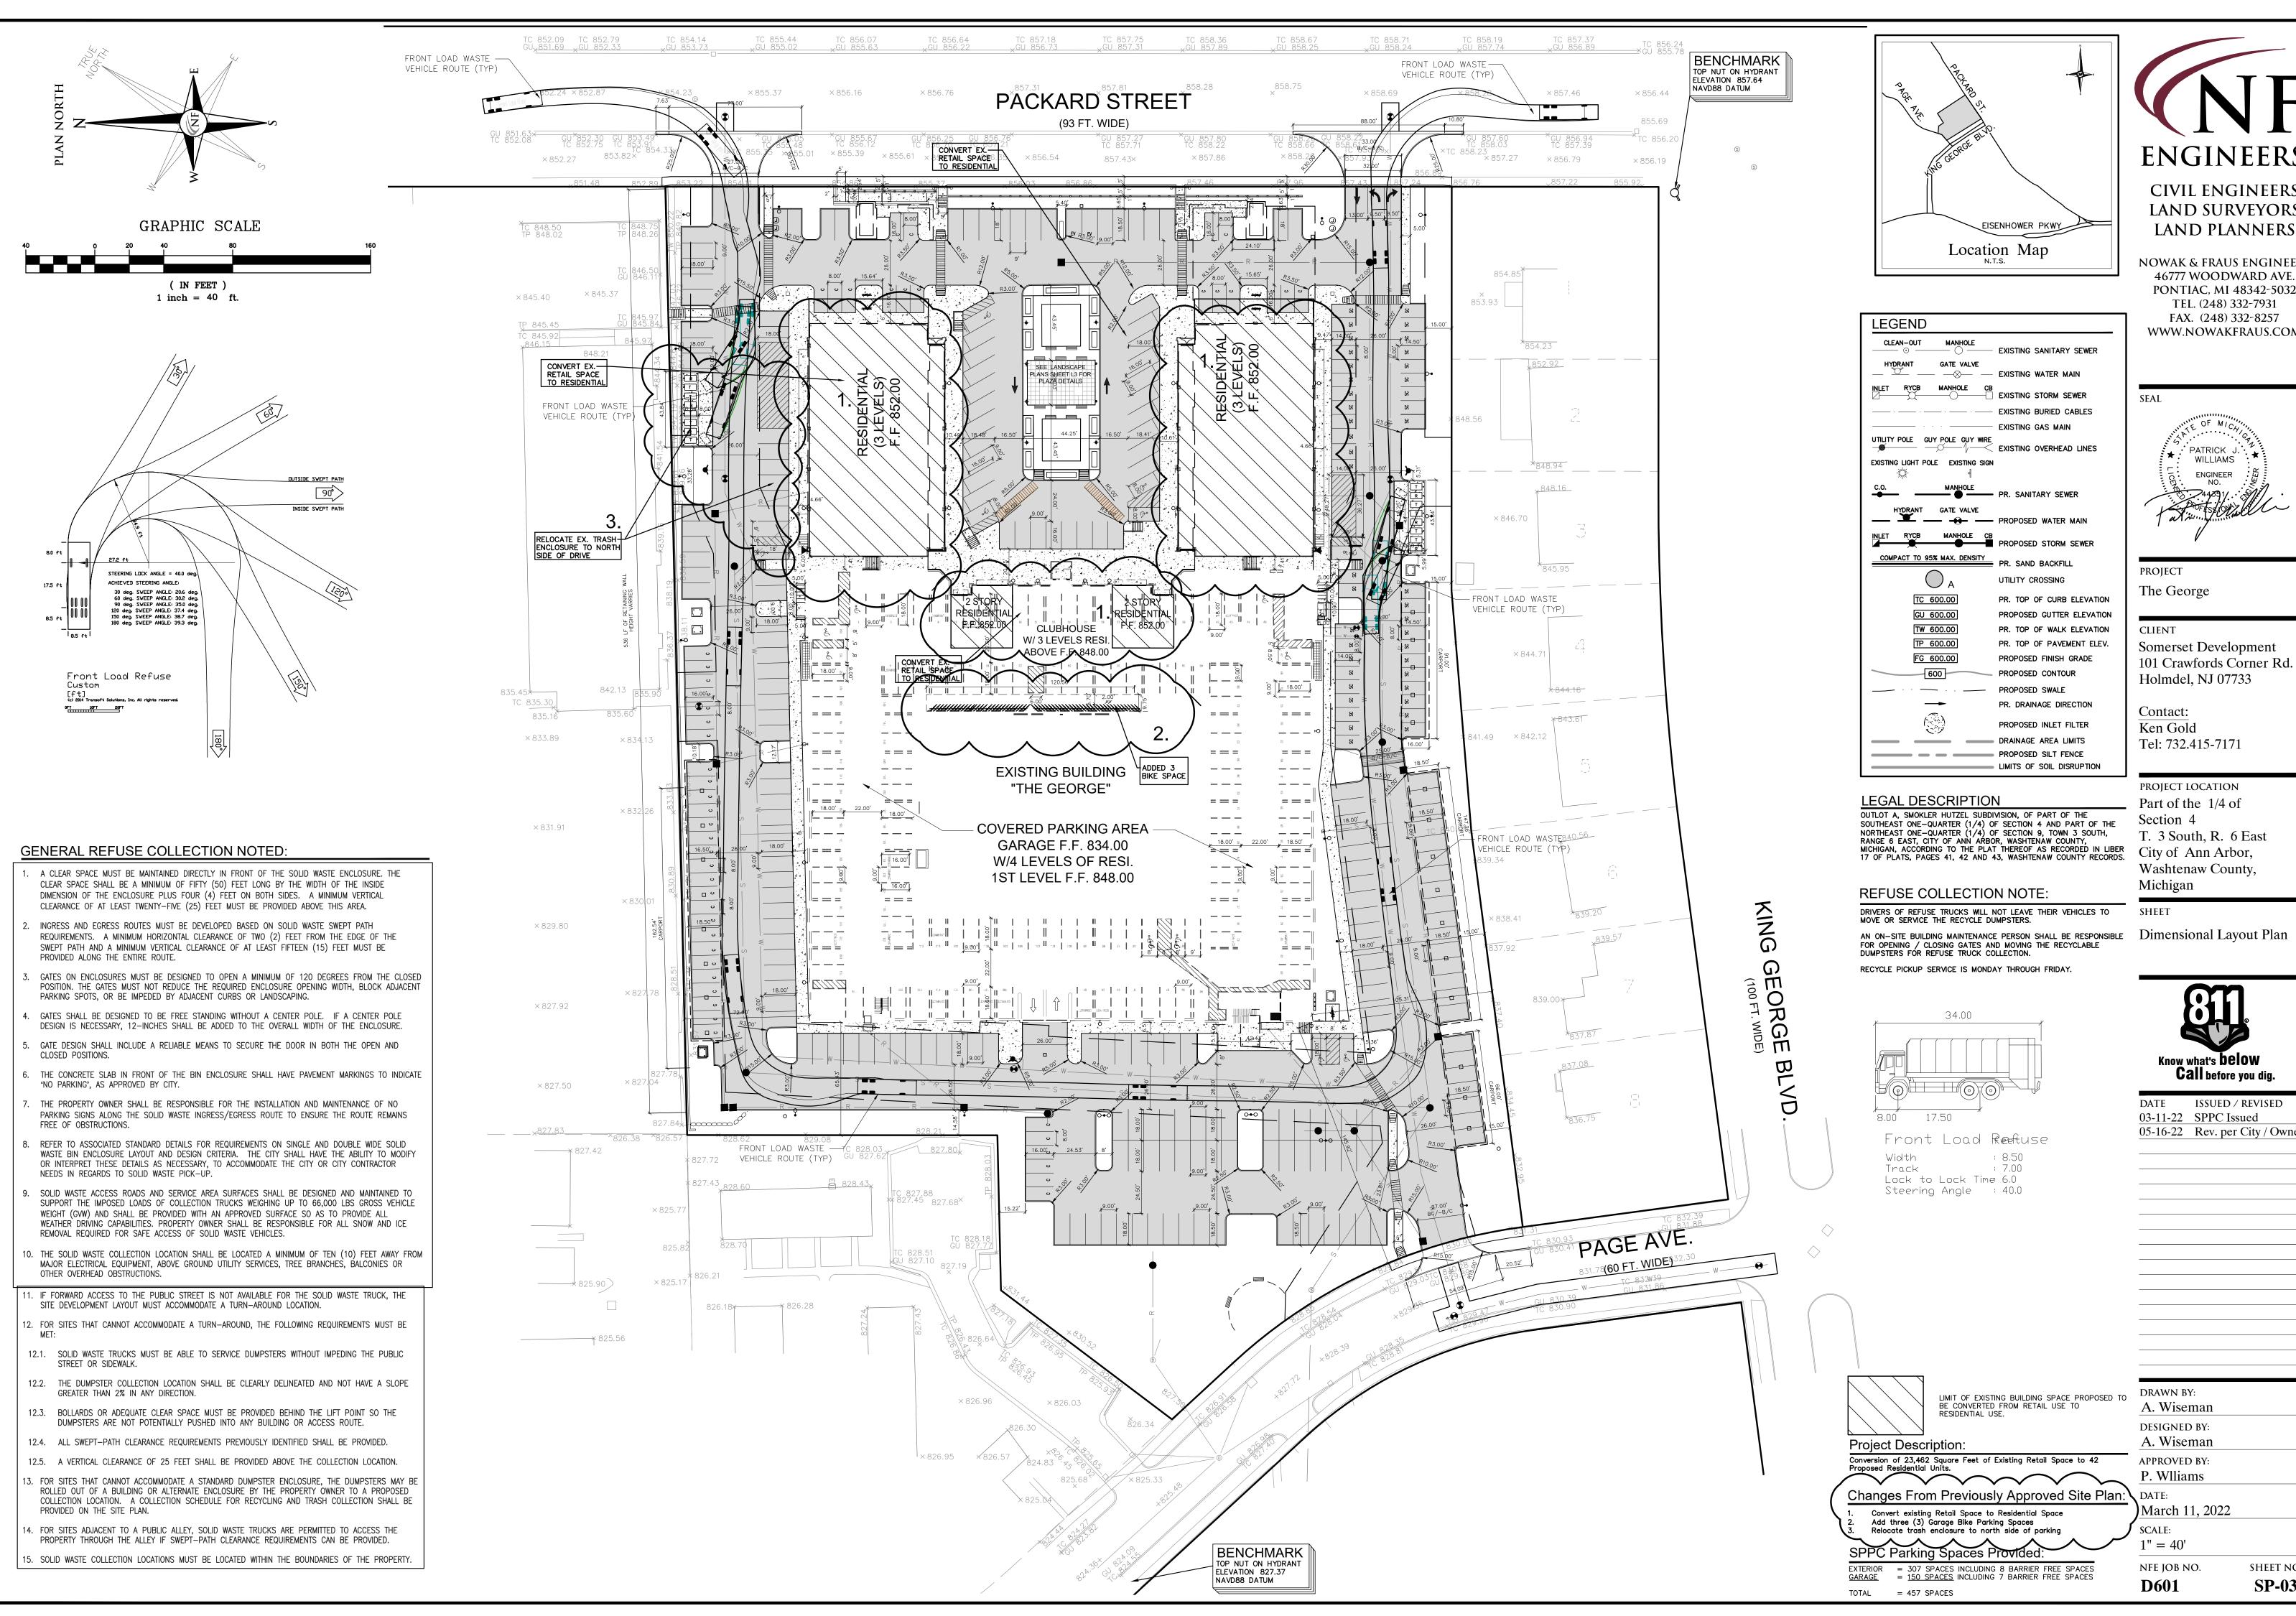
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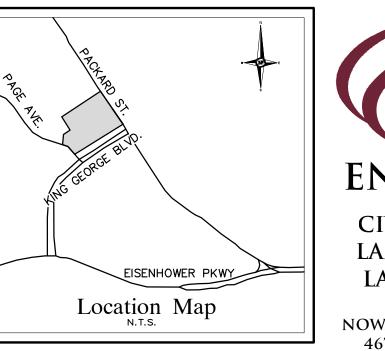
A. Wiseman

DESIGNED BY:

A. Wiseman

1'' = 40'SHEET NO. NFE JOB NO. **D601 SP-02**







NOWAK & FRAUS ENGINEERS 46777 WOODWARD AVE. PONTIAC, MI 48342-5032 TEL. (248) 332-7931 FAX. (248) 332-8257 WWW.NOWAKFRAUS.COM

SEAL PATRICK J WILLIAMS ENGINEER NO.

PROJECT The George

CLIENT

Somerset Development 101 Crawfords Corner Rd. Holmdel, NJ 07733

Contact: Ken Gold Tel: 732.415-7171

PROJECT LOCATION Part of the 1/4 of Section 4 T. 3 South, R. 6 East City of Ann Arbor, Washtenaw County,

Know what's **below** Call before you dig.

DATE ISSUED / REVISED 03-11-22 SPPC Issued 05-16-22 Rev. per City / Owner

LIMIT OF EXISTING BUILDING SPACE PROPOSED TO BE CONVERTED FROM RETAIL USE TO

Conversion of 23,462 Square Feet of Existing Retail Space to 42

Changes From Previously Approved Site Plan: Convert existing Retail Space to Residential Space

SPPC Parking Spaces Provided:

1'' = 40'NFE JOB NO.

SCALE:

DRAWN BY:

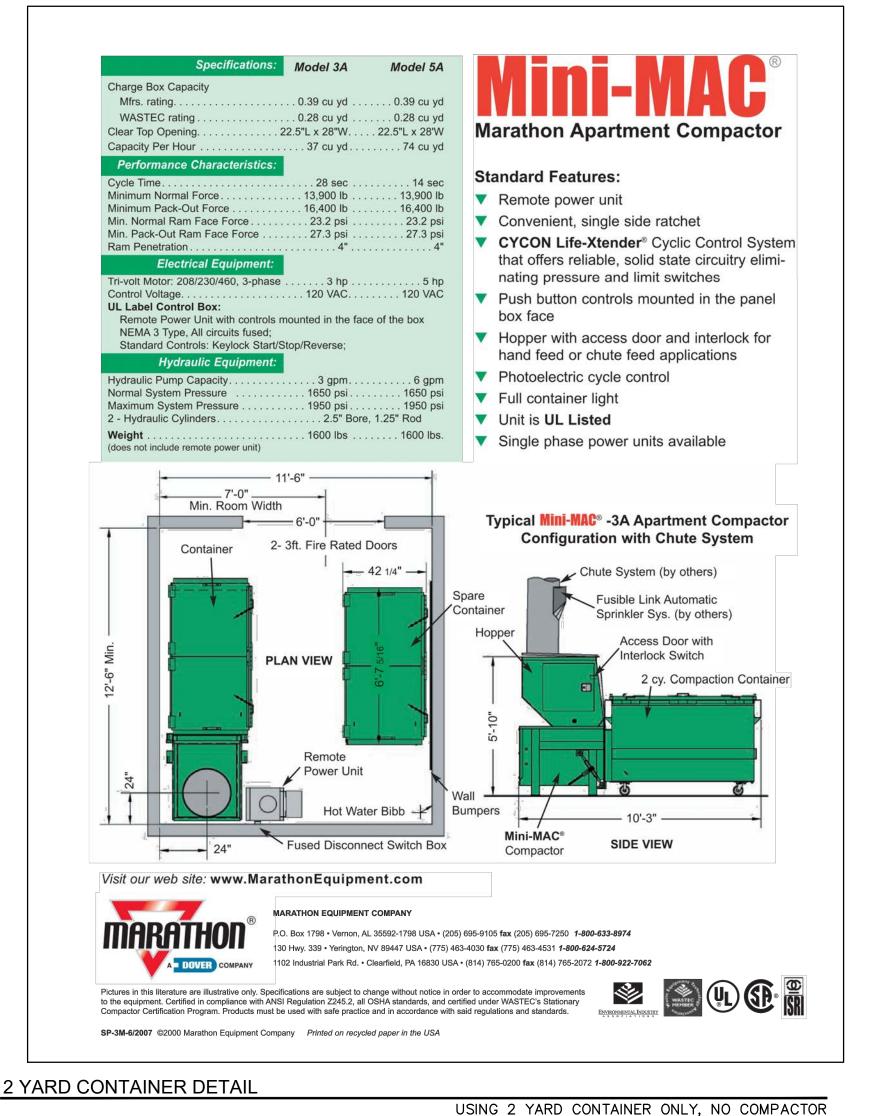
A. Wiseman

DESIGNED BY: A. Wiseman

APPROVED BY: P. Wlliams

March 11, 2022

SHEET NO. **D601 SP-03**



Quick installation

Galvanized for long lasting protection Recessed screws for a smooth look

GARAGE BICYCLE PARKING RACK DETAIL

Galvanized Safety Railing

High corrosion resistance No welding or threading

Large set screws resists thread stripping Available for schedule 40 Pipe


sizes 1 - 1/4" - 2"



PIPE RAILING

PRODUCT: I-I/4" DIAMETER GALVANIZED PIPE AT 21" AND 42" COLOR: GALVANIZED STEEL

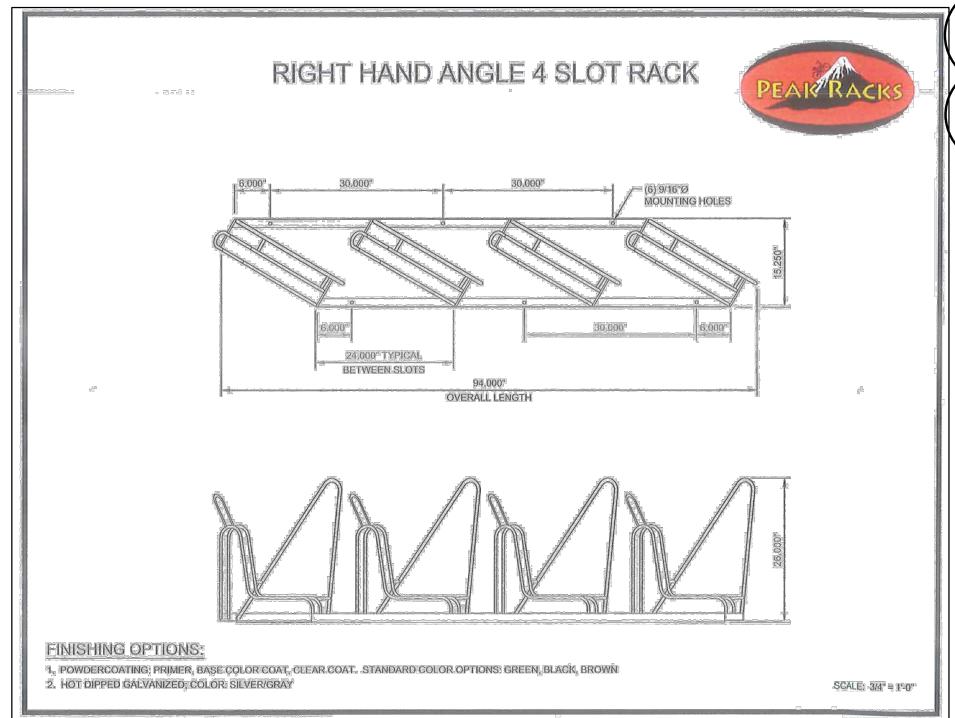NOTE: COORDINATE INSTALLATION WITH RETAINING DESIGN. PIPE RAILING TO USED USED ON WHERE WALL HEIGHT EXCEEDS 30" HIGH



GARAGE BICYCLE PARKING STORAGE



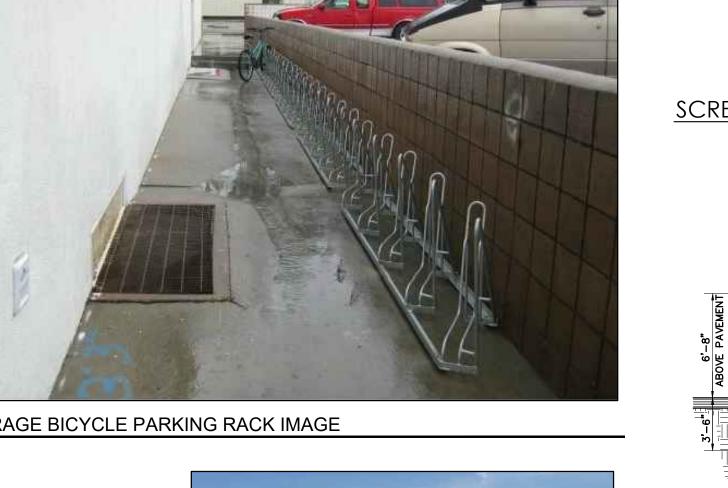
GARAGE BICYCLE PARKING RACK IMAGE

3'-6" HIGH
 PRE-FINISHED ALUM.
 GUARDRAIL SYSTEM


T/ LEVEL RETAIL EL: +4'-0"

MONOLITHIC WALK
AND STEM WALL
DEPTH TO VARY WITH
SITE GRADING


T/ SIDEWALK
EL: VARIES




CONCEPTUAL CARPORT STRUCTURE ELEVATION

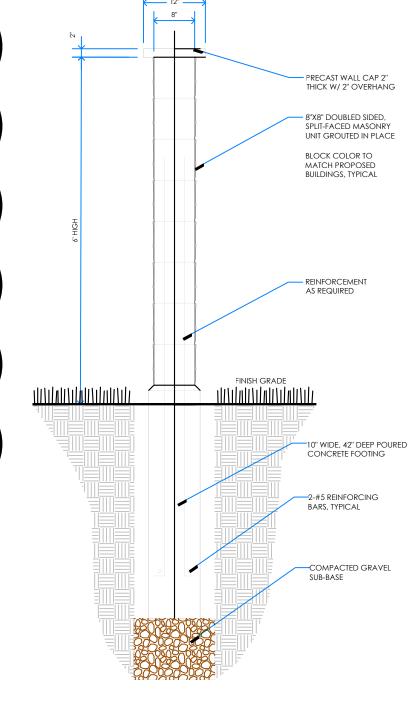


SCREEN WALL DETAIL

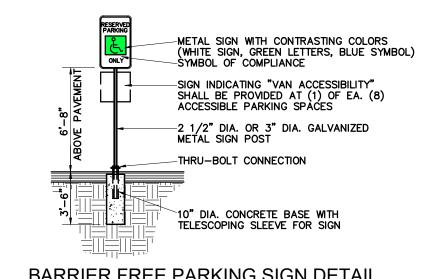

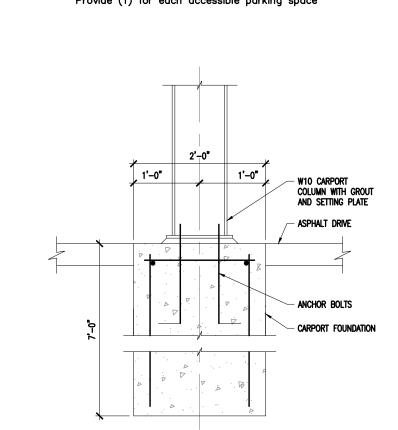
BARRIER FREE PARKING SIGN DETAIL N.T.S. Provide (1) for each accessible parking space



SECTION AT CARPORT FOUNDATION

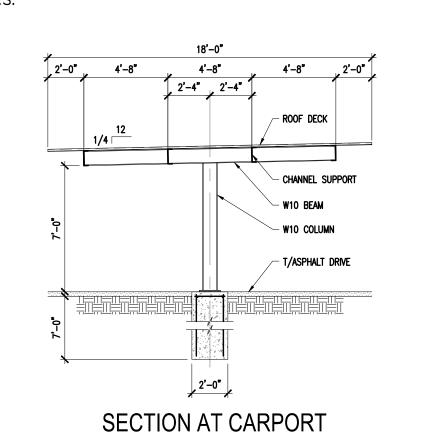

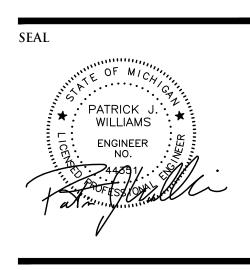ENGINEERS CIVIL ENGINEERS LAND SURVEYORS LAND PLANNERS **NOWAK & FRAUS ENGINEERS** 46777 WOODWARD AVE. PONTIAC, MI 48342-5032 TEL. (248) 332-7931 FAX. (248) 332-8257



WWW.NOWAKFRAUS.COM

PROJECT The George

CLIENT Somerset Development 101 Crawfords Corner Rd. Holmdel, NJ 07733

Contact: Ken Gold Tel: 732.415-7171

PROJECT LOCATION Part of the 1/4 of Section 4 T. 3 South, R. 6 East City of Ann Arbor, Washtenaw County, Michigan

SHEET

Miscellaneous Site Details

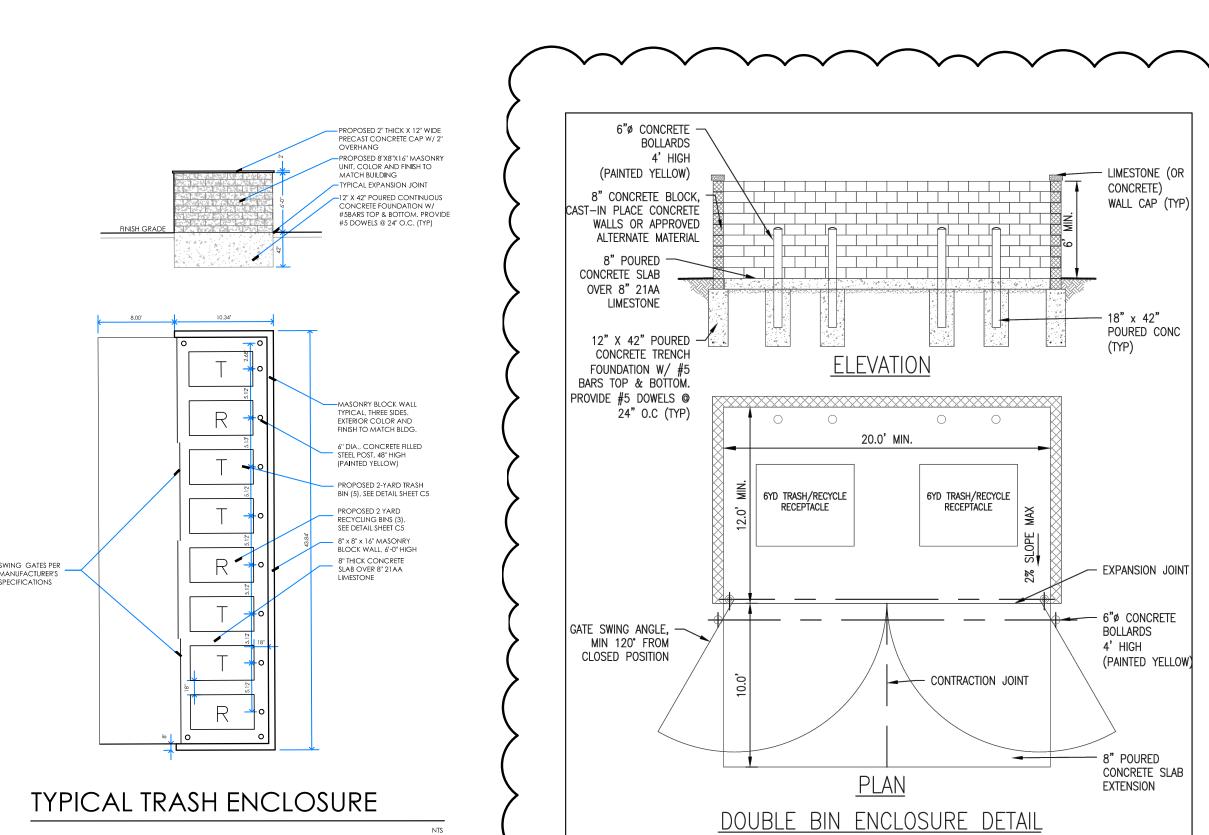


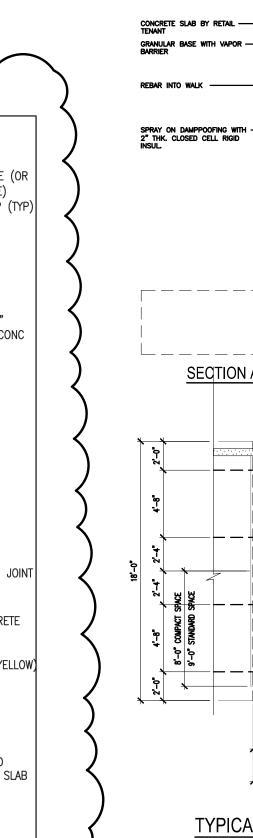
DATE ISSUED / REVISED 03-11-22 SPPC Issued 05-16-22 Rev. per City / Owner

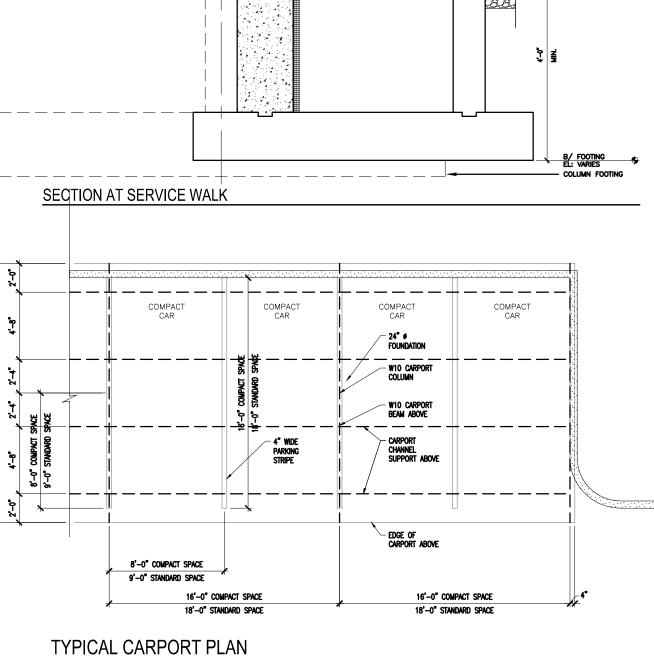
DRAWN BY: A. Wiseman **DESIGNED BY:** A. Wiseman APPROVED BY: P. Wlliams DATE: March 11, 2022 SCALE: 1'' = 40'NFE JOB NO. SHEET NO.

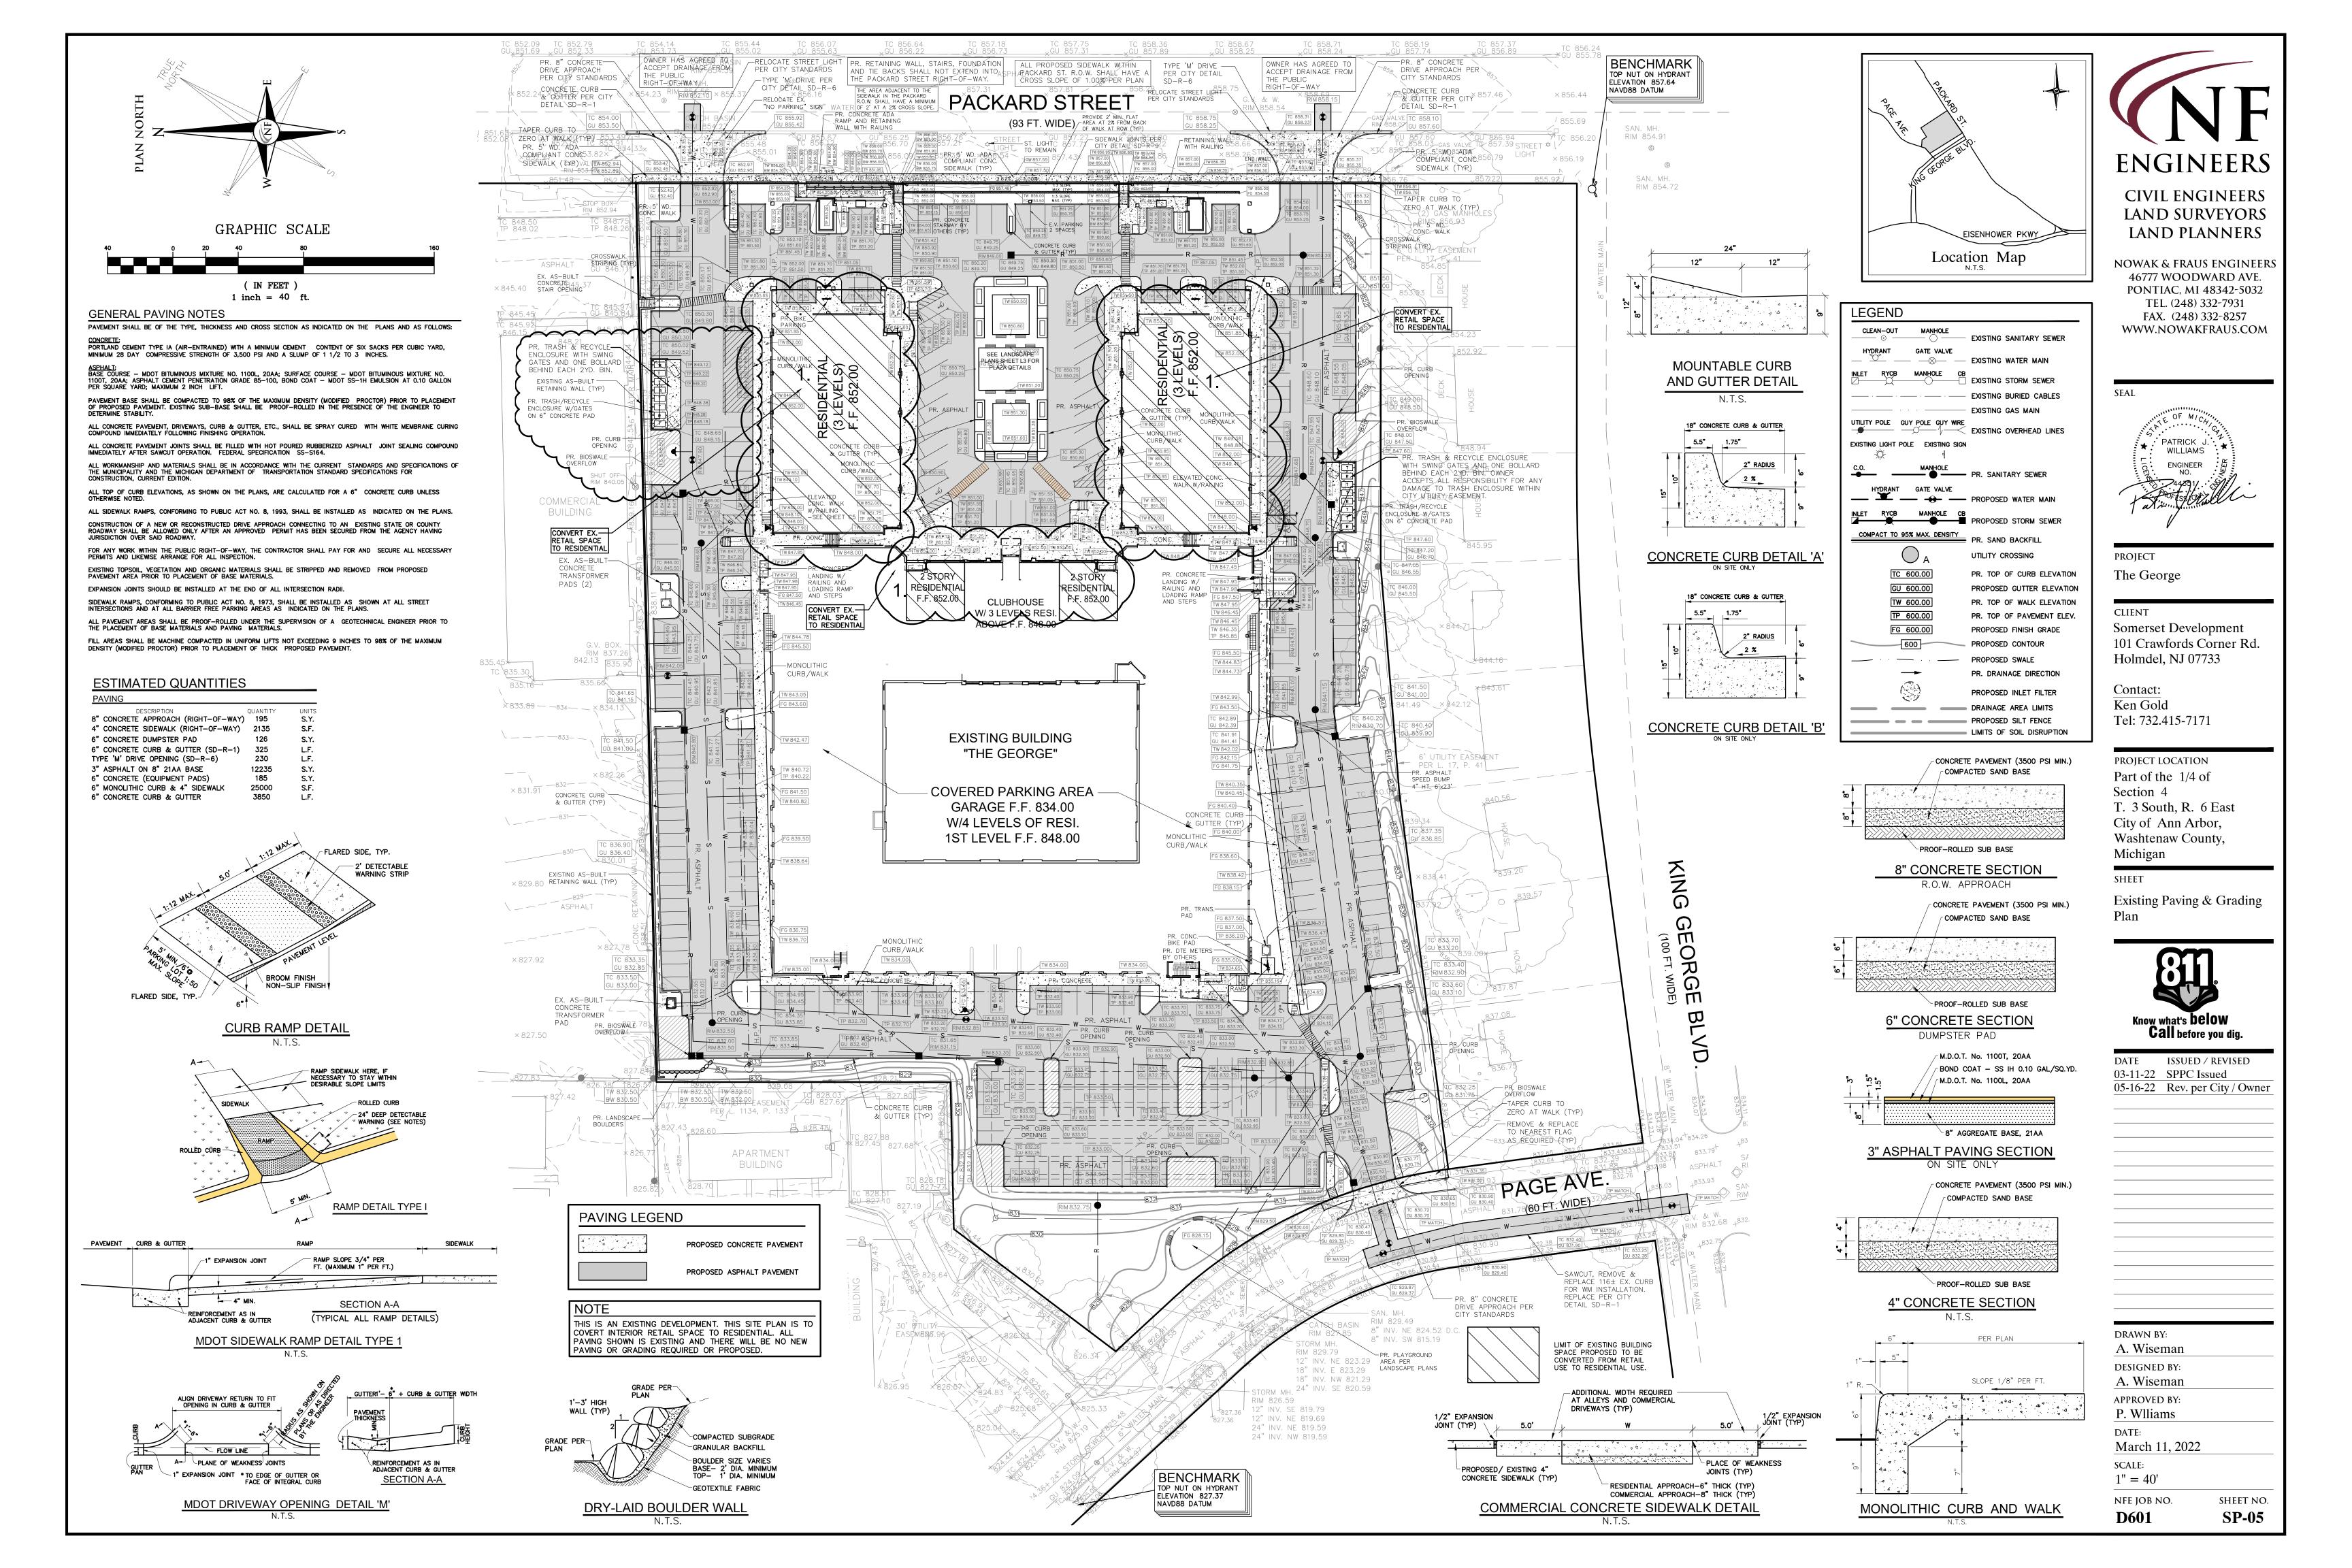
D601

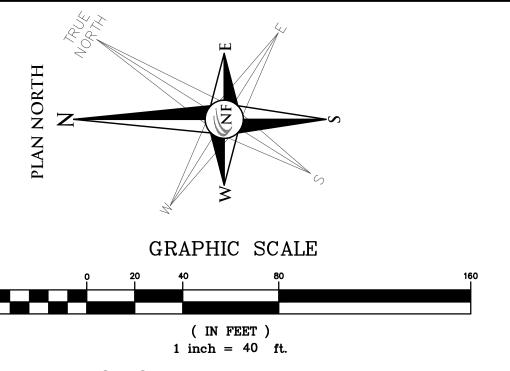
SP-04











SITE UTILITY NOTES

FIELD PRIOR TO INSTALLATION OF ANY NEW LINES.

CONFLICT WITH THE PROPOSED IMPROVEMENTS SHOWN.

REFER TO INTERIOR PLUMBING DRAWINGS FOR TIE-IN OF ALL UTILITIES.

CONTRACTOR IS RESPONSIBLE FOR REPAIRS OR DAMAGE TO ANY EXISTING UTILITY DURING CONSTRUCTION AT NO COST TO THE OWNER.

SEE SPECIFICATIONS FOR BACKFILLING AND COMPACTION REQUIREMENTS ON UTILITY TRENCHES. ALL FILL MATERIAL IS TO BE IN PLACE, AND COMPACTED BEFORE INSTALLATION OF PROPOSED UTILITIES. CONTRACTOR SHALL NOTIFY THE UTILITY AUTHORITIES INSPECTORS 72 HOURS BEFORE CONNECTING TO

ALL UTILITIES SHOULD BE KEPT TEN (10') FEET APART (PARALLEL) OR WHEN CROSSING 18" VERTICAL CLEARANCE (OUTSIDE EDGE OF PIPE TO OUTSIDE EDGE OF PIPE).

LINES UNDERGROUND SHALL BE INSTALLED, INSPECTED AND APPROVED BEFORE BACKFILLING. TOPS OF EXISTING MANHOLES SHALL BE RAISED AS NECESSARY TO BE FLUSH WITH PROPOSED PAVEMENT ELEVATION WITH WATER TIGHT LIDS. DRAWINGS DO NOT PURPORT TO SHOW ALL EXISTING UTILITIES. EXISTING UTILITIES SHALL BE VERIFIED IN

CONTRACTOR IS RESPONSIBLE FOR COMPLYING TO THE SPECIFICATIONS OF THE LOCAL AUTHORITIES (CITY OF ANN ARBOR/WASHTENAW COUNTY) WITH REGARDS TO MATERIALS AND INSTALLATION OF THE WATER

THE CONTRACTOR MUST CALL "811" AT LEAST 72 HOURS BEFORE ANY EXCAVATION TO REQUEST EXACT FIELD LOCATION OF UTILITIES. IT SHALL BE THE RESPONSIBILITY OF THE CONTRACTOR TO RELOCATE ALL EXISTING UTILITIES WHICH

ALL NECESSARY INSPECTIONS AND/OR CERTIFICATIONS REQUIRED BY CODES AND/OR UTILITY SERVICE COMPANIES SHALL BE PERFORMED PRIOR TO ANNOUNCED BUILDING POSSESSION AND THE FINAL CONNECTION OF SERVICE.

CONTRACTOR SHALL COORDINATE WITH ALL UTILITY COMPANIES FOR INSTALLATION REQUIREMENTS AND

CONTRACTOR SHALL REFER TO ARCHITECTURAL PLANS AND SPECIFICATIONS FOR ACTUAL LOCATION OF ALL UTILITY ENTRANCES TO INCLUDE SANITARY SEWER LATERALS, DOMESTIC AND FIRE PROTECTION WATER SERVICE, ELECTRICAL, TELEPHONE AND GAS SERVICE. CONTRACTOR SHALL COORDINATE INSTALLATION OF UTILITIES, IN SUCH A MANNER AS TO AVOID

CONFLICTS. AS WELL AS COORDINATING WITH CITY UTILITY REQUIREMENTS AS TO ASSURE PROPER LOCATION AND SCHEDULING FOR TIE-INS/CONNECTIONS PRIOR TO CONNECTING TO EXISTING UTILITIES. THE CONTRACTOR SHALL CONDUCT ALL REQUIRED TESTS TO THE SATISFACTION OF THE RESPECTIVE UTILITY COMPANIES AND THE OWNER'S INSPECTING AUTHORITIES.

CONTRACTOR SHALL COMPLY TO THE FULLEST EXTENT WITH THE LATEST STANDARDS OF OSHA DIRECTIVES OR ANY OTHER AGENCY HAVING JURISDICTION FOR EXCAVATION AND TRENCHING PROCEDURES. THE CONTRACTOR SHALL USE SUPPORT SYSTEMS, SLOPING, BENCHING, AND OTHER MEANS OF PROTECTION. THIS TO INCLUDE BUT NOT LIMITED FOR ACCESS AND EGRESS EXCAVATION AND TRENCHING. CONTRACTOR IS RESPONSIBLE TO COMPLY WITH PERFORMANCE FROM ALL CRITERIA FOR OSHA.

CONTRACTOR SHALL LOCATE ALL EXISTING UTILITIES PRIOR TO CONSTRUCTION

ALL STORM SEWER SHALL BE PREMIUM JOINT (RUBBER GASKET) DUE TO RESIDUAL CONTAMINATION ON SITE, VITON GASKETS MUST BE USED FROM STATION 4+00 TO STATION 6+25 ON THE PROPOSED SOUTH WATER MAIN LINE EXCEPT WHERE JOINT RESTRAINT I REQUIRED DUE TO THE USE OF VERTICAL BENDS, IN THESE SITUATIONS MECHANICAL JOINTS SHALL BI USED. THE PROPOSED 6" FIRE LINE AT STATION 6+04 AND 4" DOMESTIC LINE AT STATION 6+07 SHALL

PIPE BEDDING FOR WATER MAIN SHALL BE MINIMUM 4" THICK CITY OF ANN ARBOR CLASS II SAND

ALL SANITARY SEWER SHALL BE SUBJECT TO AIR AND MANDREL TESTING AND TELEVISION INSPECTION. NOTES

ALL CONSTRUCTION SHALL CONFORM TO THE PUBLIC SERVICES DEPARTMENT STANDARD SPECIFICATIONS DATED JANUARY 1, 1993, AND INCLUDE ALL UPDATES ISSUED AT THE TIME OF CONSTRUCTION PLAN

F THE CONSTRUCTION TO BE INSPECTED BY PUBLIC SERVICES DOES NOT COMMENCE WITH ONE YEAR OF THE DATE OF THE PUBLIC SERVICES INSPECTION REQUEST APPROVAL, THIS APPROVAL WILL EXPIRE AND HE CONSTRUCTION PLANS SHALL BE SUBJECT TO RE-REVIEW AND PAYMENT OF ALL APPLICABLE PLAN REVIEW FEES WILL BE REQUIRED.

THE PUBLIC SERVICES TECHNICIAN'S COPY OF THE STAMPED, APPROVED PLANS SHALL GOVERN THE PUBLIC SERVICES TECHNICIAN HAS THE RIGHT TO HALT CONSTRUCTION ACTIVITIES AND REQUIRE

THAT ITEMS THAT DO NOT MEET CITY STANDARDS BY REDONE/ REPLACED/ RECONSTRUCTED. MISS-DIG MUST BE NOTIFIED THREE (3) WORKING DAYS PRIOR TO CONSTRUCTION @ (800) 482-7171. ALL PERMITS AND APPROVED PLANS ARE TO BE ON-SITE AT ALL TIMES.

DISCONNECTION IS REQUIRED IN ACCORDANCE WITH CURRENT CITY SPECIFICATIONS OF ALL EXISTING BUILDING FOOTING DRAINS. FOOTING DRAINS REMOVED MAY OFFSET REQUIRED MITIGATION. PARKING LOT INLETS SHALL DRAIN TO THE SANITARY SEWER FOR ALL LEVELS LOCATED BELOW GRADE. THE FINAL LIMITS OF THE 6" WATER MAIN ABANDONMENT, AND ANY REQUIRED WATER SERVICE TRANSFERS, WILL BE DETERMINED AT THE CONSTRUCTION PLAN STAGE.

THE CONTRACTOR SHALL SUBMIT A DETAILED TRAFFIC CONTROL PLAN FOR INSTALLATION OF UTILITIES, UTILITY KILLS. AND SERVICE LEAD REPLACEMENTS. AS PEDESTRIAN ROUTES WILL BE DISRUPTED. PROPOSED PEDESTRIAN DETOUR ROUTE(S) DURING CONSTRUCTION SHALL ALSO BE PROVIDED.

UTILITY NOTES

ALSO RECEIVE VITON GASKETS.

TRENCH DETAIL SD-TD-1, SD-TD-4, SD-TD-5 AND SD-TD-7 OF DIVISION X OF THE CITY OF ANN ARBOR STANDARD DETAILS SHALL BE USED FOR PROPOSED WATERMAIN. TRENCH DETAIL SD-TD-4 AND DETAIL SD-S-7 DIVISION X OF THE CITY OF ANN ARBOR STANDARD DETAILS SHALL BE USED FOR PROPOSED SANITARY SEWER LEAD.

THE OMISSION OF ANY CURRENT STANDARD DETAIL DOES NOT RELIEVE THE CONTRACTOR FROM THIS

FIRE DEPARTMENT NOTES FIRE PROTECTION ALARM AND DETECTION SYSTEMS SHALL BE IN COMPLIANCE WITH ALL APPLICABLE CODES ADOPTED BY THE CITY OF ANN ARBOR.

KNOX BOX SHALL BE MOUNTED ON AN APPROVED EXTERIOR LOCATION FOR EMERGENCY ACCESS TO

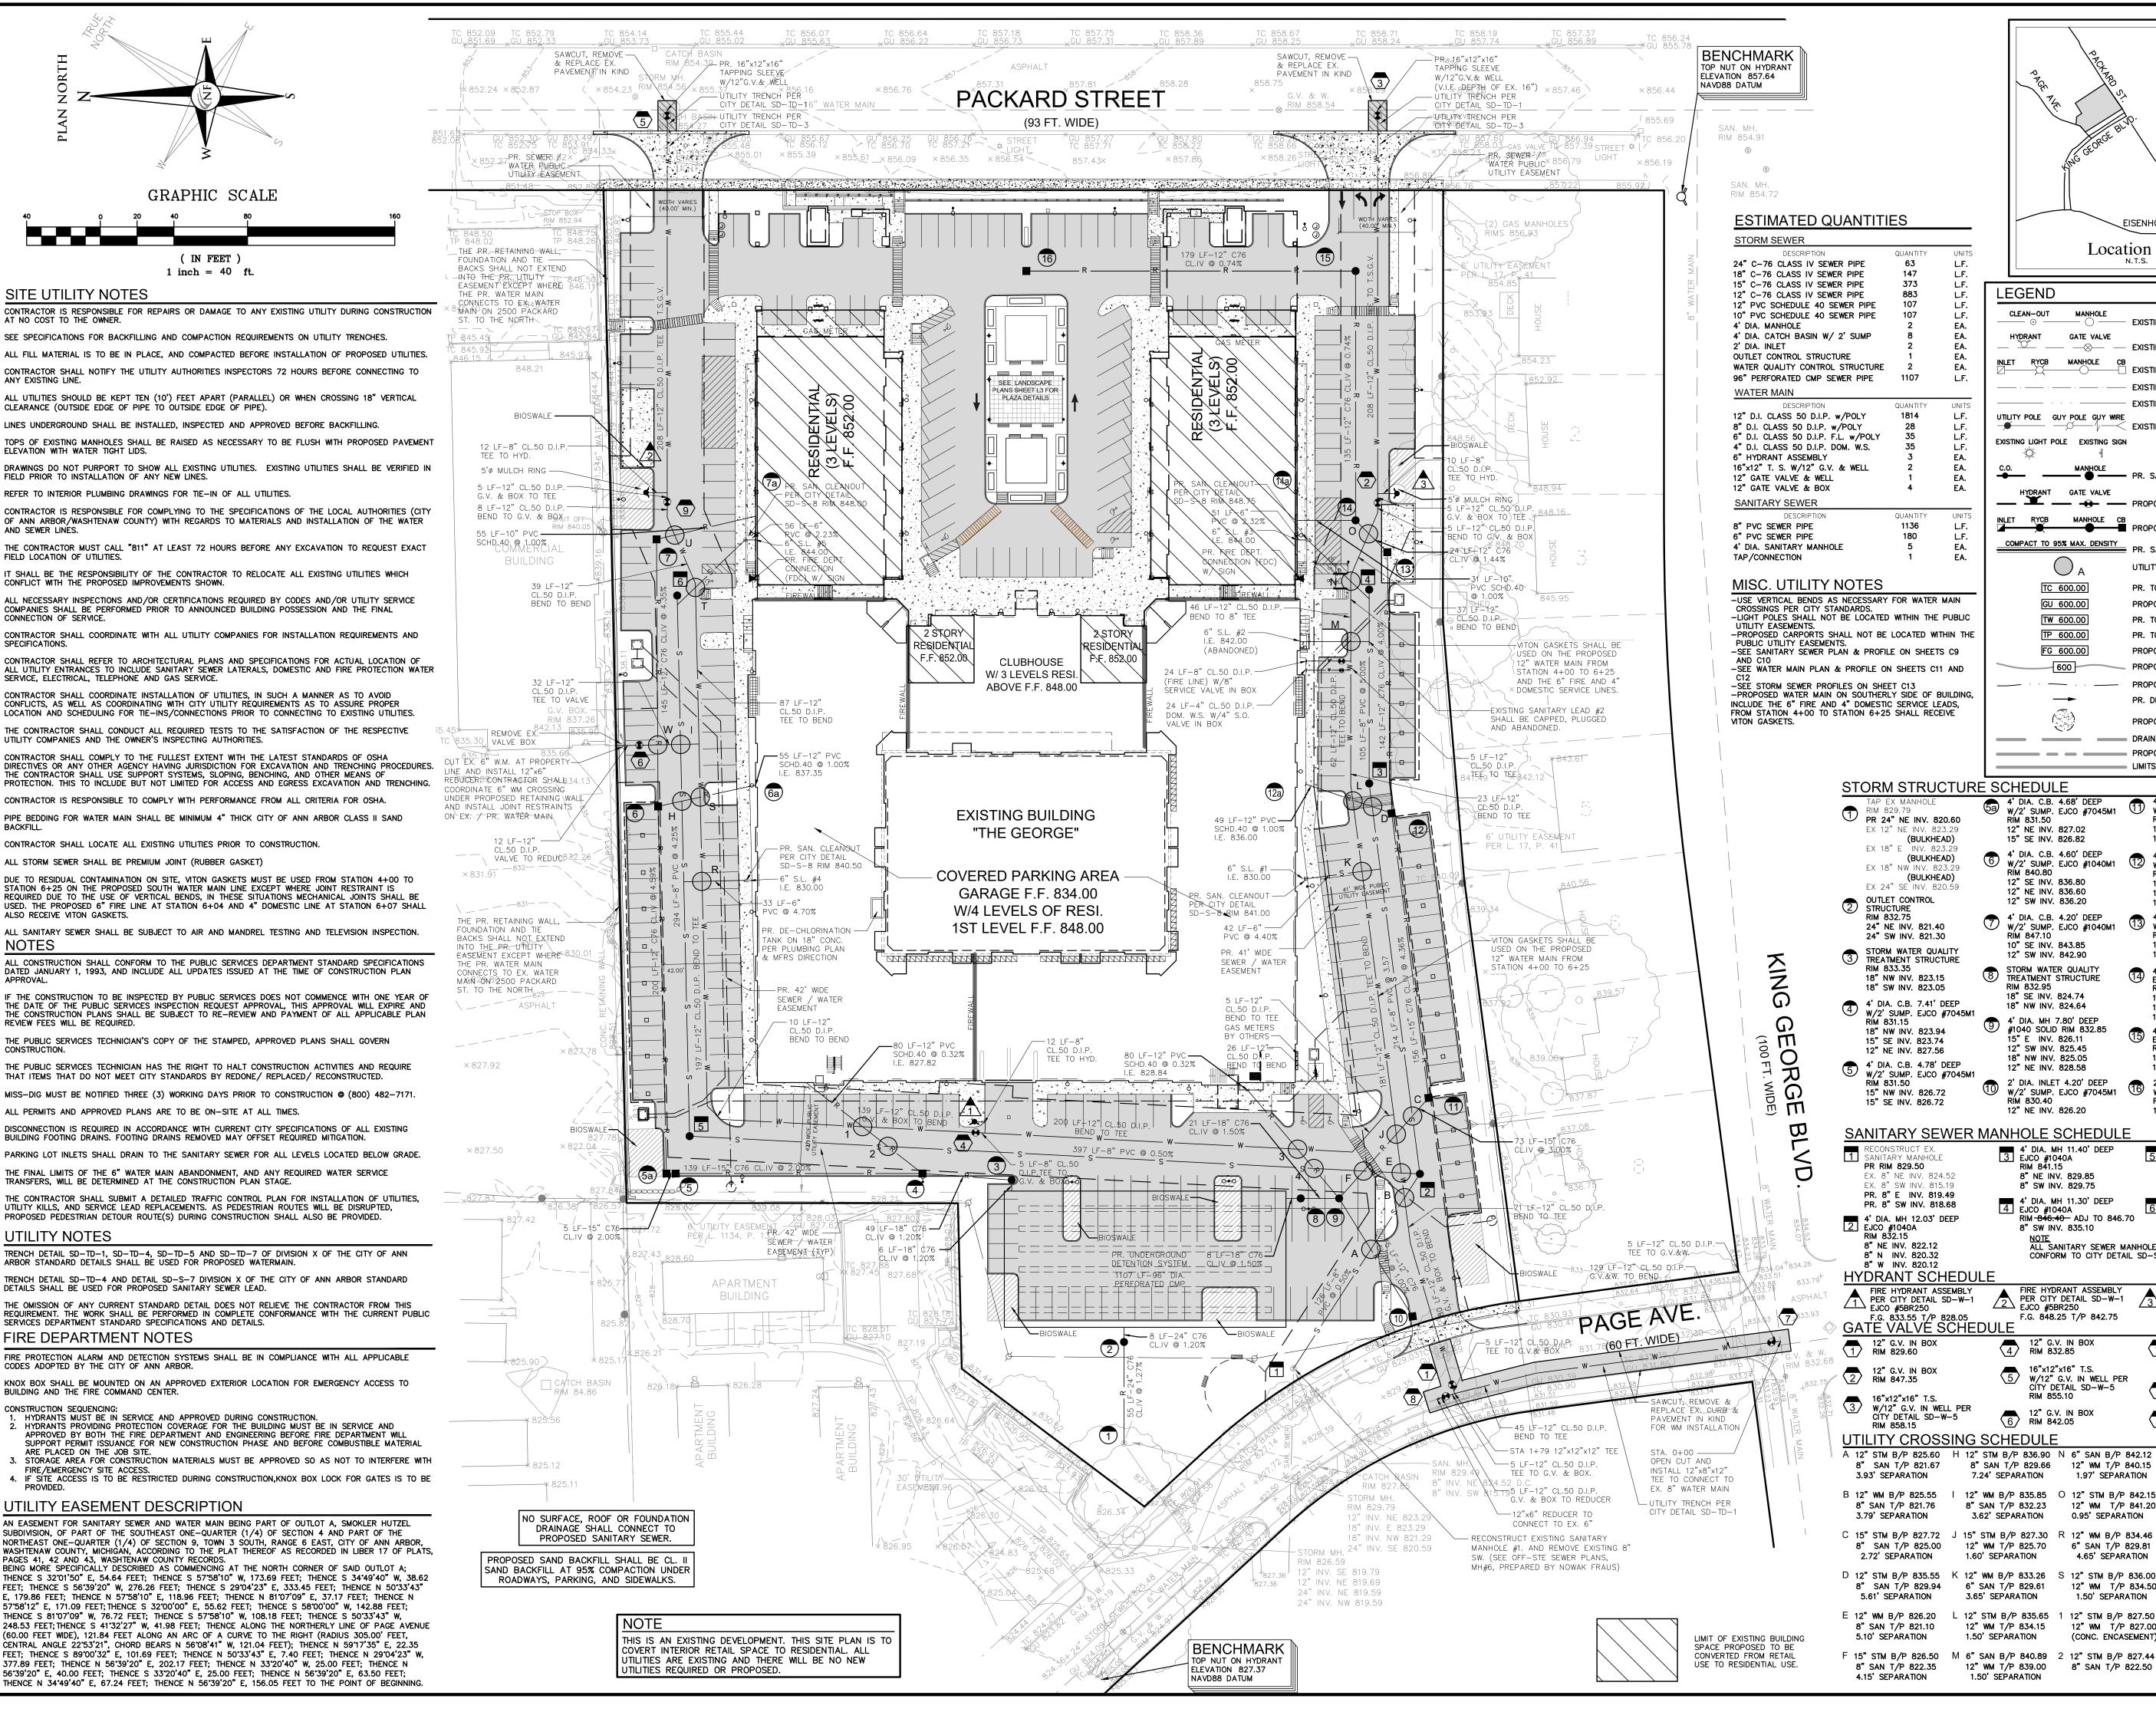
CONSTRUCTION SEQUENCING: HYDRANTS MUST BE IN SERVICE AND APPROVED DURING CONSTRUCTION. HYDRANTS PROVIDING PROTECTION COVERAGE FOR THE BUILDING MUST BE IN SERVICE AND APPROVED BY BOTH THE FIRE DEPARTMENT AND ENGINEERING BEFORE FIRE DEPARTMENT WILL

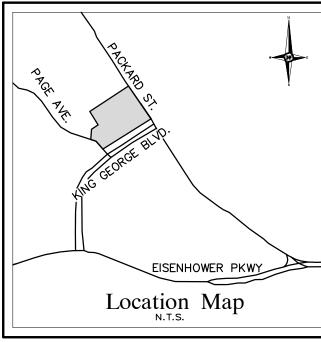
SUPPORT PERMIT ISSUANCE FOR NEW CONSTRUCTION PHASE AND BEFORE COMBUSTIBLE MATERIAL ARE PLACED ON THE JOB SITE. 3. STORAGE AREA FOR CONSTRUCTION MATERIALS MUST BE APPROVED SO AS NOT TO INTERFERE WITH FIRE/EMERGENCY SITE ACCESS. 4. IF SITE ACCESS IS TO BE RESTRICTED DURING CONSTRUCTION, KNOX BOX LOCK FOR GATES IS TO BE

UTILITY EASEMENT DESCRIPTION

SERVICES DEPARTMENT STANDARD SPECIFICATIONS AND DETAILS.

AN EASEMENT FOR SANITARY SEWER AND WATER MAIN BEING PART OF OUTLOT A, SMOKLER HUTZEL SUBDIVISION, OF PART OF THE SOUTHEAST ONE-QUARTER (1/4) OF SECTION 4 AND PART OF THE NORTHEAST ONE-QUARTER (1/4) OF SECTION 9, TOWN 3 SOUTH, RANGE 6 EAST, CITY OF ANN ARBOR, WASHTENAW COUNTY, MICHIGAN, ACCORDING TO THE PLAT THEREOF AS RECORDED IN LIBER 17 OF PLATS, PAGES 41. 42 AND 43. WASHTENAW COUNTY RECORDS. BEING MORE SPECIFICALLY DESCRIBED AS COMMENCING AT THE NORTH CORNER OF SAID OUTLOT A; THENCE S 32°01'50" E. 54.64 FEET: THENCE S 57°58'10" W. 173.69 FEET: THENCE S 34°49'40" W. 38.62 FFFT: THENCE S 56"39"20" W. 276.26 FFFT: THENCE S 29"04"23" F. 333.45 FFFT: THENCE N 50"33"43" E, 179.86 FEET; THENCE N 57'58'10" E, 118.96 FEET; THENCE N 81'07'09" E, 37.17 FEET; THENCE N 57'58'12" E, 171.09 FEET; THENCE S 32'00'00" E, 55.62 FEET; THENCE S 58'00'00" W, 142.88 FEET; THENCE S 81'07'09" W. 76.72 FEET: THENCE S 57'58'10" W. 108.18 FEET: THENCE S 50'33'43" W. 248.53 FEET; THENCE S 41°32'27" W, 41.98 FEET; THENCE ALONG THE NORTHERLY LINE OF PAGE AVENUE (60.00 FEET WIDE), 121.84 FEET ALONG AN ARC OF A CURVE TO THE RIGHT (RADIUS 305.00' FEET, CENTRAL ANGLE 22'53'21", CHORD BEARS N 56'08'41" W, 121.04 FEET); THENCE N 59"17'35" E, 22.35 FFET THENCE S 8900'32" F 101 69 FFET THENCE N 50'33'43" F 7 40 FFET THENCE N 29'04'23" W 377.89 FEET: THENCE N 56°39'20" E. 202.17 FEET: THENCE N 33°20'40" W. 25.00 FEET: THENCE N 56'39'20" E, 40.00 FEET; THENCE S 33'20'40" E, 25.00 FEET; THENCE N 56'39'20" E, 63.50 FEET; THENCE N 34'49'40" E, 67.24 FEET; THENCE N 56'39'20" E, 156.05 FEET TO THE POINT OF BEGINNING





LEGEND EXISTING SANITARY SEWER EA. EA. EA. --- --- EXISTING BURIED CABLES EXISTING GAS MAIN UTILITY POLE GUY POLE GUY WIRE EXISTING OVERHEAD LINES EA. EA. EA. GATE VALVE PROPOSED STORM SEWER COMPACT TO 95% MAX. DENSITY EA. PR. SAND BACKFILL UTILITY CROSSING TC 600.00 PR. TOP OF CURB ELEVATION GU 600.00 PROPOSED GUTTER ELEVATION TW 600.00 PR. TOP OF WALK ELEVATION TP 600.00 PR. TOP OF PAVEMENT ELEV. FG 600.00 PROPOSED FINISH GRADE PROPOSED CONTOUR PROPOSED SWALE PR. DRAINAGE DIRECTION PROPOSED INLET FILTER DRAINAGE AREA LIMITS PROPOSED SILT FENCE LIMITS OF SOIL DISRUPTION

STORM STRUCTURE SCHEDULE 4' DIA. C.B. 4.60' DEEP W/2' SUMP. EJCO #7045M1 4' DIA. C.B. 4.68' DEEP W/2' SUMP. EJCO #7045M1 RIM 829.79 RÍM 832.90 PR 24" NE INV. 820.60 RIM 831.50 15" NE INV. 828.40 12" NF INV. 827.02 (BULKHEAD) 15" SE INV. 826.82 15" W INV. 828.30 4' DIA. C.B. 4.60' DEEP 4' DIA. C.B. 4.50' DEEP 4' DIA. C.B. 4.60' DEEP W/2' SUMP. EJCO #1040M1 (BULKHEAD)) W/2' SUMP. EJCO #7045M1 RIM 840.80 (BULKHEAD) 12" SE INV. 836.80 12" NE INV. 836.60 12" NW INV. 835.51 OUTLET CONTROL STRUCTURE 15" SW INV. 835.20 RIM 832.75 4' DIA. C.B. 5.52' DEEP W/2' SUMP. EJCO #1040M1 4' DIA. C.B. 4.20' DEEP √ W/2' SUMP. EJCO #1040M1 24" NE INV. 821.40 RIM 846.60 ADJ TO 846.90 RÍM 847.10 24" SW INV. 821.30 STORM WATER QUALITY 10" SE INV. 843.85 12" NE INV. 842.13 12" SW INV. 841.08 12" SW INV. 842.90 TREATMENT STRUCTURE STORM WATER QUALITY TREATMENT STRUCTURE 4' DIA. MH 5.20' DEEP EJCO #1040 SOLID RIM 833.35 18" NW INV. 823.15 RIM 832.95 18" SW INV. 823.05 18" SE INV. 824.74 10" N INV. 842.69 4' DIA. C.B. 7.41' DEEP W/2' SUMP. EJCO #7045M1 18" NW INV. 824.64 12" NW INV. 842.58 9 4' DIA. MH 7.80' DEEP #1040 SOLID RIM 832 84 12" SW INV. 842.48 RÍM 831.15 #1040 SOLID RIM 832.85 18" NW INV. 823.94 4' DIA. MH 8.72' DEEP 15" E INV. 826.11 EJCO #1040 SOLID 15" SE INV. 823.74 12" SW INV. 825.45 RIM 852.30 12" NE INV. 827.56 18" NW INV. 825.05 12" NW INV. 843.68 4' DIA. C.B. 4.78' DEEP 12" NE INV. 828.58 12" SW INV. 843.58 W/2' SUMP. EJCO #7045M1 W/2' SUMP. EJCO #7045M1

2' DIA. INLET 4.00' DEEP

W/2' SUMP. EJCO #1040M4

RIM 830.40 RIM 831.50 15" NW INV. 826.72 RIM 830.40 15" SE INV. 826.72

W/2' SUMP. EJCO #1040M1 12" SE INV. 845.00 SANITARY SEWER MANHOLE SCHEDUL 4' DIA. MH 10.40' DEEP EJCO #1040A RIM 832.50 3 EJCO #1040A PR RIM 829.50 RIM 841.15 EX. 8" NE INV. 824.52 8" NF INV. 829.85 8" NE INV. 822.50 FX. 8" SW INV. 815.19 8" SW INV. 829.75 8" S INV. 822.30 PR. 8" E INV. 819.49 4' DIA MH 11.85' DEEP 4' DIA. MH 11.30' DEEP PR. 8" SW INV. 818.68 4 EJCO #1040A RIM 846.40 ADJ TO 846.70 EJCO #1040A RIM 846.65 ■ 4' DIA. MH 12.03' DEEP 2 | EJCO #1040A 8" SW INV. 835.10 8" SW INV. 835.00 NOTE.

ALL SANITARY SEWER MANHOLES SHALL 8" NE INV. 822.12 8" N INV. 820.32 CONFORM TO CITY DETAIL SD-S-1 8" W INV. 820.12 HYDRANT SCHEDUL FIRE HYDRANT ASSEMBLY
PER CITY DETAIL SD-W-1
EJCO #5BR250 FIRE HYDRANT ASSEMBLY
PER CITY DETAIL SD-W-1
EJCO #5BR250 FIRE HYDRANT ASSEMBLY PER CITY DETAIL SD-W-1 PER CITY DE ...
EJCO #5BR250
6 848.00 F.G. 848.25 T/P 842.75 F.G. 848.00 T/P 842.50 F.G. 833.55 T/P 828.05 GATE VALVÉ SCHEDUL 12" GATE VALVE IN WELL PER CITY 12" G.V. IN RIM 829.60 4 RIM 832.85 DETAIL SD-W-3 12" G.V. IN BOX RIM 847.35 16"x12"x16" T.S. W/12" G.V. IN WELL PER RIM 833.25 12" G.V. IN BOX CÍTY DETAIL SD-W-5 RIM 829.50 16"x12"x16" T.S. W/12" G.V. IN WELL PER 12" G.V. IN BOX RIM 842.05 RIM 858.15 JTILITY CROSSING SCHEDULE A 12" STM B/P 825.60 H 12" STM B/P 836.90 N 6" SAN B/P 842.12 T 6" SAN B/P 842.50

8" SAN T/P 821.67 8" SAN T/P 829.66 12" WM T/P 840.15 3.93' SEPARATION 7.24' SEPARATION 1.97' SEPARATION U 10" STM B/P 843.09 12" WM T/P 841.59 8" SAN T/P 821.76 8" SAN T/P 832.23 12" WM T/P 841.20 3.79' SEPARATION 3.62' SEPARATION 0.95' SEPARATION 12" WM T/P 836.95 C 15" STM B/P 827.72 J 15" STM B/P 827.30 R 12" WM B/P 834.46 3 12" STM B/P 828.50 8" SAN T/P 825.00 12" WM T/P 825.70 6" SAN T/P 829.81 12" WM T/P 828.00 2.72' SEPARATION 1.60' SEPARATION 4.65' SEPARATION (CONC. ENCASEMENT) D 12" STM B/P 835.55 K 12" WM B/P 833.26 S 12" STM B/P 836.00 12" WM T/P 834.50 4 12" STM B/P 828.64 8" SAN T/P 829.94 6" SAN T/P 829.61 3.65' SEPARATION 8" SAN T/P 821.33 5.61' SEPARATION 1.50' SEPARATION E 12" WM B/P 826.20 L 12" STM B/P 835.65 1 12" STM B/P 827.50

12" WM T/P 834.15 12" WM T/P 827.00

(CONC. ENCASEMENT)

8" SAN T/P 822.50

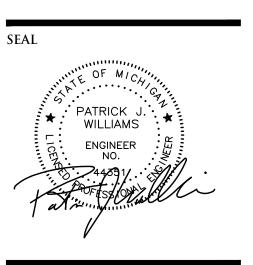
1.50' SEPARATION

12" WM T/P 839.00

1.50' SEPARATION



NOWAK & FRAUS ENGINEERS 46777 WOODWARD AVE PONTIAC, MI 48342-5032 TEL. (248) 332-7931 FAX. (248) 332-8257 WWW.NOWAKFRAUS.COM



PROJECT The George

CLIENT Somerset Development 101 Crawfords Corner Rd. Holmdel, NJ 07733

Contact: Ken Gold Tel: 732.415-7171

PROJECT LOCATION Part of the 1/4 of Section 4 T. 3 South, R. 6 East City of Ann Arbor, Washtenaw County, Michigan

SHEET Existing Utilities Plan



ISSUED / REVISED 03-11-22 SPPC Issued 05-16-22 Rev. per City / Owner

DRAWN BY: A. Wiseman **DESIGNED BY:** A. Wiseman APPROVED BY: P. Wlliams March 11, 2022 SCALE: 1'' = 40'NFE JOB NO. SHEET NO. **SP-06**

Maintenance Plan and Budget

Storm Water Management System Maintenance Plan for;

Packard Square LLC (owner)

- Responsibility for Maintenance
 - a. During construction, it is the developer's responsibility to perform the maintenance.
 - b. Following construction, it will be the responsibility of the owner to perform the maintenance.
- 2. Source of Financing

The owner is required to pay for all maintenance activities on a continuing basis.

- 3. Maintenance Tasks and Schedule
- a. See the charts below: The first describes maintenance tasks during construction to be performed by the developer, the second describes maintenance tasks by the owner.
- b. Immediately following construction, the developer will have the storm water management system inspected by an engineer to verify grades of the detention and filtration areas and make recommendations for any necessary sediment removal.

Maintenance Tasks and Schedule during Construction

	Compon	<u>ents</u>					Schedule
	Storm Sewer System	Catch Basin Sumps	Catch Basin Inlet Castings	Outflow Control Structures	Water Quality Structure	Storm Detention Pipe	
Tasks							
Inspect for Sediment accumulation	Х	Х	Х	Х	Х	Х	Weekly
Removal of sediment accumulation	X	Х	Х	Х	Х	Х	As needed & prior to turnover
Inspect for floatables and debris		X		Х	Х		Quarterly
Cleaning of flotables and debris		Х		X	Х		Quarterly & at turnover
Make adjustments or replacements as determined by pre- turnover inspection	x	x	х	х	x	x	As needed

	Compone	nts				Schedule
	Storm Sewer System	Catch Basin Inlet Casings	Outflow Control Structure	Water Quality Structure	Storm Detention Pipe	
Tasks						
Inspect for Sediment accumulation	Х	X	X	Х	X	Annually
Removal of sediment accumulation	X	х	X	Х	X	Every 2 years as needed
Inspect for floatables and debris		х	X	Х	X	Annually
Cleaning of flotables and debris		Х	X	X	×	Annually
Inspect structural elements during wet weather	Х	X	X	Х	X	Annually
Make adjustments or replacements as determined by annual wet weather inspection	X	х	x	Х	X	As Needed
Keep records of all inspections and maintenance activities and report to owner						Annually
Keep records of all costs for inspections, maintenance and repairs. Report to owner						Annually

A	#200.00
Annual inspection for sediment accumulation	\$200.00
Removal of sediment accumulation every 2 years as needed	\$600.00
Inspect for floatables and debris annually and after major storms	\$150.00
Removal of floatables and debris annually and after major storms	\$200.00
Inspect structural elements during wet weather and compare to asbuilt plans every 2 years	\$150.00
Make structural adjustments or replacements as determined by inspection as needed	\$400.00
Have professional engineer carry out emergency inspections upon identification of severe problems	\$600.00
Total Annual Budget	\$2,300.00



NOWAK & FRAUS ENGINEERS 46777 WOODWARD AVE. PONTIAC, MI 48342-5032 TEL. (248) 332-7931 FAX. (248) 332-8257 WWW.NOWAKFRAUS.COM

LAND PLANNERS

SFAI



PROJECT
The George

CLIENT
Somerset Development
101 Crawfords Corner Rd.
Holmdel, NJ 07733

Contact: Ken Gold Tel: 732.415-7171

PROJECT LOCATION
Part of the 1/4 of
Section 4
T. 3 South, R. 6 East
City of Ann Arbor,
Washtenaw County,
Michigan

SHEET

Storm Water Maintenance Plan and Budget



DATE ISSUED / REVISED
03-11-22 SPPC Issued
05-16-22 Rev. per City / Owner

DRAWN BY:

A Wiseman

A. Wiseman

DESIGNED BY:

A. Wiseman

A. Wiseman

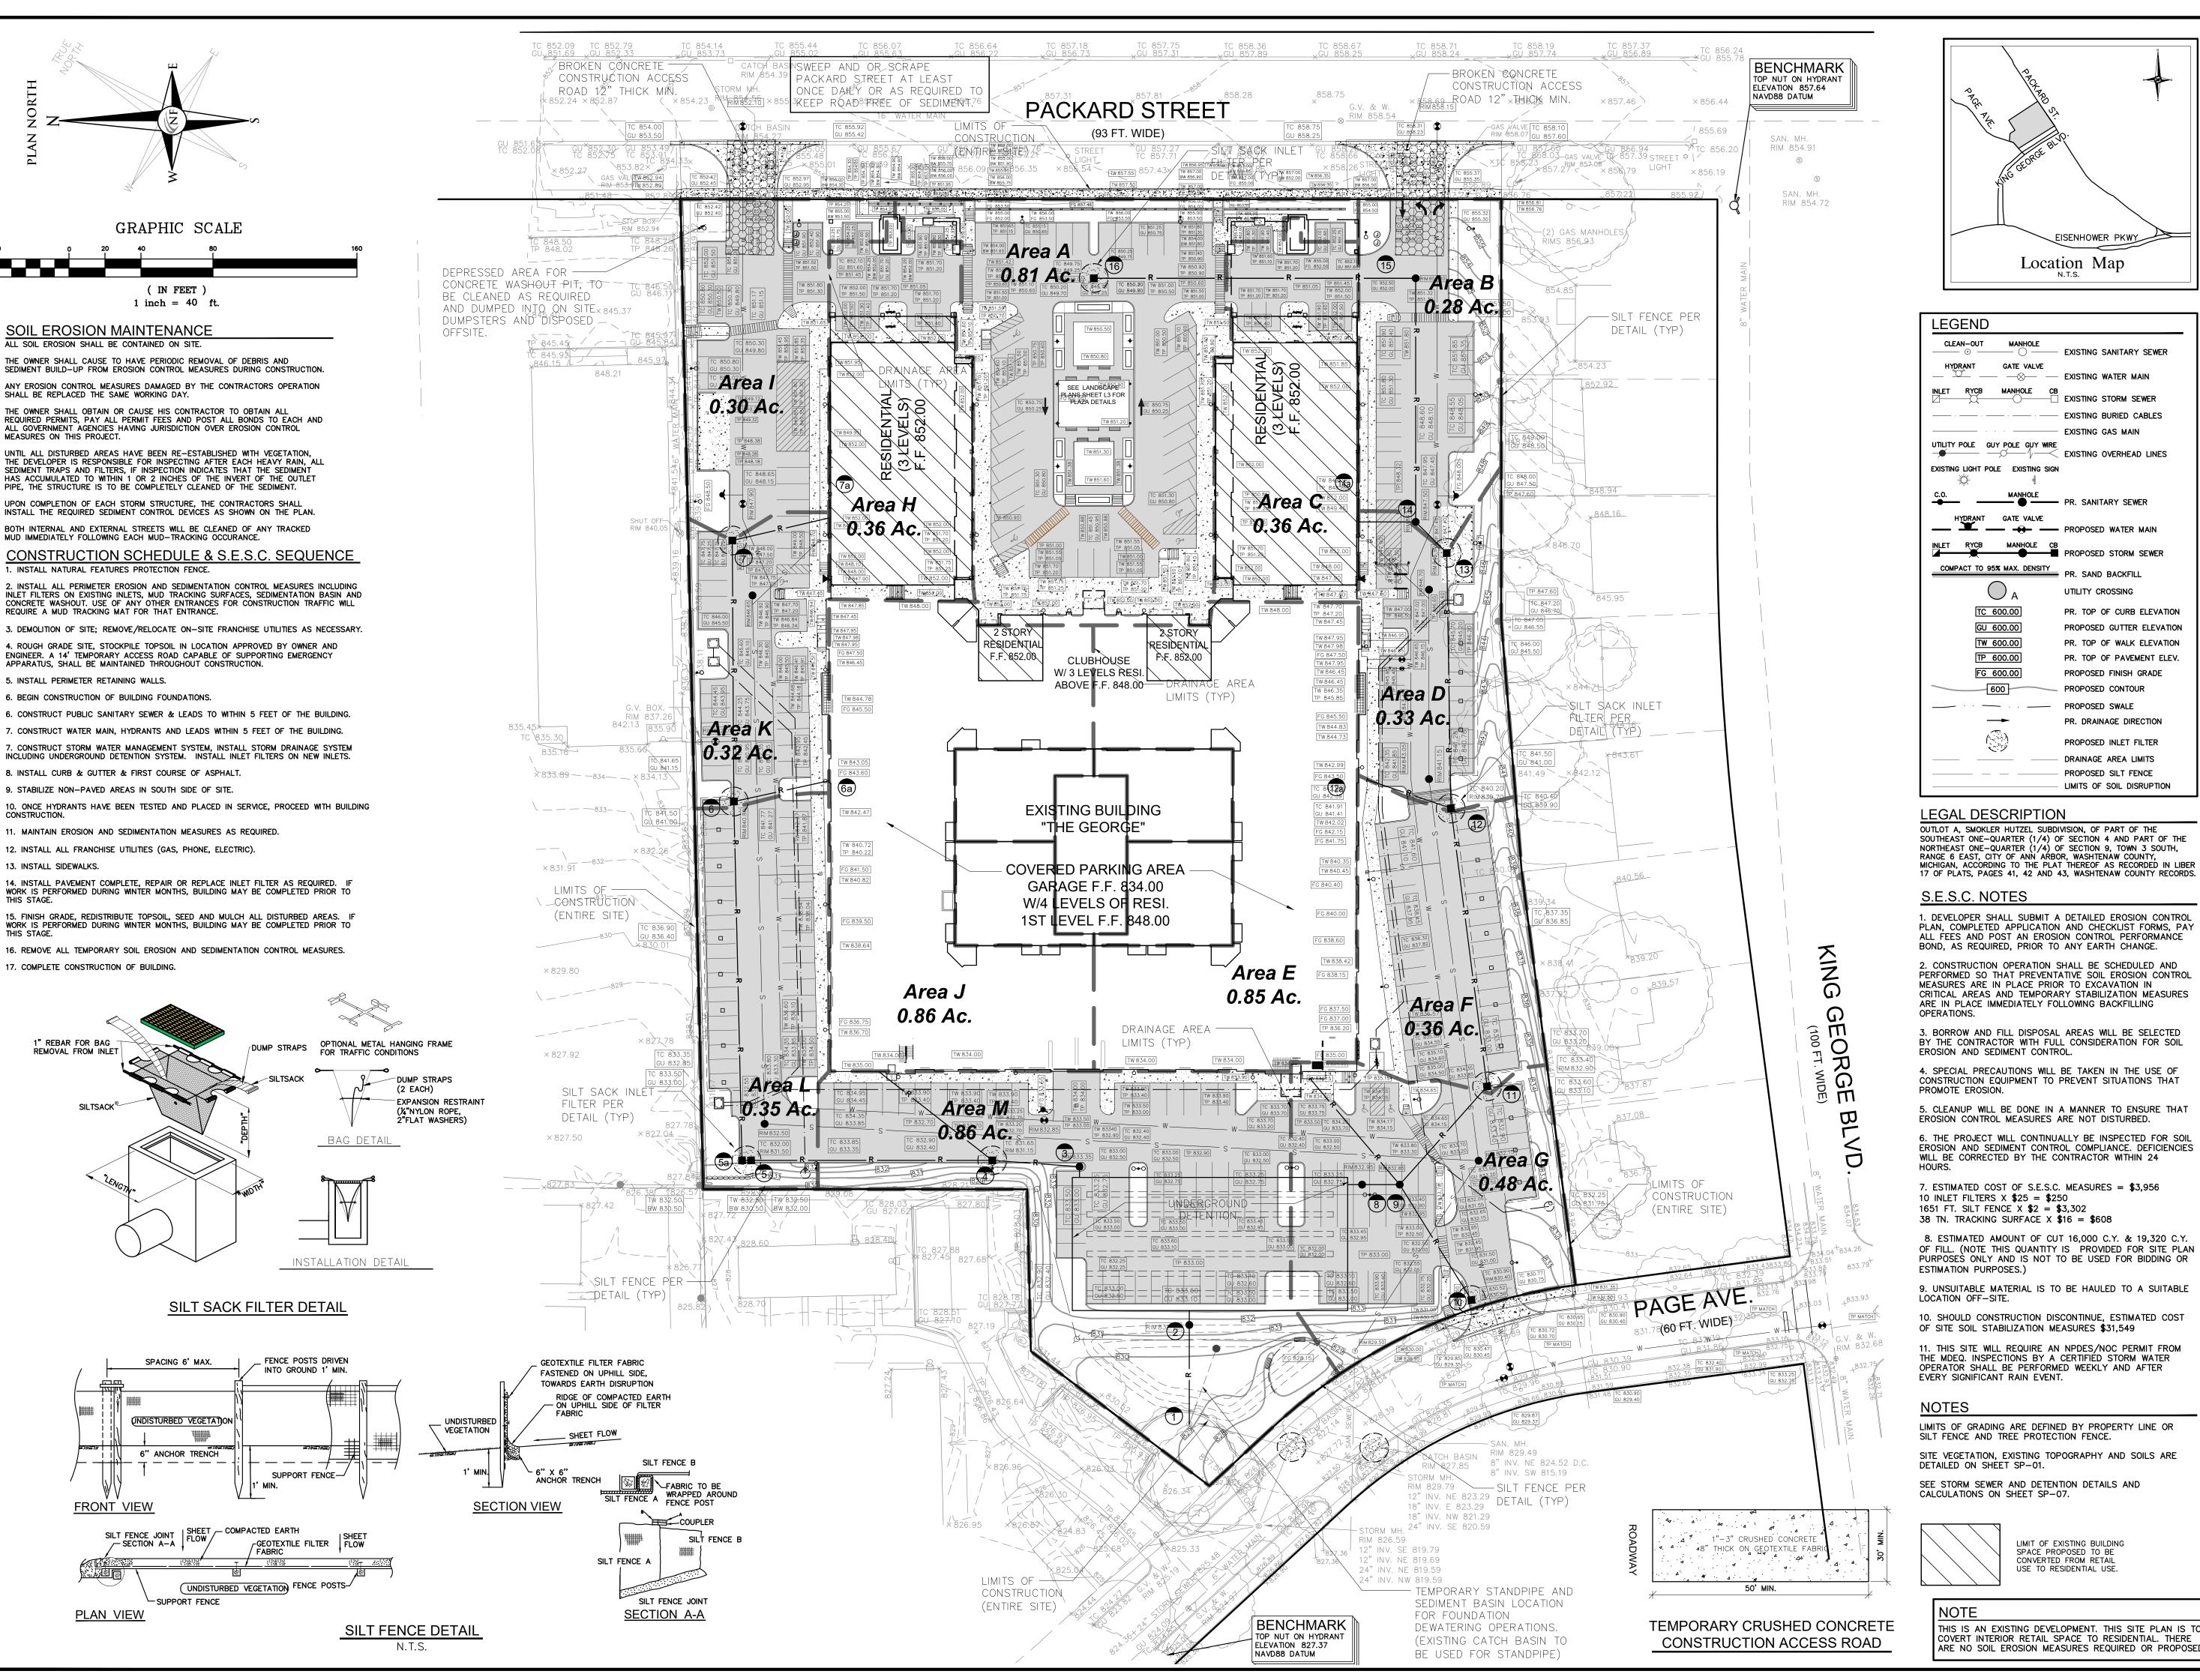
APPROVED BY:

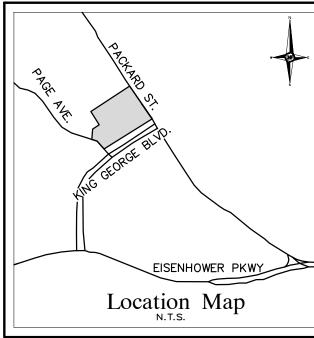
P. Wlliams
DATE:

March 11, 2022 SCALE:

 $\frac{1" = 40'}{\text{NFE IOB NO.}}$

NFE JOB NO. SHEET NO. **SP-08**





EXISTING SANITARY SEWER

EXISTING GAS MAIN

PR. SAND BACKFILL

UTILITY CROSSING

PR. TOP OF CURB ELEVATION

PROPOSED GUTTER ELEVATION

PR. TOP OF WALK ELEVATION

PR. TOP OF PAVEMENT ELEV.

PROPOSED FINISH GRADE

PR. DRAINAGE DIRECTION

PROPOSED INLET FILTER

DRAINAGE AREA LIMITS

PROPOSED SILT FENCE LIMITS OF SOIL DISRUPTION

PROPOSED CONTOUR

PROPOSED SWALE

GATE VALVE



NOWAK & FRAUS ENGINEERS 46777 WOODWARD AVE. PONTIAC, MI 48342-5032 TEL. (248) 332-7931 FAX. (248) 332-8257 WWW.NOWAKFRAUS.COM

EXISTING STORM SEWER SEAL - EXISTING BURIED CABLES PATRICK J WILLIAMS ENGINEER NO. PROJECT

The George

CLIENT

Somerset Development 101 Crawfords Corner Rd. Holmdel, NJ 07733

Contact: Ken Gold Tel: 732.415-7171

PROJECT LOCATION Part of the 1/4 of Section 4 T. 3 South, R. 6 East City of Ann Arbor, Washtenaw County,

Michigan

SHEET Soil Erosion and Sedimentation Control Plan



Call before you dig. DATE ISSUED / REVISED

03-11-22 SPPC Issued 05-16-22 Rev. per City / Owner

9. UNSUITABLE MATERIAL IS TO BE HAULED TO A SUITABLE

10. SHOULD CONSTRUCTION DISCONTINUE, ESTIMATED COST OF SITE SOIL STABILIZATION MEASURES \$31,549

11. THIS SITE WILL REQUIRE AN NPDES/NOC PERMIT FROM THE MDEQ. INSPECTIONS BY A CERTIFIED STORM WATER OPERATOR SHALL BE PERFORMED WEEKLY AND AFTER

LIMITS OF GRADING ARE DEFINED BY PROPERTY LINE OR SILT FENCE AND TREE PROTECTION FENCE. SITE VEGETATION, EXISTING TOPOGRAPHY AND SOILS ARE DETAILED ON SHEET SP-01.

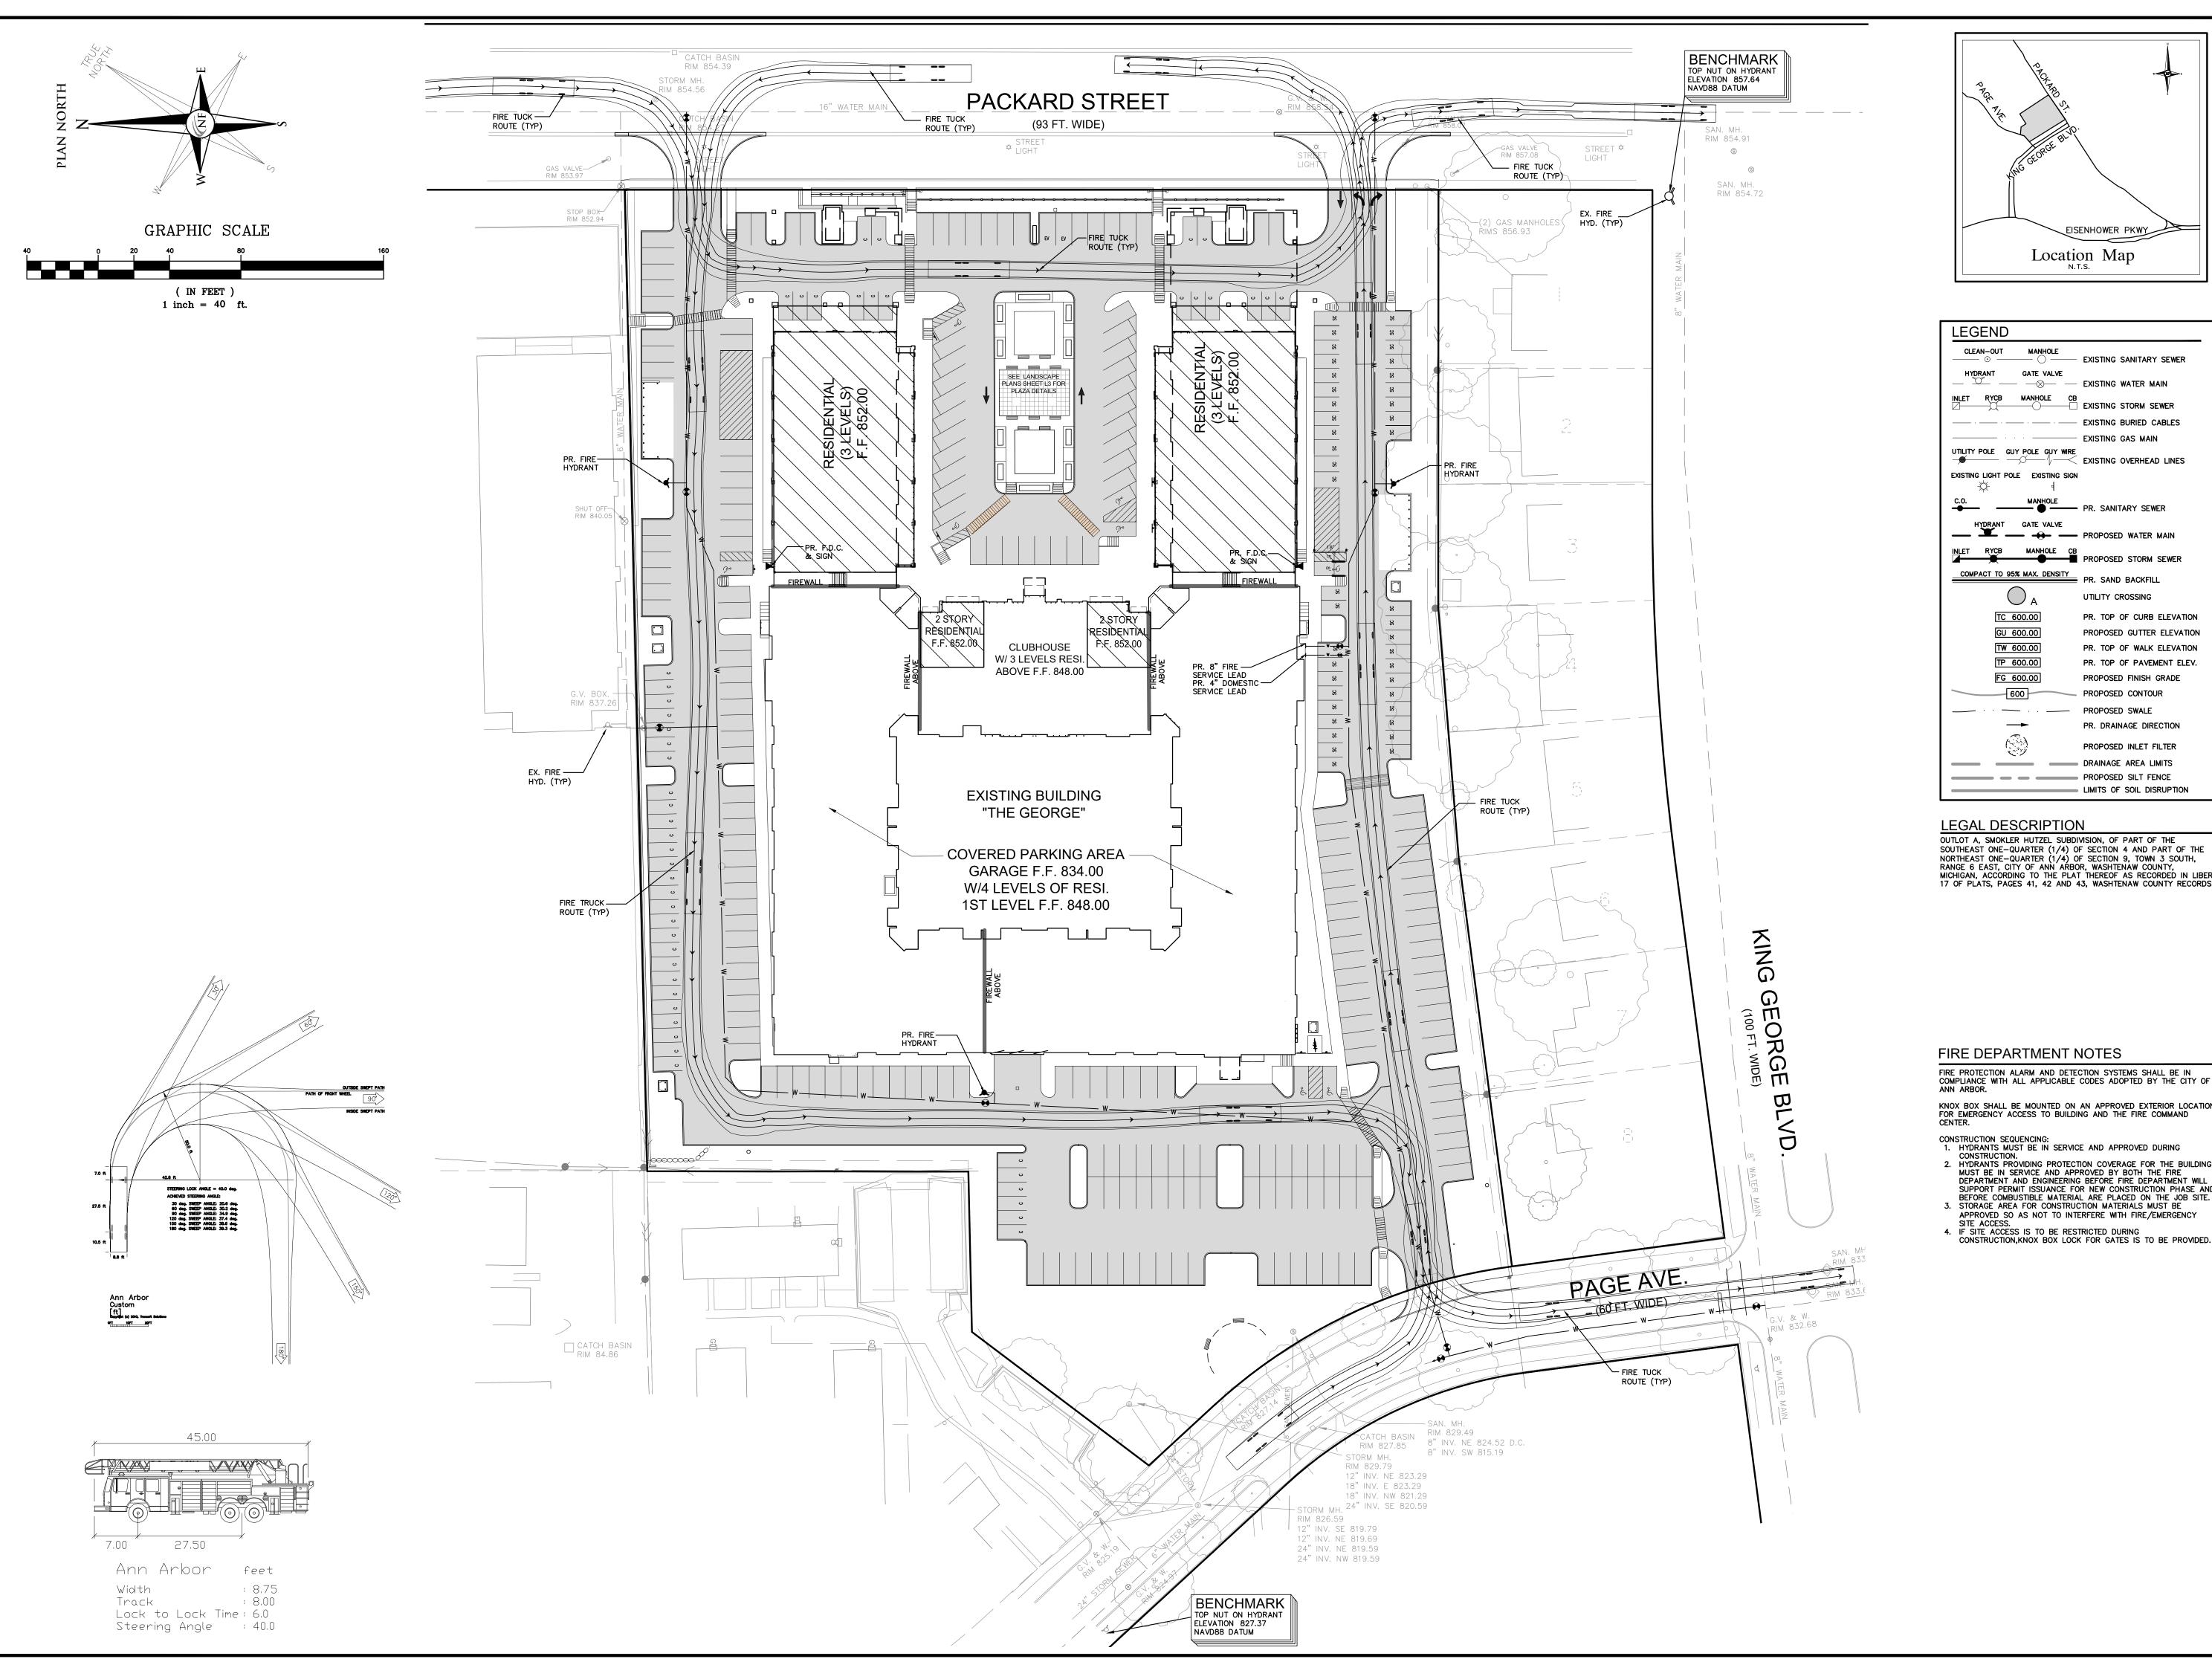
SEE STORM SEWER AND DETENTION DETAILS AND CALCULATIONS ON SHEET SP-07.



LIMIT OF EXISTING BUILDING SPACE PROPOSED TO BE CONVERTED FROM RETAIL USE TO RESIDENTIAL USE.

THIS IS AN EXISTING DEVELOPMENT. THIS SITE PLAN IS TO COVERT INTERIOR RETAIL SPACE TO RESIDENTIAL. THERE ARE NO SOIL EROSION MEASURES REQUIRED OR PROPOSED. DRAWN BY: A. Wiseman **DESIGNED BY:** A. Wiseman APPROVED BY: P. Wlliams DATE: March 11, 2022 SCALE: 1'' = 40'

NFE JOB NO. SHEET NO. **SP-09 D601**





CLEAN-OUT MANHOLE
O O CENTRAL EXISTING SANITARY SEWER

EXISTING STORM SEWER

----- EXISTING GAS MAIN

PR. SANITARY SEWER

MANHOLE CB PROPOSED STORM SEWER

UTILITY CROSSING

PR. TOP OF CURB ELEVATION

PROPOSED GUTTER ELEVATION

PR. TOP OF WALK ELEVATION

PR. TOP OF PAVEMENT ELEV.

PROPOSED FINISH GRADE

PROPOSED INLET FILTER

LIMITS OF SOIL DISRUPTION

PROPOSED CONTOUR

PROPOSED SWALE PR. DRAINAGE DIRECTION

DRAINAGE AREA LIMITS

PROPOSED SILT FENCE

OUTLOT A, SMOKLER HUTZEL SUBDIVISION, OF PART OF THE

- $\overset{\smile}{\smile}$ - \otimes - Existing water main

EXISTING BURIED CABLES

UTILITY POLE GUY POLE GUY WIRE

EXISTING OVERHEAD LINES

COMPACT TO 95% MAX. DENSITY PR. SAND BACKFILL

LEGEND

HYDRANT GATE VALVE

INLET RYCB MANHOLE CB

EXISTING LIGHT POLE EXISTING SIGN

TC 600.00

TW 600.00

FG 600.00



NOWAK & FRAUS ENGINEERS 46777 WOODWARD AVE. PONTIAC, MI 48342-5032 TEL. (248) 332-7931 FAX. (248) 332-8257 WWW.NOWAKFRAUS.COM

SEAL · PATRICK J. WILLIAMS ENGINEER NO.

PROJECT The George

CLIENT Somerset Development 101 Crawfords Corner Rd. Holmdel, NJ 07733

Contact: Ken Gold Tel: 732.415-7171

PROJECT LOCATION Part of the 1/4 of Section 4 NORTHEAST ONE—QUARTER (1/4) OF SECTION 9, TOWN 3 SOUTH, RANGE 6 EAST, CITY OF ANN ARBOR, WASHTENAW COUNTY, MICHIGAN, ACCORDING TO THE PLAT THEREOF AS RECORDED IN LIBER T. 3 South, R. 6 East City of Ann Arbor, 17 OF PLATS, PAGES 41, 42 AND 43, WASHTENAW COUNTY RECORDS. Washtenaw County, Michigan

SHEET

Fire Protection Plan

FIRE DEPARTMENT NOTES

FIRE PROTECTION ALARM AND DETECTION SYSTEMS SHALL BE IN COMPLIANCE WITH ALL APPLICABLE CODES ADOPTED BY THE CITY OF ANN ARBOR. KNOX BOX SHALL BE MOUNTED ON AN APPROVED EXTERIOR LOCATION FOR EMERGENCY ACCESS TO BUILDING AND THE FIRE COMMAND CENTER.

CONSTRUCTION SEQUENCING:

1. HYDRANTS MUST BE IN SERVICE AND APPROVED DURING CONSTRUCTION.

- 2. HYDRANTS PROVIDING PROTECTION COVERAGE FOR THE BUILDING MUST BE IN SERVICE AND APPROVED BY BOTH THE FIRE DEPARTMENT AND ENGINEERING BEFORE FIRE DEPARTMENT WILL SUPPORT PERMIT ISSUANCE FOR NEW CONSTRUCTION PHASE AND BEFORE COMBUSTIBLE MATERIAL ARE PLACED ON THE JOB SITE.

 3. STORAGE AREA FOR CONSTRUCTION MATERIALS MUST BE
- APPROVED SO AS NOT TO INTERFERE WITH FIRE/EMERGENCY SITE ACCESS.
- 4. IF SITE ACCESS IS TO BE RESTRICTED DURING CONSTRUCTION, KNOX BOX LOCK FOR GATES IS TO BE PROVIDED.

 Output

 Description:



DATE ISSUED / REVISED 03-11-22 SPPC Issued 05-16-22 Rev. per City / Owner

DRAWN BY: A. Wiseman **DESIGNED BY:** A. Wiseman APPROVED BY: P. Wlliams DATE: March 11, 2022 SCALE: 1'' = 40'

NFE JOB NO.

D601

SHEET NO. **SP-10**

Statistics							
Description	Symbol	Avg	Max	Min	Max/Min	Avg/Min	Avg/Max
Grade @ 0'	+	1.2 fc	7.6 fc	0.0 fc	N/A	N/A	0.2:1
Residential Parking	Ж	2.7 fc	5.8 fc	0.3 fc	19.3:1	9.0:1	0.5:1
Retail Parking	Ж	2.3 fc	5.0 fc	0.5 fc	10.0:1	4.6:1	0.5:1
RESIDENTIAL PROPERTY EDGE	+	0.1 fc	0.1 fc	0.0 fc	N/A	N/A	1.0:1

Symbol	Label	Quantity	Manufacturer	Catalog Number	Description	Lamp	Lumens Per Lamp	Wattage
	A	3	Lithonia Lighting	DSX1 LED P3 30K T5W MVOLT	DSX1 LED P3 30K T5W MVOLT	LED	12039	204
	В	2	Lithonia Lighting	DSX1 LED P3 30K T3M MVOLT	DSX1 LED P3 30K T3M MVOLT	LED	11338	102
	С	10	Lithonia Lighting	DSX1 LED P4 30K T3M MVOLT	DSX1 LED P4 30K T3M MVOLT	LED	13064	125
	D	11	Lithonia Lighting	DSX1 LED P4 30K BLC MVOLT	DSX1 LED P4 30K BLC MVOLT	LED	11026	125
	Е	3	Lithonia Lighting	DSX1 LED P3 30K T4M MVOLT	DSX1 LED P3 30K T4M MVOLT	LED	11426	102
	F	13	Lithonia Lighting	DSX1 LED P1 30K T4M MVOLT	DSX1 LED P1 30K T4M MVOLT	LED	6327	54
	G	23	Lithonia Lighting	VCPG LED P1 30K LANE MVOLT	VCPG LED WITH P1 - PERFORMANCE PACKAGE, 3000K, LANE OPTIC TYPE FACTORY TUNED DRIVER	LED	3507	26.57
	Н	8	Lithonia Lighting	RADPT P1 30K SYM	RADEAN Post-Top with P1 3000K Symmetric distribution	LED	3189	25.4134

General Note

1. SEE DRAWING FOR LUMINAIRE MOUNTING HEIGHT.

2. CALCULATIONS ARE SHOWN IN FOOTCANDLES AT: 0' - 0"

3. LIGHTING ALTERNATES REQUIRE NEW PHOTOMETRIC CALCULATION AND RESUBMISSION TO CITY FOR APPROVAL.

THE ENGINEER AND/OR ARCHITECT MUST DETERMINE APPLICABILITY OF THE LAYOUT TO EXISTING / FUTURE FIELD CONDITIONS. THIS LIGHTING LAYOUT REPRESENTS ILLUMINATION LEVELS CALCULATED FROM LABORATORY DATA TAKEN UNDER CONTROLLED CONDITIONS IN ACCORDANCE WITH ILLUMINATING ENGINEERING SOCIETY APPROVED METHODS. ACTUAL PERFORMANCE OF ANY MANUFACTURER'S LUMINAIRE MAY VARY DUE TO VARIATION IN ELECTRICAL VOLTAGE, TOLERANCE IN LAMPS, AND OTHER VARIABLE FIELD CONDITIONS. MOUNTING HEIGHTS INDICATED ARE FROM GRADE AND/OR FLOOR UP.

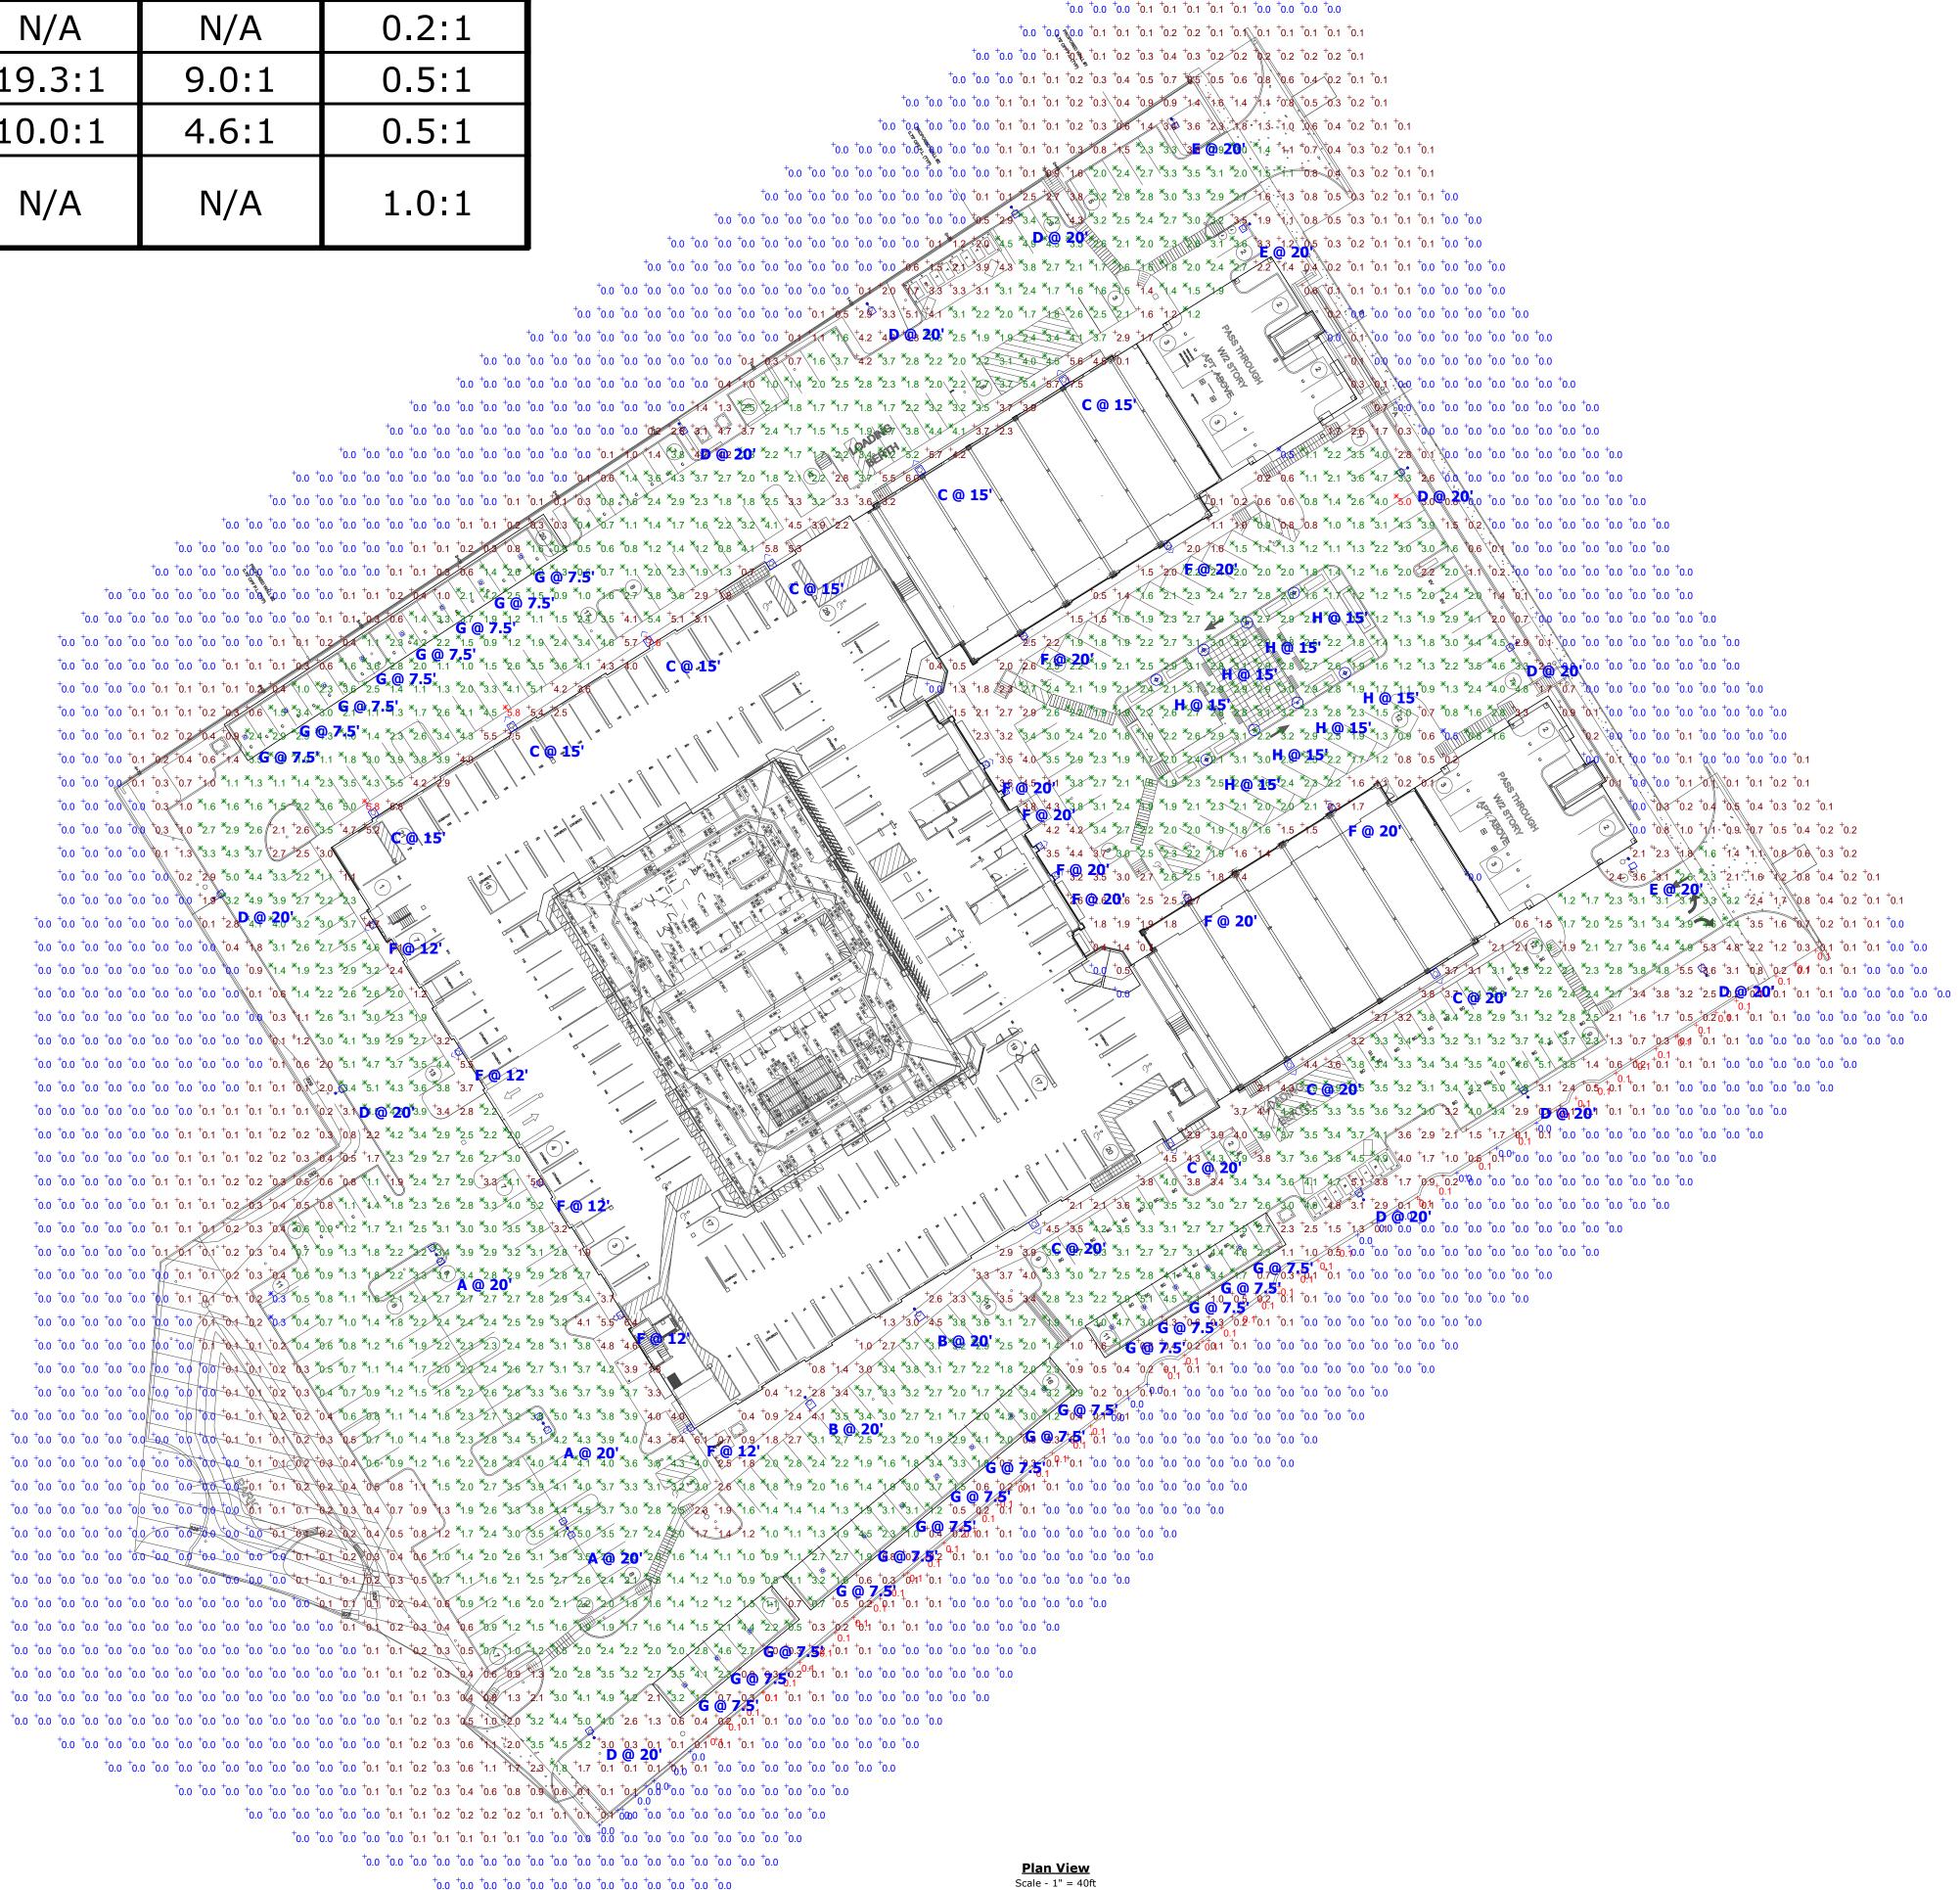
THESE LIGHTING CALCULATIONS ARE NOT A SUBSTITUTE FOR INDEPENDENT ENGINEERING ANALYSIS OF LIGHTING SYSTEM SUITABILITY AND SAFETY. THE ENGINEER AND/OR ARCHITECT IS RESPONSIBLE TO REVIEW FOR MICHIGAN ENERGY CODE AND LIGHTING QUALITY COMPLIANCE.

UNLESS EXEMPT, PROJECT MUST COMPLY WITH LIGHTING CONTROLS REQUIRMENTS DEFINED IN ASHRAE 90.1 2013. FOR SPECIFIC INFORMATION CONTACT GBA CONTROLS GROUP AT ASG@GASSERBUSH.COM OR 734-266-6705.

FOR ORDERING INQUIRIES CONTACT GASSER BUSH AT QUOTES@GASSERBUSH.COM OR 734-266-6705.

THIS DRAWING WAS GENERATED FROM AN ELECTRONIC IMAGE FOR ESTIMATION PURPOSE ONLY. LAYOUT TO BE VERIFIED IN FIELD BY OTHERS.

MOUNTING HEIGHT IS MEASURED FROM GRADE TO FACE OF FIXTURE. POLE HEIGHT SHOULD BE CALCULATED AS THE MOUNTING HEIGHT LESS BASE HEIGHT.



+0.0 +0.0 +0.0 +0.0 +0.0 +0.0

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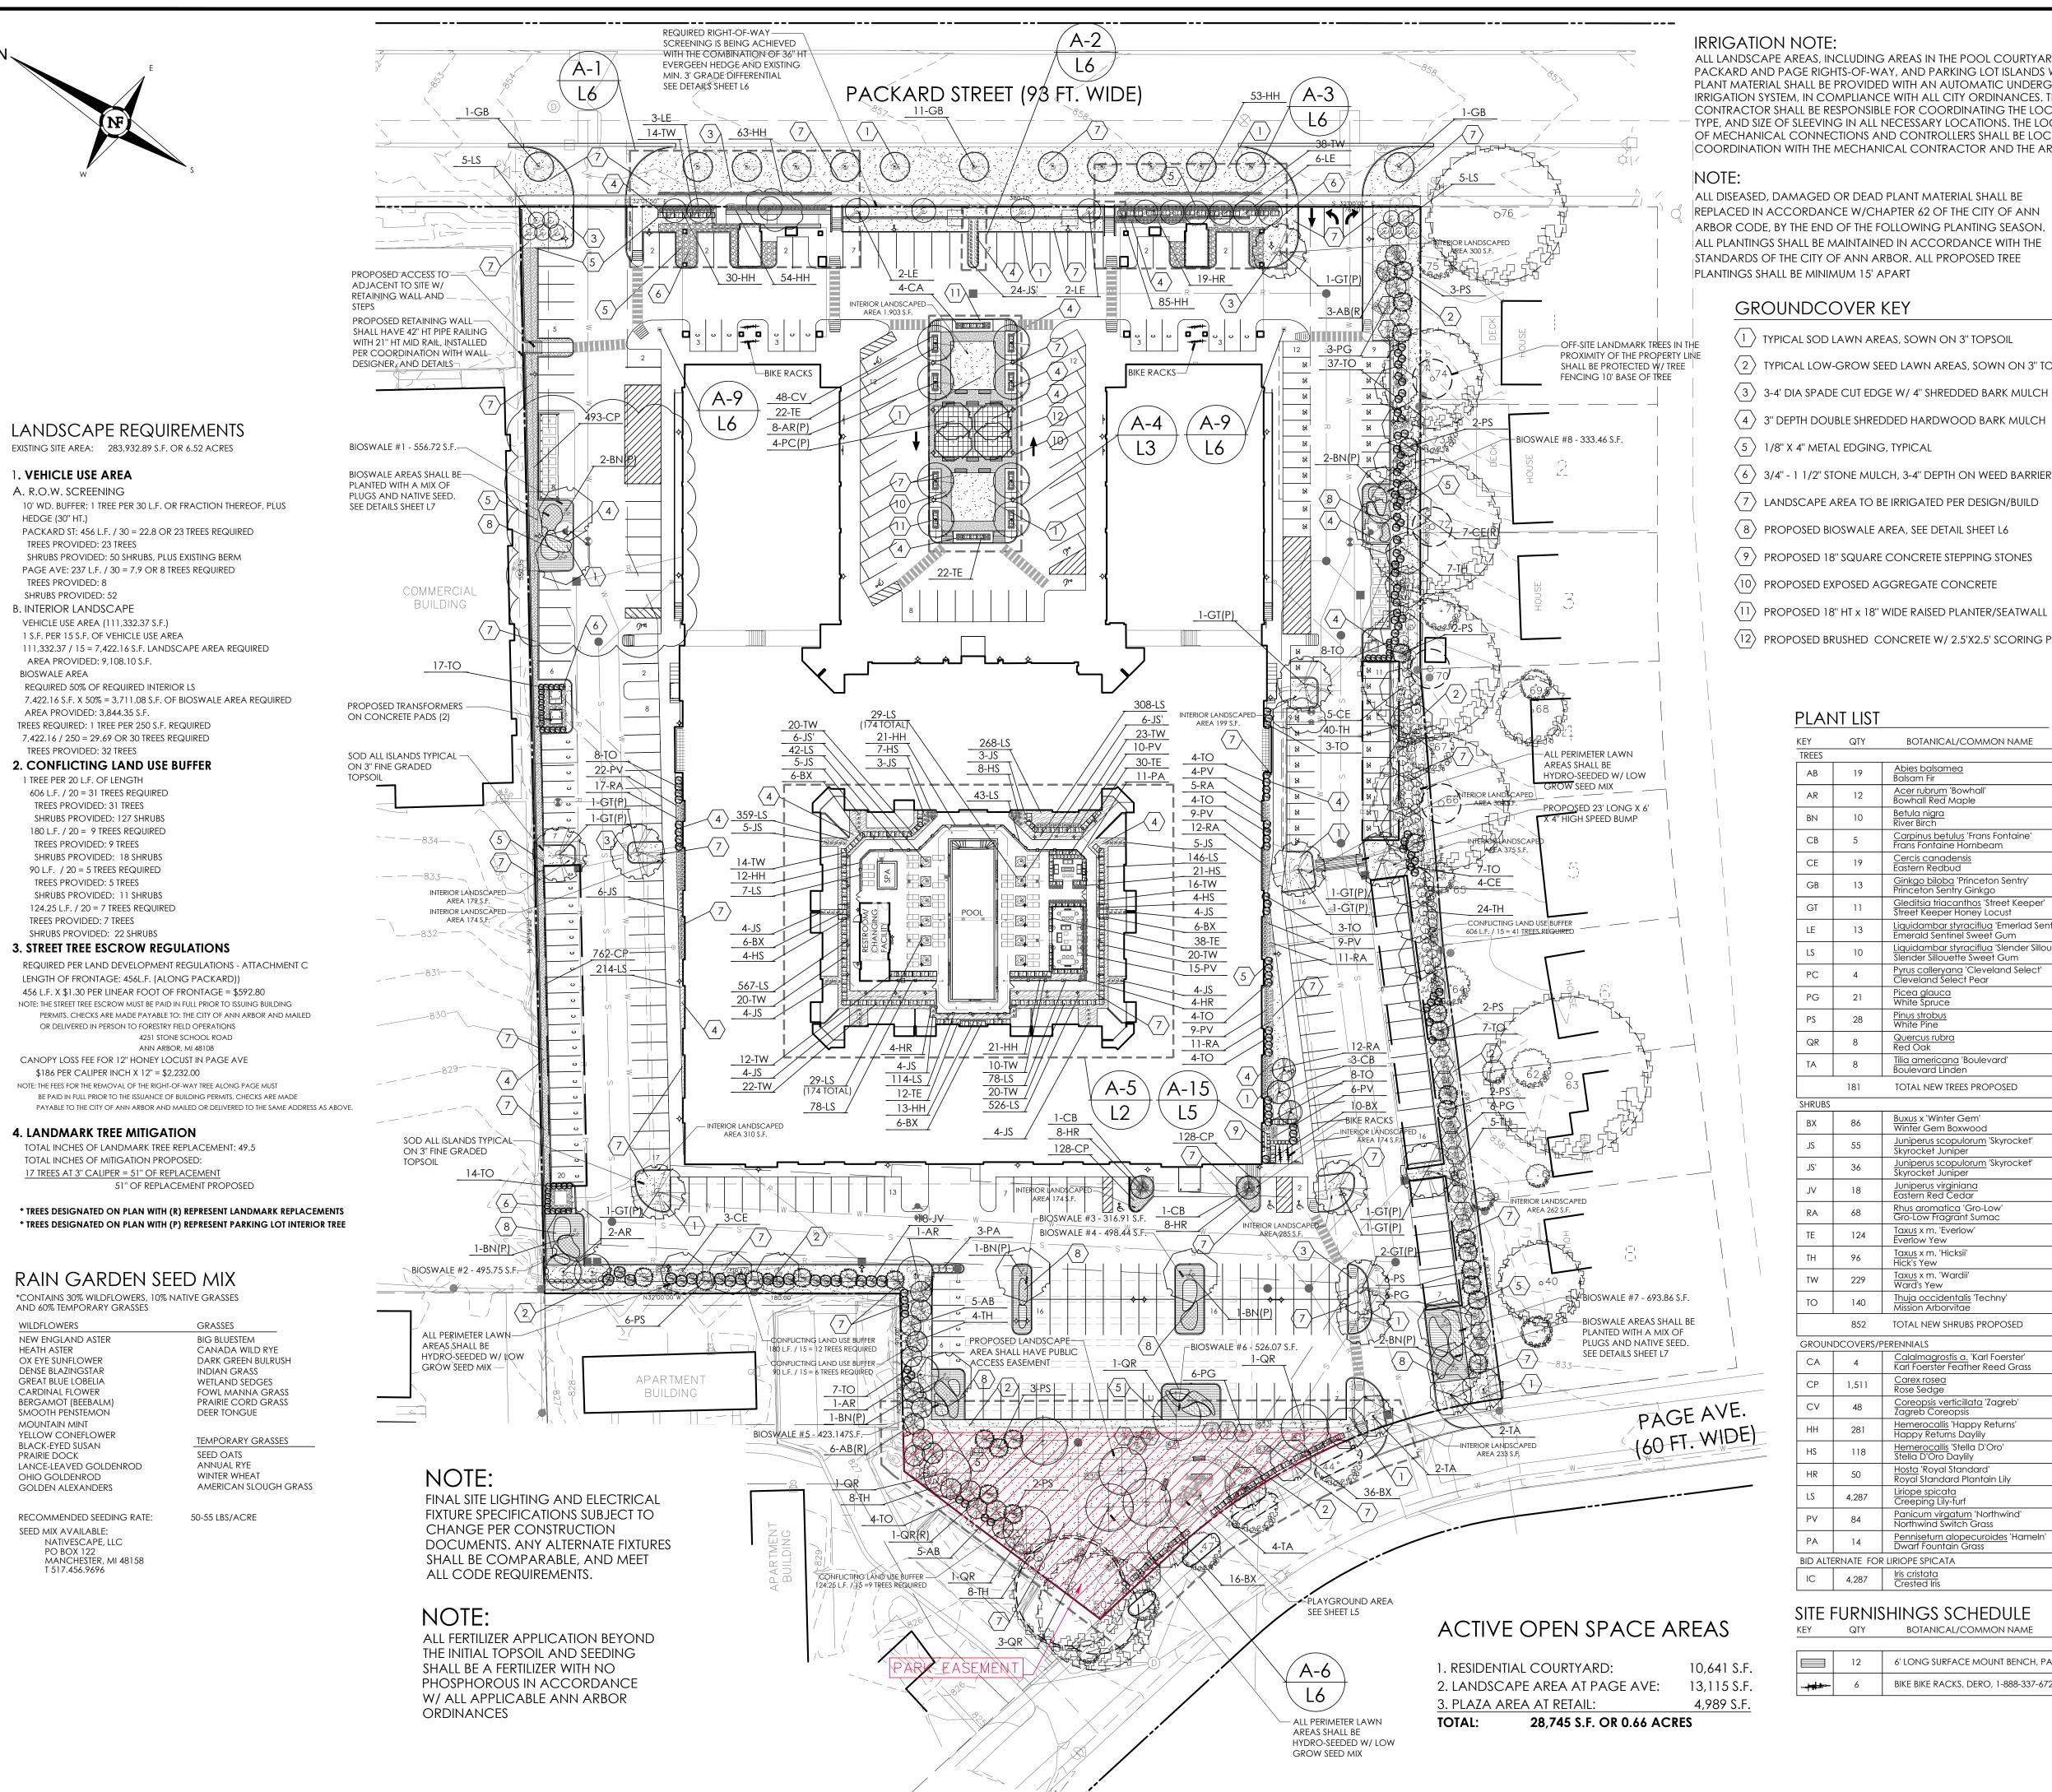
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THE GEORGE
SITE PHOTOMETRIC PLAN
PREPARED FOR: NOWAK & FRAU
GASSER BUSH ASSOCIATES
WWW.GASSERBUSH.COM

Designer
DS/DB
Date
04/26/2022
Scale
Not to Scale
Drawing No.
#22-74987 V2

1 of 1



IRRIGATION NOTE:

ALL LANDSCAPE AREAS, INCLUDING AREAS IN THE POOL COURTYARD, THE PACKARD AND PAGE RIGHTS-OF-WAY, AND PARKING LOT ISLANDS WITH PLANT MATERIAL SHALL BE PROVIDED WITH AN AUTOMATIC UNDERGROUND IRRIGATION SYSTEM, IN COMPLIANCE WITH ALL CITY ORDINANCES. THE CONTRACTOR SHALL BE RESPONSIBLE FOR COORDINATING THE LOCATION, TYPE, AND SIZE OF SLEEVING IN ALL NECESSARY LOCATIONS. THE LOCATION OF MECHANICAL CONNECTIONS AND CONTROLLERS SHALL BE LOCATED IN COORDINATION WITH THE MECHANICAL CONTRACTOR AND THE ARCHITECT.

ALL DISEASED, DAMAGED OR DEAD PLANT MATERIAL SHALL BE REPLACED IN ACCORDANCE W/CHAPTER 62 OF THE CITY OF ANN ARBOR CODE, BY THE END OF THE FOLLOWING PLANTING SEASON. ALL PLANTINGS SHALL BE MAINTAINED IN ACCORDANCE WITH THE STANDARDS OF THE CITY OF ANN ARBOR. ALL PROPOSED TREE PLANTINGS SHALL BE MINIMUM 15' APART

GROUNDCOVER KEY

- $\langle 1 \rangle$ TYPICAL SOD LAWN AREAS, SOWN ON 3" TOPSOIL
- $\langle 2 \rangle$ typical low-grow seed lawn areas, sown on 3" topsoil
- \langle 3 \rangle 3-4' DIA SPADE CUT EDGE W/ 4" SHREDDED BARK MULCH
- 4 3" DEPTH DOUBLE SHREDDED HARDWOOD BARK MULCH
- $\langle 5 \rangle$ 1/8" X 4" METAL EDGING, TYPICAL
- $\langle 6 \rangle$ 3/4" 1 1/2" STONE MULCH, 3-4" DEPTH ON WEED BARRIER
- $\langle 7 \rangle$ LANDSCAPE AREA TO BE IRRIGATED PER DESIGN/BUILD
- (8) PROPOSED BIOSWALE AREA, SEE DETAIL SHEET L6

- (12) PROPOSED BRUSHED CONCRETE W/ 2.5'X2.5' SCORING PATTERN

BOTANICAL/COMMON NAME

<u>Carpinus betulus</u> 'Frans Fontaine' Frans Fontaine Hornbeam

<u>Ginkgo biloba</u> 'Princeton Sentry' <u>Princeton Sentry Ginkgo</u>

Gleditsia triacanthos 'Street Keeper Street Keeper Honey Locust

<u>Liquidambar styraciflua</u> 'Emerlad Sentinel' Emerald Sentinel Sweet Gum

<u>Liquidambar styraciflua</u> 'Slender Sillouette' Slender Sillouette Sweet Gum

Acer rubrum 'Bowhall' Bowhall Red Maple

Pinus strobus White Pine

Quercus rubra Red Oak

Tilia americana 'Boulevard' Boulevard Linden

TOTAL NEW TREES PROPOSED

<u>Juniperus scopulorum</u> 'Skyrocket

<u>Juniperus scopulorum</u> 'Skyrocket' Skyrocket Juniper

 $\underline{\underline{\mathsf{Taxus}}}\, x\, \mathsf{m.}\, \mathsf{'Everlow'}$ $\underline{\mathsf{Everlow}}\, \mathsf{Yew}$

Taxus x m. 'Wardii' Ward's Yew

852 TOTAL NEW SHRUBS PROPOSED

Carex rosea Rose Sedge

Thuja occidentalis 'Techny'
Mission Arborvitae

Calalmagrostis a. 'Karl Foerster' Karl Foerster Feather Reed Grass

Coreopsis verticillata 'Zagreb' Zagreb Coreopsis

Hemerocallis 'Happy Returns Happy Returns Daylily

Hemerocallis 'Stella D'Oro'
Stella D'Oro Davlily

<u>Hosta</u> 'Royal Standard' Royal Standard Plantain Lily

<u>Panicum virgatum</u> 'Northwind' Northwind Switch Grass

Pennisetum alopecuroides 'Hameln'
Dwarf Fountain Grass

BOTANICAL/COMMON NAME

BIKE BIKE RACKS, DERO, 1-888-337-6729

124

229

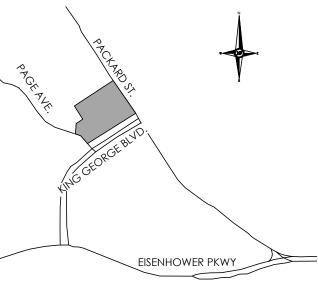
1,511

118

4,287

14

4,287



LOCATION MAP

ROOT COMMENT

FULL TO GROUND

FULL BRANCHED HEAD

FULL TO GROUND

FULL TO GROUND

MAINTAIN AS 5' HT HEDGE

MAINTAIN AS HEDGE

MAINTAIN AS HEDGE

MAINTAIN AS HEDGE

FULL HEAD

FULL HEAD

B&B FULL BRANCHED HEAD

CLUMP FORM

B&B

B&B

B&B

B&B

B&B

2.5" CAL SEE PLAN B&B FULL BRANCHED HEAD

B&B

B&B

B&B

B&B

B&B

B&B

CONT

B&B

B&B

B&B

B&B

CONT

SPACING

8' OC

SEE PLAN

3.5" CAL SEE PLAN

2.5" CAL SEE PLAN

2.5" CAL SEE PLAN

2.5" CAL | SEE PLAN

3.5" CAL | SEE PLAN

8' OC

VARIES

VARIES

30" OC

30" OC

5' OC

24" OC

2' OC

3' OC

3' OC

30" OC

SEE PLAN

15" OC

18" OC

12" OC

18" OC

24" OC

12" OC

30" OC

30" OC

#1 POT 12" OC

SEE PLAN

SIZE

7' HT

14' HT

2.5" CAL

2.5" CAL

7' HT

2.5" CAL

2.5" CAL

24-30" HT

5' HT

5' HT

3 GAL

18" HT

36" HT

30" HT

5' HT

3 GAL

PLUG

18" HT

2 GAL

2 GAL

2 GAL

#1 POT

3 GAL

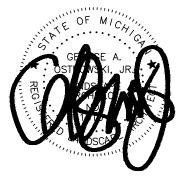
3 GAL

6' LONG SURFACE MOUNT BENCH, PARC VUE, FROM LANDSCAPE FORMS, 1800-521-2546

6-8' HT



NOWAK & FRAUS ENGINEERS 46777 WOODWARD AVE. PONTIAC, MI 48342-5032 TEL. (248) 332-7931 FAX. (248) 332-8257



PROJECT The George

CLIENT Somerset Development 101 Crawfords Corner Rd Holmdel, NJ, 07733

Contact: Ken Gold Phone: 732-415-7171

PROJECT LOCATION Part of the 1/4 of Section 4 T. 3 South, R. 6 East City of Ann Arbor, Washtenaw County, Michigan

SHEET

Existing Landscape Plan




03/11/	21 SPPC ISSUED	
05/16/	22 REVISED PER CITY/OWNER	
DRAV	VN BY:	
	vn by: Ostrowski	
G. (
G. C	Ostrowski	
G. C	Ostrowski Gned by:	

DATE: 03-11-22 SCALE:

1'' = 40'NFE JOB NO.

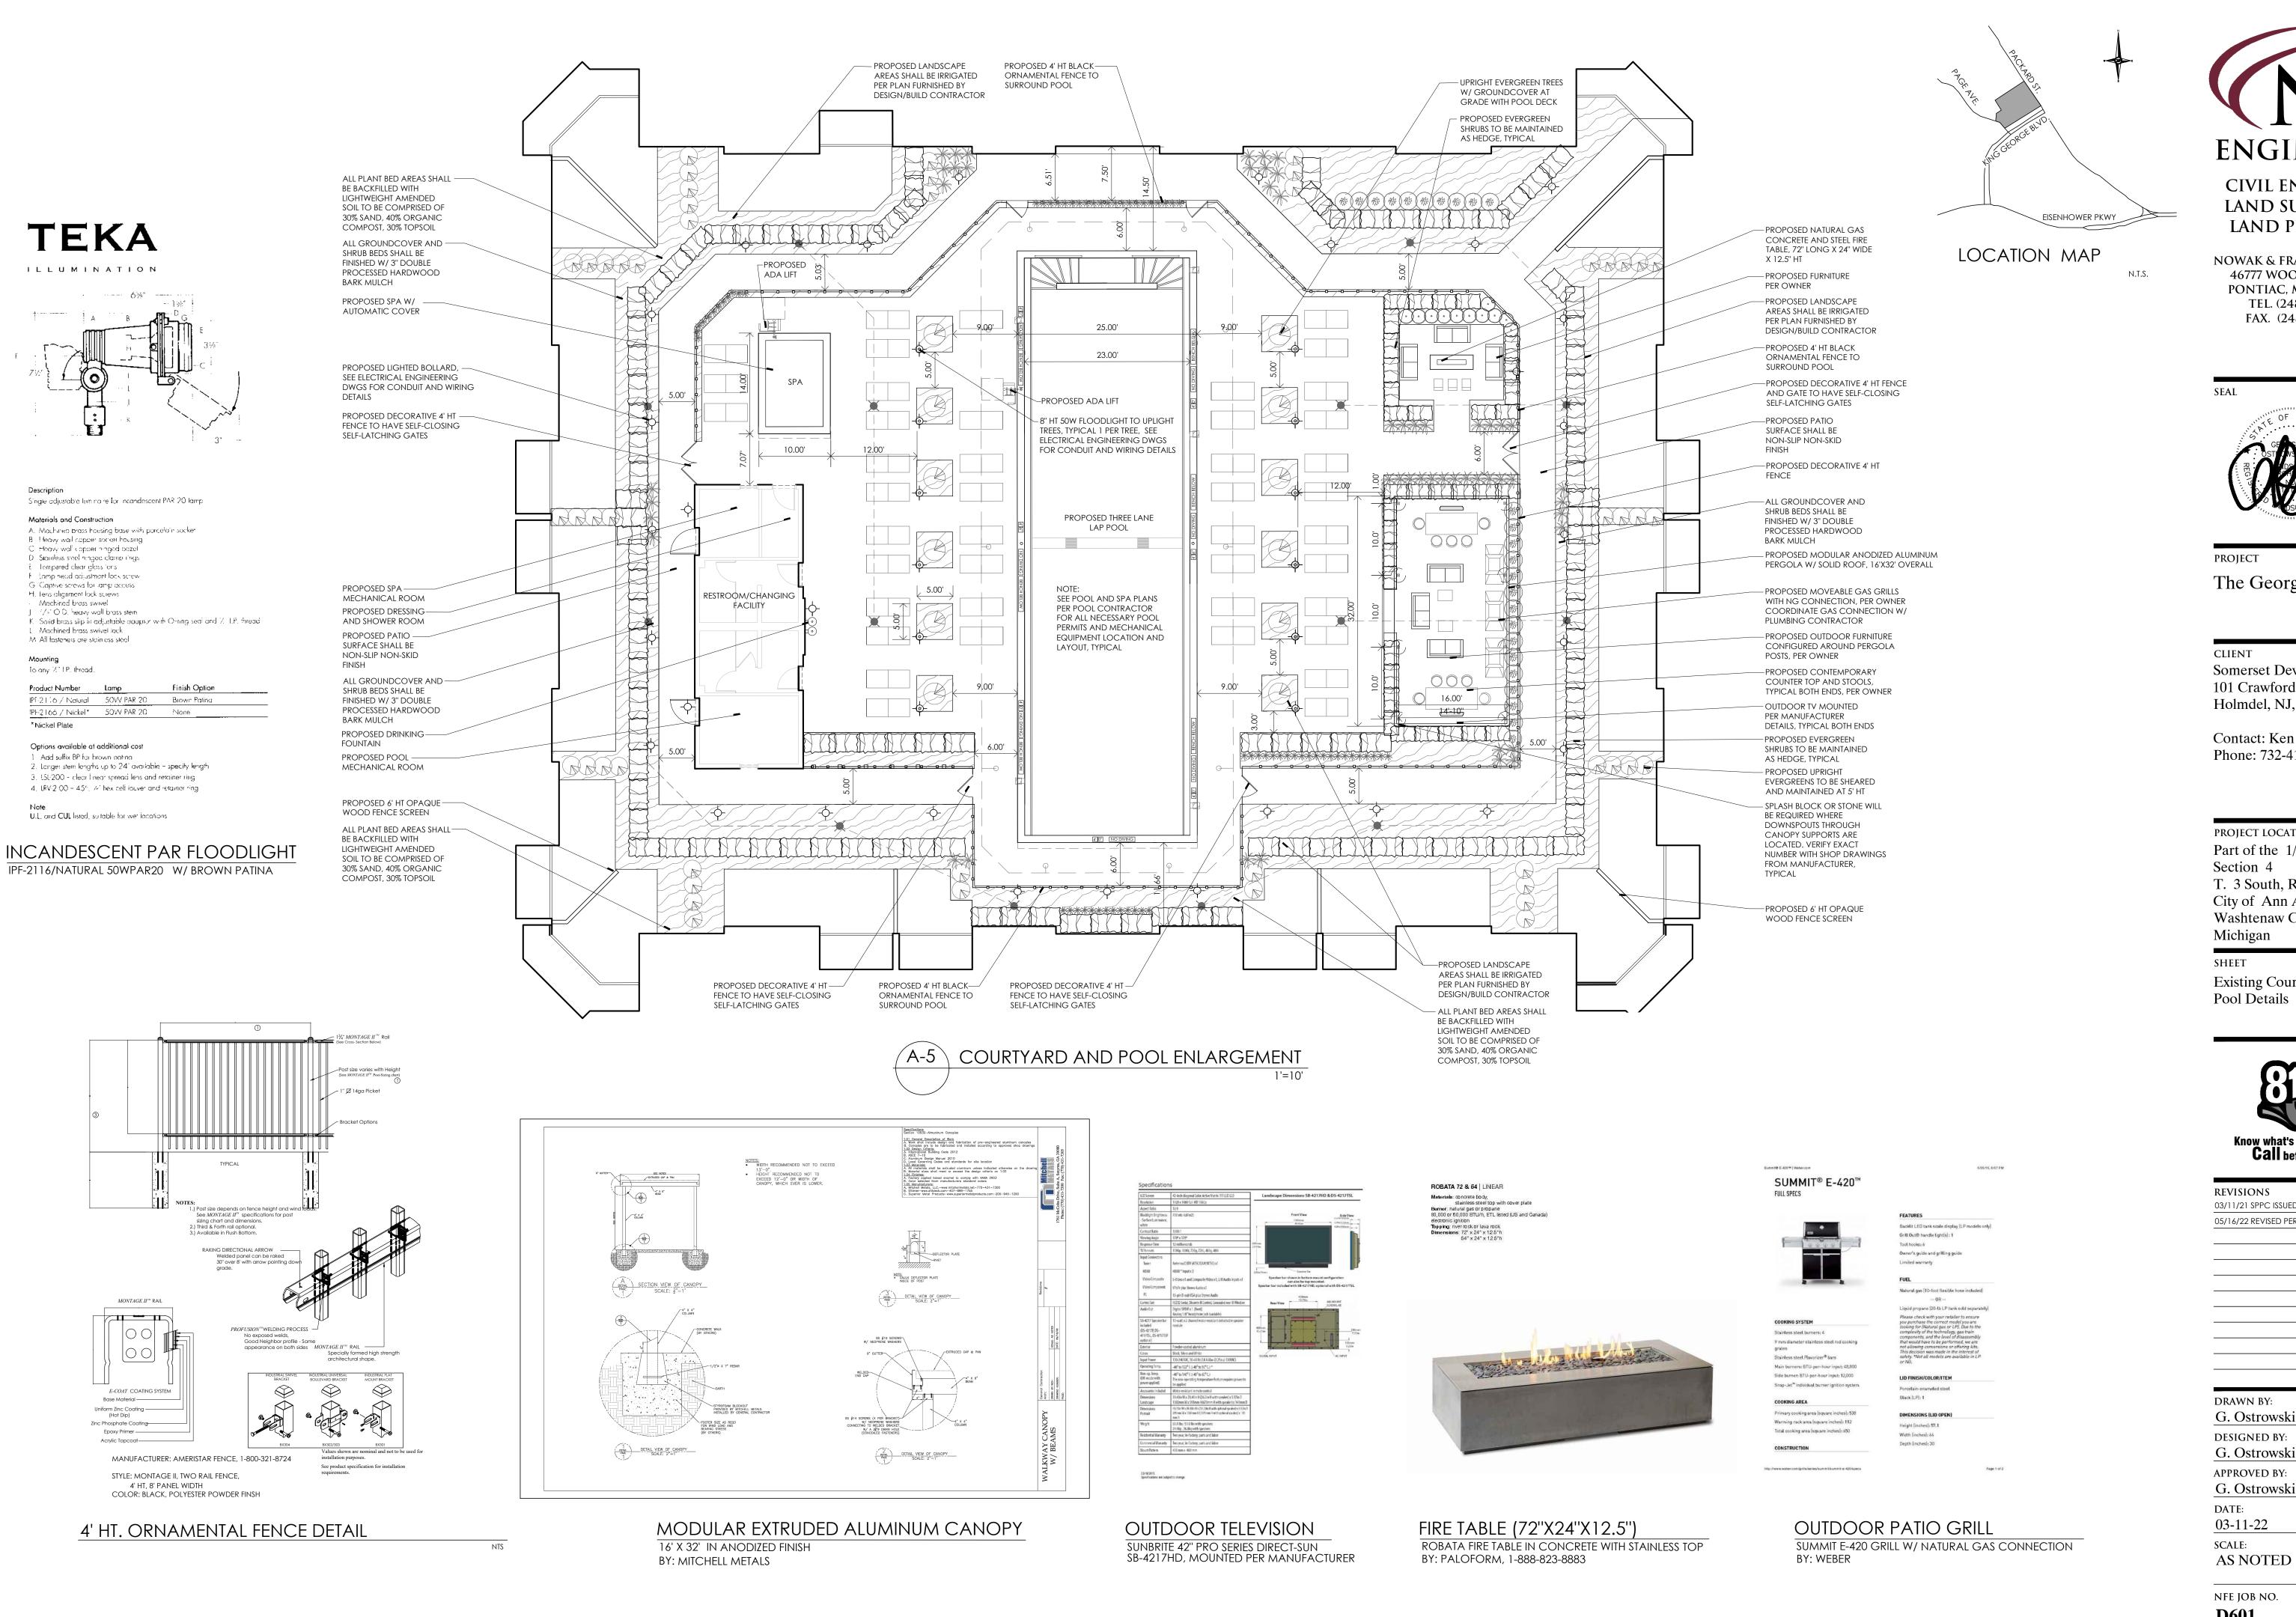SHEET NO. **D601** L1



ENGINEERS CIVIL ENGINEERS LAND SURVEYORS LAND PLANNERS

> **NOWAK & FRAUS ENGINEERS** 46777 WOODWARD AVE. PONTIAC, MI 48342-5032 TEL. (248) 332-7931 FAX. (248) 332-8257



PROJECT The George

CLIENT Somerset Development 101 Crawfords Corner Rd Holmdel, NJ, 07733

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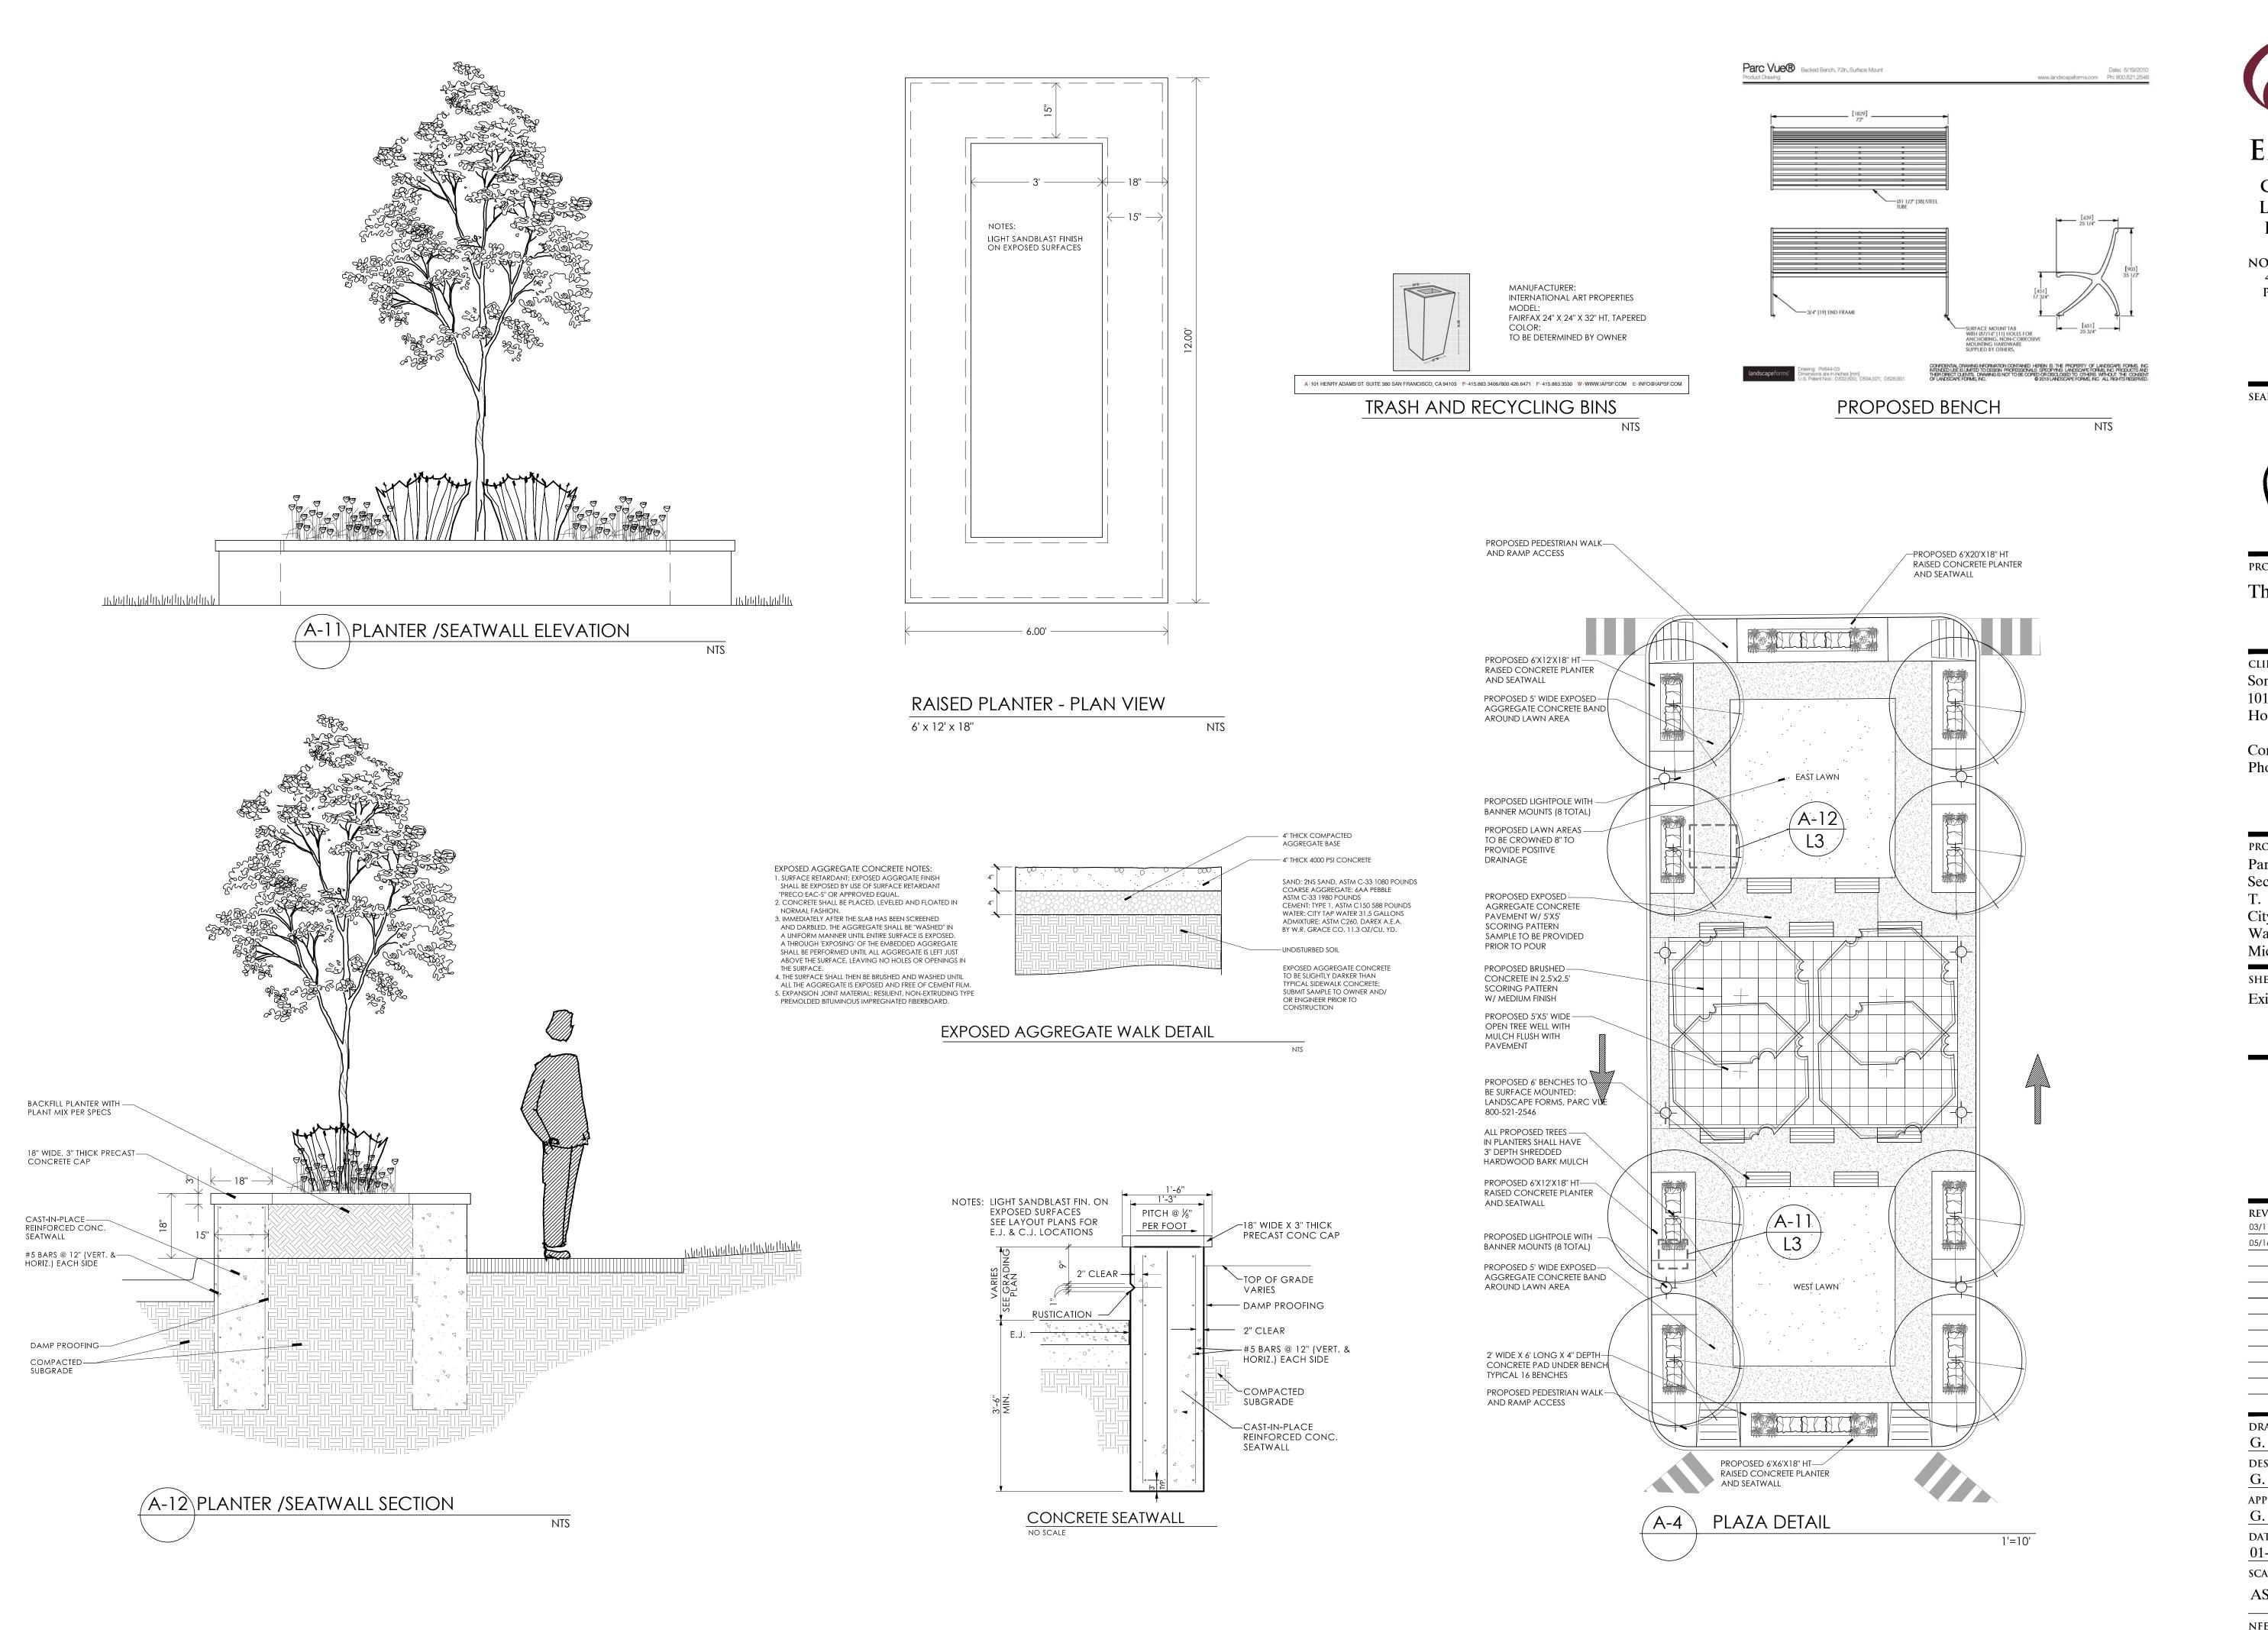
PROJECT LOCATION Part of the 1/4 of Section 4 T. 3 South, R. 6 East City of Ann Arbor, Washtenaw County, Michigan

SHEET Existing Courtyard/ Pool Details



REVISION	NS
03/11/21 SP	PC ISSUED
05/16/22 RE	VISED PER CITY/OWNER
DRAWN I	BY:
G. Ostr	owski
G. Ostr designe	owski D BY:
DRAWN I G. Ostr DESIGNE G. Ostr APPROVE	owski D BY: owski

NFE JOB NO. SHEET NO. **D601**





LAND PLANNERS **NOWAK & FRAUS ENGINEERS** 46777 WOODWARD AVE. PONTIAC, MI 48342-5032 TEL. (248) 332-7931

FAX. (248) 332-8257

SEAL



PROJECT

The George

CLIENT Somerset Development 101 Crawfords Corner Rd Holmdel, NJ, 07733

Contact: Ken Gold Phone: 732-415-7171


PROJECT LOCATION Part of the 1/4 of Section 4 T. 3 South, R. 6 East City of Ann Arbor, Washtenaw County, Michigan


SHEET

Existing Plaza and Details



03/11/21 SPPC ISSUED	5V / O V / V F D
05/16/22 REVISED PER CIT	Y/OWNER
DRAWN BY:	
G. Ostrowski	
DESIGNED BY:	
designed by: G. Ostrowski	
DESIGNED BY: G. Ostrowski APPROVED BY:	
DESIGNED BY: G. Ostrowski APPROVED BY: G. Ostrowski	
DESIGNED BY: G. Ostrowski APPROVED BY: G. Ostrowski DATE:	
DESIGNED BY: G. Ostrowski APPROVED BY: G. Ostrowski	
DESIGNED BY: G. Ostrowski APPROVED BY: G. Ostrowski DATE:	
DESIGNED BY: G. Ostrowski APPROVED BY: G. Ostrowski DATE: 01-21-11	
DESIGNED BY: G. Ostrowski APPROVED BY: G. Ostrowski DATE: 01-21-11 SCALE:	SHEET NC

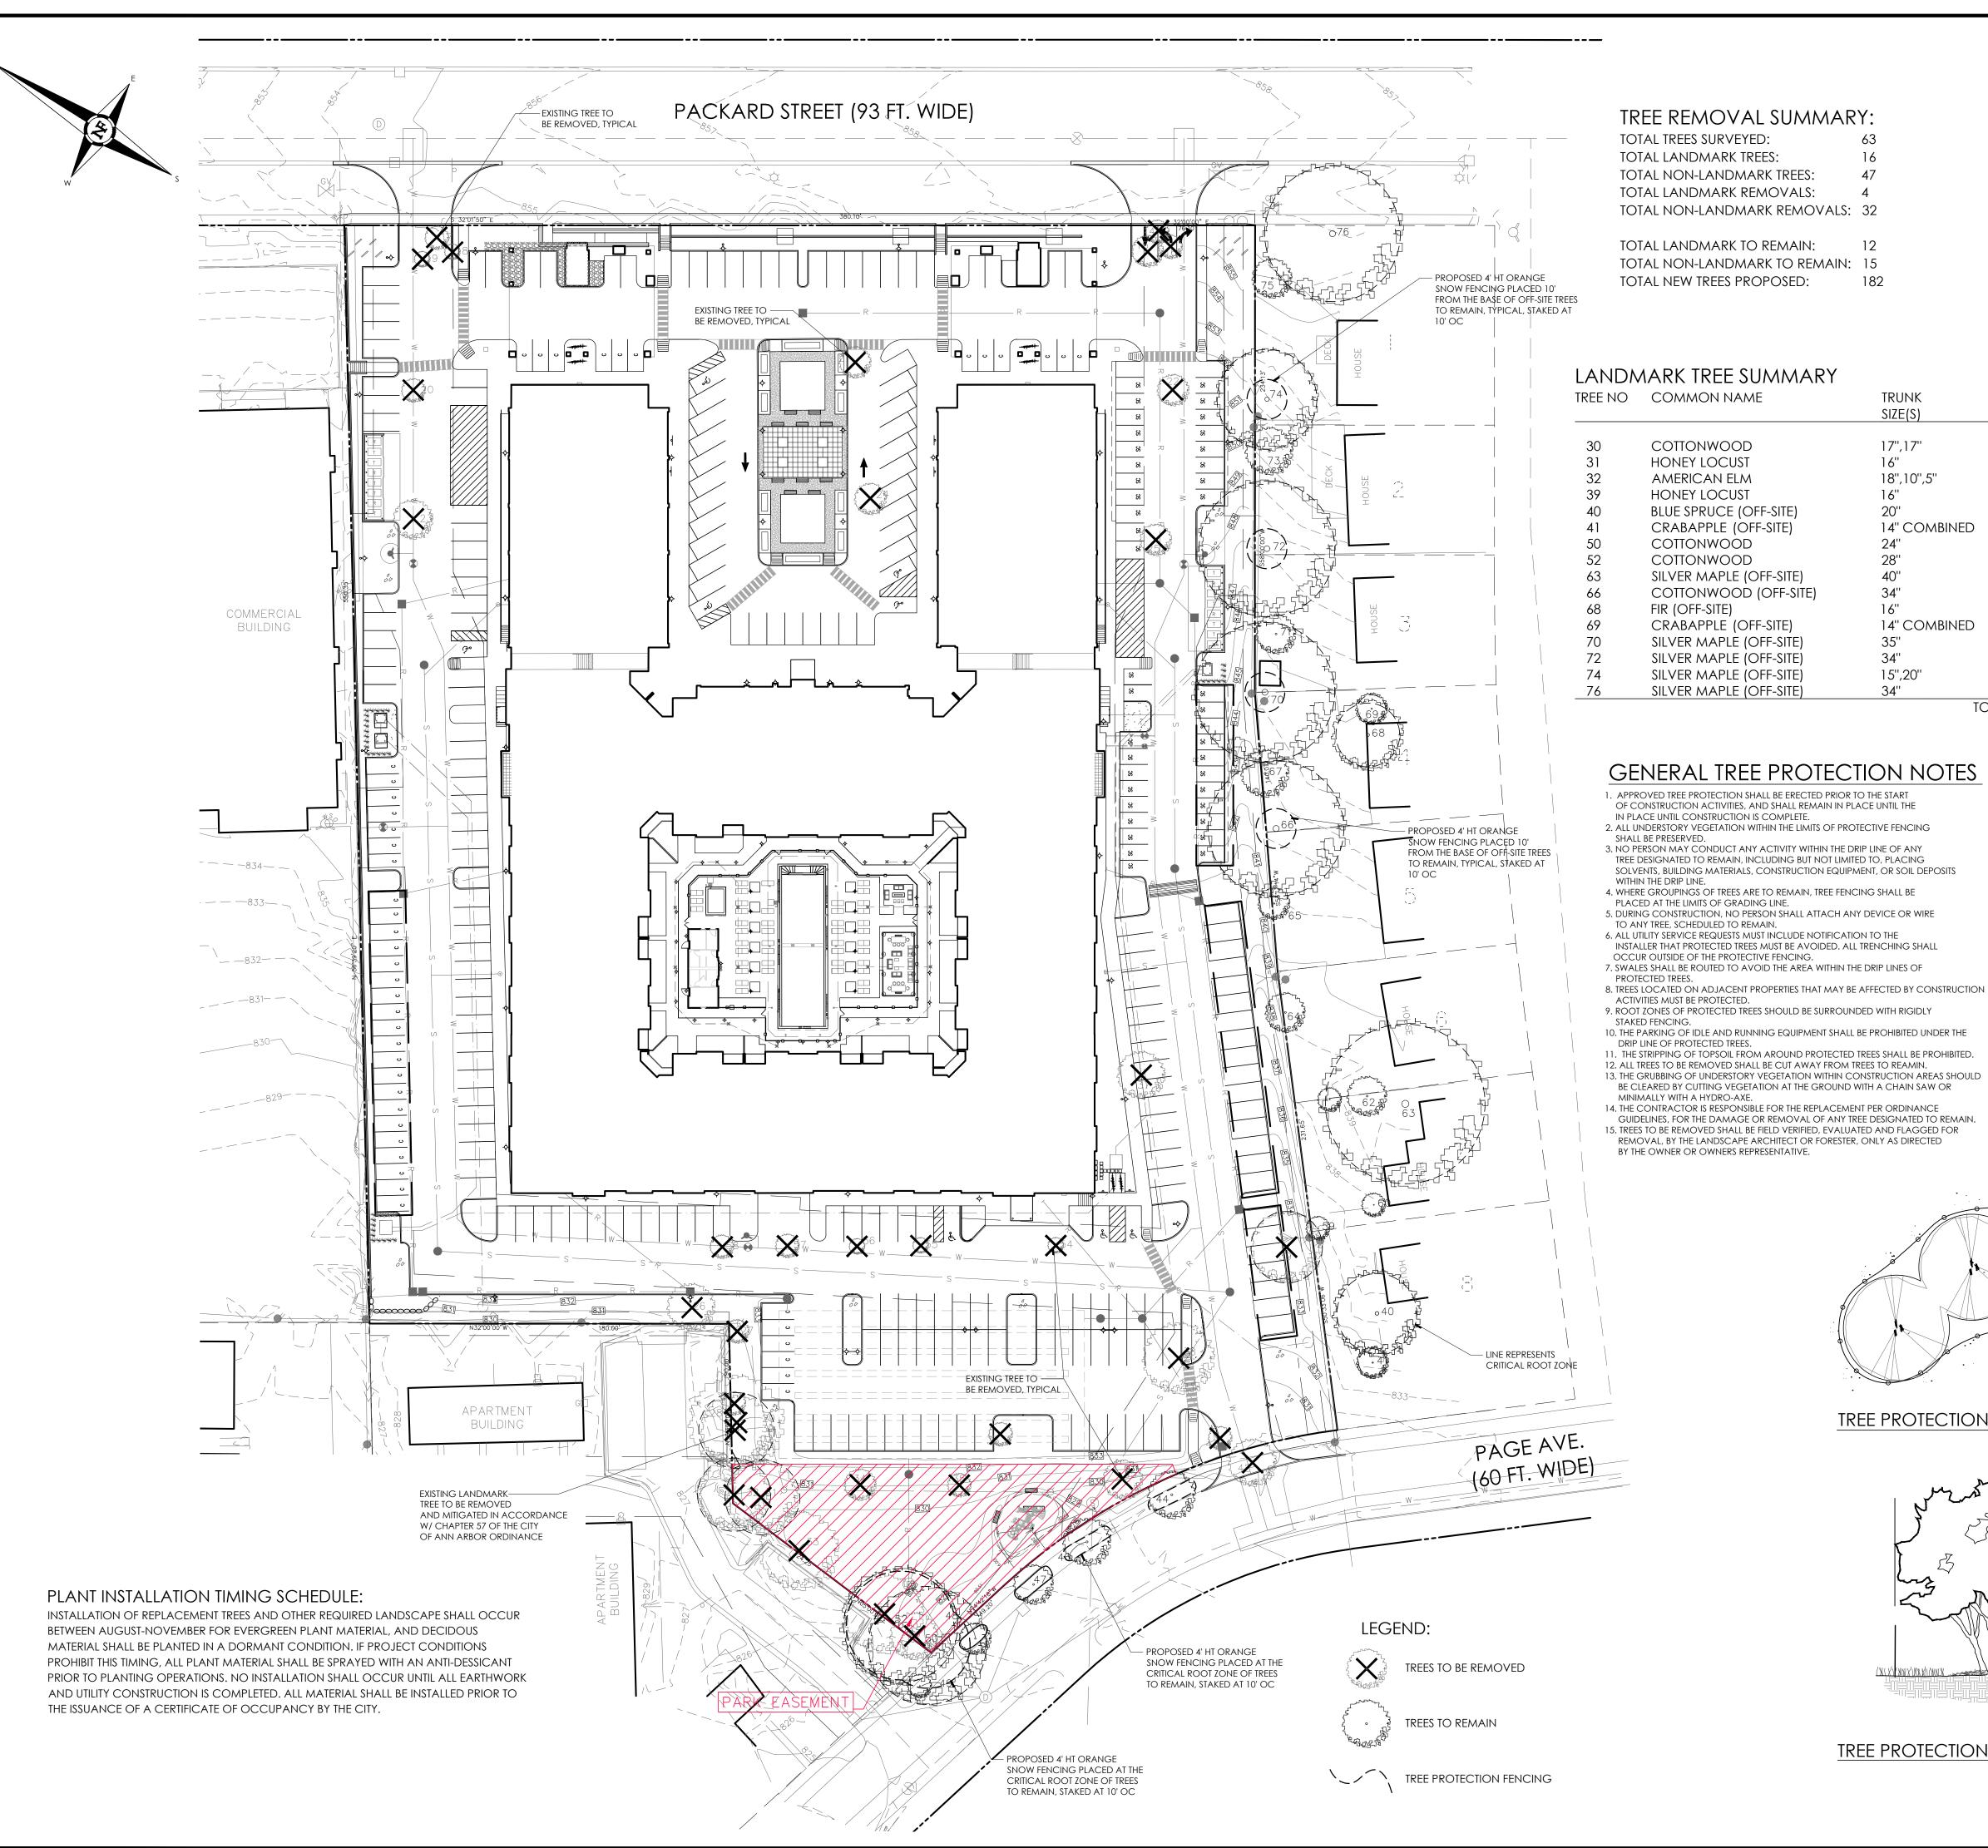

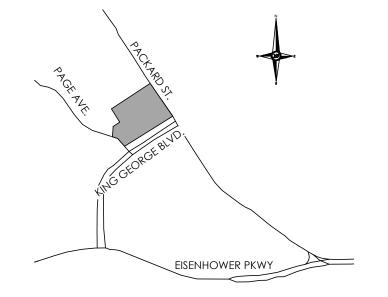

LOCATION MAP

TREE NO	COMMON NAME	trunk size(s)	REMOVE/REMAIN	MITIGATION REQUIRED (Y/N)	REPLACEMEN (50% OF DBH
30	COTTONWOOD	17",17"	REMOVE	Υ	17''
31	HONEY LOCUST	16"	REMOVE	Υ	8''
32	AMERICAN ELM	18",10",5"	REMOVE	Υ	16.5"
39	HONEY LOCUST	16"	REMOVE	Υ	8''
40	BLUE SPRUCE (OFF-SITE)	20"	REMAIN	Ν	-
41	CRABAPPLE (OFF-SITE)	14" COMBINED	REMAIN	Ν	-
50	COTTONWOOD	24"	REMAIN	Ν	-
52	COTTONWOOD	28"	REMAIN	Ν	-
63	SILVER MAPLE (OFF-SITE)	40''	REMAIN	Ν	-
66	COTTONWOOD (OFF-SITE)	34"	REMAIN	Ν	-
68	FIR (OFF-SITE)	16"	REMAIN	Ν	-
69	CRABAPPLE (OFF-SITE)	14" COMBINED	REMAIN	Ν	-
70	SILVER MAPLE (OFF-SITE)	35"	REMAIN	Ν	-
72	SILVER MAPLE (OFF-SITE)	34"	REMAIN	Ν	-
74	SILVER MAPLE (OFF-SITE)	15",20"	REMAIN	Ν	_
76	SILVER MAPLE (OFF-SITE)	34"	REMAIN	Ν	-
		T(OTAL INCHES OF LAND!	MARK TREE MITIGATION:	49.5" TOTAL

TREE PROTECTION DETAIL-PLAN

TREE PROTECTION DETAIL-SECTION

GENERAL TREE PROTECTION NOTES

- 1. APPROVED TREE PROTECTION SHALL BE ERECTED PRIOR TO THE START OF CONSTRUCTION ACTIVITIES, AND SHALL REMAIN IN PLACE UNTIL THE
- 2. ALL UNDERSTORY VEGETATION WITHIN THE LIMITS OF PROTECTIVE FENCING
- 3. NO PERSON MAY CONDUCT ANY ACTIVITY WITHIN THE DRIP LINE OF ANY TREE DESIGNATED TO REMAIN, INCLUDING BUT NOT LIMITED TO, PLACING
- SOLVENTS, BUILDING MATERIALS, CONSTRUCTION EQUIPMENT, OR SOIL DEPOSITS
- 5. DURING CONSTRUCTION, NO PERSON SHALL ATTACH ANY DEVICE OR WIRE
- 6. ALL UTILITY SERVICE REQUESTS MUST INCLUDE NOTIFICATION TO THE
- INSTALLER THAT PROTECTED TREES MUST BE AVOIDED. ALL TRENCHING SHALL
- 7. SWALES SHALL BE ROUTED TO AVOID THE AREA WITHIN THE DRIP LINES OF
- 9. ROOT ZONES OF PROTECTED TREES SHOULD BE SURROUNDED WITH RIGIDLY
- 10. THE PARKING OF IDLE AND RUNNING EQUIPMENT SHALL BE PROHIBITED UNDER THE
- 12. ALL TREES TO BE REMOVED SHALL BE CUT AWAY FROM TREES TO REAMIN.
- 13. THE GRUBBING OF UNDERSTORY VEGETATION WITHIN CONSTRUCTION AREAS SHOULD BE CLEARED BY CUTTING VEGETATION AT THE GROUND WITH A CHAIN SAW OR
- 14. THE CONTRACTOR IS RESPONSIBLE FOR THE REPLACEMENT PER ORDINANCE
- GUIDELINES, FOR THE DAMAGE OR REMOVAL OF ANY TREE DESIGNATED TO REMAIN.

 15. TREES TO BE REMOVED SHALL BE FIELD VERIFIED, EVALUATED AND FLAGGED FOR REMOVAL, BY THE LANDSCAPE ARCHITECT OR FORESTER, ONLY AS DIRECTED

MITIGATION SUMMARY:

TOTAL INCHES OF LANDMARK TREE REPLACEMENT: 49.5 TOTAL INCHES OF MITIGATION PROPOSED: 17 TREES AT 3" CALIPER = 33" OF REPLACEMENT REQUIRED

SEE SHEET L1 FOR PROPOSED REPLACEMENT

- 5/8" X 6'8" RE-ROD, OR EQUAL, SUPPORT POSTS

EVERY 10' O.C. INSTALL POSTS A MIN. 24" INTO GROUND, TYPICAL

ON PLAN, TYPICAL

-4' HIGH PROTECTIVE

FENCE, AS SPECIFIED

PLACED AT TREE DRIPLINE

4' HIGH FENCING, AS SPECIFIED, TO BE PLACED AT DRIP LINE OR

PROTECTION FENCING TO BE MAINTAINED THROUGHOUT THE CONSTRUCTION PERIOD

LIMITS OF GRADING, AS INDICATED

TREE LOCATIONS FOR LANDMARK TREES

51" OF REPLACEMENT PROPOSED Contact: Ken Gold Phone: 732-415-7171

PROJECT

CLIENT

The George

Somerset Development

Holmdel, NJ, 07733

101 Crawfords Corner Rd

PROJECT LOCATION Part of the 1/4 of Section 4 T. 3 South, R. 6 East City of Ann Arbor, Washtenaw County,

ENGINEERS

CIVIL ENGINEERS

LAND SURVEYORS

LAND PLANNERS

NOWAK & FRAUS ENGINEERS 46777 WOODWARD AVE. PONTIAC, MI 48342-5032 TEL. (248) 332-7931

FAX. (248) 332-8257

SHEET

Michigan

Existing Natural Features Mitigation Plan



REVISIONS

03/11/21 SPPC ISSUED 05/16/22 REVISED PER CITY/OWNER

DRAWN BY: G. Ostrowski **DESIGNED BY:**

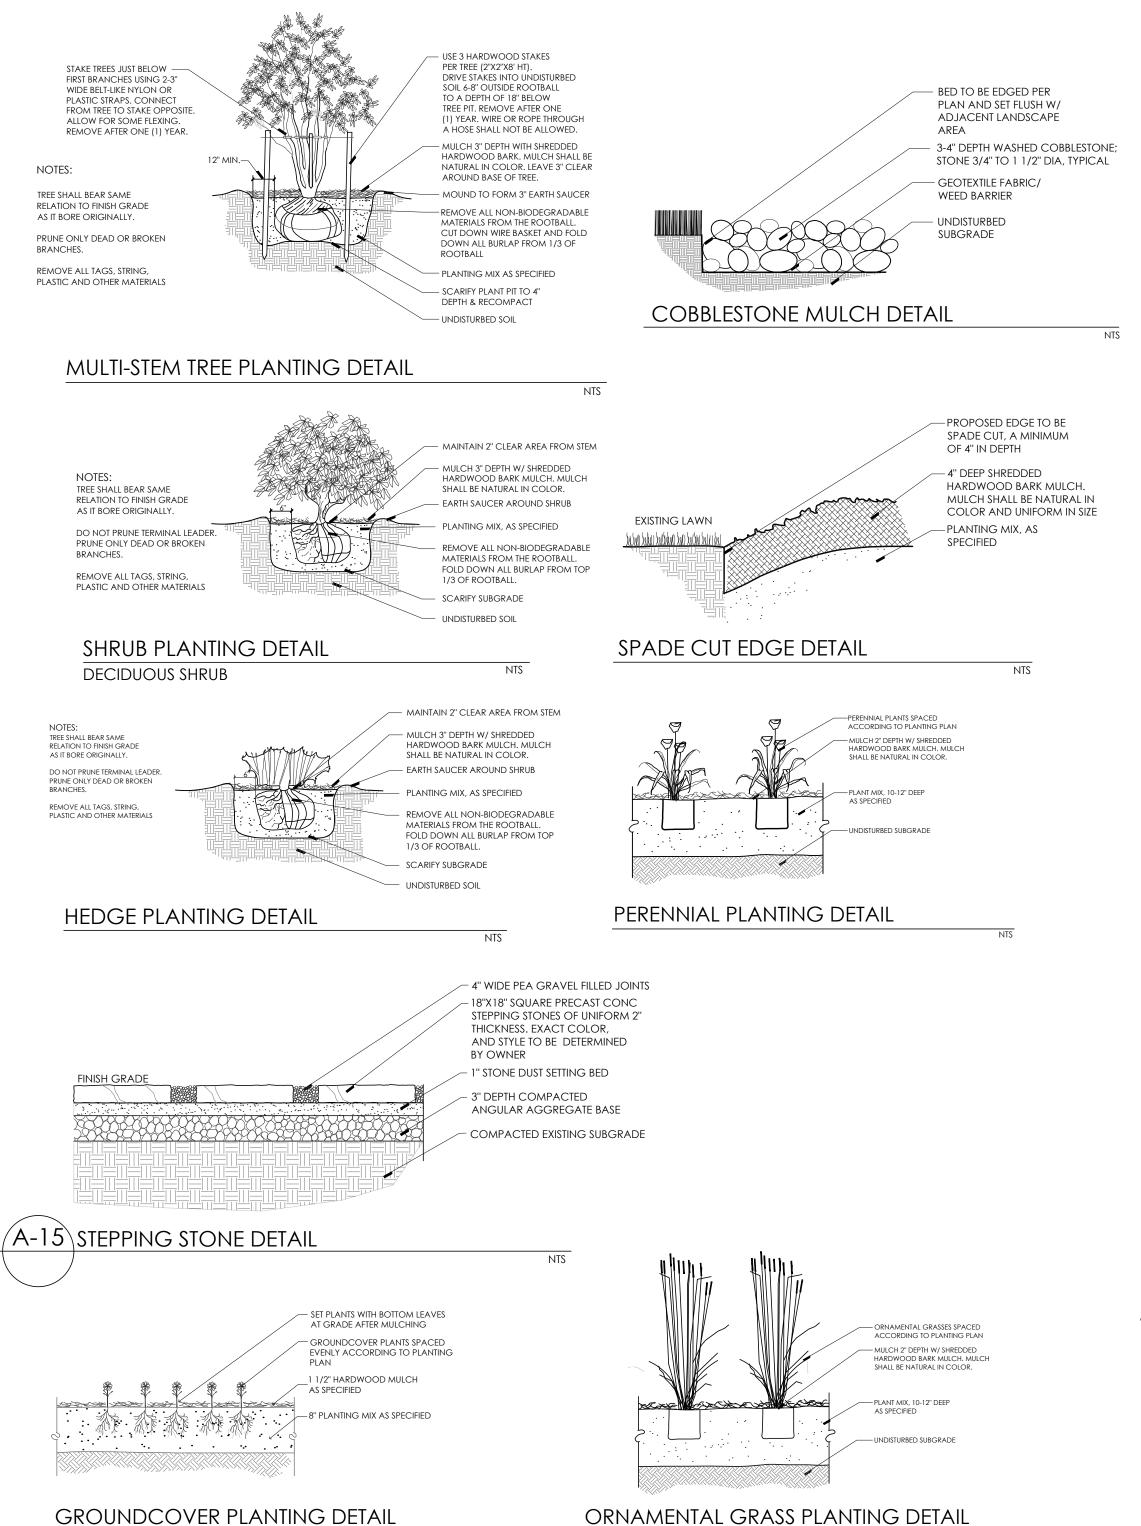
G. Ostrowski APPROVED BY:

G. Ostrowski DATE:

03-11-22 SCALE: 1'' = 40'

NFE JOB NO. **D601**

SHEET NO.



GENERAL SOD NOTE:

SOD INSTALLATION SHALL OCCUR ONLY:

GENERAL SEED NOTE:

SEEDING INSTALLATION SHALL OCCUR ONLY:

TYPICAL SEEDED LAWN MIX:

ALL LAWN AREAS DESIGNATED TO BE SEEDED, SHALL BE HYDROSEEDED WITH TYPICAL DROUGHT TOLERANT, DURABLE

> 30% NITE HAWK PERENNIAL RYE 30% KENTUCKY BLUEGRASS 20% CREEPING RED FESCUE 10% MERIT KENTUCKY BLUEGRASS

BLENDED SEED MIX, AT A RATE OF 220 LBS PER ACRE MIX IS

10% NEWPORT KENTUCKY BLUEGRASS

SPRING: APRIL1 TO JUNE1

UNTIL ESTABLISHED.

COMPRISED OF

SPRING: APRIL1 TO JUNE1

FALL: AUGUST 15 TO OCTOBER 15

FALL: AUGUST 15 TO OCTOBER 15

ALL LAWN AREAS DESIGNATED TO BE SODDED, SHALL BE SODDED WITH

ALL LAWN AREAS DESIGNATED TO BE SEEDED, SHALL BE HYDRO-SEEDED

WITH SPECIFIED BLENDS, AND STABILIZED WITH WOOD CELLULOSE FIBER MULCH (2,000 LBS PER ACRE) . IN AREAS SUBJECT TO EROSION, SEEDED LAWN SHALL

MINIMUM 3" PREPARED TOPSOIL, AND SHALL BE KEPT MOIST AND WATERED DAILY

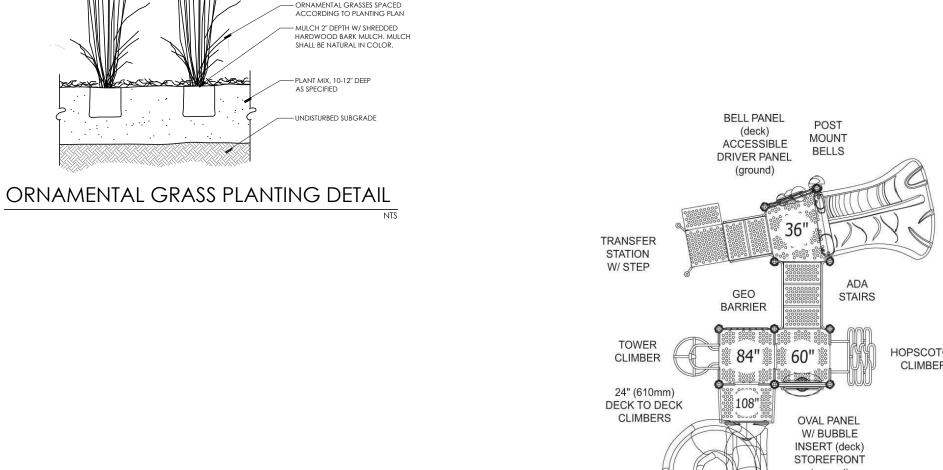
BE FURTHER STABILIZED WHERE NECESSARY WITH BIODEGRADABLE EROSION BLANKET AND STAKED UNTIL ESTABLISHED. ALL SEED SHALL BE APPLIED OVER A

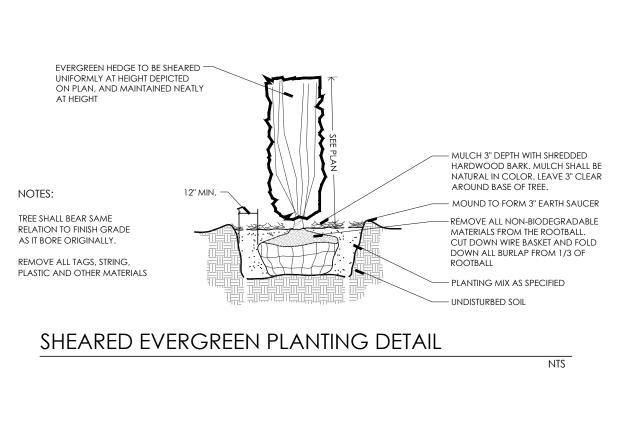
A BLENDED DURABLE BLUEGRASS SOD, TYPICALLY GROWN IN THE REGION. ALL

TURF SHALL BE PLACED ON A MINIMUM 3" PREPARED TOPSOIL, AND WATERED

DAILY UNTIL ESTABLISHMENT. IN AREAS SUBJECT TO EROSION, SODDED LAWN

SHALL BE STABILIZED WHERE NECESSARY, AND LAID PERPENDICULAR TO SLOPES









BIKE RACK DETAIL BIKE BIKE RACK, COLOR PER OWNER BY: DERO, 888-337-6729

Make A Statement



- High corrosion resistance
- No welding or threading

Galvanized Safety Railing

- Galvanized for long lasting protection
- · Recessed screws for a smooth look
- Quick installation
- Large set screws resists
- thread stripping
- Available for schedule 40 Pipe sizes 1 - 1/4" - 2"



PIPE RAILING

ABOVE GRADE COLOR: GALVANIZED STEEL

NOTE: COORDINATE INSTALLATION WITH RETAINING WALL

SAFETY ZONE LAYOUT DETAIL

GENERAL LANDSCAPE NOTES

DISCREPANCY BETWEEN PLAN AND PLANT LIST, THE PLAN SHALL GOVERN QUANTITIES. CONTACT THE LANDSCAPE ARCHITECT WITH ANY

2. THE CONTRACTOR SHALL VERIFY LOCATIONS OF ALL ON-SITE UTILITIES

3. THE CONTRACTOR SHALL COORDINATE ALL RELATED ACTIVITIES WITH

4. PLANTS SHALL BE FULL, WELL-BRANCHED, AND IN HEALTHY VIGOROUS

6. ALL TREES MUST BE STAKED, FERTILIZED AND MULCHED AND SHALL BE

5. PLANTS SHALL BE WATERED BEFORE AND AFTER PLANTING IS COMPLETE.

TO THE OWNER'S REPRESENTATIVE PRIOR TO COMMENCEMENT.

DAMAGE OR INTERRUPTION OF SERVICES SHALL BE THE RESPONSIBILITY

CONCERNS.

OF THE CONTRACTOR.

GROWING CONDITION.

YEAR FOLLOWING PLANTING.

AND A DEPTH OF 3" IN ALL LAWN AREAS.

AS INDICATED IN PLANTING DETAILS.

THE PLANS AND/OR SPECIFICATIONS.

GREATER CONDITION.

MATERIAL, AND PIECES ON INCONSISTENT SIZE.

THE PLANS AND FIELD CONDITIONS PRIOR TO INSTALLATION.

1. LANDSCAPE CONTRACTOR SHALL VISIT SITE, INSPECT EXISTING CONDITIONS AND REVIEW PROPOSED PLANTING AND RELATED WORK. IN CASE OF

PRIOR TO BEGINNING CONSTRUCTION ON HIS/HER PHASE OF WORK. ANY

OTHER TRADES, AND SHALL REPORT ANY UNACCEPTABLE SITE CONDITIONS

GUARANTEED TO EXHIBIT A NORMAL GROWTH CYCLE FOR AT LEAST ONE (1)

7. ALL MATERIAL SHALL CONFORM TO THE GUIDELINES ESTABLISHED IN THE MOST

8. CONTRACTOR WILL SUPPLY FINISHED GRADE AND EXCAVATE AS NECESSARY TO

9. PROVIDE CLEAN BACKFILL SOIL, USING NATIVE MATERIAL FROM ON-SITE WHERE

SUPPLY PLANT MIX DEPTH IN ALL PLANTING BEDS AS INDICATED IN PLANT DETAILS

POSSIBLE. SOIL SHALL BE SCREENED AND FREE OF DEBRIS, FOREIGN MATERIAL, AND

BEING BACKFILLED. APPLICATION SHALL BE AT THE MANUFACTURERS RECOMMENDED

11. PLANT MIX (PREPARED TOPSOIL) SHALL CONSIST OF 1/3 SCREENED NATIVE TOPSOIL,

1/3 SAND, AND 1/3 "DAIRY DOO" COMPOST, MIXED WELL AND SPREAD TO A DEPTH

12. ALL PLANTINGS SHALL BE MULCHED WITH SHREDDED HARDWOOD BARK, SPREAD TO A DEPTH OF 3" FOR TREES AND SHRUBS, AND 2" ON ANNUALS, PERENNIALS, AND GROUNDCOVER PLANTINGS. MULCH SHALL BE FREE FROM DEBRIS AND FOREIGN

13. NO SUBSTITUTIONS OR CHANGES OF LOCATION, OR PLANT TYPE SHALL BE MADE

14. THE LANDSCAPE ARCHITECT SHALL BE NOTIFIED OF ANY DISCREPANCIES BETWEEN

MATERIAL IN A VERTICAL CONDITION THROUGHOUT THE GUARANTEED PERIOD.

16. THE LANDSCAPE ARCHITECT OR OWNERS REPRESENTATIVE SHALL HAVE THE RIGHT

TO REJECT ANY WORK OR MATERIAL THAT DOES NOT MEET THE REQUIREMENTS OF

17. THE LANDSCAPE CONTRACTOR SHALL SEED AND MULCH OR SOD (AS INDICATED ON

LIMITS. FURTHER, THE CONTRACTOR SHALL BE RESPONSIBLE FOR RESTORING AREAS

DISTURBED DURING CONSTRUCTION, NOT IN THE CONTRACT LIMITS, TO EQUAL OR

18. ALL LANDSCAPE AREAS SHALL HAVE PROPER DRAINAGE THAT PREVENTS EXCESSIVE

WATER FROM PONDING ON LAWN AREAS OR AROUND TREES AND SHRUBS.

PLANS) ALL AREAS DESIGNATED AS SUCH ON THE PLANS, THROUGHOUT THE CONTRACT

15. THE LANDSCAPE CONTRACTOR SHALL BE RESPONSIBLE FOR MAINTAINING ALL PLANT

WITHOUT THE APPROVAL OF THE LANDSCAPE ARCHITECT OR OWNERS REPRESENTATIVE.

RECENT EDITION OF THE "AMERICAN STANDARDS FOR NURSERY STOCK".

10. SLOW-RELEASE FERTILIZER SHALL BE ADDED TO THE PLANT PITS BEFORE

Part of the 1/4 of Section 4 PRODUCT: 1-1/4" DIAMETER GALVANIZED PIPE AT 21" AND 42" T. 3 South, R. 6 East City of Ann Arbor, Washtenaw County, DESIGN. PIPE RAILING TO USED USED ON ALL WALLS WHERE WALL HEIGHT EXCEEDS 30" HIGH Michigan

> EXISTING SAMITARY— MANHOLE AS REFERENCE

SAFETY ZONE

TO LAYOUT CENTER OF

Know what's **below**

General Landscape

Notes and Details

ENGINEERS

CIVIL ENGINEERS

LAND SURVEYORS

LAND PLANNERS

NOWAK & FRAUS ENGINEERS

46777 WOODWARD AVE.

PONTIAC, MI 48342-5032

TEL. (248) 332-7931

FAX. (248) 332-8257

SEAL

PROJECT

CLIENT

The George

Somerset Development

Holmdel, NJ, 07733

Contact: Ken Gold

PROIECT LOCATION

SHEET

Phone: 732-415-7171

101 Crawfords Corner Rd

Call before you dig.

REVISIONS 03/11/21 SPPC ISSUED 05/16/22 REVISED PER CITY/OWNER

DRAWN BY: G. Ostrowski **DESIGNED BY:**

G. Ostrowski APPROVED BY:

G. Ostrowski DATE: 03-11-22

VARIES

SCALE:

NFE JOB NO. SHEET NO. **D601**

L5

IN THE EVENT THE PLAY-EQUIPMENT VARIES IN LOCATION, MAINTAIN A MINIMUM OF 8' CLEAR FROM ALL EQUIPMENT TO ESTABLISH EDGE OF SAFETY ZONE GRADE AREA TO PROVIDE FLAT -PLACEMENT. MAINTAIN 1/1,5% POSITIVE SLOPE TOWARD PAGE PLAYGROUND AREA HOP, SKIP AND SLIDE, BY PLAYWORLD SYSTEMS HOPSCOTCH -RECOMMENDED SAFETY ZONE AROUND STRUCTURE MINIMUM 12" SHREDDED HARDWOOD BARK MULCH OR PER MANUFACTURERS RECOMMENDATION





The Bike Bike Rack is an eye-catching, functional piece of street art. It

DERO

SOUTHWEST LOCATION

EASTSIDE UNDER BLDG (CENTERED ON COLUMNS)

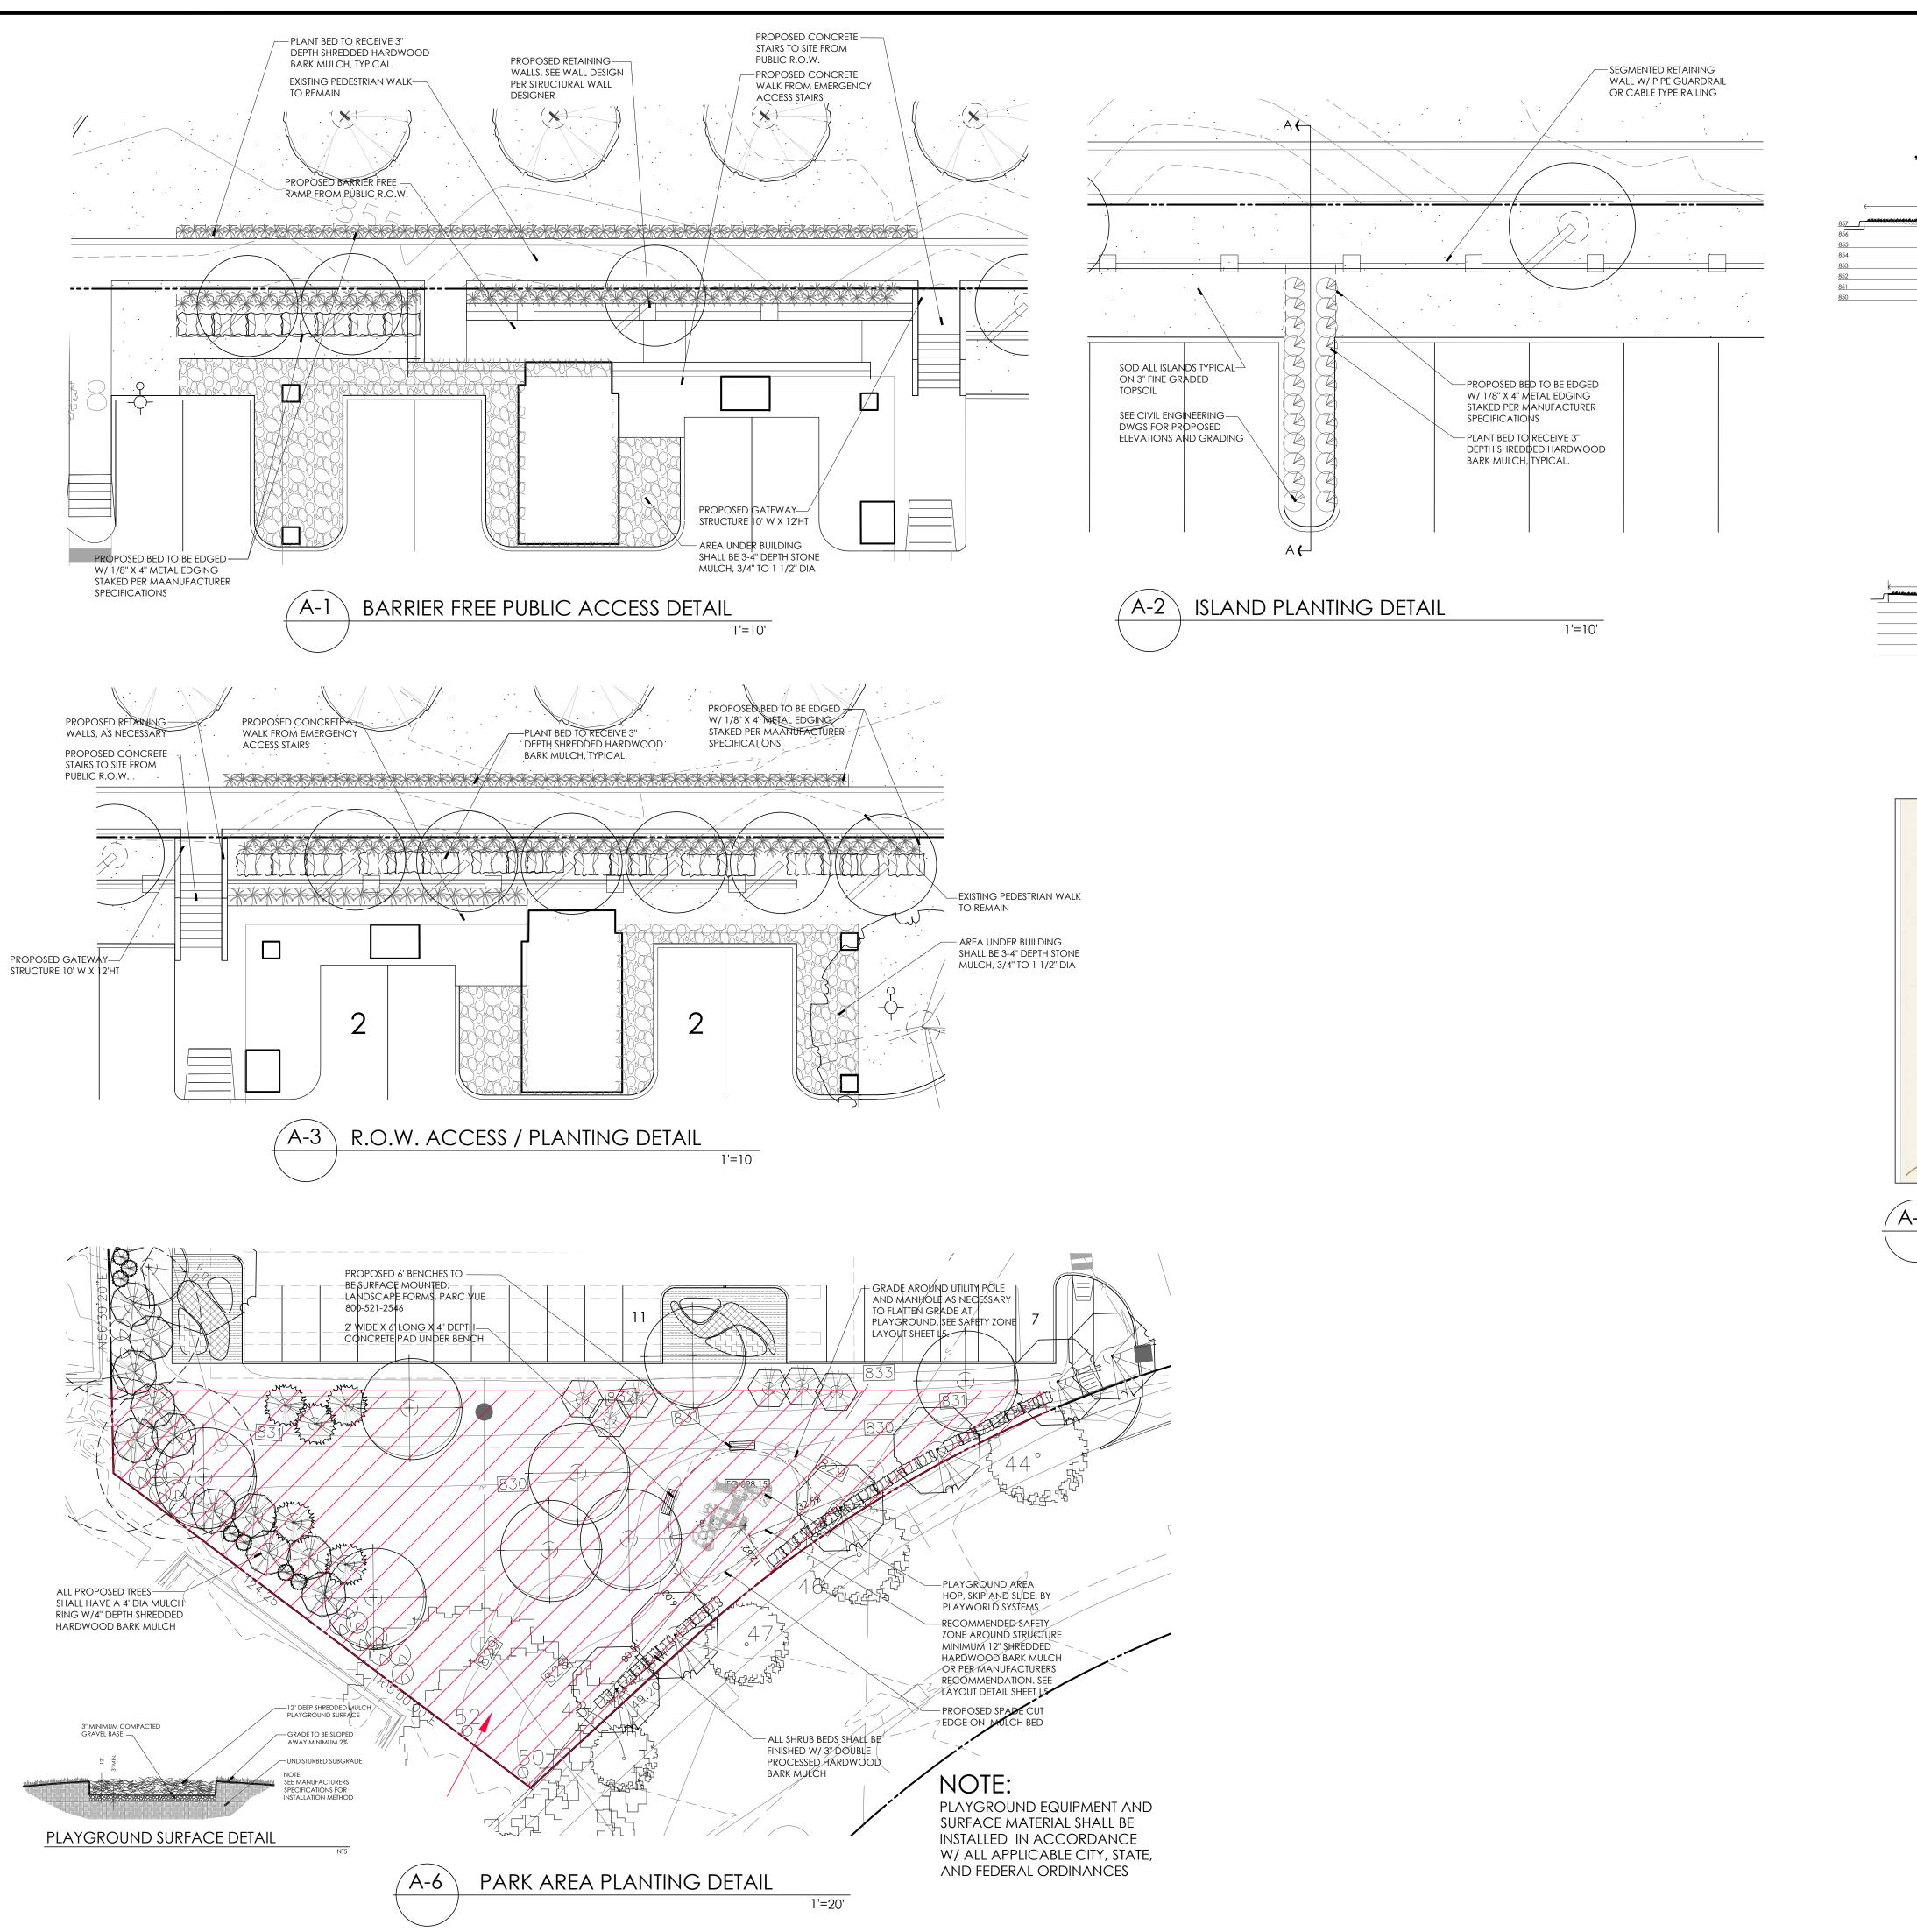
EXTERIOR BIKE RACK LAYOUT

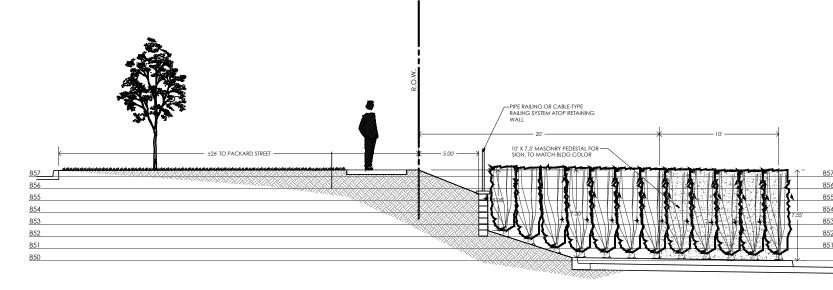
SLITHER SLIDE

PLAYGROUND DETAIL PRODUCT NO. 350-1520,

AVAII ABI F: PLAYWORLD MIDSTATES 1-800-367-4440

HOP, SKIP & SLIDE





ISLAND/WALL SECTION A-A

PROPOSED WALL HEIGHT VARIES, SEE CIVIL DRAWING FOR DETAILS

856
858
858
858

1" = 8'

1" = 8'

PACKARD ROAD TYPICAL SECTION

12.00 in

Aluminum
Parking

10.00 in

1.00 in

1.00 in

RESIDENT
PARKING

10.00 in


1.00 in

A-9 DIRECTIONAL ON-SITE WAYFINDING



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LAND PLANNERS

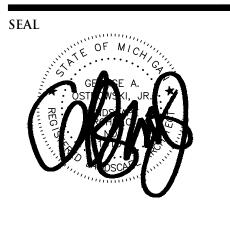

PROJECT
The George

Schement Somerset Development 101 Crawfords Corner Rd Holmdel, NJ, 07733

Contact: Ken Gold Phone: 732-415-7171

PROJECT LOCATION
Part of the 1/4 of
Section 4
T. 3 South, R. 6 East
City of Ann Arbor,
Washtenaw County,
Michigan

SHEET
Park and Frontage
Details




REVISIONS	
03/11/21 SPPC ISSUE	
05/16/22 REVISED PE	R CITY/OWNER
DRAWN BY:	
DRAWN BY: G. Ostrowsk	i
	i
G. Ostrowsk	-
G. Ostrowski designed by:	-
G. Ostrowsk DESIGNED BY: G. Ostrowsk	i
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NFE JOB NO.

D601

SHEET NO.

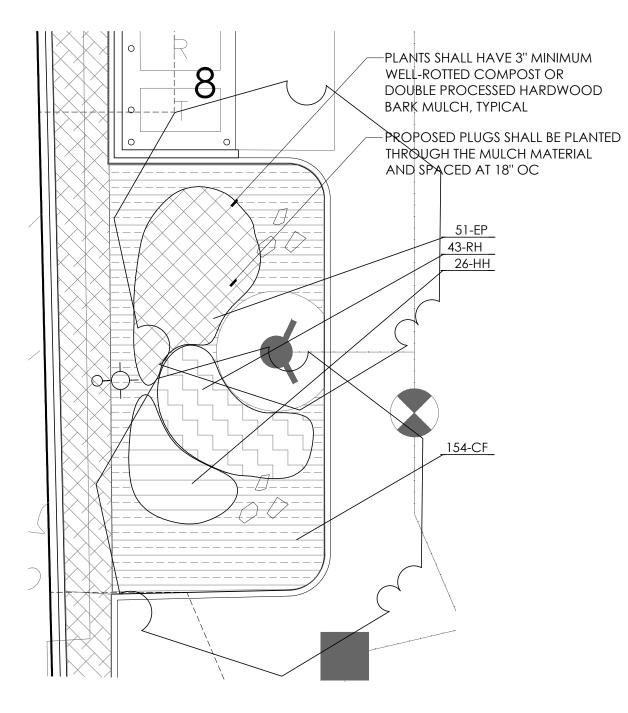L6



BIOSWALE AREA #1 - 556.72 S.F. SCALE 1" = 8'

PLANTS SHALL HAVE 3" MINIMUM

DOUBLE PROCESSED HARDWOOD

PROPOSED PLUGS SHALL BE PLANTED

THROUGH THE MULCH MATERIAL

WELL-ROTTED COMPOST OR

BARK MULCH, TYPICAL

AND SPACED AT 18" OC

114-CF

SCALE 1" = 8'

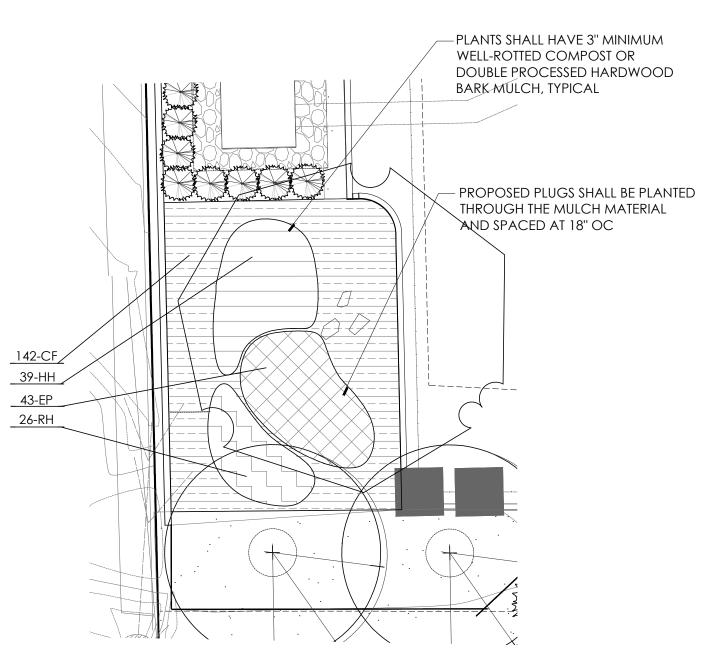
BIOSWALE AREA #5 - 423.47 S.F.

PROPOSED CURB INLET, SEE—

CIVIL DWGS FOR DETAIL

12" DEPTH BIOSWALE—

SOIL MIX




BIOSWALE AREA #2 - 495.75 S.F.


BARK MULCH, TYPICAL

AND SPACED AT 18" OC

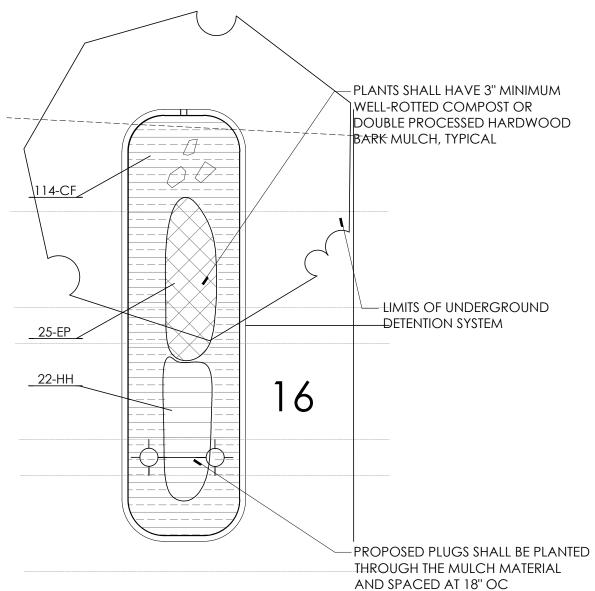SCALE 1" = 8'



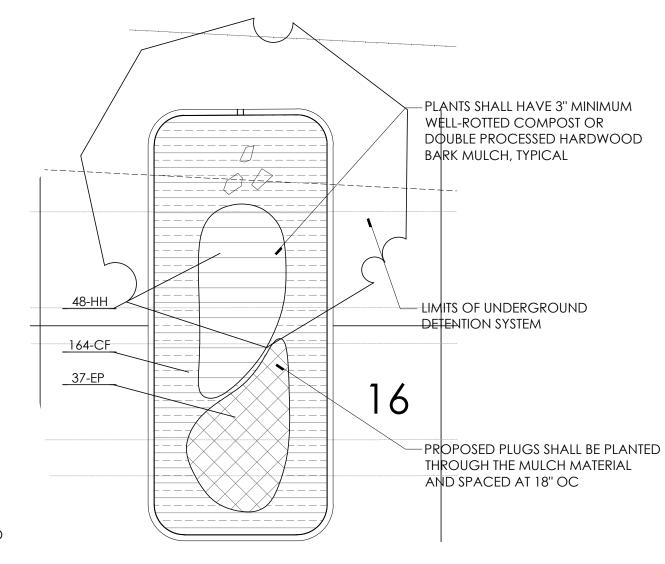BIOSWALE AREA #3 - 316.91 S.F. SCALE 1" = 8'



BIOSWALE AREA #4 - 498.44 S.F.

Maintenance

SCALE 1" = 8'

SEAL



ENGINEERS

CIVIL ENGINEERS

LAND SURVEYORS

LAND PLANNERS

NOWAK & FRAUS ENGINEERS 46777 WOODWARD AVE. PONTIAC, MI 48342-5032

TEL. (248) 332-7931

FAX. (248) 332-8257

PROJECT

The George

CLIENT Somerset Development 101 Crawfords Corner Rd Holmdel, NJ, 07733

Contact: Ken Gold Phone: 732-415-7171

PROJECT LOCATION Part of the 1/4 of Section 4 T. 3 South, R. 6 East City of Ann Arbor, Washtenaw County, Michigan

SHEET

Existing Bioswale Details



REVISIONS 03/11/21 SPPC ISSUED 05/16/22 REVISED PER CITY/OWNER

DRAWN BY: G. Ostrowski

DESIGNED BY: G. Ostrowski APPROVED BY:

G. Ostrowski DATE: 03-11-22

SCALE: **VARIES**

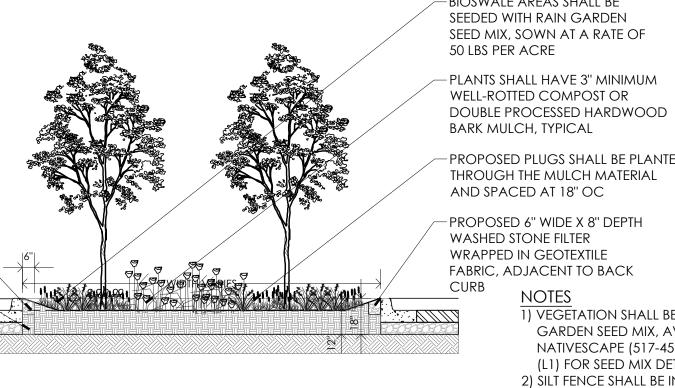
NFE JOB NO. SHEET NO. **D601 L7**

— PLANTS SHALL HAVE 3" MINIMUM WELL-ROTTED COMPOST OR DOUBLE PROCESSED HARDWOOD BARK MULCH, TYPICAL - PROPOSED PLUGS SHALL BE PLANTED - PLANTS SHALL HAVE 3" MINIMUM THROUGH THE MULCH MATERIAL AND SPACED AT 18" OC WELL-ROTTED COMPOST OR DOUBLE PROCESSED HARDWOOD PLANTS SHALL HAVE 3" MINIMUM WELL-ROTTED COMPOST OR DOUBLE PROCESSED HARDWOOD - PROPOSED PLUGS SHALL BE PLANTED BARK MULCH, TYPICAL THROUGH THE MULCH MATERIAL PROPOSED PLUGS SHALL BE PLANTED THROUGH THE MULCH MATERIAL AND SPACED AT 18" OC 76-RH _33-EP_ _178-CF_ LIMITS OF UNDERGROUND **DETENTION SYSTEM** BIOSWALE AREA #7 - 693.86 S.F.

BIOSWALE AREAS SHALL BE SEEDED WITH RAIN GARDEN SEED MIX, SOWN AT A RATE OF

SCALE 1" = 8'

BIOSWALE AREA #8 - 333.46 S.F. SCALE 1" = 8'



BIOSWALE AREA #6 - 526.07 S.F.

TYPICAL PARKING LOT BIOSWALE

PROPOSED PLUGS SHALL BE PLANTED THROUGH THE MULCH MATERIAL

FABRIC, ADJACENT TO BACK 1) VEGETATION SHALL BE A MIX OF PLUGS AND RAIN GARDEN SEED MIX, AVAILABLE FROM

NATIVESCAPE (517-456-9696). SEE LANDSCAPE PLAN

(L1) FOR SEED MIX DETAIL. 2) SILT FENCE SHALL BE INSTALLED AT THE CURB INLET, AND A BIODEGRADABLE EROSION CONTROL BLANKET SHALL BE PLACED OVER SEED AREAS IMMEDIATELY AFTER SEEDING. 3) REMOVE THE SILT FENCE AFTER THE VEGETATION IS ADEQUATELY ESTABLISHED.

4) 6" WIDE STONE FILTER SHALL BE COMPRISED OF CLEAN 3/4" TO 1-1/2" DIA STONE, WRAPPED COMPLETELY WITH FILTER FABRIC 5) SOIL IN THE BIOSWALE SHALL CONSIST OF A WELL-MIXED BLEND OF 30% COARSE MASONRY SAND, 30% ORGANIC COMPOST, AND 40% NATIVE TOPSOIL FROM AN ON-SITE, UPLAND SOURCE.

BIOSWALE PLANT LIST

KEY	QTY	BOTANICAL/COMMON NAME	SIZE	SPACING	ROOT	COMMENT		
BIOSW	BIOSWALE PLANTINGS							
EP	325	Echinaecea purpurea Purpleleaf Coneflower	#1 POT	18" OC	РОТ			
НН	282	Heliopsis helianthoides Ox-Eye Sunflower	#1 POT	18" OC	POT			
RH	228	Rudbeckia hirta Black-Eyed Susan	#1 POT	18" OC	РОТ			
PLUGS	PLUGS							
CF	1,169	Carex frankii Frank's Sedge	1 7/8"	18" OC	PLUG			

Typical Maintenance Activities for Bioswale Areas

Bioswale Operation and Maintenance Plan

Activity	Frequency
Water plants	As necessary during first
	growing season
Water plants during dry	As needed after first
periods	growing season
Re-mulch void areas	As needed
Treat diseased trees	As needed
and shrubs	
Inspect soil and repair	Monthly
eroded areas	
Remove litter and	Monthly
debris	
Add additional mulch	Once per year
	· · · · · · · · · · · · · · · · · · ·

Sufficient access shall be provided to the facility to allow all necessary inspection and maintenance activities to be completed. Maintenance of access areas shall include removal of tree seedlings and woody vegetation, repair of eroded areas and removal of litter and debris.

The soil and mulch in the facility and in areas draining to the facility shall be inspected for eroded areas. Eroded areas shall be filled with soil or mulch and vegetated.

Sediment Accumulation & Clogging

Sediment accumulation within the facility may reduce the infiltration capacity and impair proper performance of the facility. The facility shall be inspected for accumulation of sediment annually. Excessive sediment accumulation shall be removed with the area re-mulched and replanted.

The facility may have riprap at points where runoff enters or leaves the facility. The riprap is used to prevent erosion of soils from stormwater flows. The facility shall be checked to make sure that an adequate amount of riprap exists to prevent erosion and additional riprap added if necessary.

Debris & Litter

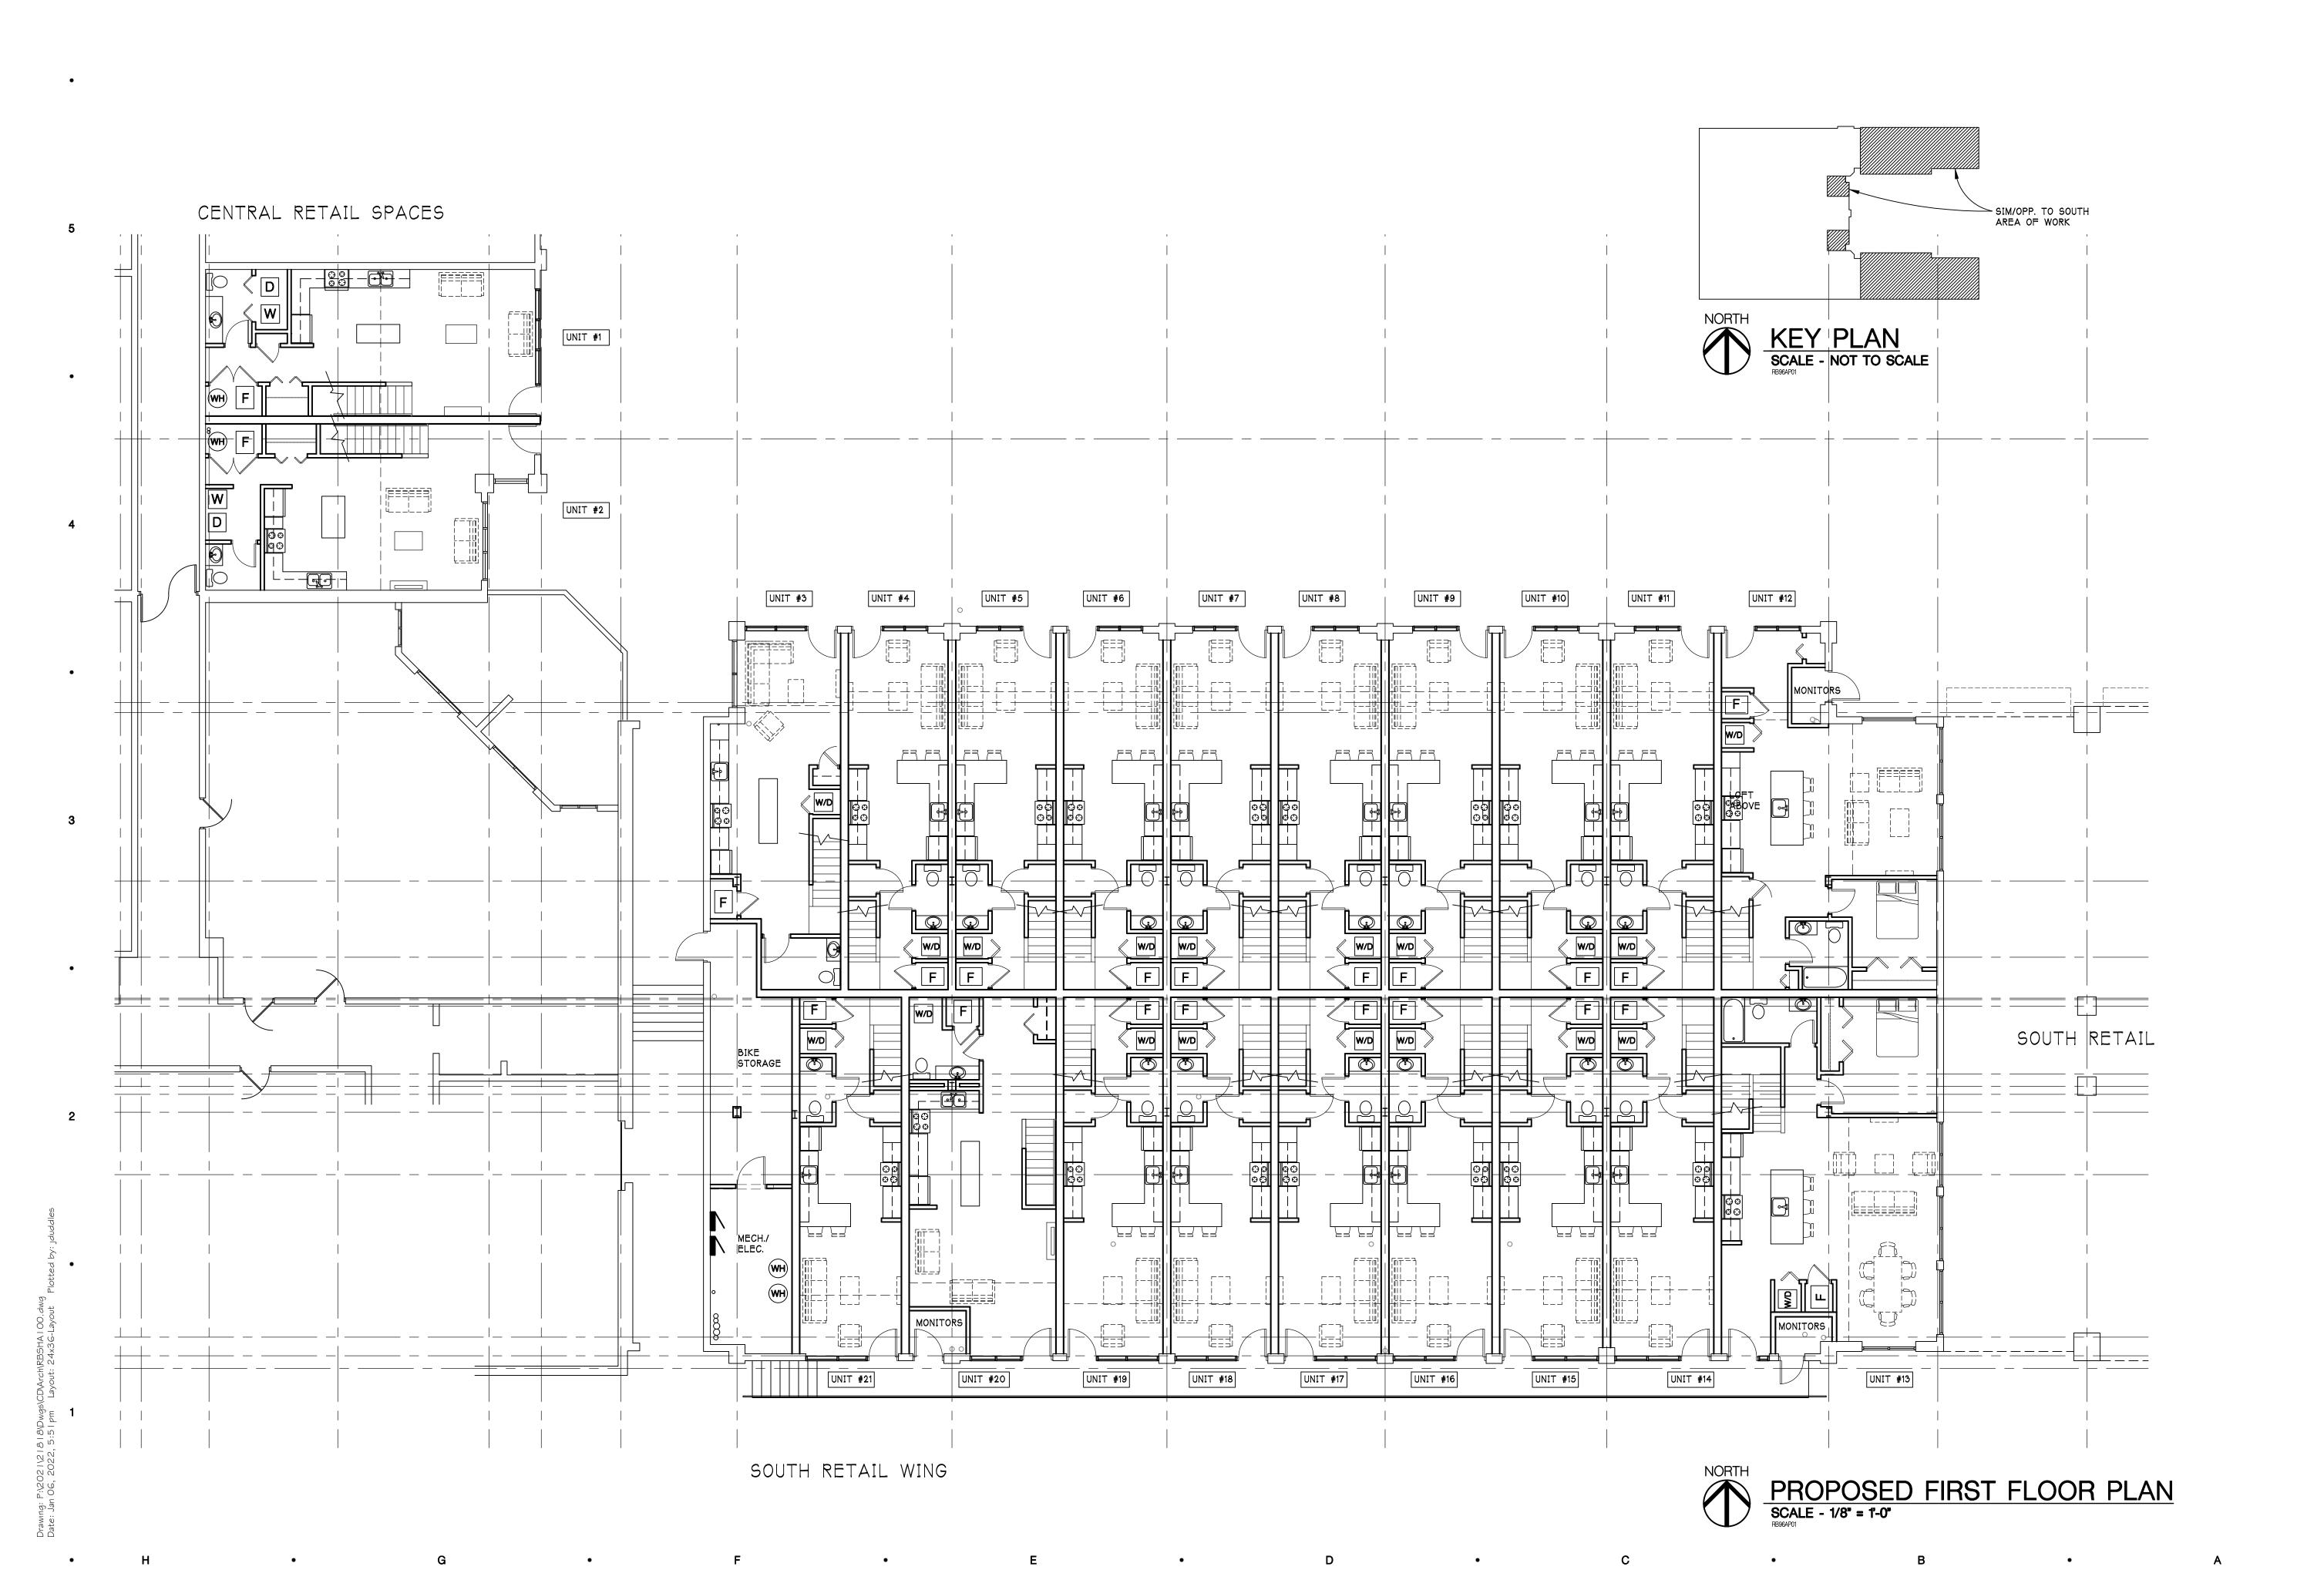
The bioswale device is expected to accumulate debris and litter. Debris and litter should be removed on a monthly basis to maintain appearance and public acceptance of the bioswale device.

Engineered Soil

Longevity of the engineered soil is decreased by clogging, reduced cation exchange capacity and accumulation of sodium. Clogging problems can be reduced by limiting the input of sediment. Cation exchange capacity can be rejuvenated by the replacement of the engineered soil. Sodium accumulation can be countered by adding gypsum to the soil and/or by allowing about 1" of clean water to percolate through the planting bed 3 to 4 times in the spring.

The vegetation type and amount are important to ensure that the facility operates correctly. Bioswale devices typically have a vegetation plan that specifies plant type, location, planting time of year, fertilizing, watering and other specifications. Proper vegetation maintenance includes watering plants during dry periods, re-mulching void areas, treating diseased trees and shrubs and mowing turf areas.

Snow shall not be dumped directly onto the bioswale area.



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Ann Arbor, MI 48104
P.734,663.4189

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CONSULTANT

PROPOSED FIRST FLOOR PLAN


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PROJECT NUMBER

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PROPOSED LOFT PLAN

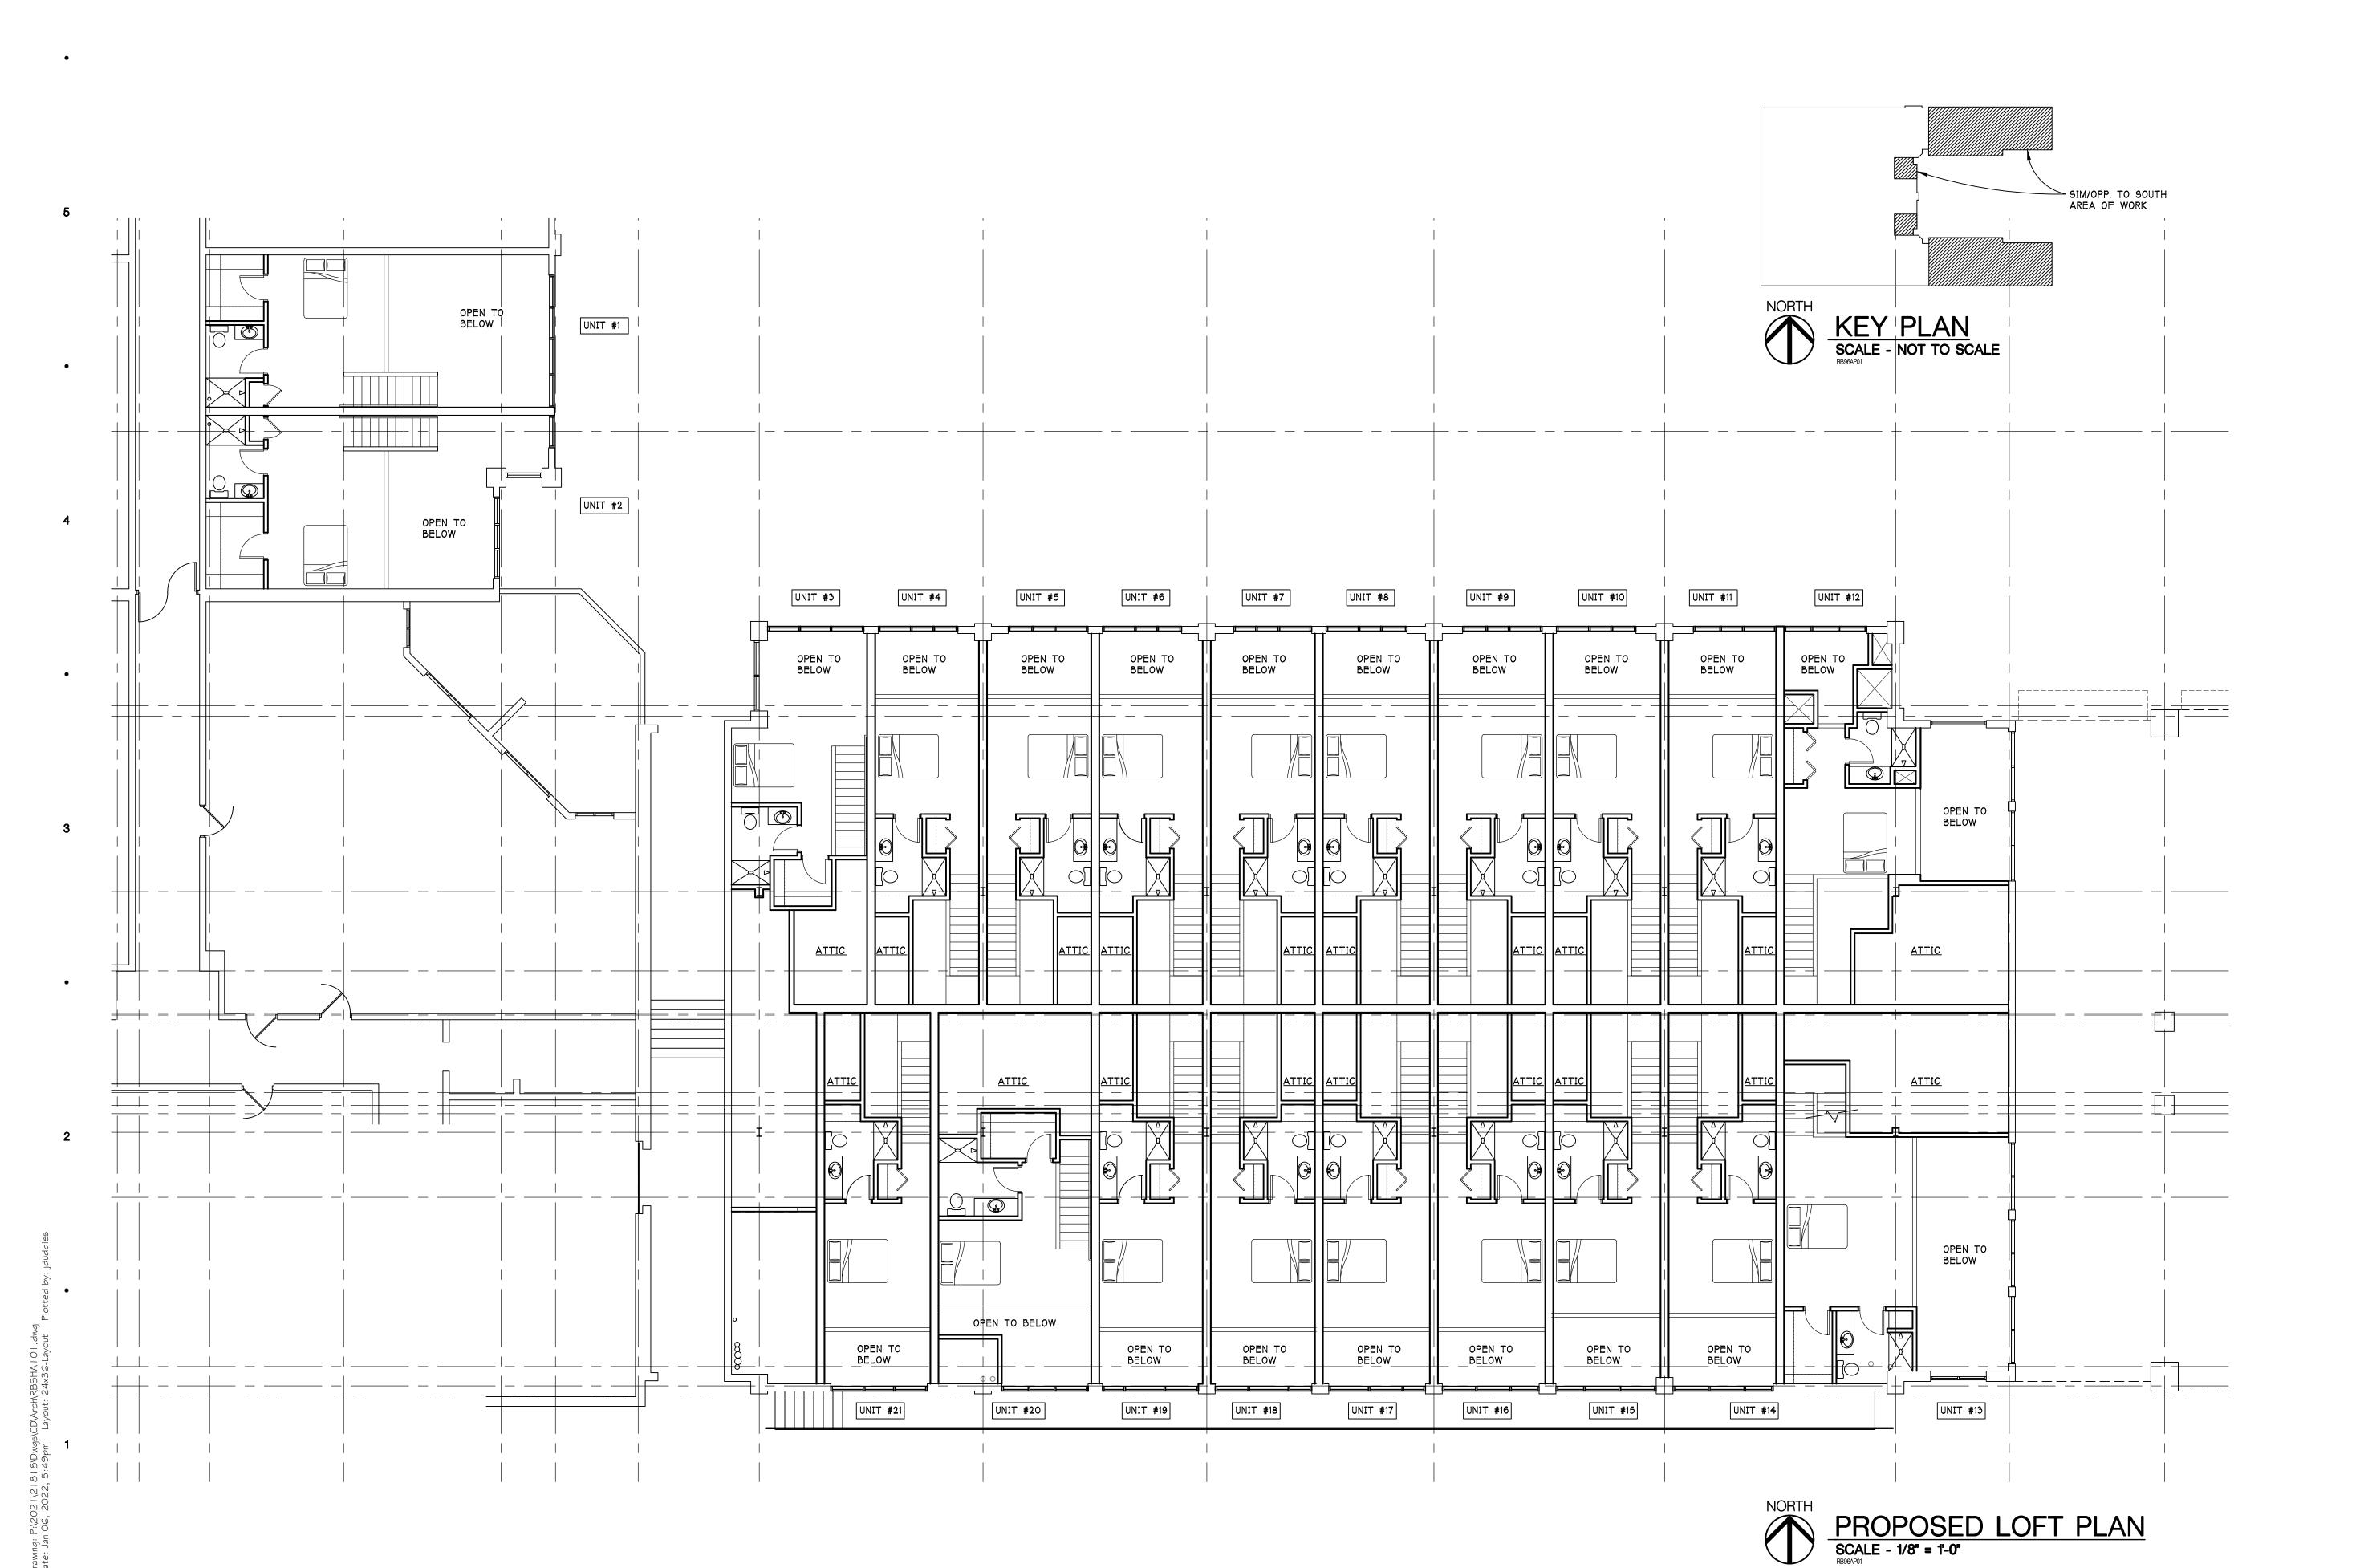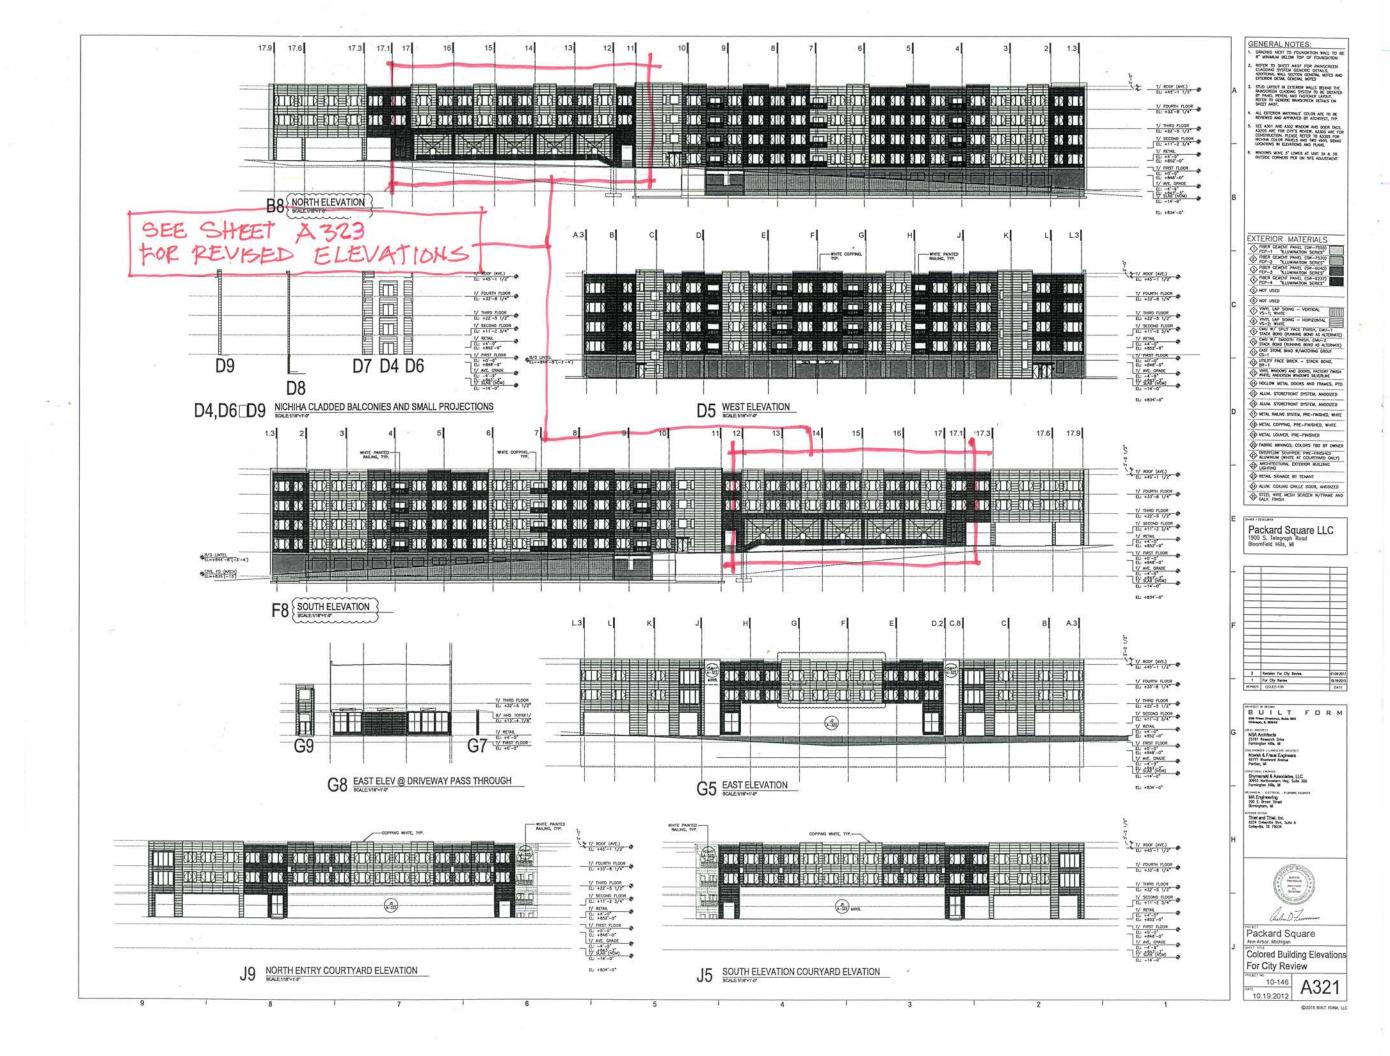
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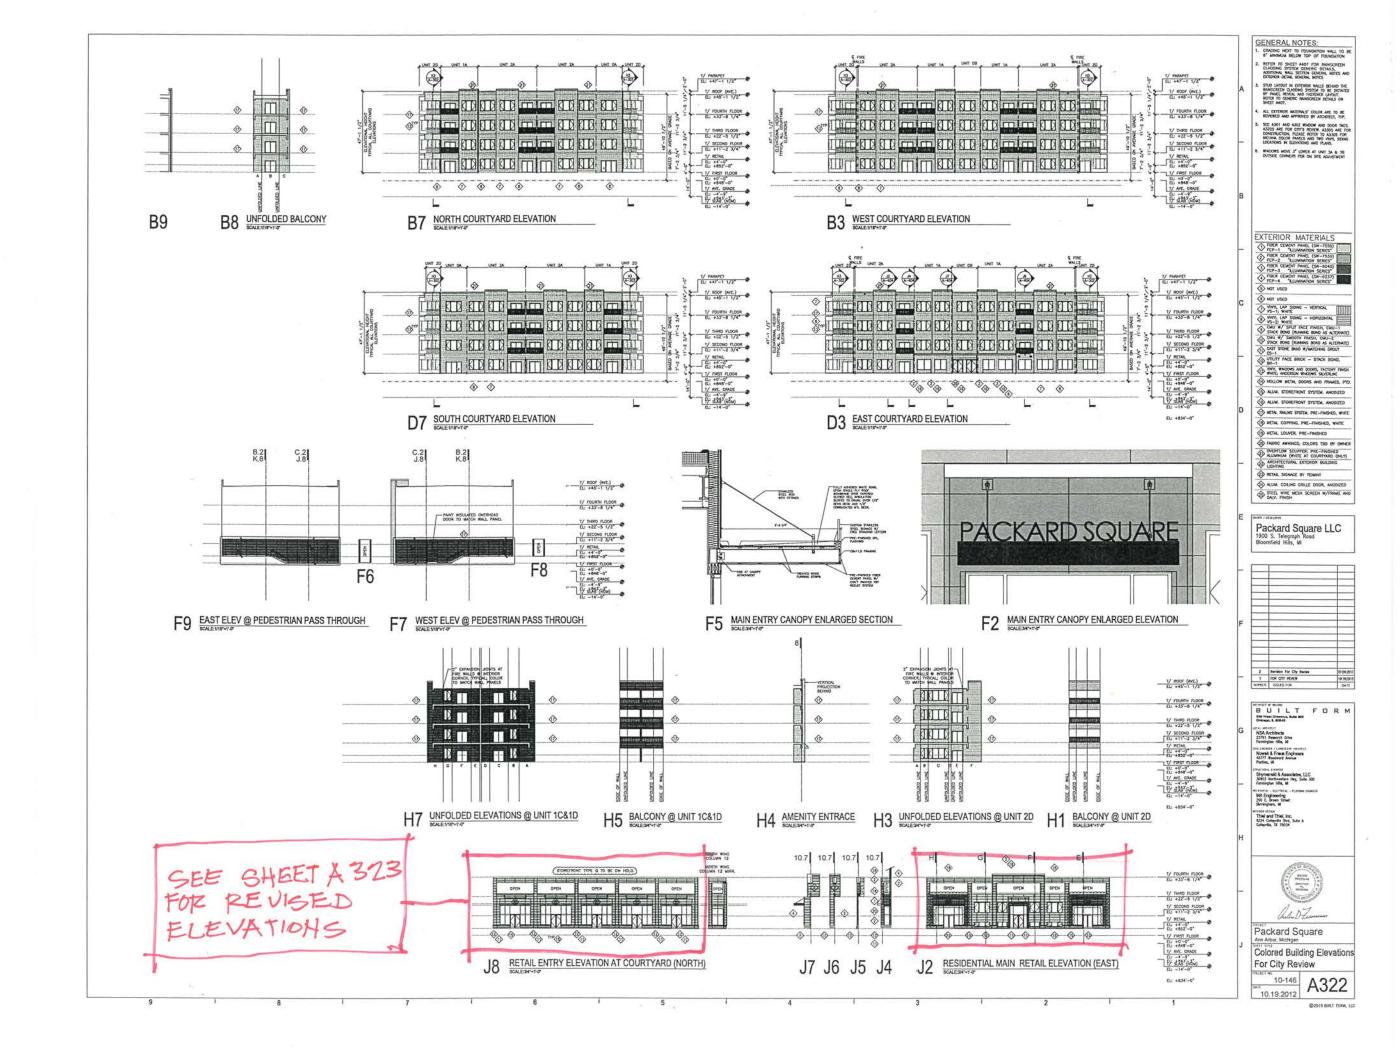
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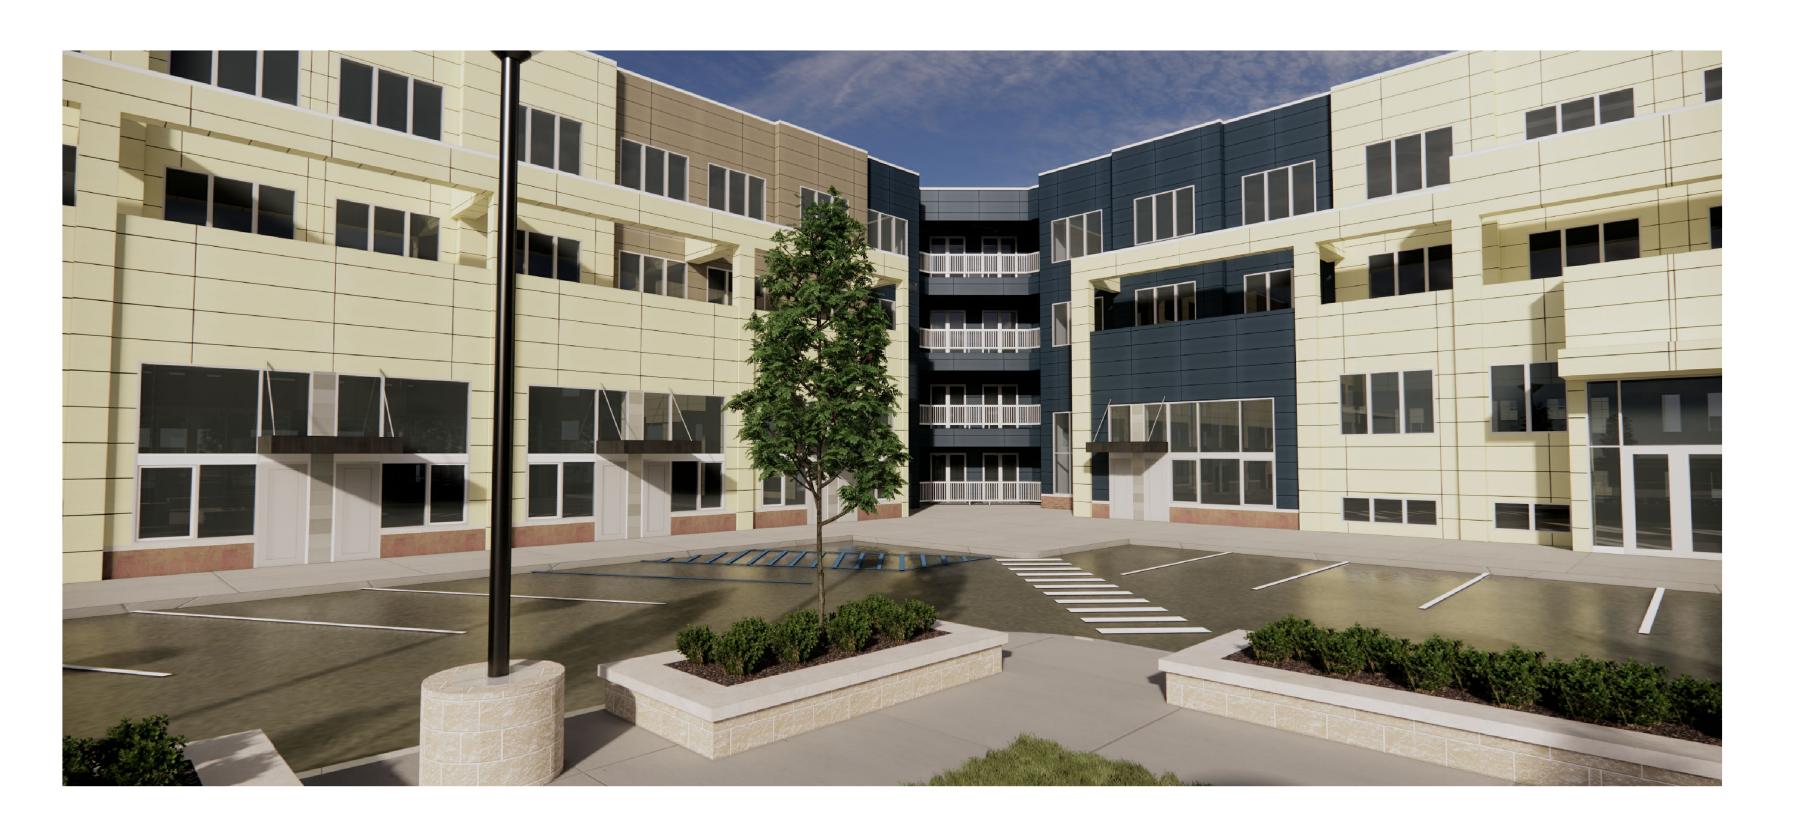






SOUTH/NORTH ELEVATION (OPP.)

SCALE - 1/8" = 1'-0"



2 COURTYARD RENDERING
SCALE - 1/8" = 1'-0"

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PARTIAL BUILDING ELEVATIONS

SHEET TITLE

20-815

PROJECT NUMBER

A-323


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COURTYARD EAST ELEVATION

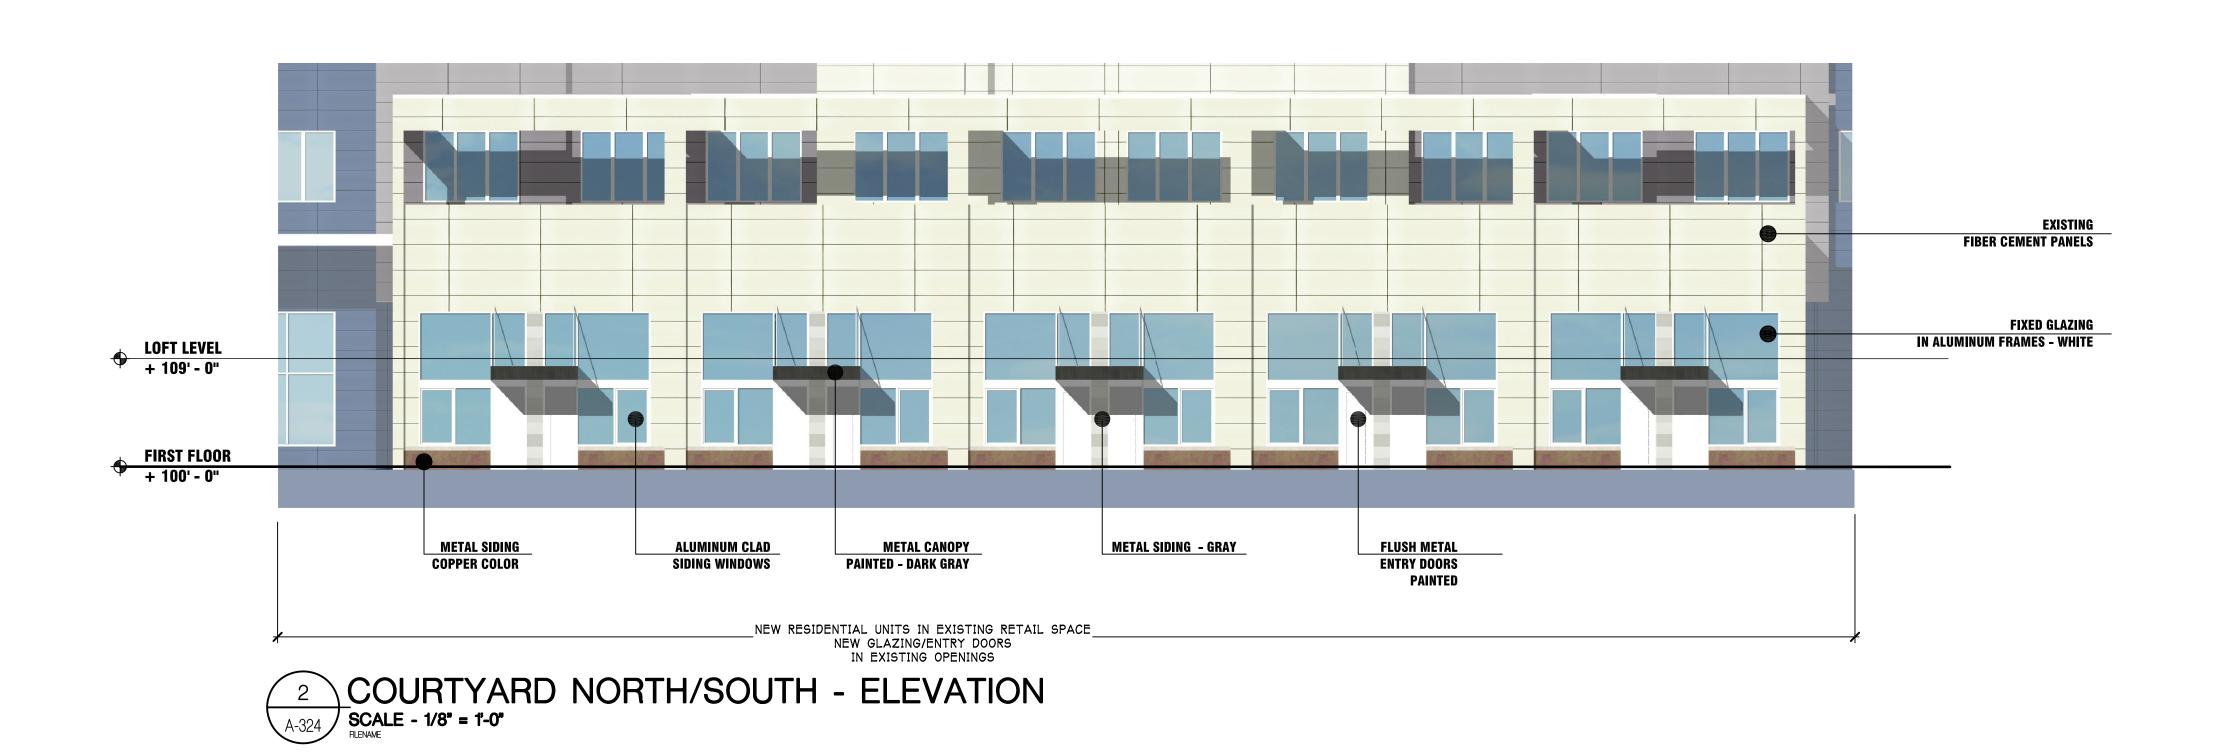SCALE - 1/8" = 1'-0"



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