212 MILLER

ARCHITECT OWNER/DEVELOPER/PETITIONER: CARL O. HUETER A.I.A 410206 LLC 1321 FRANKLIN BLVD THOMAS FITZSIMMONS ANN ARBOR, MI 48103 PO BOX 3783

ENGINEER/PETITIONER'S AGENT: MACON ENGINEERING, LLC KATHY KEINATH, P.E. PO BOX 314

ANN ARBOR, MI 48106

PHONE: 734-323-6881

CHELSEA, MI 48118

PHONE: 734-216-9941

PHONE: 734-276-8175 SURVEYOR: **KEM-TEC & ASSOCIATES** ANTHONY SYCKO, JR, PS 2255 GRATIOT AVE.

EASTPOINTE, MI 48021

586-772-2222

ANN ARBOR, WASHTENAW COUNTY

SITE PLAN SP21-048

COMPARISON CHART

8,722 sf 66.46 ft

15.00 ft

4.36

Kerrytown

8,722 sf

66.46 ft

2,130 sf

24% 14.70 ft

13.40 ft

REQUIRED

13.9 ft 13.9 ft ave front setback

39 ft Max 40 ft

Min 10%

1/2500 sf usable floor area

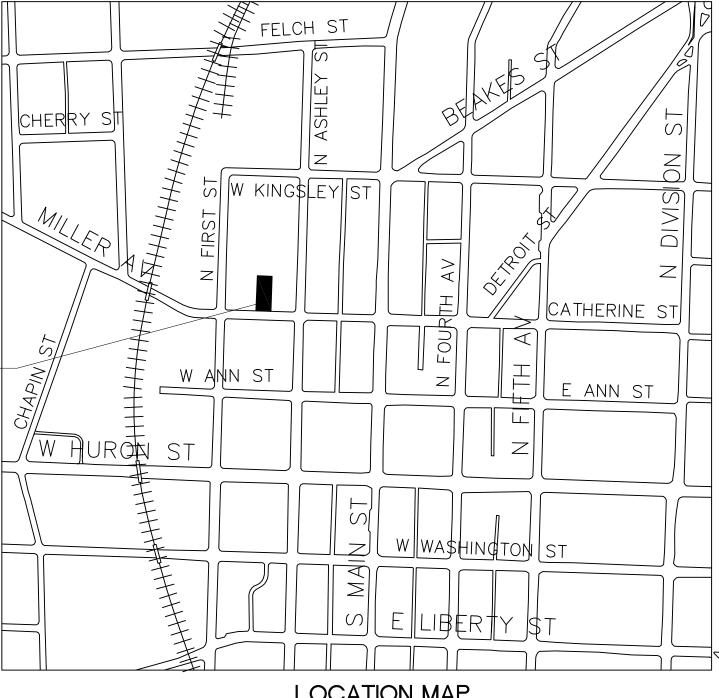
5.2 65% of Dwelling Units

2.0 25% of Dwelling Units

0.8 10% of Dwelling Units

Base FAR none, Premium 1/1000 sf

PROJEC1 SITE



LOCATION MAP

SHEET INDEX

COVER **ALTA SURVEY** DEMOLITION PLAN SP-04 LAYOUT PLAN SP-05 NATURAL FEATURES OVERLAY SP-06 LANDSCAPE SP-07 UTILITIES PLAN STORM WATER MANAGEMENT, GRADING AND SOIL EROSION CONTROL PLAN SP-09 SITE DETAILS

LOWER LEVEL GARAGE PLAN FIRST FLOOR AND COURTYARD PLAN SECOND FLOOR PLAN THIRD FLOOR PLAN ROOF AND MEZZANINE PLAN

SOUTH BUILDING ELEVATION 6C SOUTH COLOR ELEVATION EAST BUILDING ELEVATION

EAST COLOR ELEVATION NORTH BUILDING ELEVATION 8C NORTH COLOR ELEVATION

WEST BUILDING ELEVATION WEST COLOR ELEVATION

BUILDING SECTION

RENDERED BUILDING PERSPECTIVE RENDERED BUILDING PERSPECTIVE PHOTOMETRICS PLAN

NATURAL FEATURES ALTERNATIVE ANALYSES

N.T.S.

212 MILLER ANN ARBOR, I SITE CO

Box

Know what's **below**. **Call** before you dig.

3-7-22 12-22-21 12-15-21 N.T.S.

SP-01

SHEET NO.

PRELIMINARY NOT FOR CONSTRUCTION

STATEMENT OF INTEREST IN LAND

THE PETITIONER IS THE OWNER, DEVELOPER AND MANAGING MEMBER OF THE PROPERTY

THE PROJECT PROPOSES CONSTRUCTION OF ONE BUILDING WITH EIGHT RESIDENTIAL CONDOMINIUMS. PARKING IS PROVIDED IN INDIVIDUAL GARAGES BELOW EACH UNIT. AN OUTDOOR PATIO IS PROVIDED ALONG THE EAST SIDE OF THE SITE.

DEVELOPMENT PROGRAM

THE DEVELOPMENT PROGRAM FOR THE PROJECT INCLUDES EIGHT (8) RESIDENTIAL CONDOMINIUMS. THE SITE IS DESIGNATION IS FRONT YARD STREET. THERE WILL BE A MIX OF ONE, TWO AND THREE BEDROOM UNITS. THE CONDOMINIUMS ARE DESIGNED FOR THOSE WHO WOULD LIKE TO LIVE NEAR THE URBAN CORE OF THE CITY. PRIVATE OUTDOOR SPACE IS PROVIDED FOR EACH UNIT. PARKING WILL BE PROVIDED IN THE LOWER LEVEL.

THE DEVELOPMENT HAS BEEN PLANNED TO PROVIDE ADEQUATE PARKING, INGRESS AND EGRESS, STORM WATER MANAGEMENT FACILITIES, PEDESTRIAN CONNECTIONS AND ALL OTHER REQUIRED SITE ELEMENTS. THE SITE IS TO BE DEVELOPED IN ONE PHASE. IT IS SCHEDULED TO BEGIN UPON APPROVAL AND BE COMPLETED BY 2023. CONSTRUCTION COST ARE CURRENTLY ESTIMATED TO BE \$5,000,000.

THE PROPOSED PROJECT SITE IS LOCATED WITH FRONTAGE ON MILLER AVENUE JUST WEST OF ASHLEY STREET AND EAST OF FIRST STREET IN DOWNTOWN ANN ARBOR. THE SITE IS CURRENTLY ZONED D2. THERE ARE TWO PARCELS TO THE WEST. ONE IS A PARKING LOT AND THE OTHER IS USED AS RESIDENTIAL. BOTH PARCELS ARE ZONED D2. THE PROPERTY TO THE NORTH IS ZONED D2 AND USED AS A PARKING LOT. THE PROPERTY TO THE SOUTH IS ZONED D2 AND IS USED FOR RESIDENTIAL APARTMENTS. THE PROPERTY TO THE EAST IS ZONED D2 WITH A RECENTLY CONSTRUCTED RESIDENTIAL CONDOMINIUM DEVELOPMENT.

THE PROPOSED DEVELOPMENT IS NOT ANTICIPATED TO HAVE A NEGATIVE IMPACT ON PUBLIC SCHOOLS, SURROUNDING DEVELOPMENT, AIR OR WATER QUALITY. THERE ARE NO HISTORIC SITES OR STRUCTURES ON THE PROJECT SITE. THERE ARE NO NATURAL FEATURES ON THE SITE.

TRAFFIC IMPACT ANALYSIS

VEHICULAR, PEDESTRIAN AND BICYCLE ROUTES ARE SHOWN ON THE PLANS. TRIP GENERATIONS ARE SHOWN BELOW BASED ON THE INSTITUTE OF TRANSPORTATION ENGINEERS COMMON TRIP GENERATIONS FOR CONDOMINIUM USES. NO TRAFFIC STUDY IS REQUIRED BASED ON CITY CODE.

SITE TRIP GENERATION

SITE TRIP GENERATION										
				AM Peak Hour			PM Peak Hour			
Land Use	ITE Code	Amount	Units	In	Out	Total	In	Out	Total	
Condominiums	230	8	DU	1	4	5	4	2	5	
Trip Rates taken from ITE Trip Generation manual, 10th Edition										

SOIL EVALUATION

THE SOILS ON THE SITE ARE FOX SERIES FOB BASED ON THE COUNTY SOIL MAPS. INFILTRATION TESTING ON THE SITE WAS NOT PERFORMED AS THE PROJECT PROPOSES TO UTILIZE UNDERGROUND DETENTION IN PROXIMITY TO FOUNDATIONS AND NO INFILTRATION IS PROPOSED.

STANDARD SIDEWALK REPAIR AND MAINTENANCE NOTE

ALL SIDEWALKS ARE TO BE KEPT AND MAINTAINED IN GOOD REPAIR BY THE OWNER OF THE LAND ADJACENT TO AND ABUTTING THE SAME. PRIOR TO THE ISSUANCE OF THE FINAL CERTIFICATE OF OCCUPANCY FOR THIS SITE, ALL EXISTING SIDEWALKS IN NEED OF REPAIR MUST BE REPAIRED IN ACCORDANCE WITH CITY STANDARDS.

LEGAL DESCRIPTION

TAX ID 09-09-29-150-002

THE LAND SITUATED IN THE CITY OF ANN ARBOR, COUNTY OF WASHTENAW, STATE OF MICHIGAN, IS DESCRIBED AS FOLLOWS:

Zoning District

Front Setback

Rear Setback

Building Height

East Side Setback

West Side Setback

Building Coverage

Vehicular Parking

EV-C Vehicular Parking

EV-R Vehicular Parking

EV-I Vehicular Parking

* Includes garages

Open Space

Residential Dwelling Units

Offset at Top of Streetwall

Bicycle Parking Residential

Max Building Module Length

THE EAST 1/2 OF LOTS 1 AND 2, IN BLOCK 3 NORTH OF HURON STREET, RANGE 2 EAST, ORIGINAL PLAT OF THE VILLAGE (NOW CITY) OF ANN ARBOR, AS RECORDED IN TRANSCRIPTS, PAGES 152 AND 153, WASHTENAW COUNTY RECORDS.

GENERAL DESCRIPTION OF NATURAL FEATURES

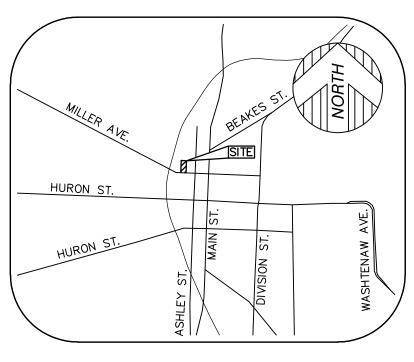
THERE ARE NO WOODLANDS, WETLANDS, WATERCOURSES, STEEP SLOPES, FLOODPLAIN OR ENDANGERED SPECIES HABITAT LOCATED ON THE SITE. THERE ARE TWO LANDMARK TREES LOCATED ON THE PROPERTY. ONE IS A 12" GINKGO AND THE OTHER IS A 35" MULBERRY.

NATURAL FEATURES STATEMENT OF IMPACT

THE 35" MULBERRY TREE WAS DETERMINED TO BE A HAZARD IN POOR CONDITION DUE TO A SPLIT TRUNK. NO MITIGATION IS REQUIRED FOR ITS REMOVAL. THE REMOVAL OF THE 12" GINKGO REQUIRES MITIGATION AS SHOWN ON THE NATURAL FEATURES AND LANDSCAPING PLANS. THE SITE IS IN THE FLOODPLAIN MANAGEMENT OVERLAY ZONING DISTRICT HOWEVER THE REGULATIONS DO NOT APPLY AS THE SITE IS NOT IN THE FLOODPLAIN.

SOLID WASTE DISPOSAL PLAN

THE SITE HAS LESS THAN 10 UNITS AND WOULD BE ALLOWED TO HAVE CARTS COLLECTED CURB SIDE. HOWEVER, THE SMALL SIZE OF THE SITE AS WELL AS ITS LOCATION ON MILLER AVENUE MAKES ACCESS TO THE SITE FOR SOLID WASTE TRUCKS CHALLENGING. THE DEVELOPMENT CONSIDERED THE SAFE ACCESS FOR TRUCKS, SAFETY OF PEDESTRIANS AND SAFETY OF MOTOR VEHICLES USING MILLER AVENUE. IT WAS DETERMINED THAT THE BEST SOLUTION WAS TO ELIMINATE THE NEED FOR SOLID WASTE VEHICLES TO PROVIDE COLLECTION AT THE SITE. THE CITY'S SOLID WASTE RESOURCE MANAGEMENT PLAN IDENTIFIED CONTAINER SHARING AS A SOLUTION TO MANAGING TRASH AND RECYCLING DOWNTOWN. CONTAINER SHARING INCREASES COLLECTION EFFICIENCY, REDUCES THE COLLECTION OF PARTIALLY FILLED CONTAINERS, AND ALIGNS WITH SUSTAINABILITY FRAMEWORK GOALS. THE PROJECT PROPOSES TO SHARE THE DUMPSTERS AT THE 309 ASHLEY DEVELOPMENT DIRECTLY ADJACENT TO THE PROJECT SITE. AN EASEMENT AGREEMENT WILL BE PROVIDED TO ALLOW THE 212 MILLER PROJECT TO ACCESS AND USE THE 309 ASHLEY DUMPSTERS. ADDITIONAL INFORMATION IS PROVIDED ON THE LAYOUT SHEET.



VICINITY MAP (NOT TO SCALE)

PARCEL AREA

8,721± SQUARE FEET = 0.20± ACRES

BENCHMARKS

BENCHMARK #1 1/2" REBAR WITH CAP, SOUTH SIDE OF MILLER AVENUE.

ELEVATION = 809.07' (NAVD 88)

BENCHMARK #2
MAG NAIL IN SIDEWALK, NORTH SIDE OF MILLER AVENUE. ELEVATION = 800.33' (NAVD 88)

SURVEYOR'S NOTE

THE UNDERGROUND UTILITIES SHOWN HAVE BEEN LOCATED FROM FIELD SURVEY INFORMATION AND EXISTING DRAWINGS. THE SURVEYOR MAKES NO GUARANTEES THAT THE UNDERGROUND UTILITIES SHOWN COMPRISE ALL SUCH UTILITIES IN THE AREA, EITHER IN SERVICE OR ABANDONED. THE SURVEYOR FURTHER DOES NOT WARRANT THAT THE UNDERGROUND UTILITIES SHOWN ARE IN THE EXACT LOCATION INDICATED ALTHOUGH HE DOES CERTIFY THAT THEY ARE LOCATED AS ACCURATELY AS POSSIBLE FROM INFORMATION AVAILABLE. THE SURVEYOR HAS NOT PHYSICALLY LOCATED THE UNDERGROUND UTILITIES OTHER THAN THE STRUCTURE INVENTORY SHOWN HEREON.

I ECENID

LEGEND	
•	SET 1/2" REBAR WITH CAP P.S. 47976
•	FOUND MONUMENT (AS NOTED)
(R&M)	RECORD AND MEASURED DIMENSION
(R)	RECORD DIMENSION
(M)	MEASURED DIMENSION
× ^{0.00}	GROUND ELEVATION
	ELECTRIC METER
0	UTILITY POLE
	GAS METER
S	SANITARY MANHOLE
=	SQUARE CATCH BASIN
©	STORM DRAIN MANHOLE
	FIRE HYDRANT
•	BOLLARD
\$	LIGHTPOST/LAMP POST
A CONTRACTOR OF THE CONTRACTOR	DECIDUOUS TREE (AS NOTED)
1470	PARCEL BOUNDARY LINE
	PLATTED LOT LINE
	ADJOINER PARCEL LINE
	BUILDING
	CONCRETE CURB
	EDGE OF CONCRETE (CONC.)
	EDGE OF ASPHALT (ASPH.)
X	FENCE (AS NOTED)
	WALL (AS NOTED)
	•
G	GAS LINE
s	SANITARY LINE
D	STORM LINE
w	WATER LINE
	MINOR CONTOUR LINE
	MAJOR CONTOUR LINE
	BUILDING AREA
	BOILDING ANLA
	ASPHALT
4.	CONCRETE

MANHOLE SCHEDULE

CATCH BASIN (CB#1026)

RIM=805.38' INV. 12" PIPE, S=799.88' STORM MANHOLE (SRM#1032) RIM=806.08' INV. 12" PIPE, N=799.88'

INV. 12" PIPE, SE=800.78' INV. 24" PIPE, E-W=798.58'

SANITARY MANHOLE (SMH#1158) RIM=797.36' INV. 8" VCP, S=786.36'

INV. 48" PIPE, E-W=783.56' SANITARY MANHOLE (SMH#1181)

RIM=797.70' INV. 8" VCP, N=786.70'

INV. 8" VCP, E=786.90'

STORM MANHOLE (SRM#1182) RIM = 795.54'

APPROXIMATE INVERT PER PLAN NOT ABLE TO VERIFY IN FIELD INV. 24" PIPE, E=789.54'

SANITARY MANHOLE (SMH#1259)

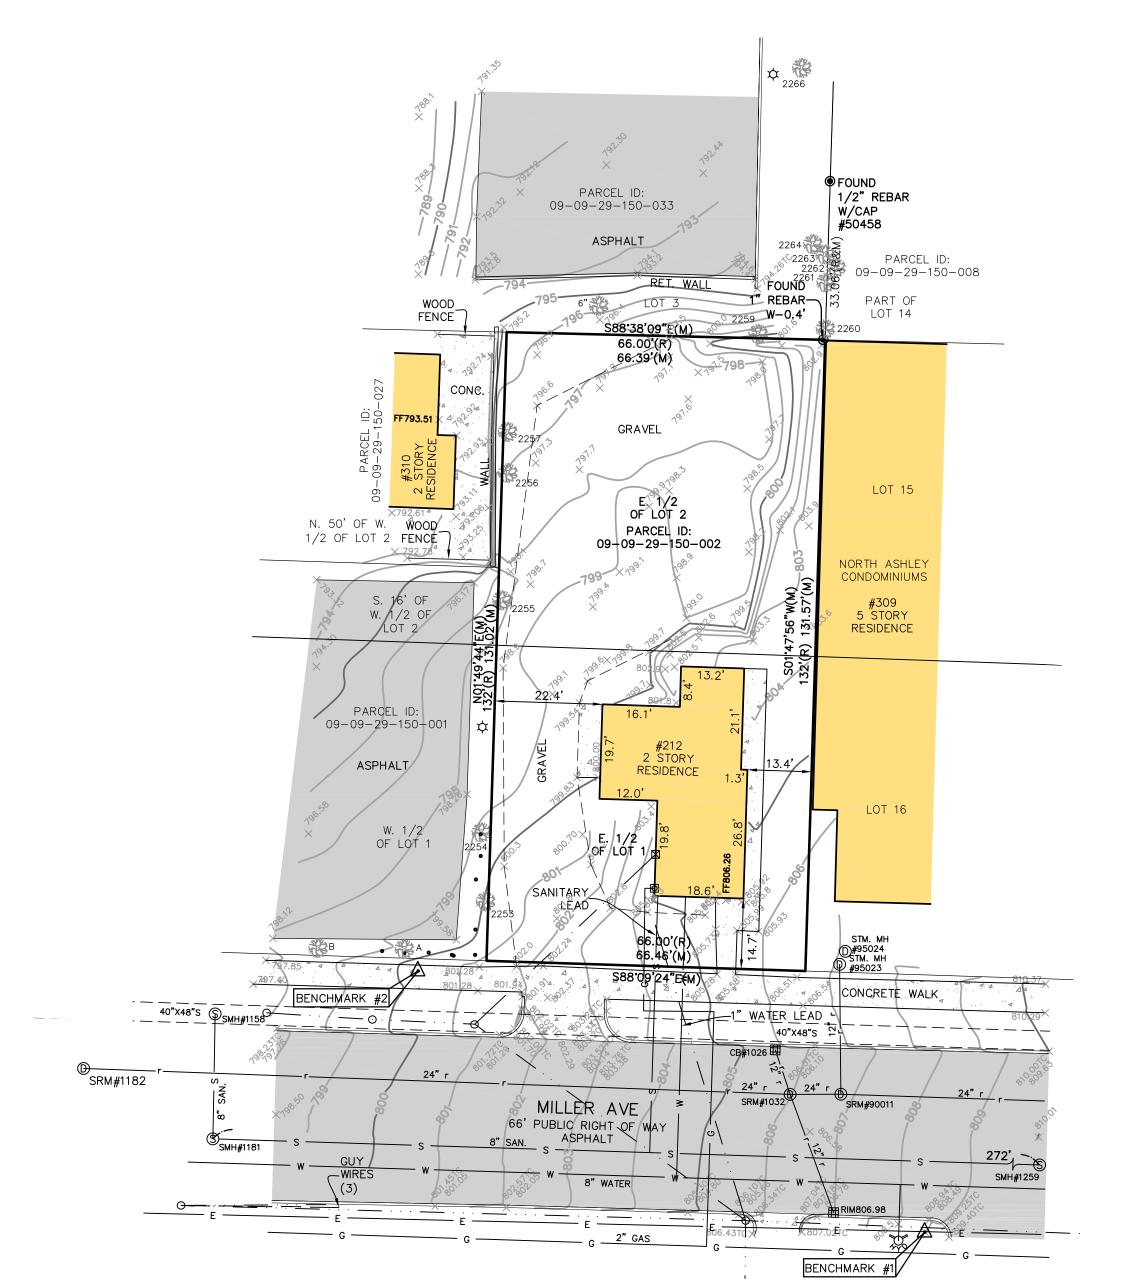
RIM=816.80' INV. 8" VCP, E-W=808.60'

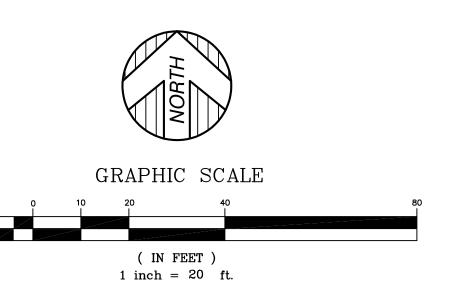
STORM MANHOLE (SRM#90011) RIM = 806.65'INV. 12" PIPE, N=799.95' INV. 24" PIPE, E=798.80'

INV. 24" PIPE, W=798.95'

STORM MANHOLE (SRM#95023-95024)

RIM=807.17' SHARED CHAMBER INV. 12" PIPE, N=800.22' T/WEIR WALL = 801.77NV. 12" PIPE, S=799.97





PROPERTY DESCRIPTION

THE LAND SITUATED IN THE CITY OF ANN ARBOR, COUNTY OF WASHTENAW, STATE OF MICHIGAN, IS DESCRIBED AS FOLLOWS:

SUI

THE EAST 1/2 OF LOTS 1 AND 2, IN BLOCK 3 NORTH OF HURON STREET, RANGE 2 EAST, ORIGINAL PLAT OF THE VILLAGE (NOW CITY) OF ANN ARBOR, AS RECORDED IN TRANSCRIPTS, PAGES 152 AND 153, WASHTENAW COUNTY

TITLE REPORT NOTE

ONLY THOSE EXCEPTIONS CONTAINED WITHIN THE ABSOLUTE TITLE INC. FILE No. 86543, DATED JULY 15, 2019, AND RELISTED BELOW WERE CONSIDERED FOR THIS SURVEY. NO OTHER RECORDS RESEARCH WAS PERFORMED BY THE CERTIFYING SURVEYOR.


NO SPECIFIC EASEMENTS LISTED

SURVE	YOR	S CF	RTIFI	CAT	ION

TO THOMAS FITZSIMMONS AND MICHAEL STAITI; AND ABSOLUTE TITLE, INC.: THIS IS TO CERTIFY THAT THIS MAP OR PLAT AND THE SURVEY ON WHICH IT IS BASED WERE MADE IN ACCORDANCE WITH THE 2016 MINIMUM STANDARD DETAIL REQUIREMENTS FOR ALTA/NSPS LAND TITLE SURVEYS, JOINTLY ESTABLISHED AND ADOPTED BY ALTA AND NSPS, AND INCLUDED ITEMS 2, 4, 5, 7A, 8, 9, AND 11 OF TABLE A, THEREOF. THE FIELD WORK WAS COMPLETED

DATE OF PLAT OR MAP: 02/05/2021

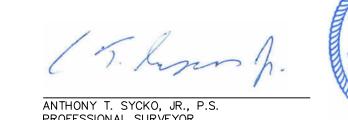ON 02/03/2021.





ANTHONY T. SYCKO, JR., P.S. PROFESSIONAL SURVEYOR MICHIGAN LICENSE NO. 47976 22556 GRATIOT AVE., EASTPOINTE, MI 48021 TSycko@kemtec-survey.com





MRJ MRJ MRJ CMC

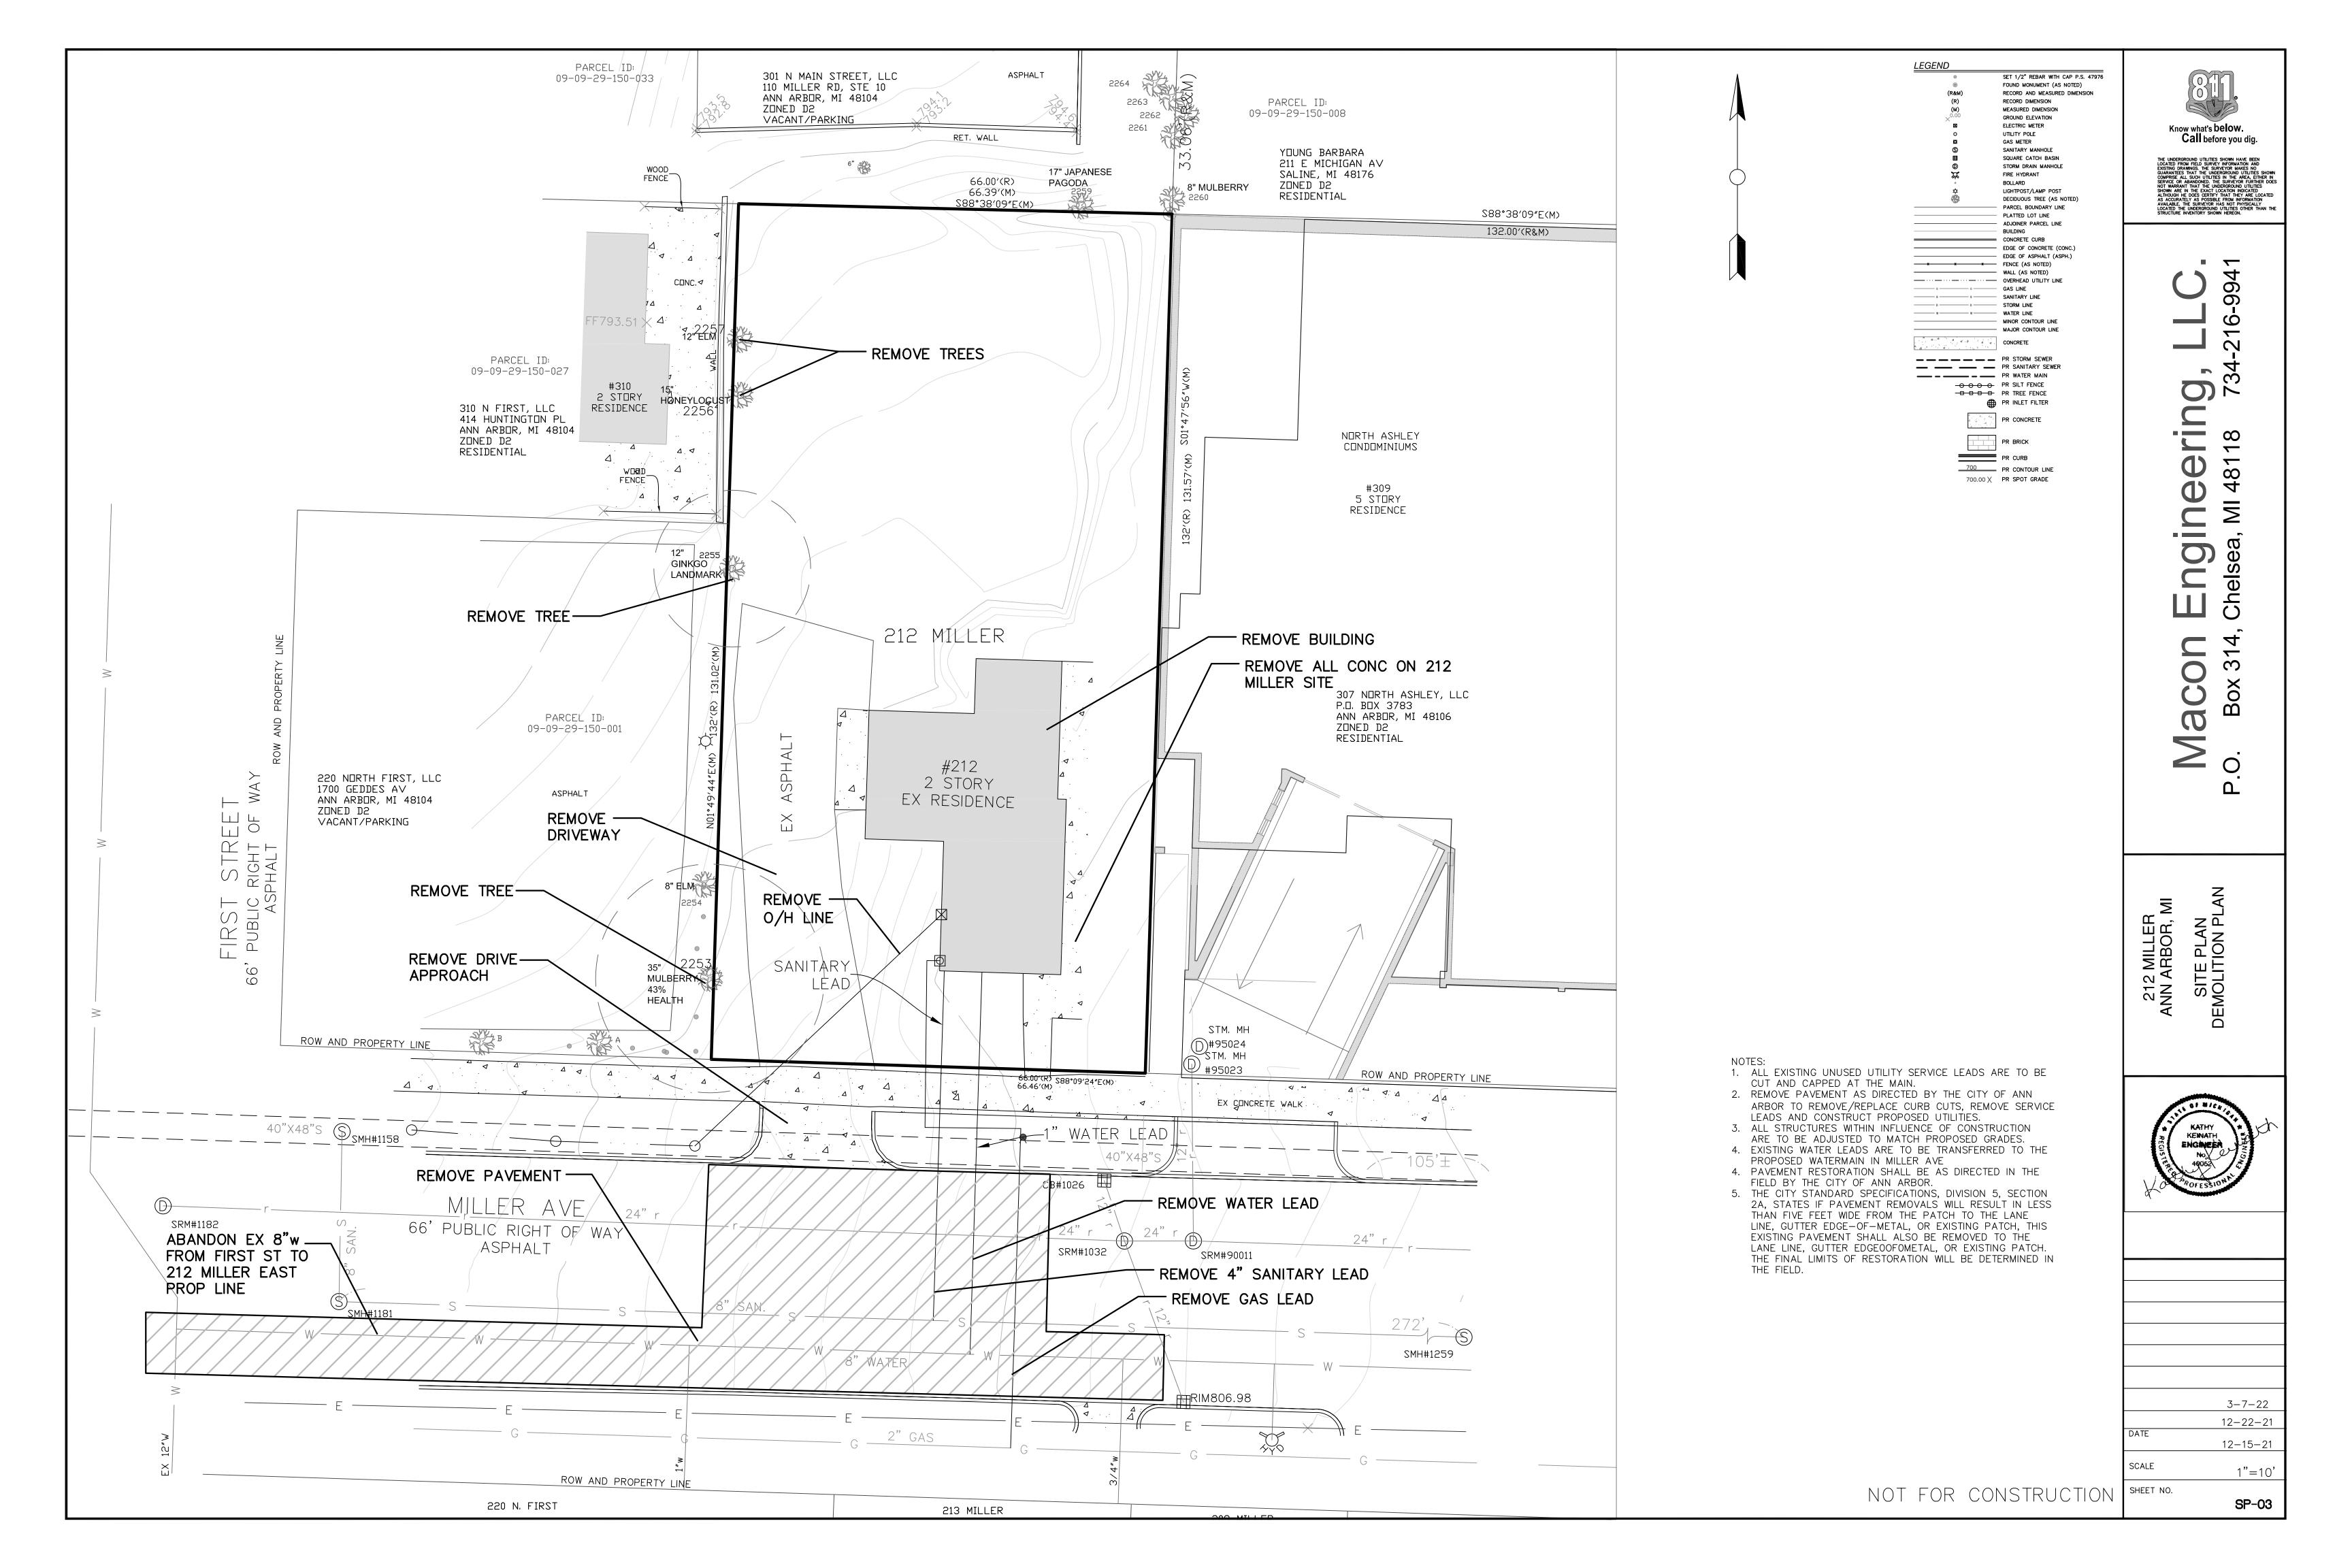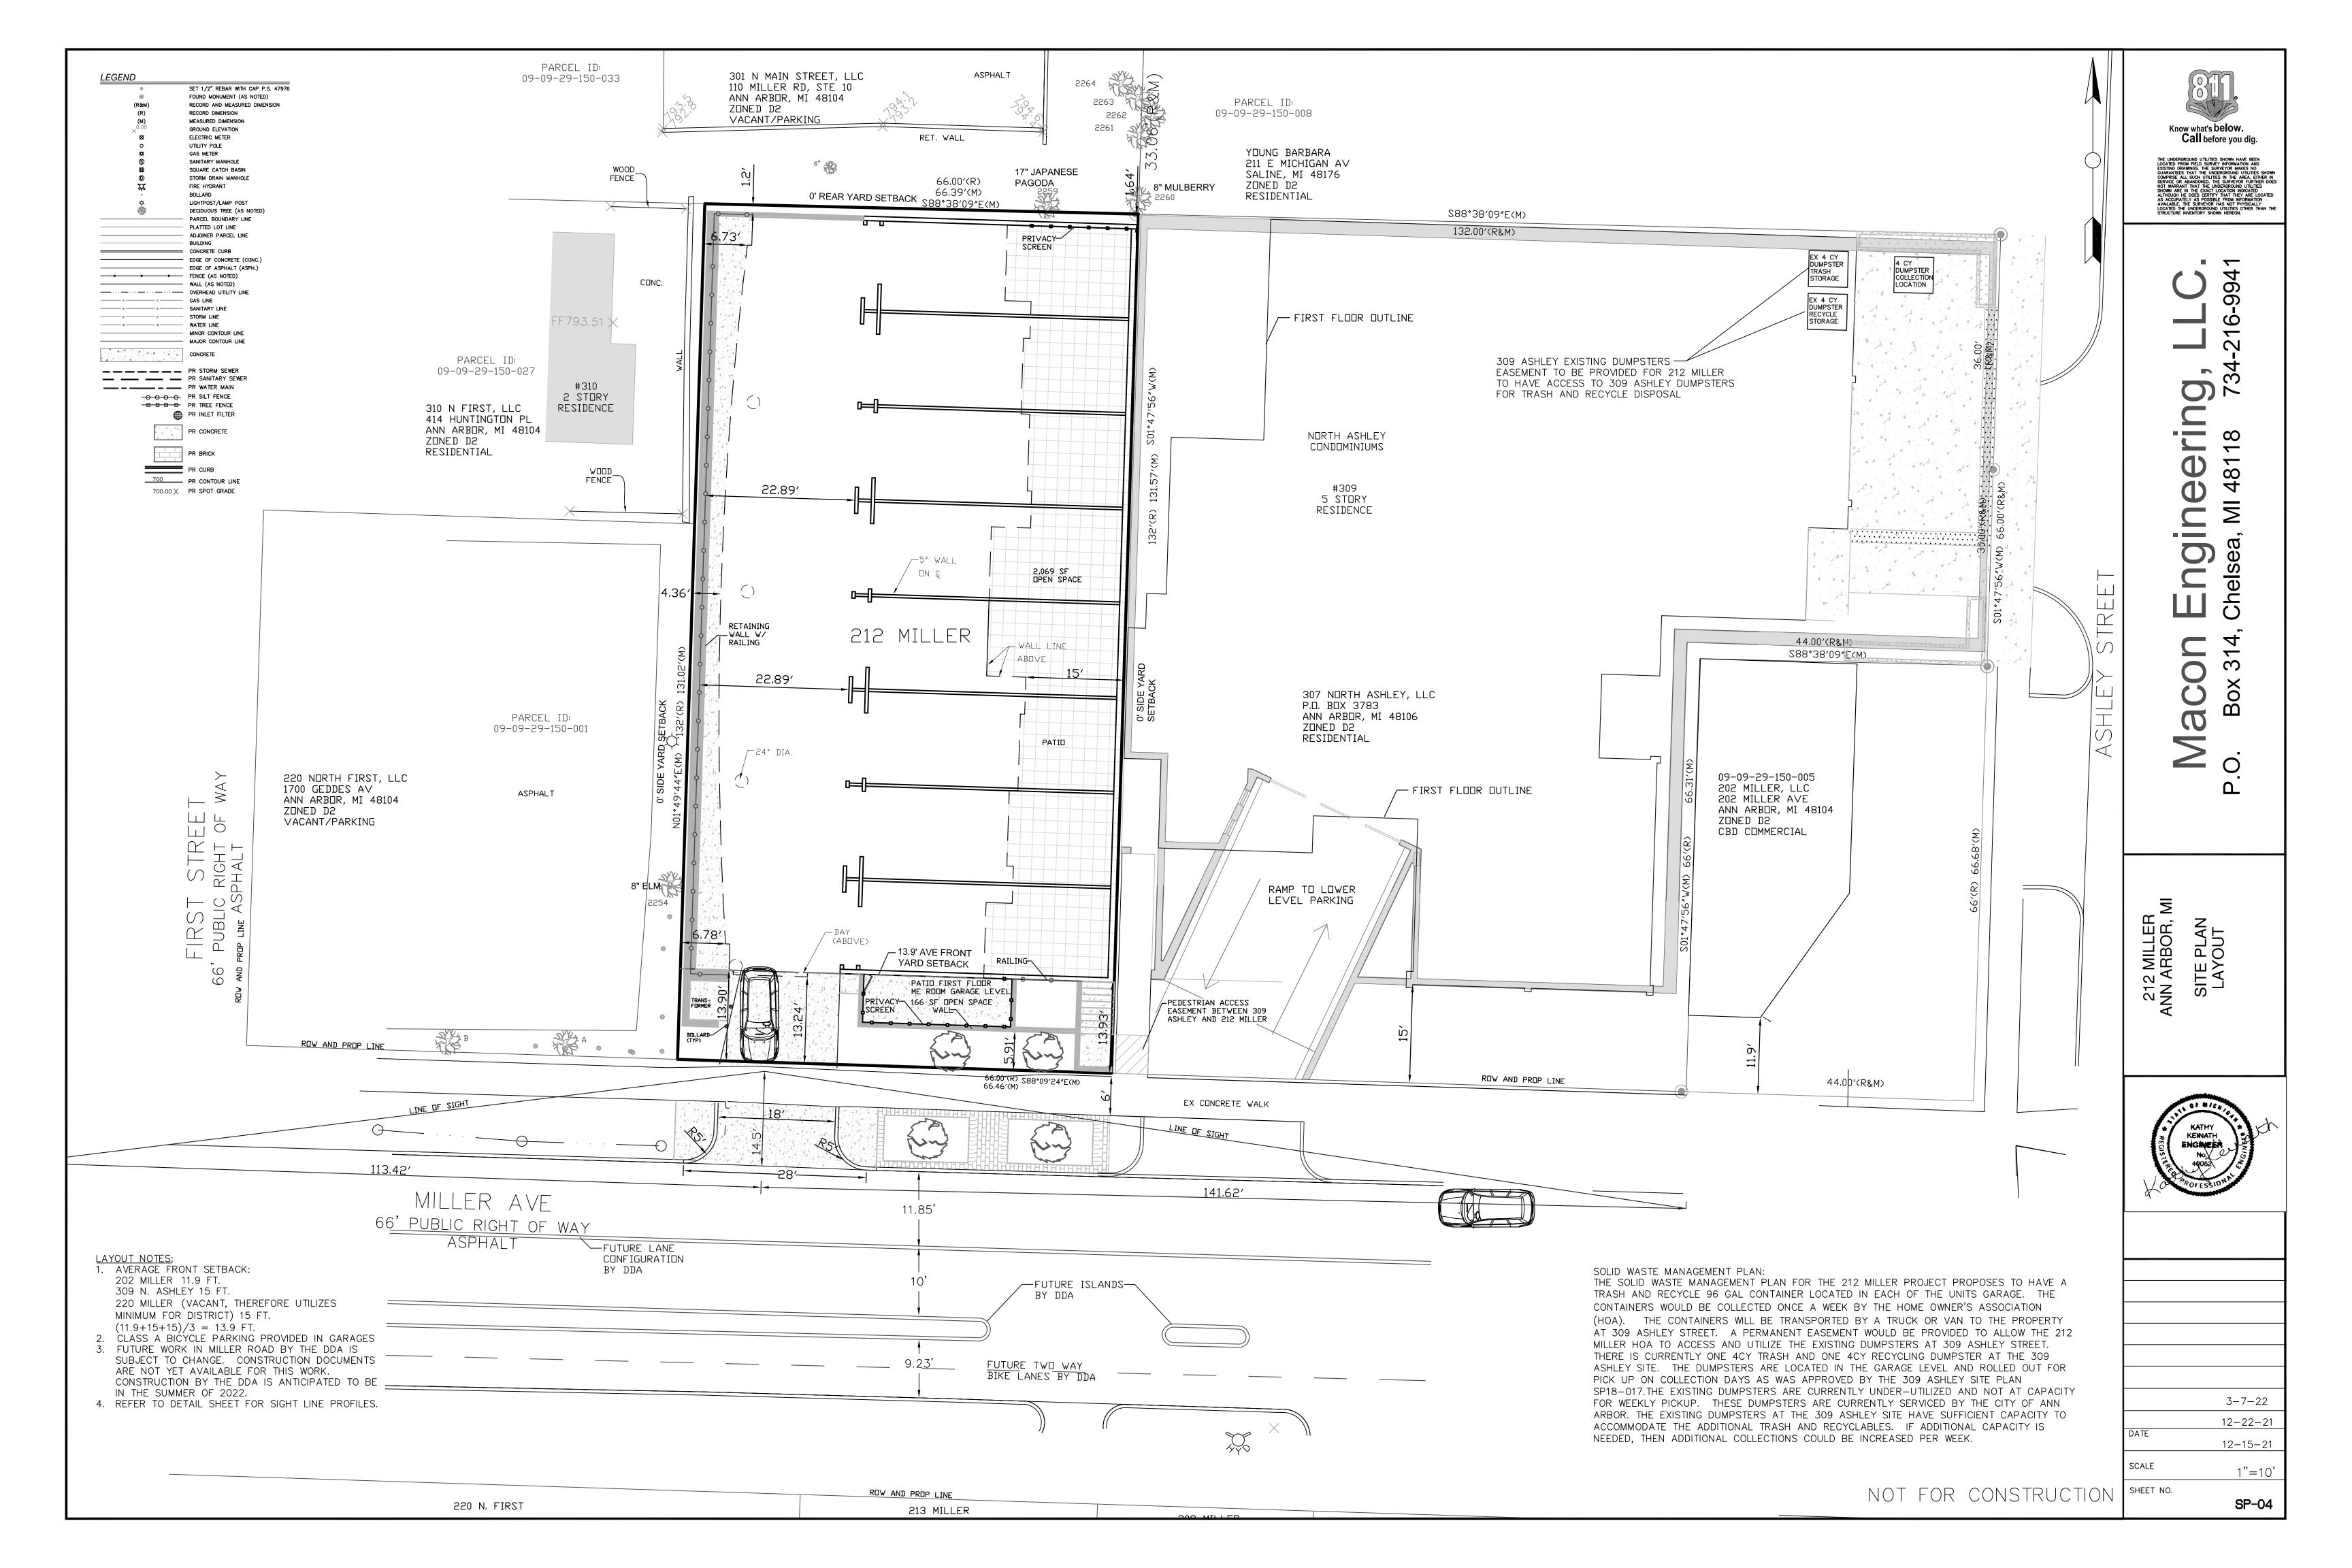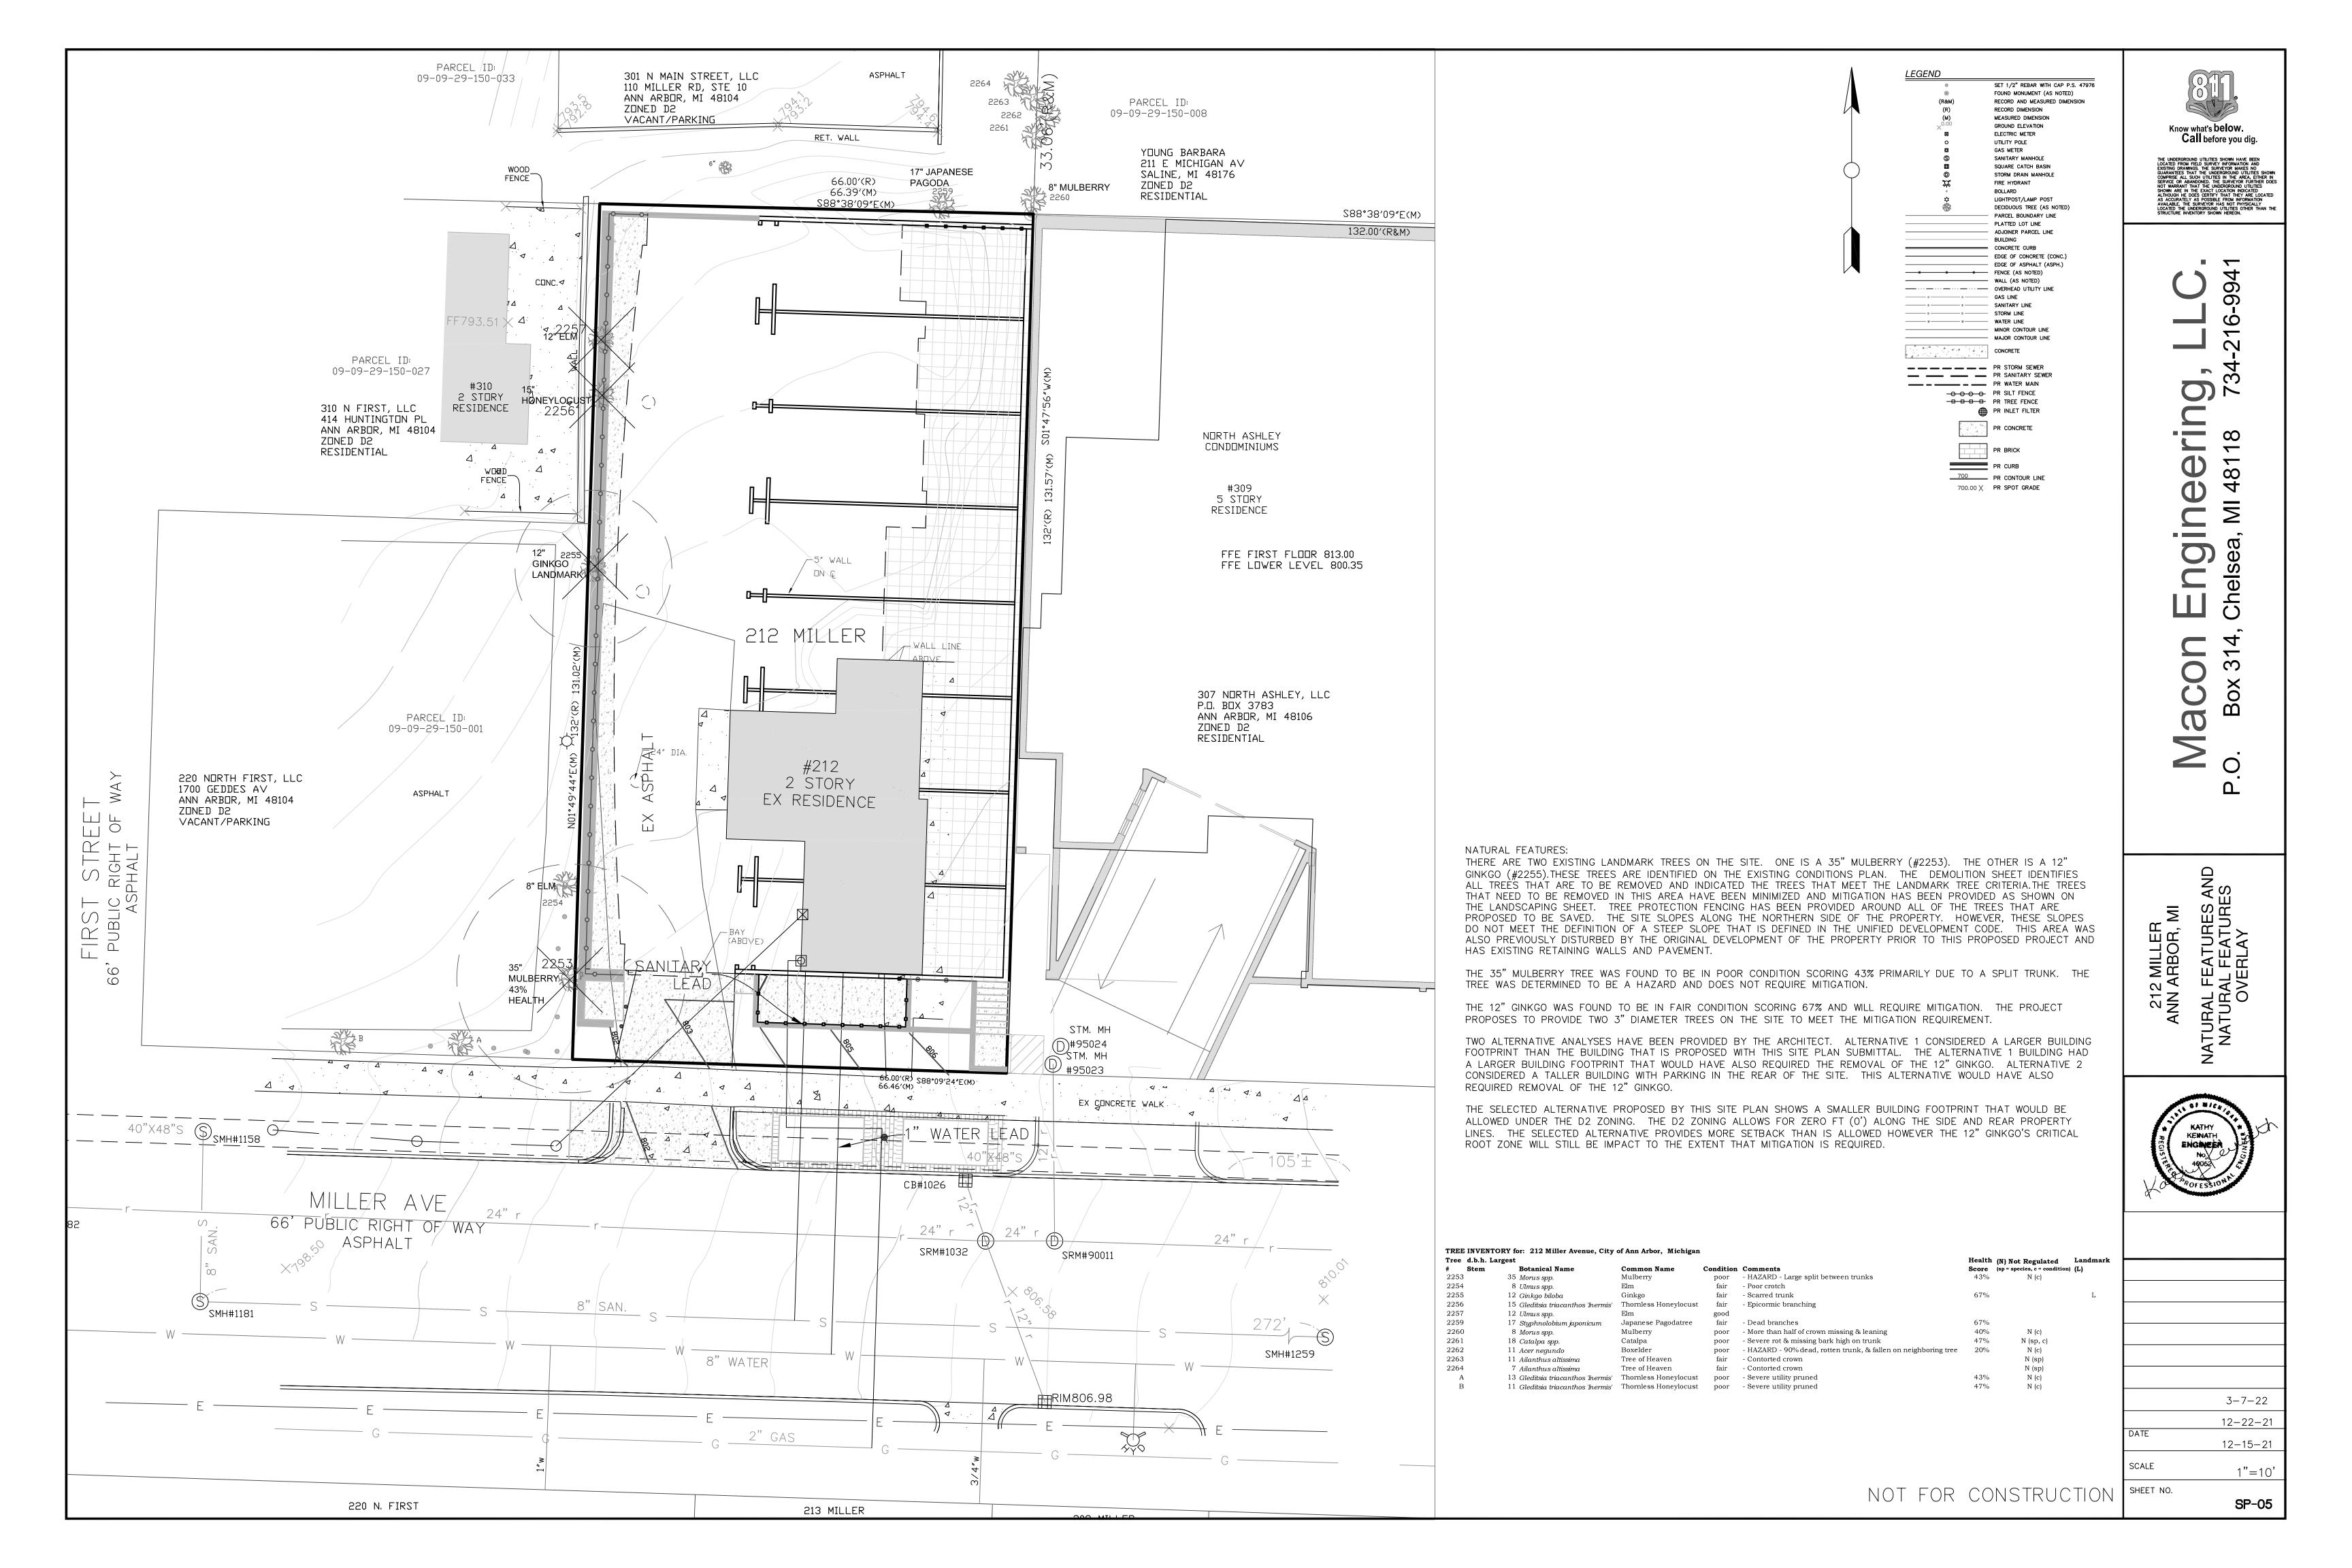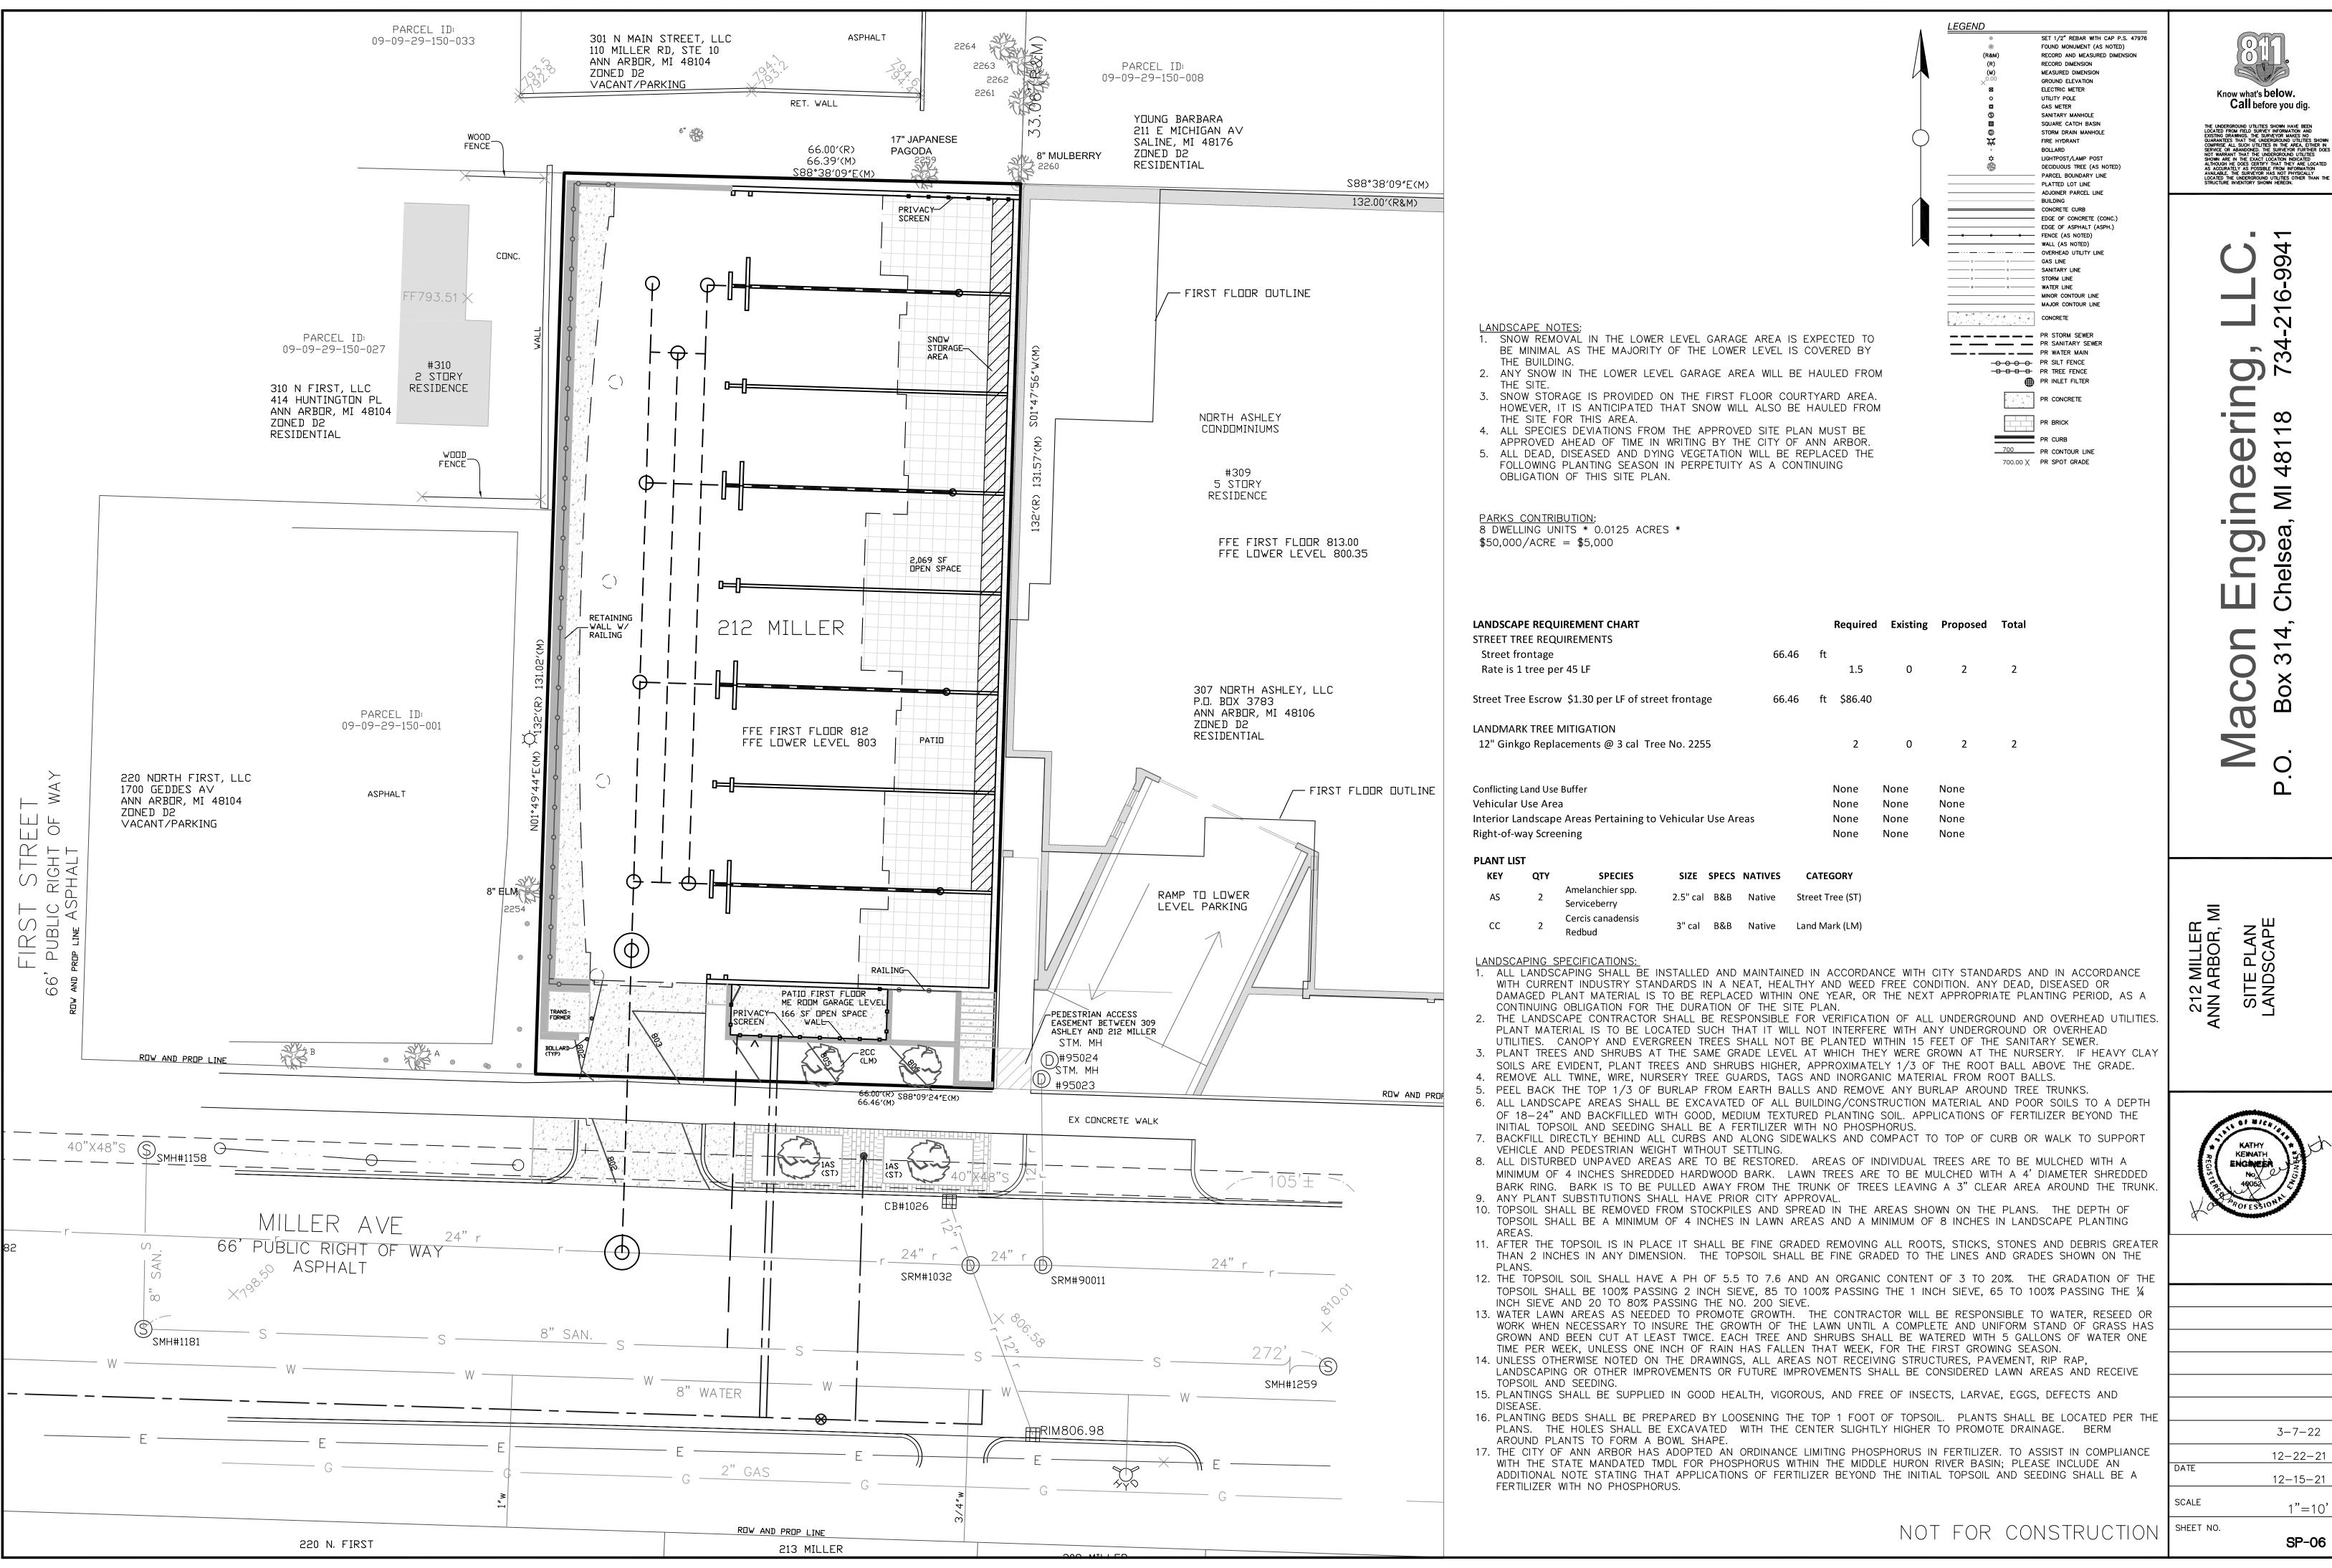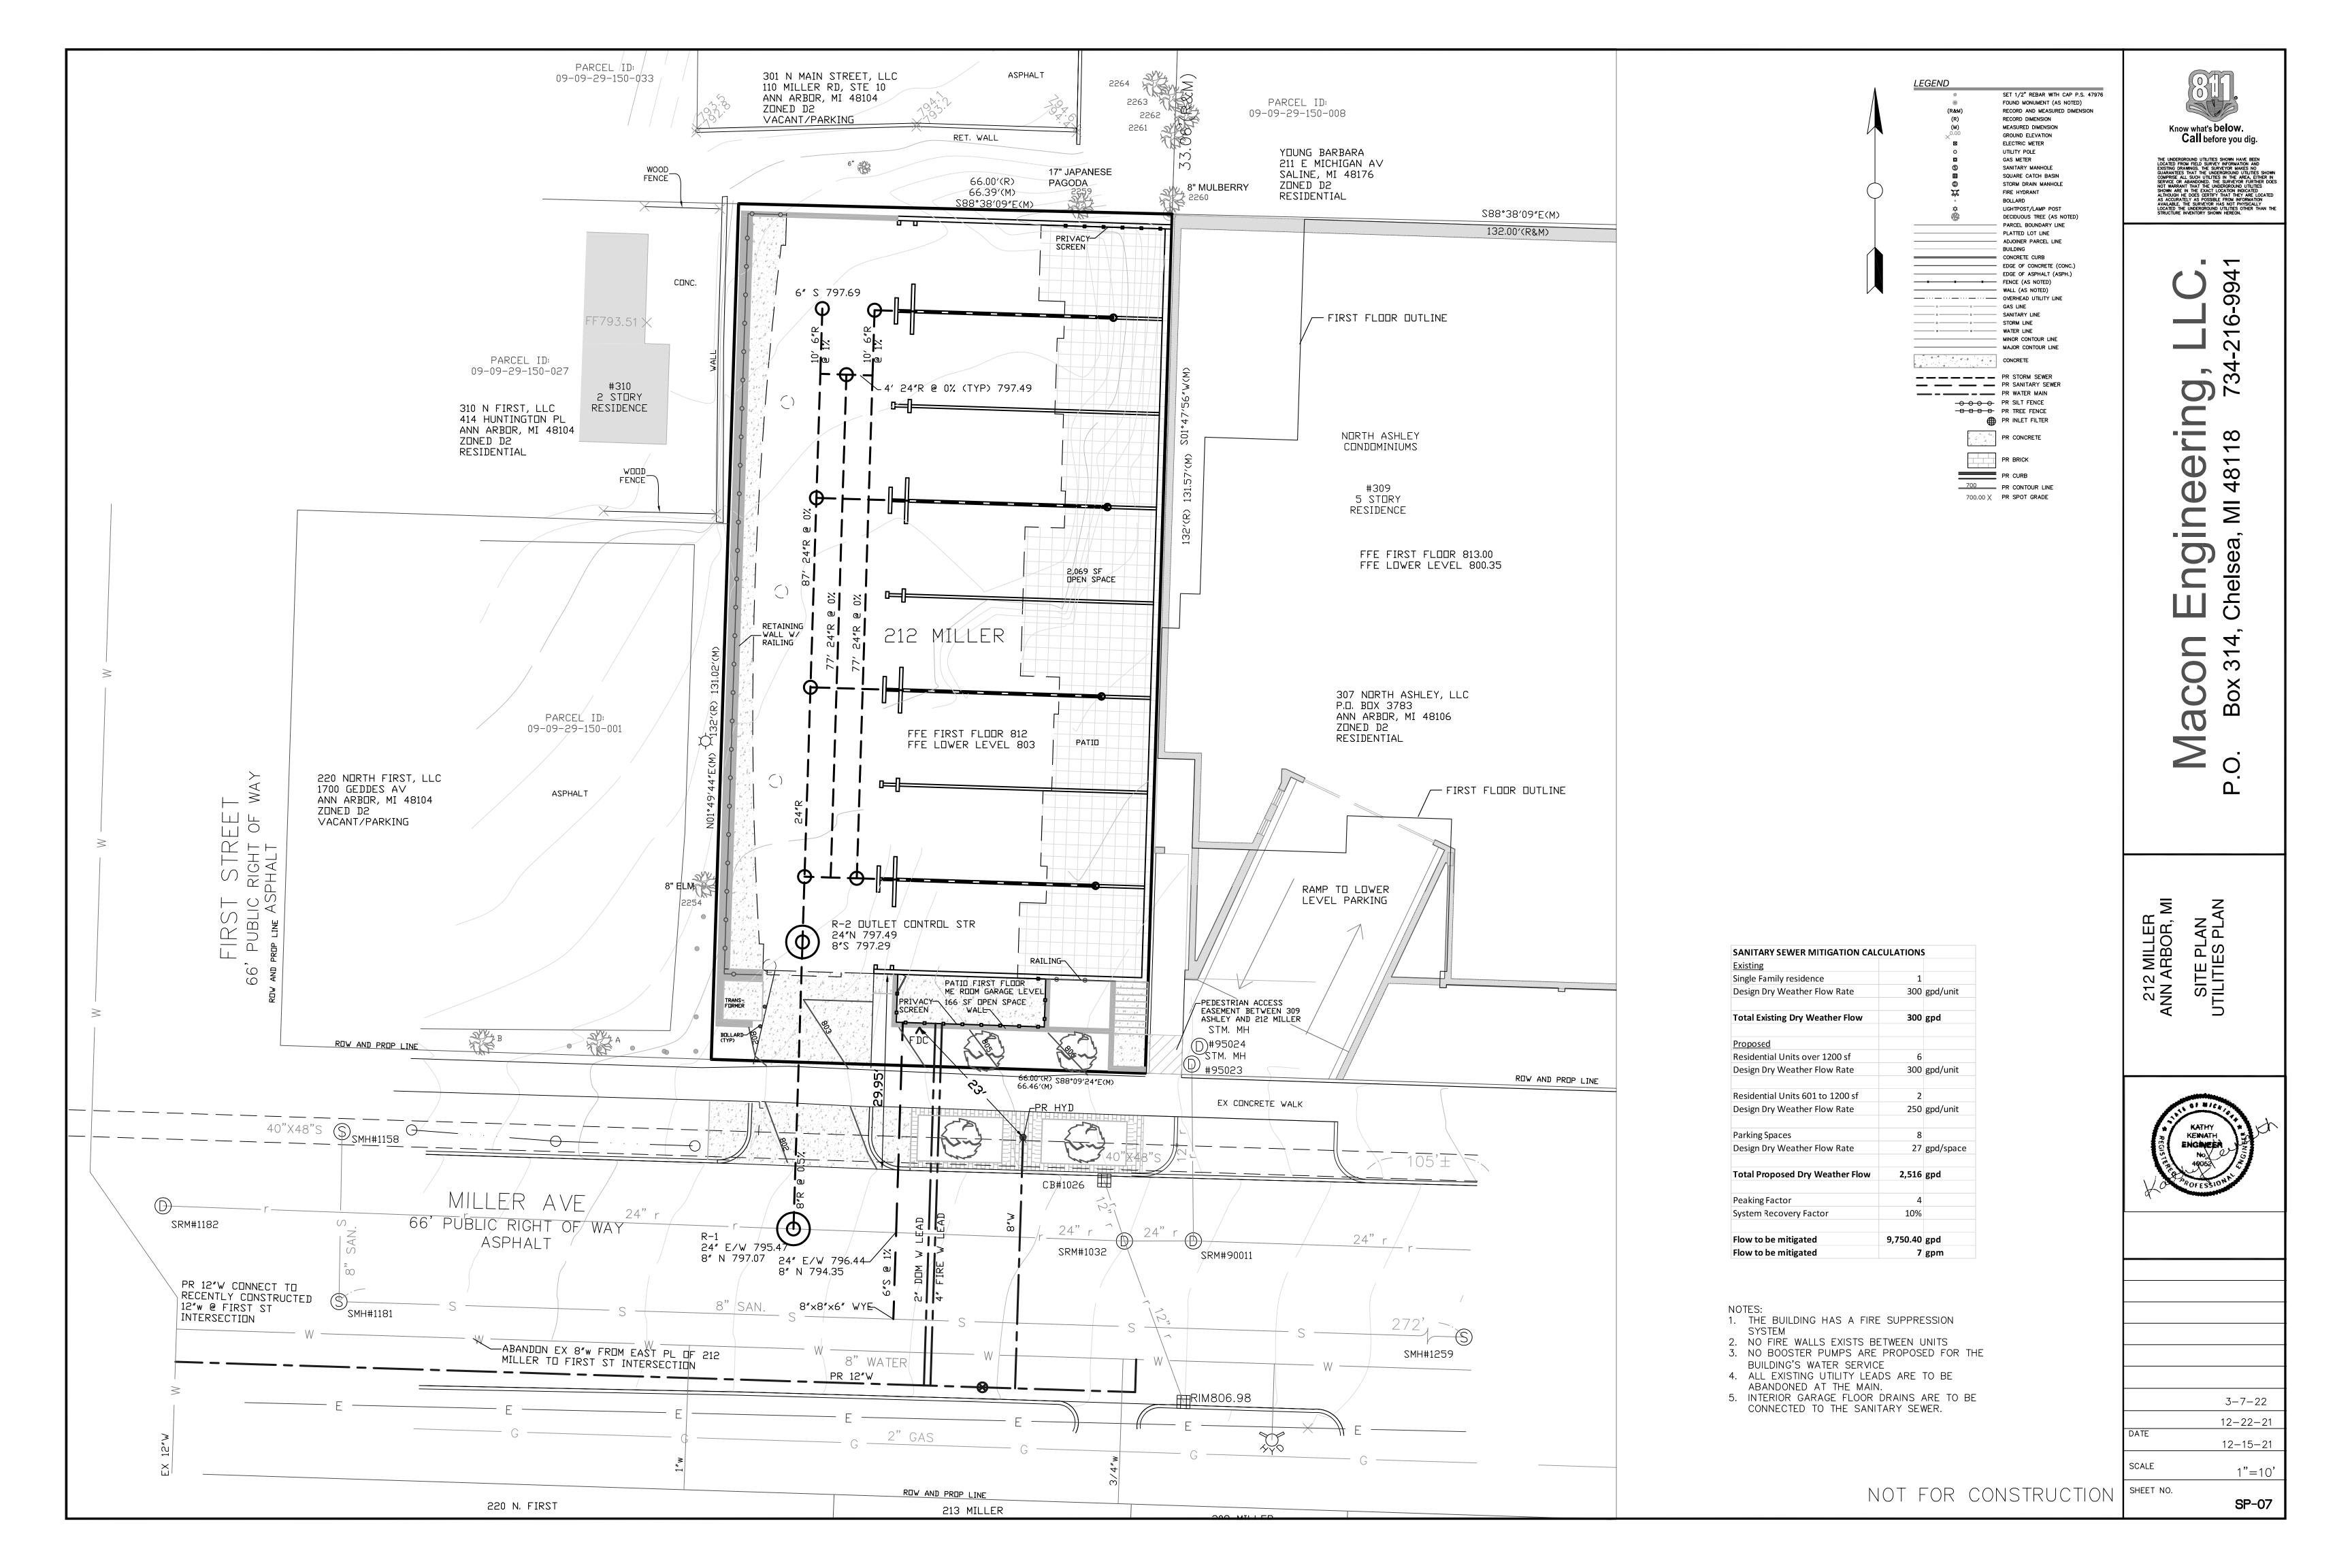
SP-02 1 OF 1 SHEETS

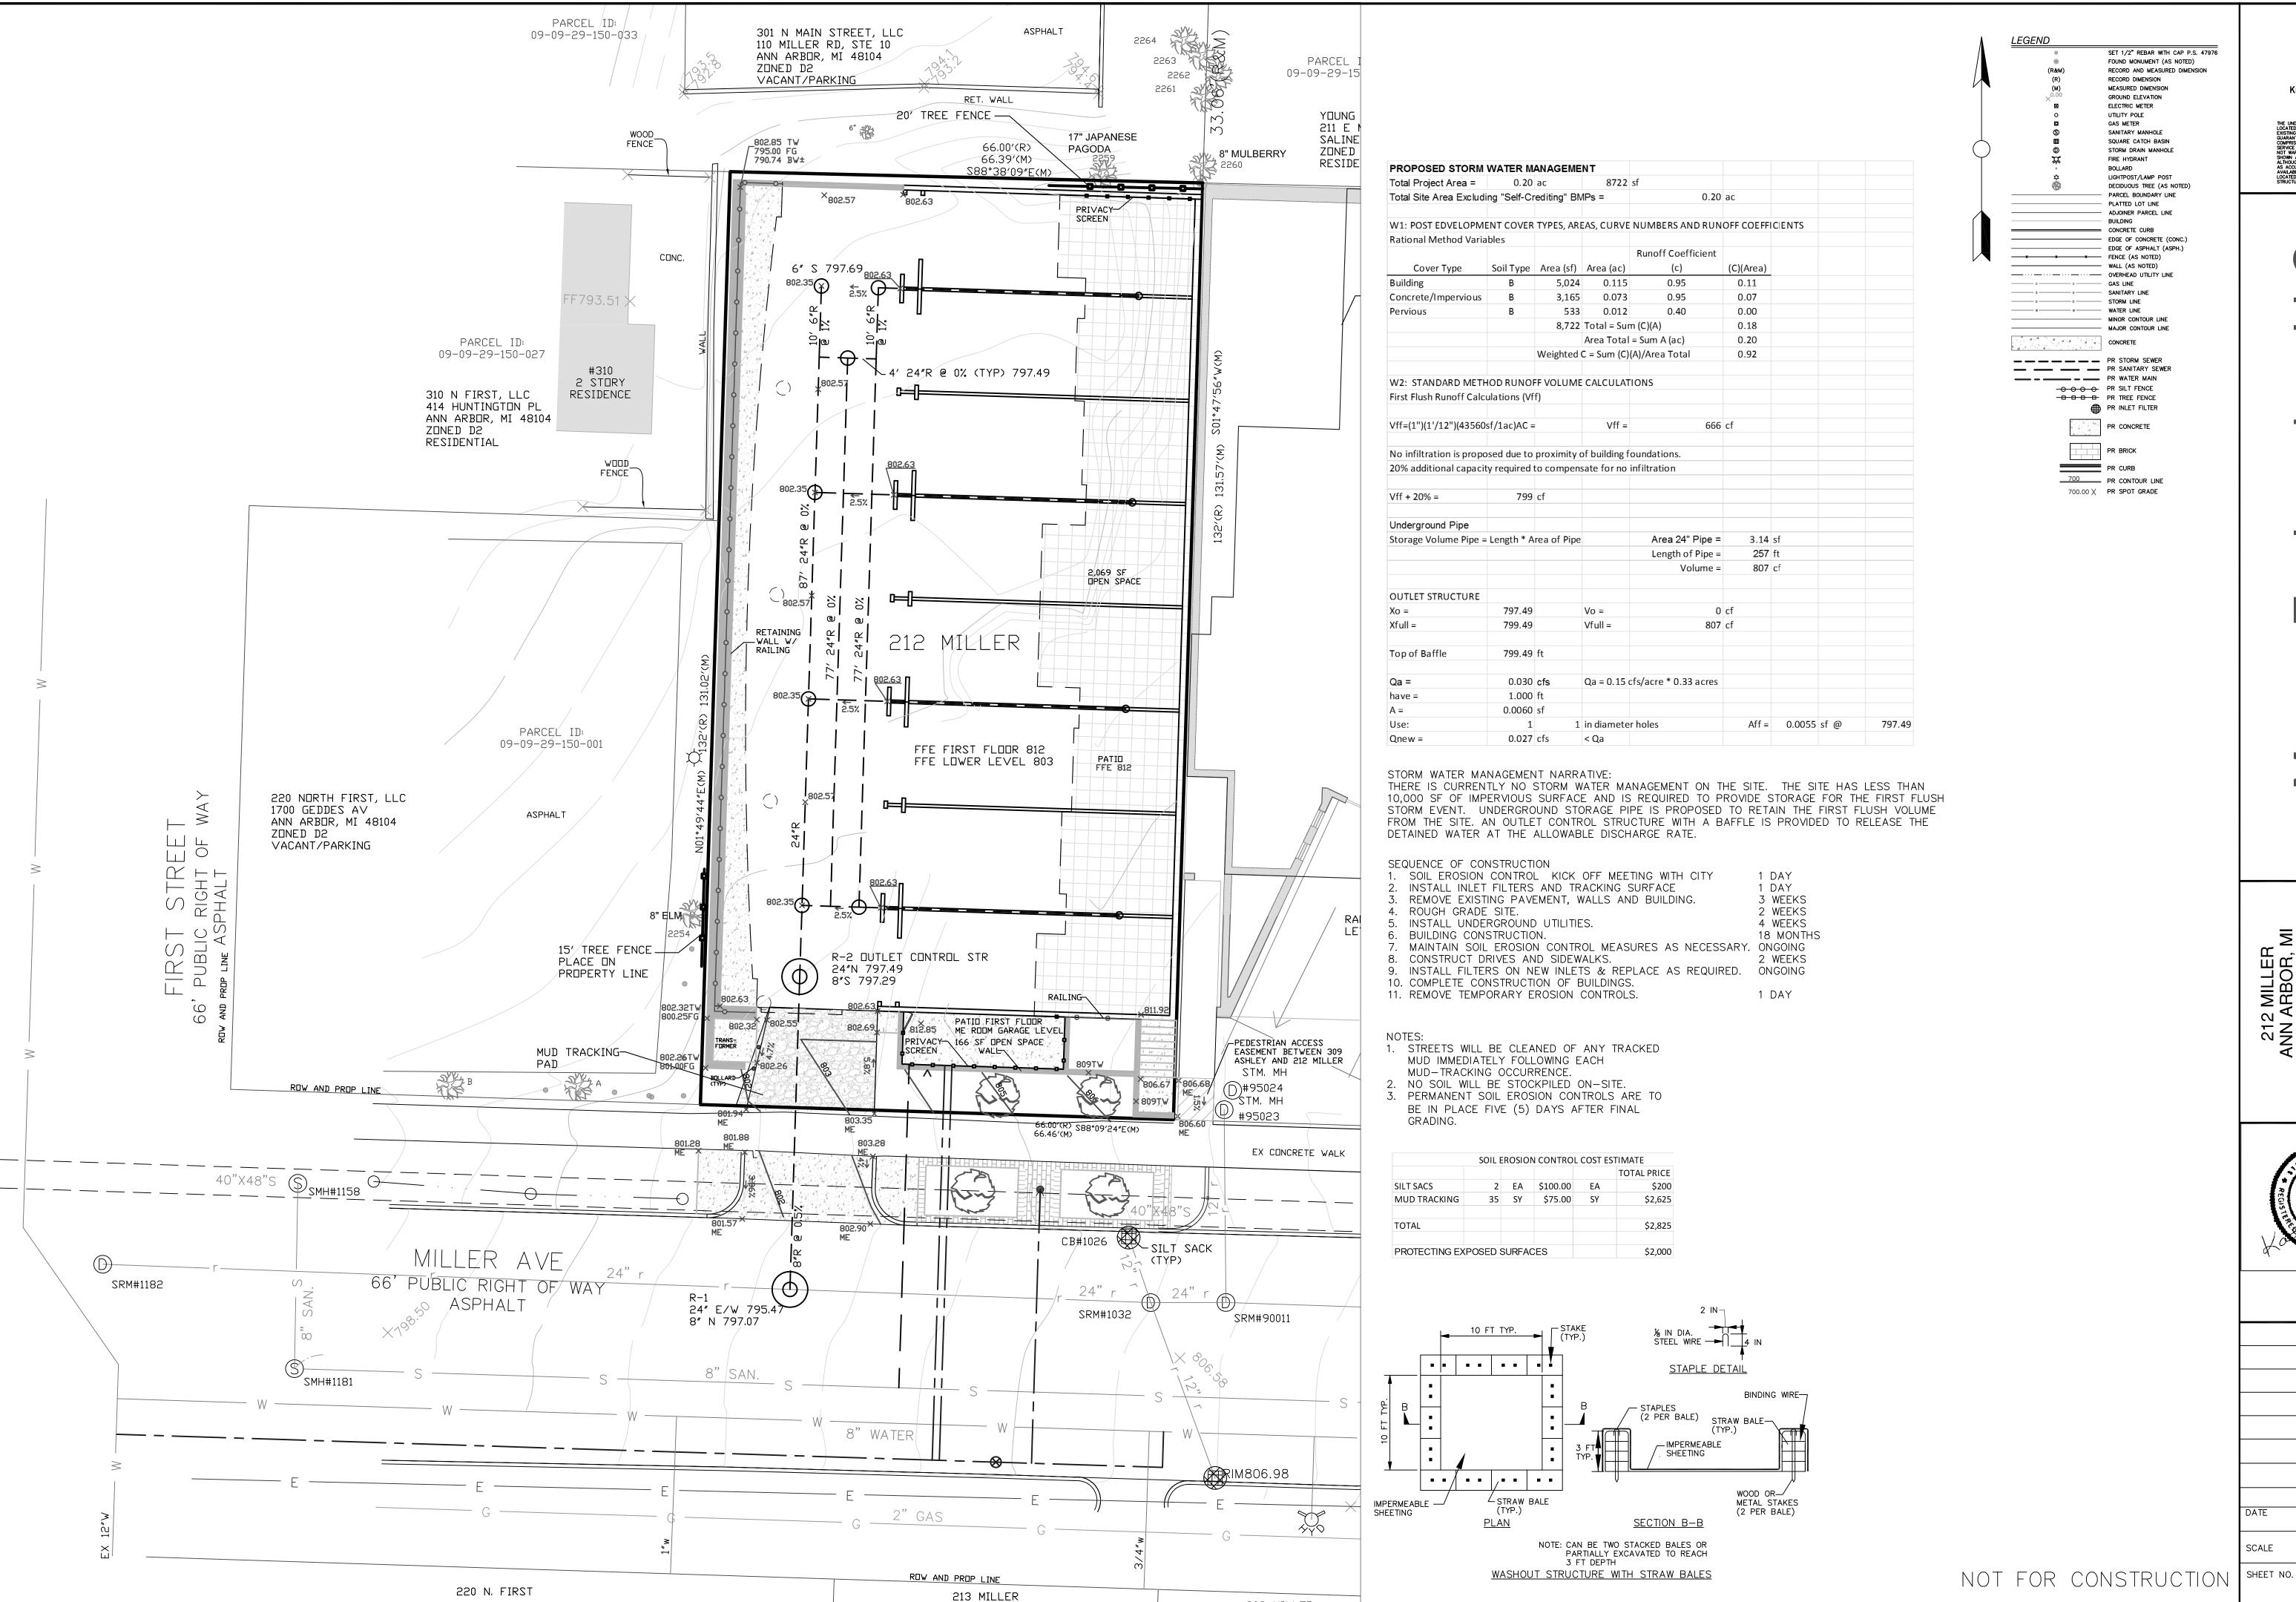













ENGINEER 3-7-22 12-22-21 12-15-21 1"=10'

SP-08

SITE PLAN GRADING, STORM WATER MANAGEMENT AND SOIL EROSION CONTROL

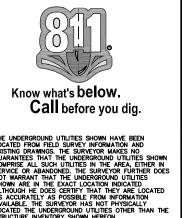 ∞ 4 <u>els</u> Ch 4 3 ŏ




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212 MILLER ANN ARBOR, N

XO




3-7-22 12-22-21 12-15-21 SCALE

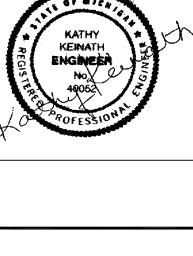SHEET NO.

N.T.S.

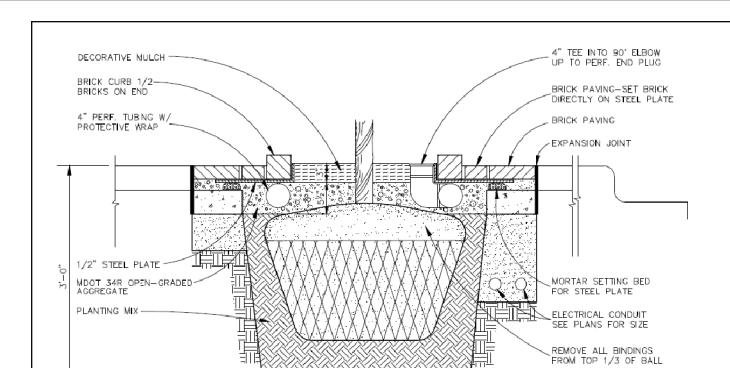SP-09



		PUBLIC SERVICES		TMENT	L BY	
		REVISIONS	REV. NO.	DR.BY C	L BY	
			1			_
	11H	FROM TOP 1/3	OF BALL			
		REMOVE ALL B				
		ELECTRICAL CO SEE PLANS FO				
PLANTING MIX		\\\\\\\\\\\\\\\\\\\\\\\\\\\\\\\\\\\\\\				

MAINTENANCE TASKS AND SCHEDULES DURING CONSTRUCTION

Storm Catch Catch Ditches Outlet

|System|Sumps| Inlet |Swales

Inspect for sediment

Inspect for floatables

Clearing of floatables

Inspection for erosion

Re-establish permanent

vegetation on eroded

Inspect Storm system

Make adjustments or

replacements as
determined by annual X X X
wet weather inspection

components during wet

Remove sediment

accumulation

accumulation

and debris

and debris

slopes

weather

| Sewer | Basin | Basin | & | Structures |

DR. BY NOF CHL BY CSS DRAWING NO.

SCALE NONE DATE 1-31-94

∠ Quarterly

X at turnover

Weekly

As needed & prior

As needed & prior

Quarterly &

to turnover

Annually and

at turnover

As needed

SD-R-12

POLYPROPYLENE BASIN GRATE -DUMP STRAPS **EXPANSION** RESTRAINT (1/4" NYLON OVERFLOW WASHERS INSTALLATION BAG DETAIL TEMPORARY INLET DUMP STRAP _DUMP STRAP SEDIMENT FILTER SILT SACK TEMPORARY INLET SEDIMENT FILTER TO BE INSTALLED ON ALL PAVED CATCH BASINS OR STORM INLETS. INLET FILTER TO BE SIMILAR TO "STREAMGUARD" AS MANUFACTURED BY STORMWATER SERVICES CORPORATION (206-767-0441) OR "SILTSACK" AS MANUFACTURED BY ATLANTIC CONSTRUCTION FABRICS, INC. (800-448-3636). CLEAN FILTER AS NEEDED.



TREE PROTECTION DETAIL

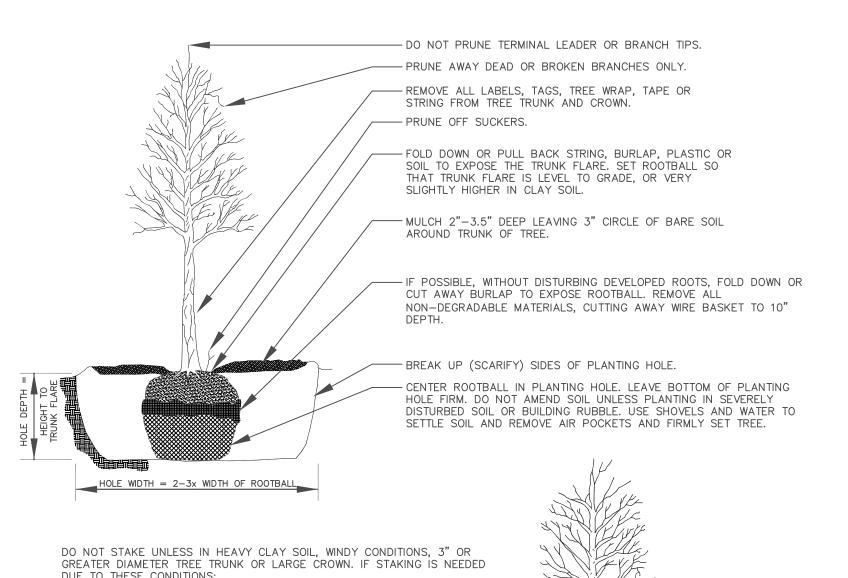
STANDARD 48" HEIGHT

STANDARD

CHAIN LINK

FENCE WITH METAL POST

ELEVATION



TREE PLANTING

• STAKE WITH 2 x 2 HARDWOOD STAKES, OR APPROVED EQUAL,

LOOSELY STAKE TREE TRUNK TO ALLOW FOR TRUNK FLEXING.

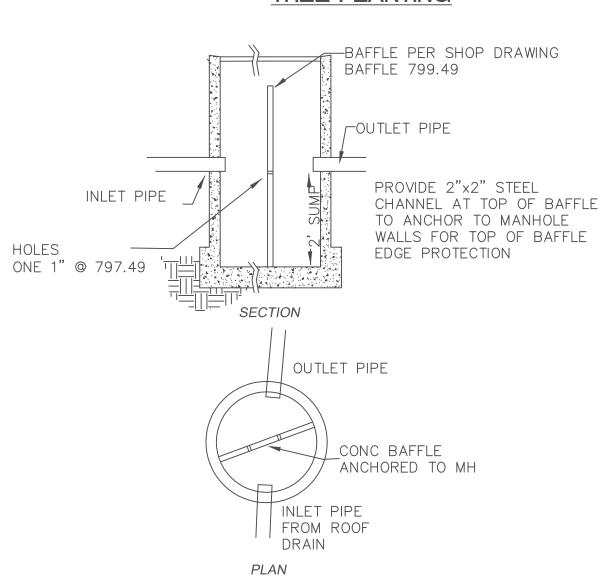
STAKE TREES JUST BELOW FIRST BRANCH WITH 2"-3" WIDE

BELT-LIKE, NYLON OR PLASTIC STRAPS (2 PER TREE ON OPPOSITE SIDES OF TREE, CONNECT FROM TREE TO STAKE HORIZONTALLY. DO

DRIVEN 6"-8" OUTSIDE OF ROOTBALL.

NOT USE ROPE OR WIRE THROUGH A HOSE.)

REMOVE ALL STAKING MATERIALS AFTER 1 YEAR.



CONTRACTOR TO INSTALL & MAINTAIN ANTI-TRACKING PAD. WHEN AGGREGATE BECOMES SATURATED WITH FINES, CONTRACTOR TO SCARIFY AND RELAY AGGREGATE. ANTI-TRACKING PAD DOES NOT RELIEVE CONTRACTOR FROM SWEEPING AND CLEANING ADJACENT WALKS AND ROADS.

5' MINIMUM

. 4

4" CLASS II GRANULAR MATERIAL COMPACTED TO 95% MAX. DENSITY

EXPANSION JOINT

25 FT. MINIMUM 6" MIN. — EXISTING GROUND MUD TRACKING PAD AREA

EROSION CONTROL BLANKETS SHALL BE PLACED ON ALL NEWLY SEEDED AREAS WITH SLOPES OF 1V TO 3H OR STEEPER. THE BLANKETS SHALL BE HIGH VELOCITY EXCELSIOR MULCH BLANKETS OR HIGH VELOCITY STRAW MULCH BLANKETS. NET ANCHORS SHALLBE PLACED AT MINIMUM INTERVALS OF 30 INCHES ALONG ALL JOINTS UNLESS MANUFACTURER'S RECOMMENDATIONS REQUIRE CLOSER SPACING.

___EXISTING GRADE NEW SEED AREA 4" NEW TOPSOIL ROTOTILLED OR SCARIFED SOIL

NEW SEEDED AREA

TASKS	Catch Basin	Ditches &	Overflow Control	Rip-Rap	Filtration Basins	Storm Detention Areas	Wetlands	SCHEDULE
	Inlet Castings		Structures					
Inspect for sediment accumulation	X		X			X		Annually
Removal of sediment accumulation	X		Χ			Χ		Every 2 years as needed
Inspect for floatables and debris	X		X			X		Annually
Clearing of floatables and debris	X		X			Χ		Annually
Inspection for erosion								Annually
Re — establish permanent vegetation on eroded slopes								As needed
Inspect Storm system components during wet weather and compare to as — built plans	X		X			X		Annually
Make adjustments or replacements as determined by annual wet weather inspection	X		X			X		As needed
Keep records of inspections and maintenance activities	X		X			Χ		Annually
			, ,					

_ 1-3/4" SAND/CEMENT (3:1) DRY SETTING BED

----4" CLASS "A" CONCRETE SLAB

___6" CLASS II GRANULAR MATERIAL COMPACTED TO 95% MAX. DENSITY

PUBLIC SERVICES DEPARTMENT

CITY OF ANN ARBOR

DDA BRICK PAVING SECTION DR. BY NOF CHL BY CSS DRAWING NO.

SCALE NONE DATE 1-31-94 SD-R-13

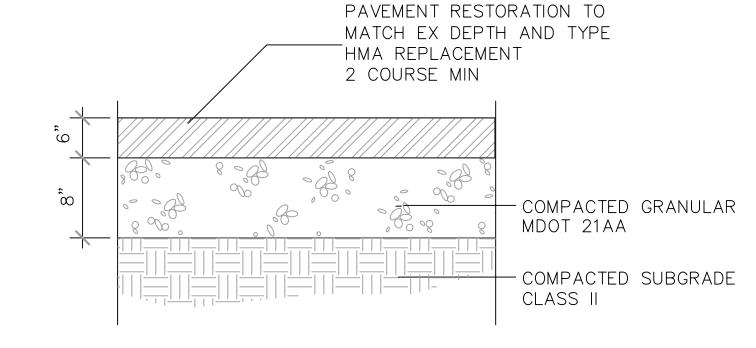
PERMANENT MAINTENANCE TASKS AND SCHEDULE

SHEET NO.


REV. NO. DR.BY CH. BY DATE

---EXPANSION JOINT

REVISIONS



PUBLIC ROAD PAVEMENT

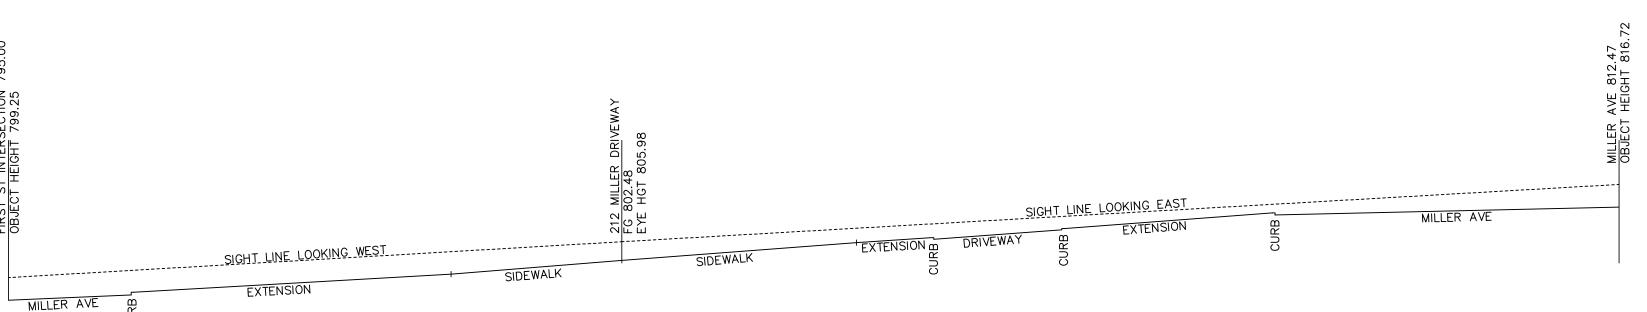


NOT FOR CONSTRUCTION

4' DIAMETER OUTLET STRUCTURE

#4 BARS

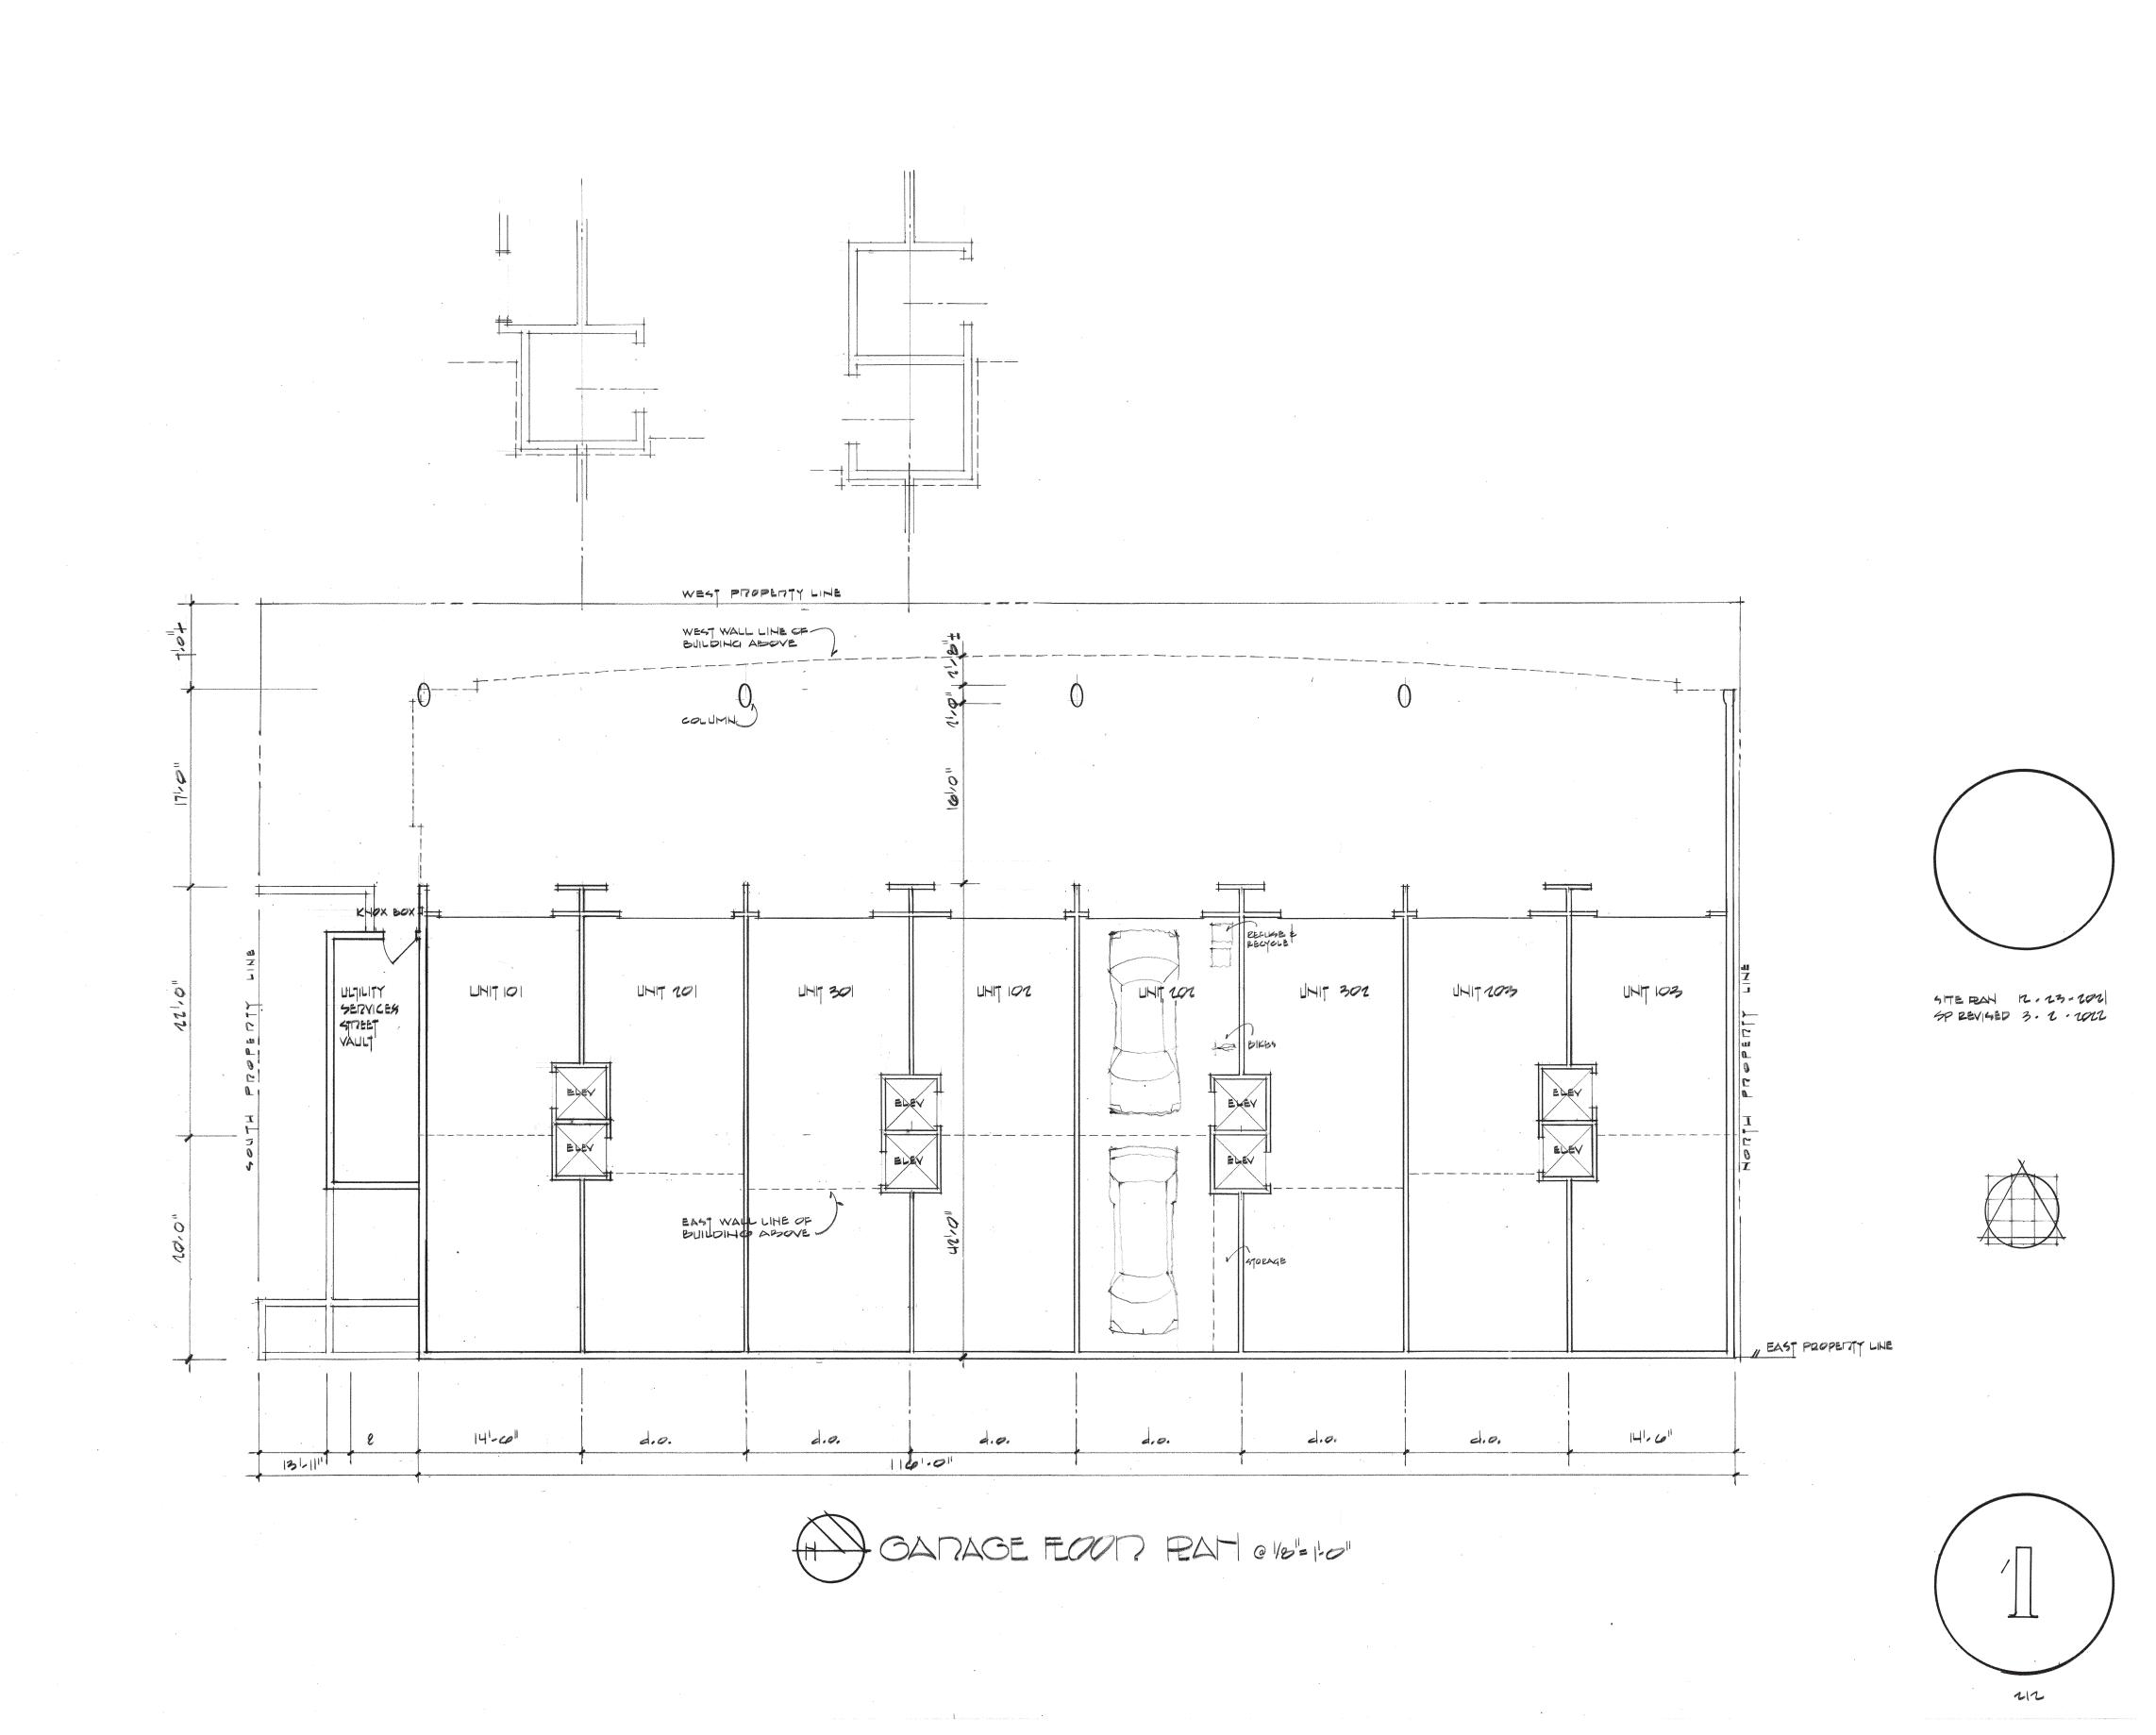BARRIER CURB '-0" LAP ON BARS


SITE LINE PROFILE




FIRE SAFETY SPECIFIC SITE PLAN COMPLIANCE ITEMS

- Knox Box added at exterior entry to Utility Services Vault to fire water service entry.
 Building Construction Type to be upgraded to 5A.
 Building to be protected with a compliant NFPA 13 fire suppression system.
 North Building wall plane one foot off property line to be upgraded to a "Fire Wall"
- classification with a 2 hour fire rated assembly.

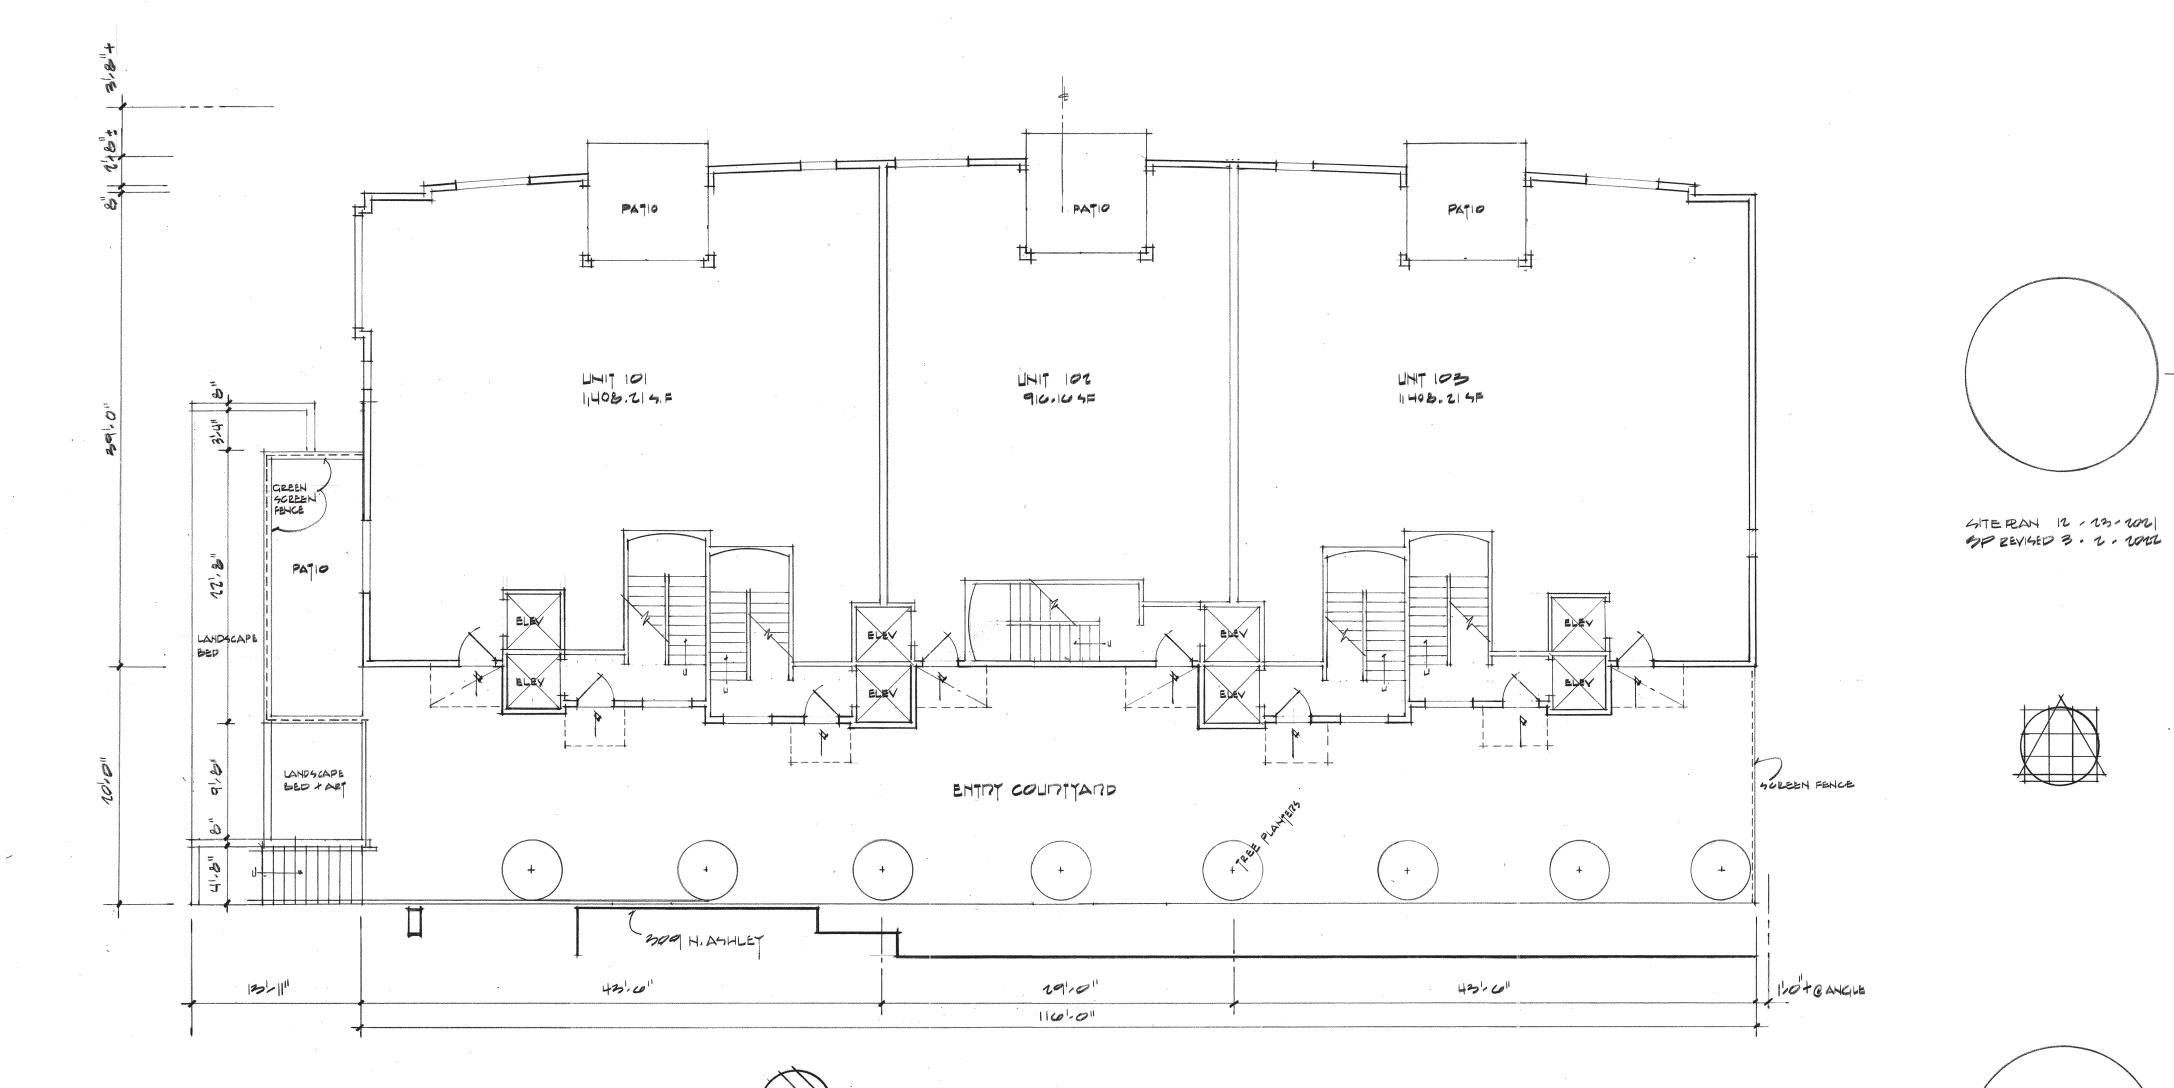
 5. North Building wall plane to have no operable openings. Opening shown to be 90 minute rated solid glass block assemblies.



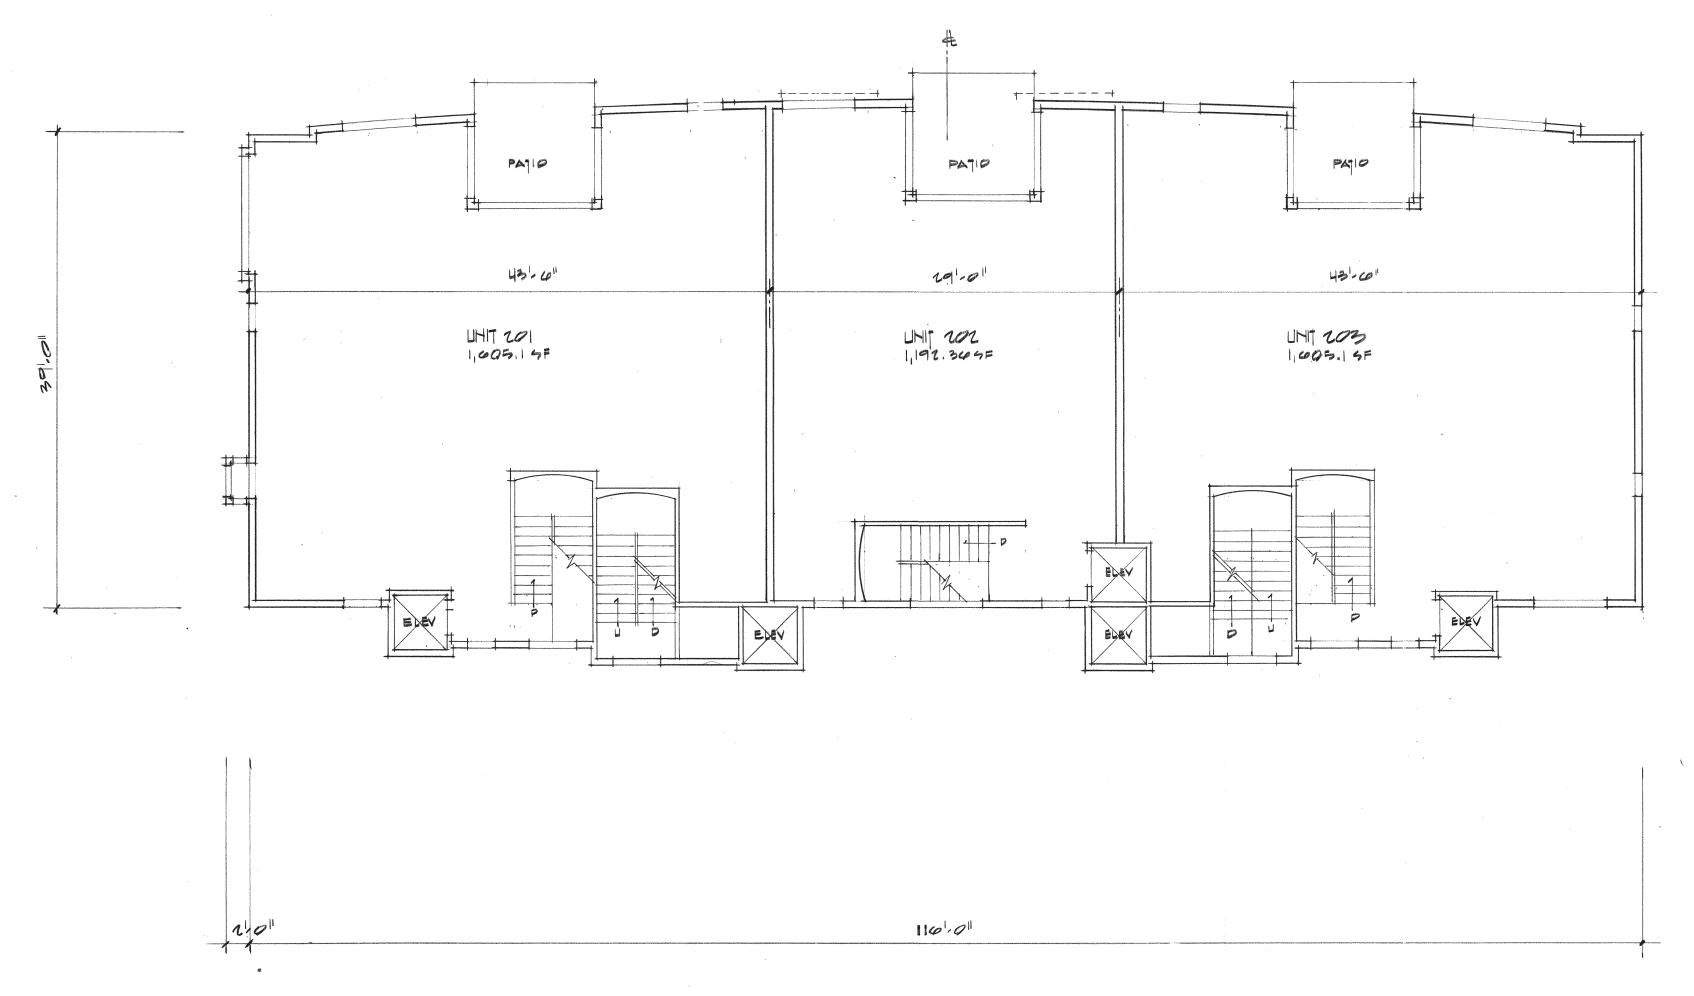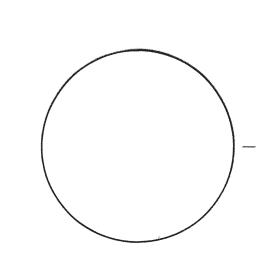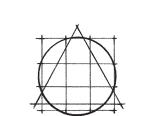
FLOOD AREAS EXCLUDE ELEVATOR, STAIR & PATIO AREAS

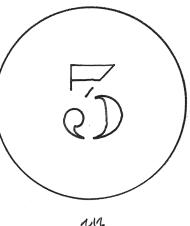


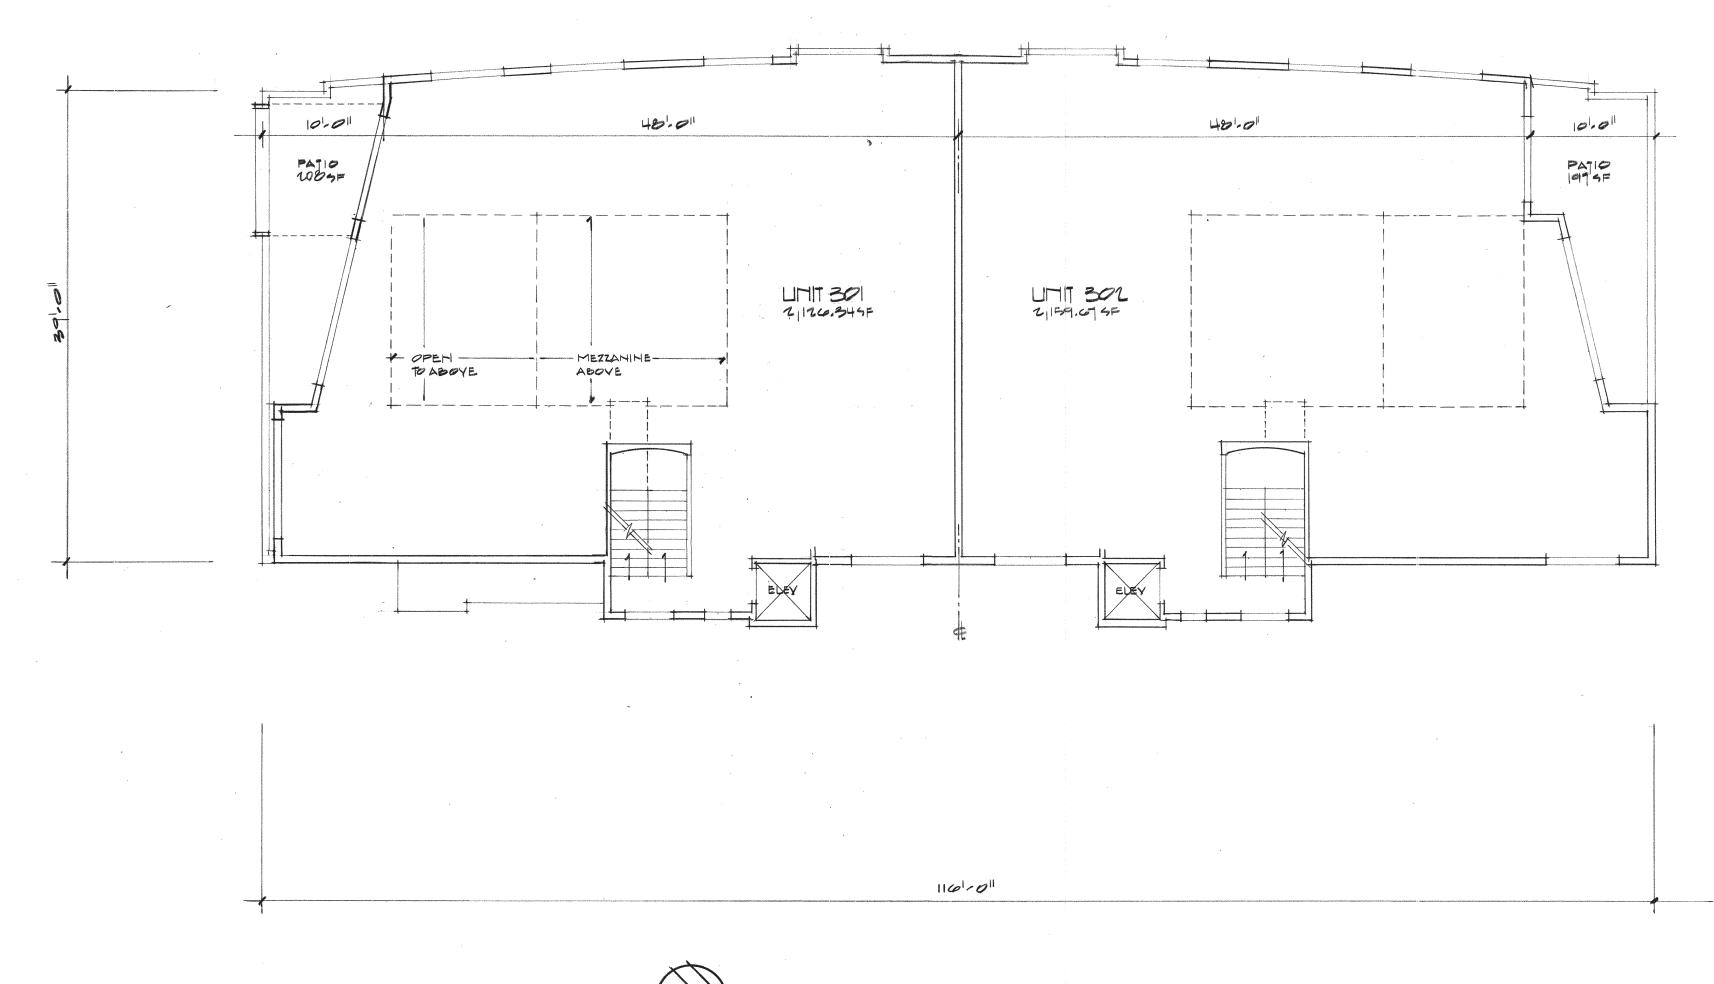


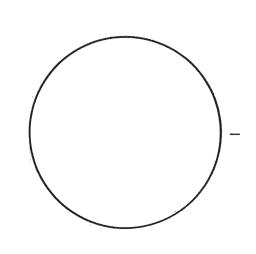




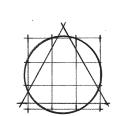


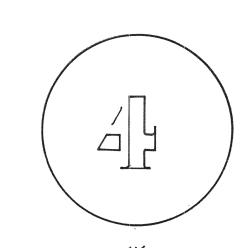


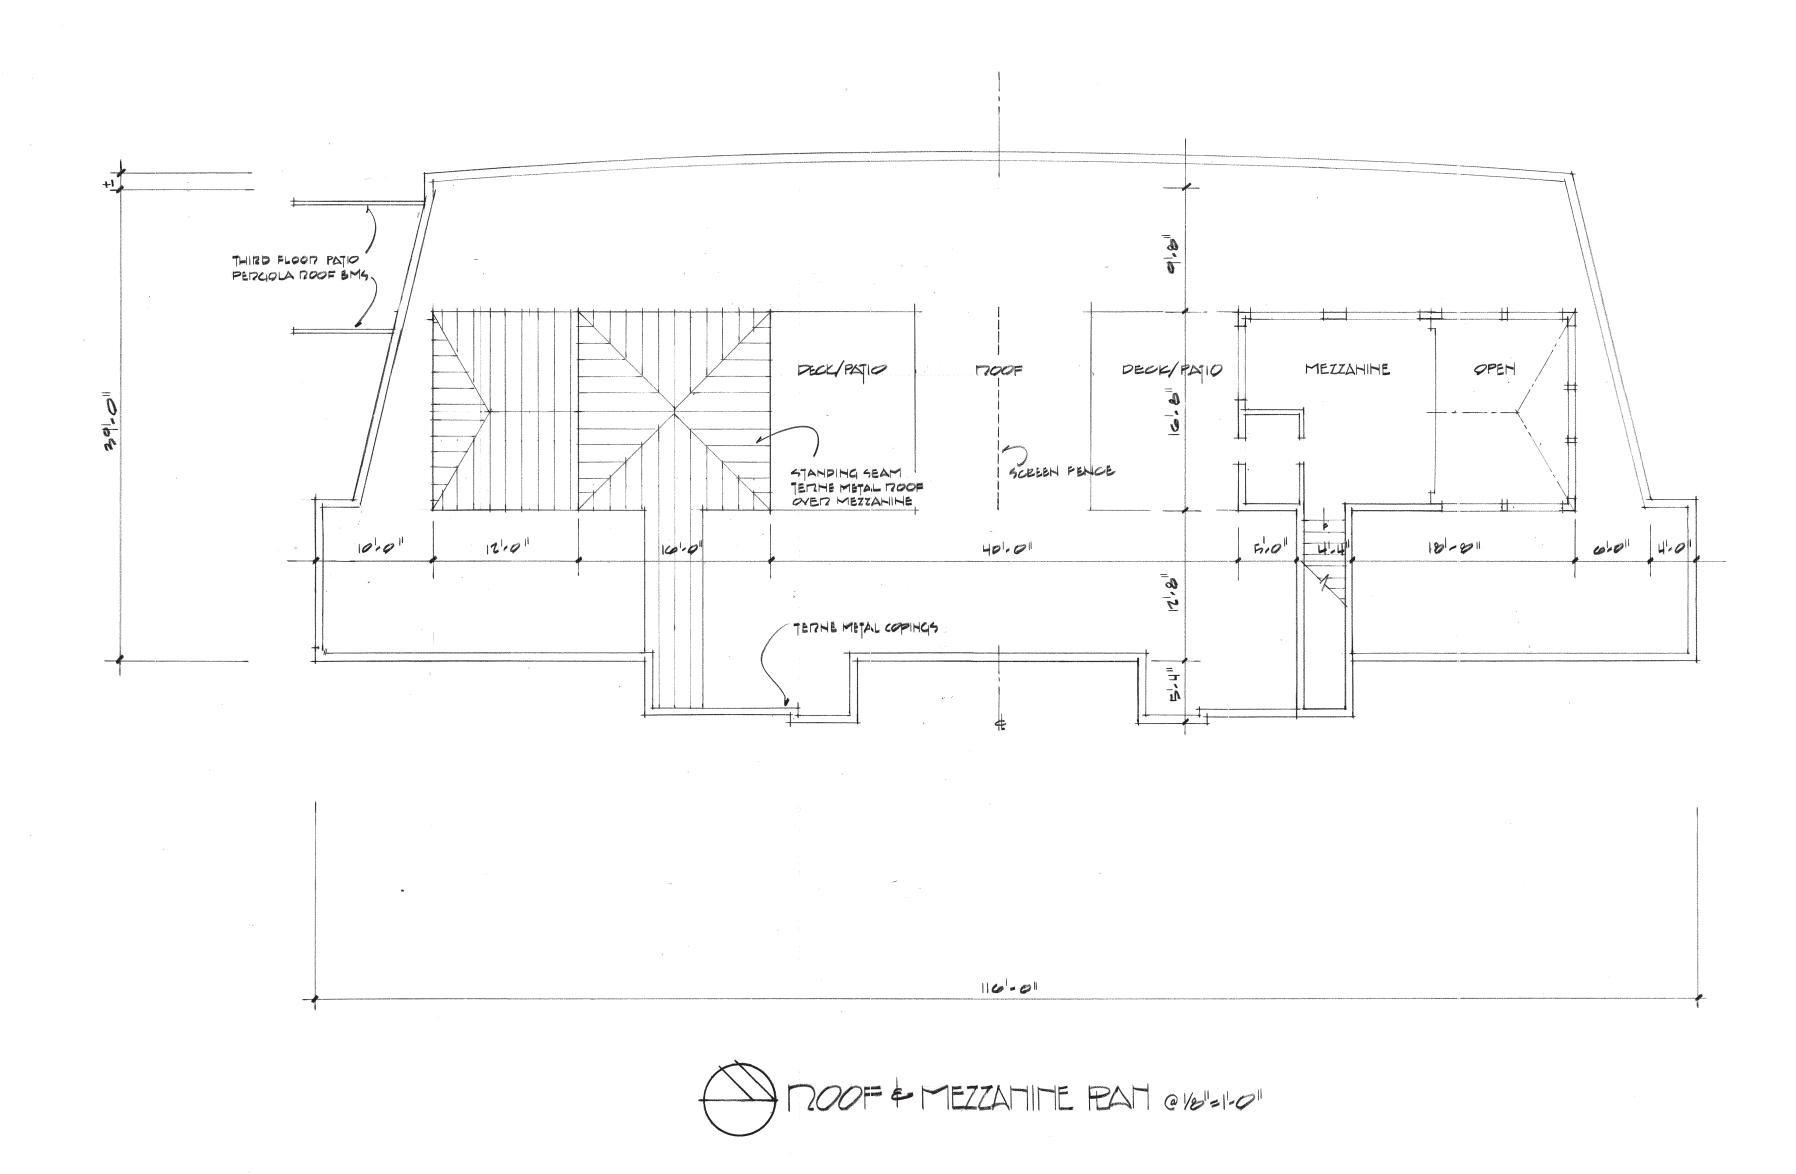


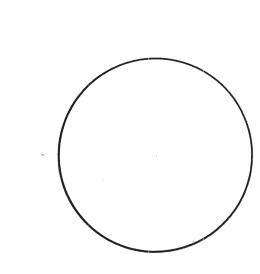


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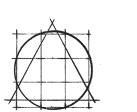








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MASSING & ARCHITECTURAL DESIGN DESCRIPTIVE

PROPOSED BUILDING IS A SMALLER SCALE SINGLE MASS STRUCTURE CONTAINING 8 DWELLING UNITS ON THREE FLOORS OF APPROXIMATELY 4,650 SQUARE FOOT EACH WITH A LOWER LEVEL/BASEMENT PARKING GARAGE FOR EACH UNIT WITH SPACE TO PARK TWO VEHICLES PER UNIT.

THE SOUTH FACING FRONT ELEVATION IS BROKEN UP BY MATERIALS SELECTION MAINLY OF RUSTICATED WHITE MASONRY, THE THIRD FLOOR STREETWALL OFFSET, THE PROJECTED ARCHITECTURAL ELEMENTS AND THE MAIN MASS CANTILEVERED OUT OVER THE DRIVE ENTRY VOID TO THE LOWER LEVEL GARAGES. IN FRONT OF THIS PLANE IS A GREEN-SCAPED PLANTED PATIO SCENE FENCE AND THE STEPPED LANDSCAPE SAND BLASTED CONCRETE WALLED PLANTING BEDS. TO THE RIGHT IS THE LARGER VOID CREATED BY THE LANDSCAPED ENTRY COURTYARD SPACE.

THE EAST SIDE IS BROKEN UP WITH THE ARTICULATED VERTICAL CIRCULATION ELEVATOR AND STAIR TOWERS CLAD IN WHITE NICHIHA PANELS SET OUT FROM THE MAIN BUILDING MASS WALL CLAD IN A RUSTICATED WHITE MASONRY. THE UNIT PEDESTRIAN ENTRIES ARE ON THIS SIDE AND ACCENTUATED WITH STANDING SEAMED COPPER ROOFS AND ORNAMENTAL LIGHT FIXTURES. THIS SIDE ALSO FEATURES THE 20 FOOT WIDE LANDSCAPED COURTYARD, SETTING THIS BUILDING AWAY FROM THE MUCH LARGER 309 NORTH AHSLEY BUILDING NOW UNDER CONSTRUCTION. PLANTINGS ARE SELECTED FOR ZONE 5 ENVIRONMENT COMPATIBLE FOR PLANTINGS IN THE NOTED LARGE ARCHITECTURAL PLANTERS.

THE REAR NORTH FACING ELEVATION IS ONLY ONE FOOT OFF THE PROPERTY LINE AND THEREFORE IS IMPACTED IN FIRE RATING COMPLIANCE, SO THE WINDOWS ARE GLASS BLOCK JEWELS SET INTO A SIMPLE STATED ELEVATION CONSISTING OF SOLID PLANES OF THE RUSTICATED WHITE MASONRY AND SAND BLASTED CONCRETE FOUNDATION WALLS, LANDSCAPE SCREEN FENCE AND WITH RELIEF COMING IN A THIRD FLOOR RECESSED OFFSET PATIO AREA.

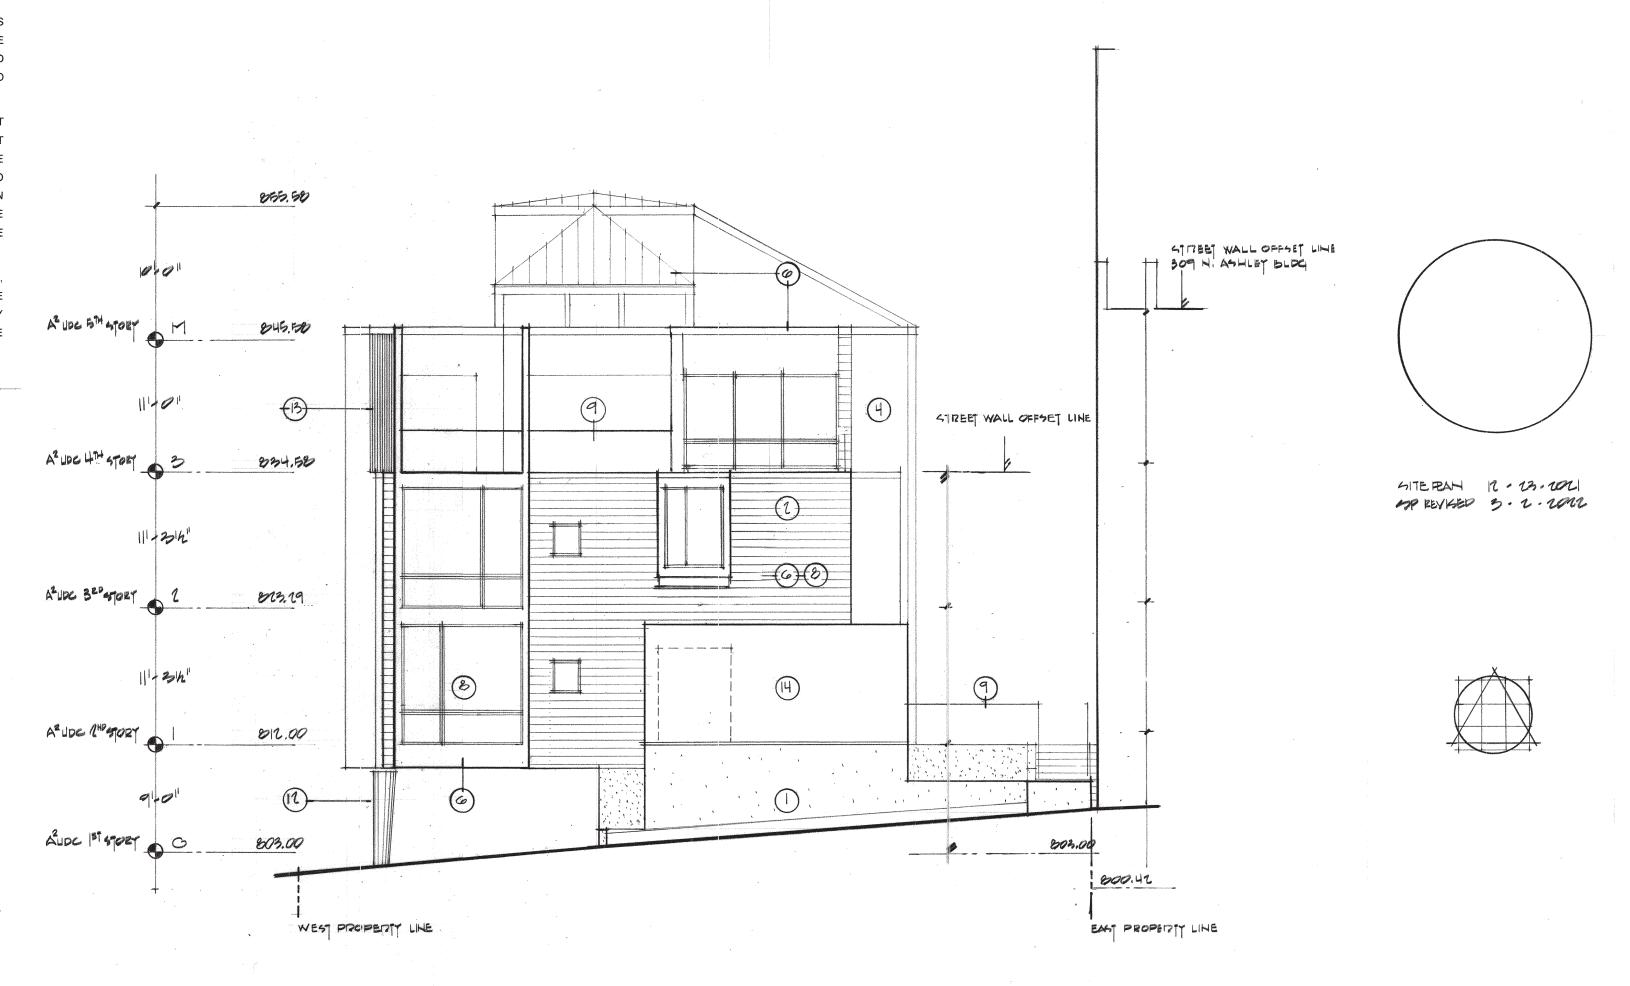
THE WEST FACING SIDE ELEVATION IS CURVED TO ECHO THE ANN ARBOR RAILROAD EASEMENT JUST WEST OF THE SITE. THIS CURVE ALSO SOFTENS THIS LARGE BUILDING PLANE TO THE VIEW OF THE WEST APPROACHING PUBLIC COMING DOWN MILLER. THIS ELEVATION IS ACCENTUATED WITH THE PLAY OF THE VARIOUS SIZED WINDOWS, PROJECTING AND RECESSED UNIT BALCONIES AND BAYS, ALONG WITH THE VOID SETUP ON SCULPTED COLUMNS OF THE RECESSED LOWER LEVEL PARKING GARAGE ENTRIES. THE MAIN WALL PORTION IS CLAD IN SILVER GRAY NICHIHA PANELS WHICH PRESENTS A NON-UNIFORM APPEARANCE DUE TO THE WALL'S CURVED SURFACE. THIS IS BOOKEND BY THE AFOREMENTIONED MASONRY AT THE NORTH AND SOUTH ENDS.

THE BUILDING ROOF HAS TWO MEZZANINE/CLERESTORY STRUCTURES OPEN TO THE THIRD FLOOR UNITS, WHICH ARE SETBACK FROM THE MAIN BUILDING MASS ROOF EDGES, AND CLAD IN THE SOFT GRAY TERNE COATED STAINLESS METAL. THIS SAME TERNE METAL IS USED FOR THE ROOF COPINGS AND PROJECTED BAY WINDOW ELEMENTS. THE OVERALL BUILDING IS PURPOSELY LIGHT TONED IN VARIOUS SHADES OF WHITE AND LIGHTER GRAYS.

EXTERIOR BUILDING COMPONENTS KEY

- 1. SAND BLASTED EXPOSED NATURAL CONCRETE
- 2. RUSTICATED WHITE UNIT MASONRY
- NICHIHA ARCHITECTURAL WALL PANEL SYSTEM: SILVER GRAY
- NICHIHA ARCHITECTURAL WALL PANEL SYSTEM: OPAL WHITE
- NICHIHA ARCHITECTURAL WALL PANEL SYSTEM: GRAPHITE
- TERNE COATED STAINLESS STEEL: SOFT GRAY

 STANDING SEAMED COPPER ENTRY ROOFS: WEATHERED
- BLACK FRAMED INSULATED GLASS WINDOWS
- POWDERED COATED STEEL GUARDRAILS
- 10. INSULATED GLAZED ENTRY DOOR: GRAPHITE
- 11. INSULATED OVERHEAD GARAGE DOOR: GRAPHITE
- 12. COMPOSITE COLUMN SURROUND: GRAY
- 13. WOOD PRIVACY FENCE STRUCTURE: TO WEATHER NATURAL GRAY
- 14. GREEN ECO LIVING LANDSCAPED PRIVACY FENCE STRUCTURE: IVY GREEN
- 15. GLASS BLOCK WINDOW" CLEAR GLASS
- 16. UNIT MASONRY RETAINING WALL SYSTEM: EARTHTONED



SOUTH BUILDING ELEVATION @16"=1"0"



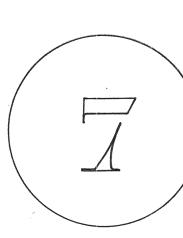
SOUTH DEMDERED ELEVATION





16. UNIT MASONRY RETAINING WALL SYSTEM: EARTHTONED














EXTERIOR BUILDING COMPONENTS KEY

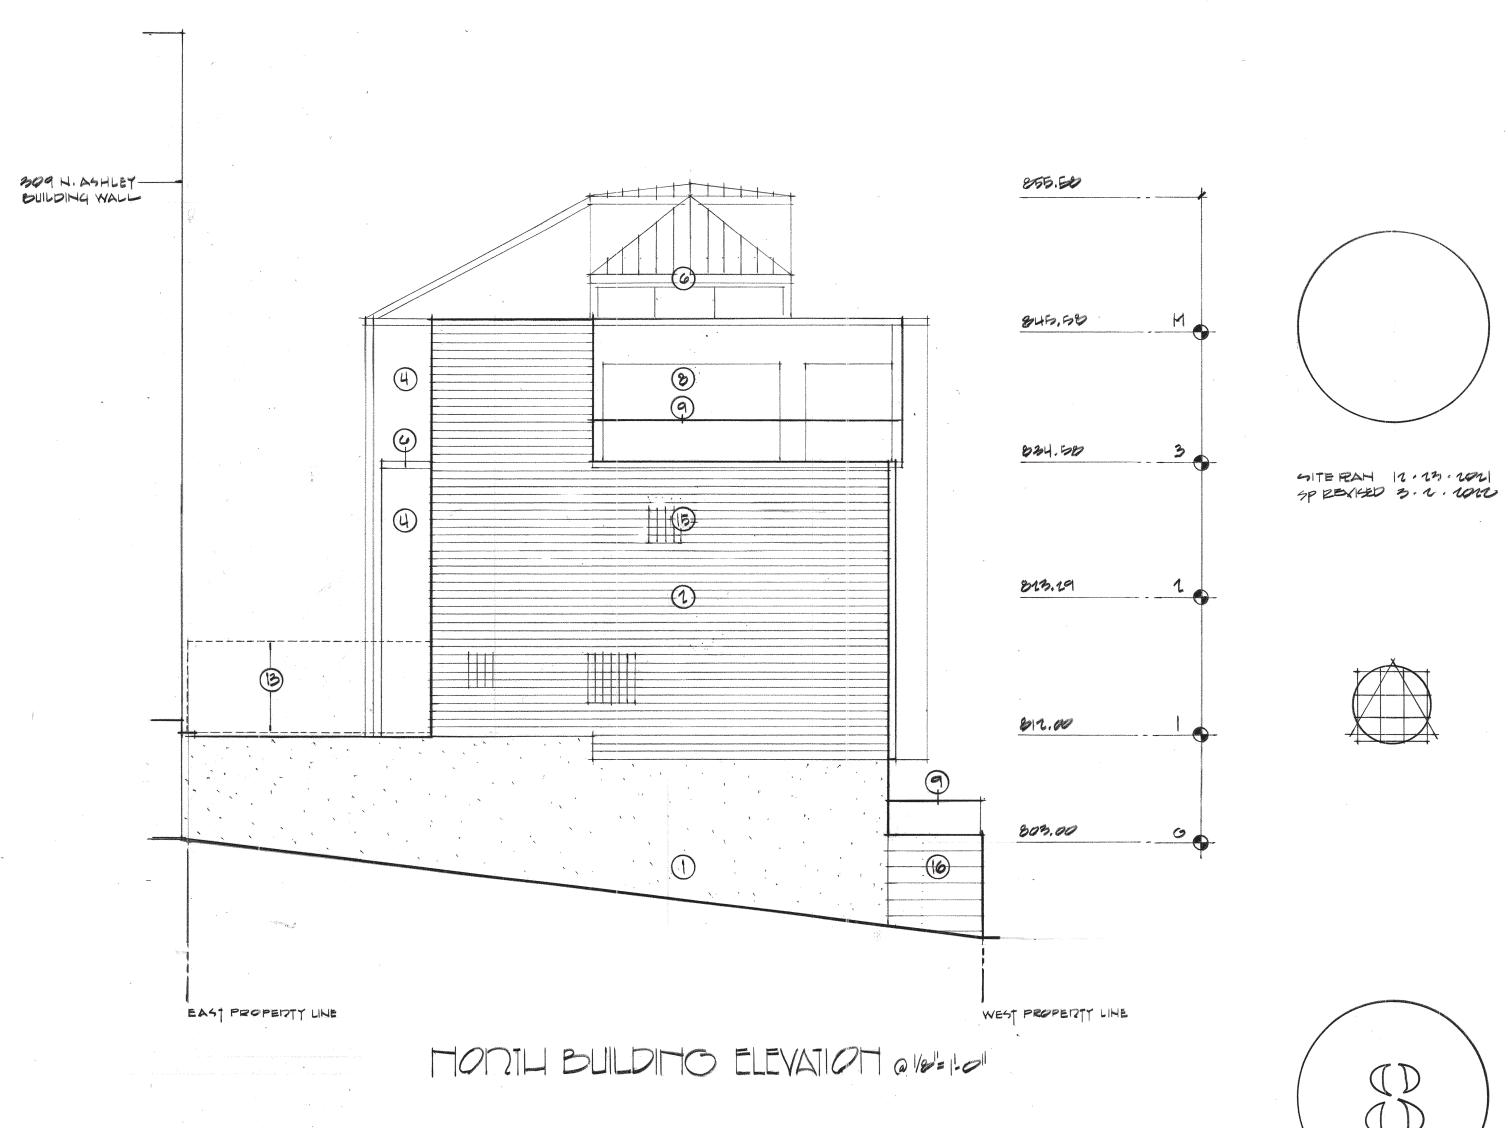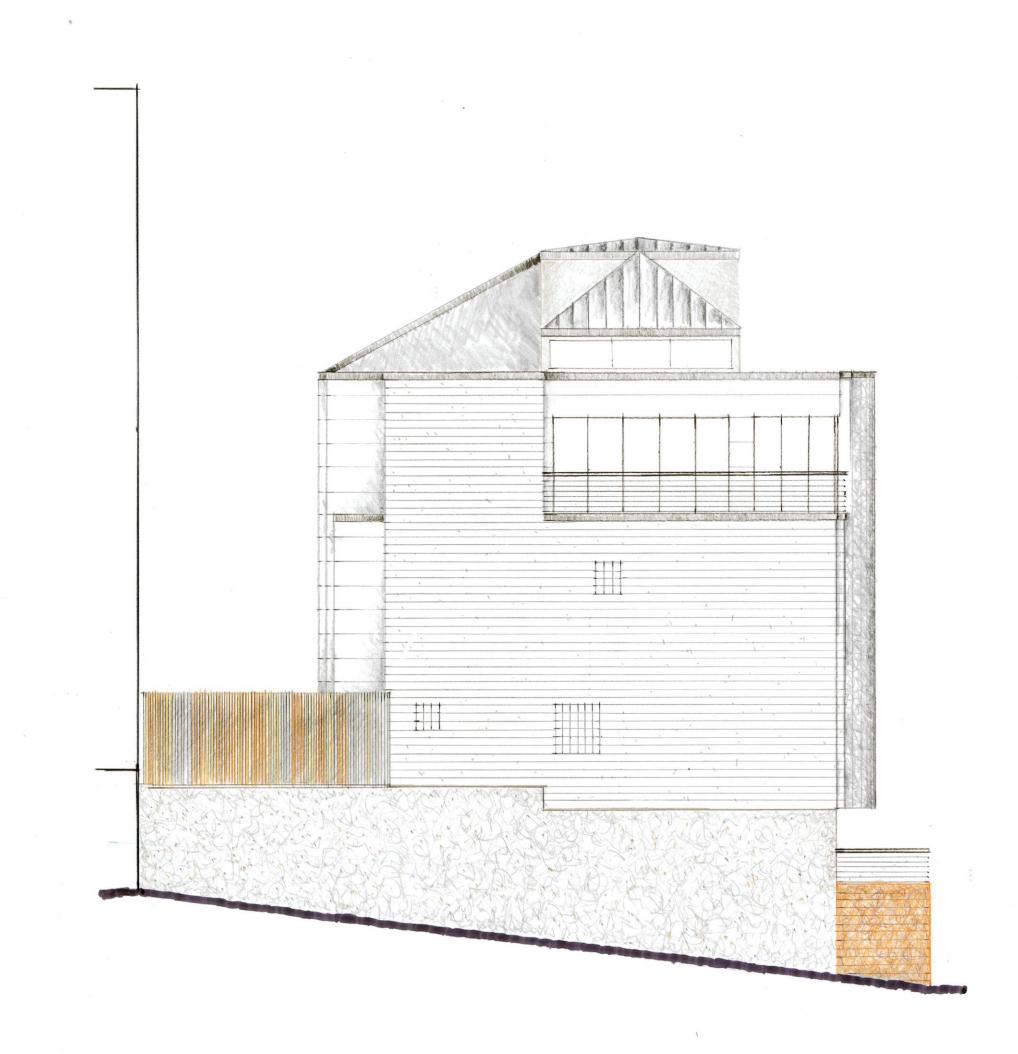- 1. SAND BLASTED EXPOSED NATURAL CONCRETE
- 2. RUSTICATED WHITE UNIT MASONRY
- 3. NICHIHA ARCHITECTURAL WALLPANEL SYSTEM: SILVER GREY
- 4. NICHIHA ARCHITECTECTURAL WALL PANEL SYSTEM: OPAL WHITE
- 5. NICHIHA ARCHITECTURAL WALL PANEL SYSTEM: GRAPHITE
- TERNE COATED STAINLESS STEEL: SOFT GREY
 STANDING SEAM COPPER ENTRY ROOF: WEATHERED
- 8. BLACK FRAMED INSULATED GLASS WINDOWS
- 8. BLACK FRAINED INSOLATED GLASS WINDOWS
- 9. POWDER COATED STEEL GUARD RAILS & BALUSTERS
- 10. INSULATED GLAZED ENTRY DOOR: GRAPHITE
- INSULATED OVERHEAD GARAGE DOOR: GRAPHITE
 COMPOSITE COLUMN SURROUND: GREY
- 13. WOOD PRIVACY FENCE STRUCTURE: WEATHERED GREY
- 14. GREEN ECO LIVING LANDSCAPED PRIVACY FENCE STRUCTURE: IVY GREEN
- 15. GLASS BLOCK WINDOW CLEAR GLASS
- 16. UNIT MASONRY RETAINING WALL SYSTEM: EARTHTONED






MONTH NEMDENED ELEVATION

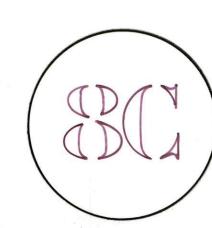


EXTERIOR BUILDING COMPONENTS KEY

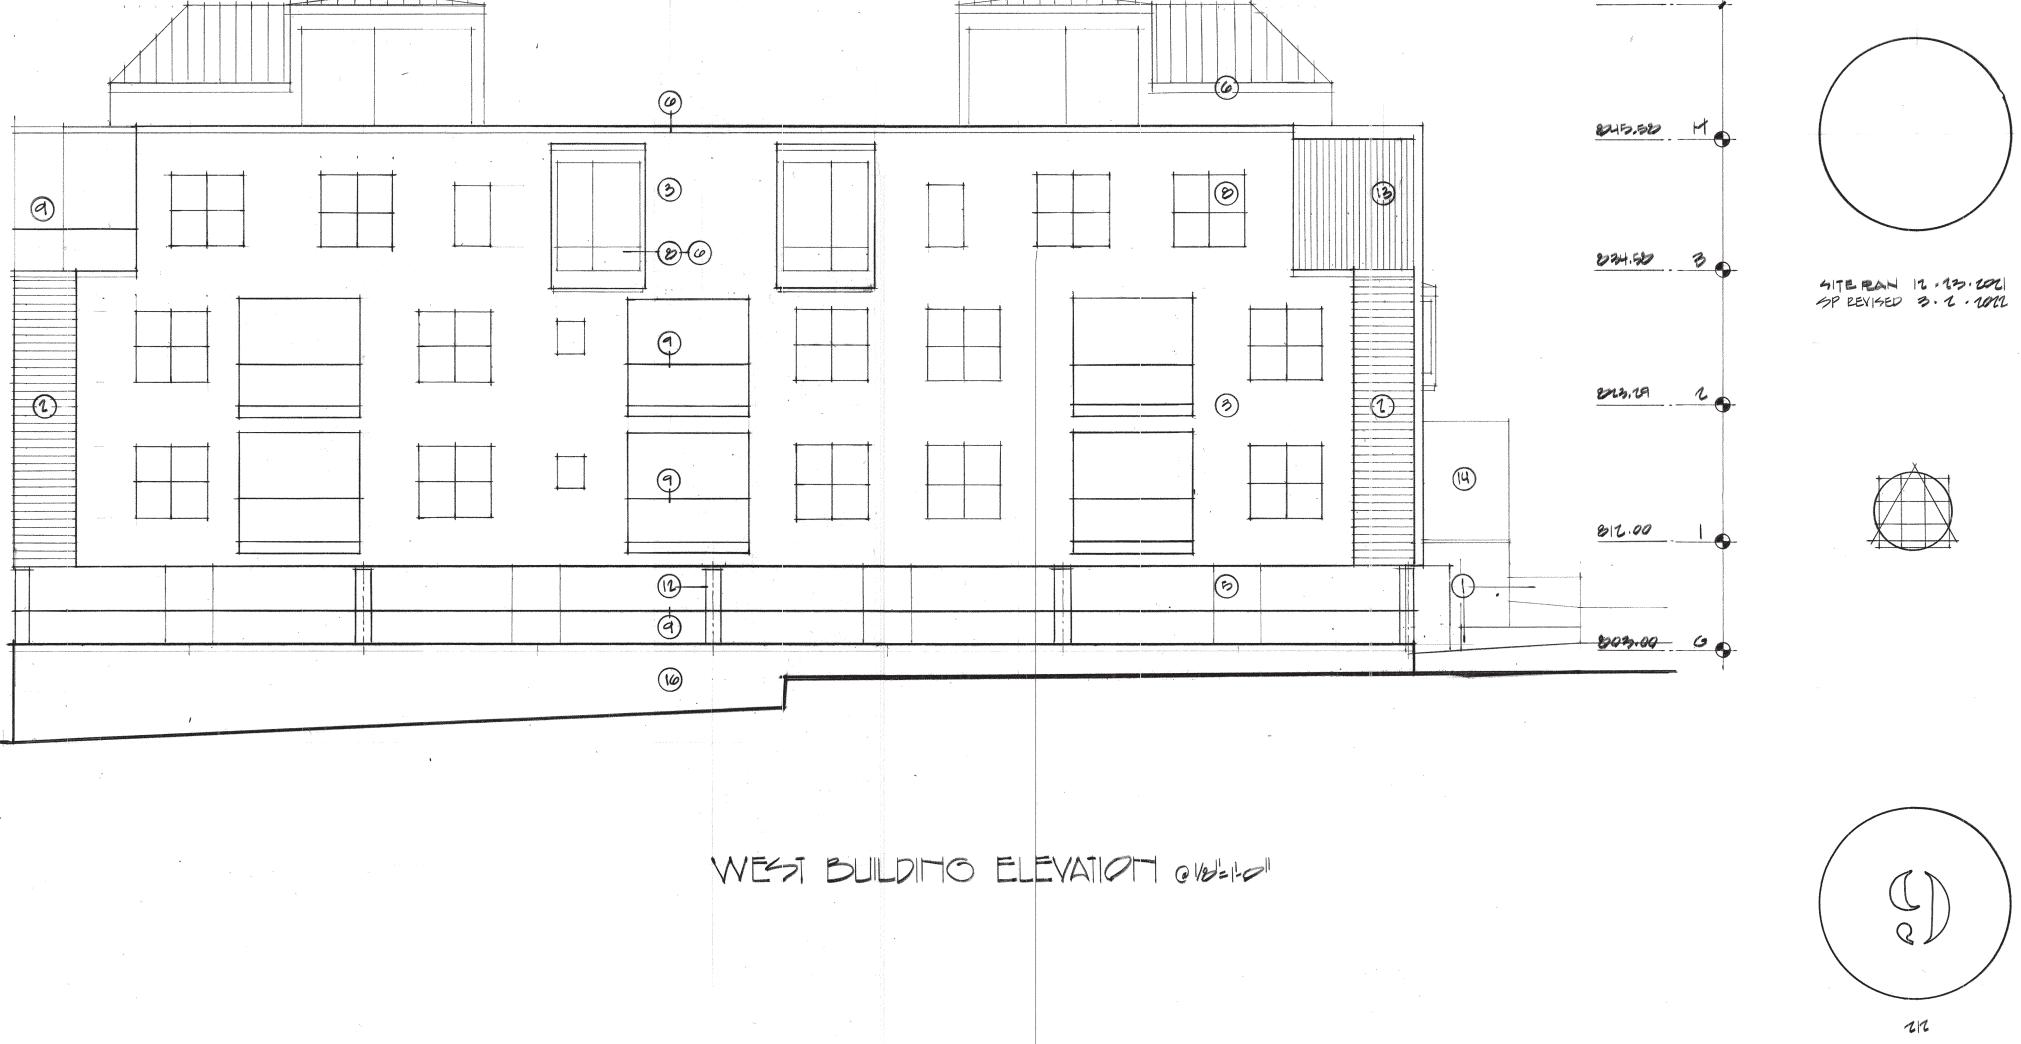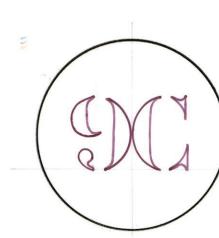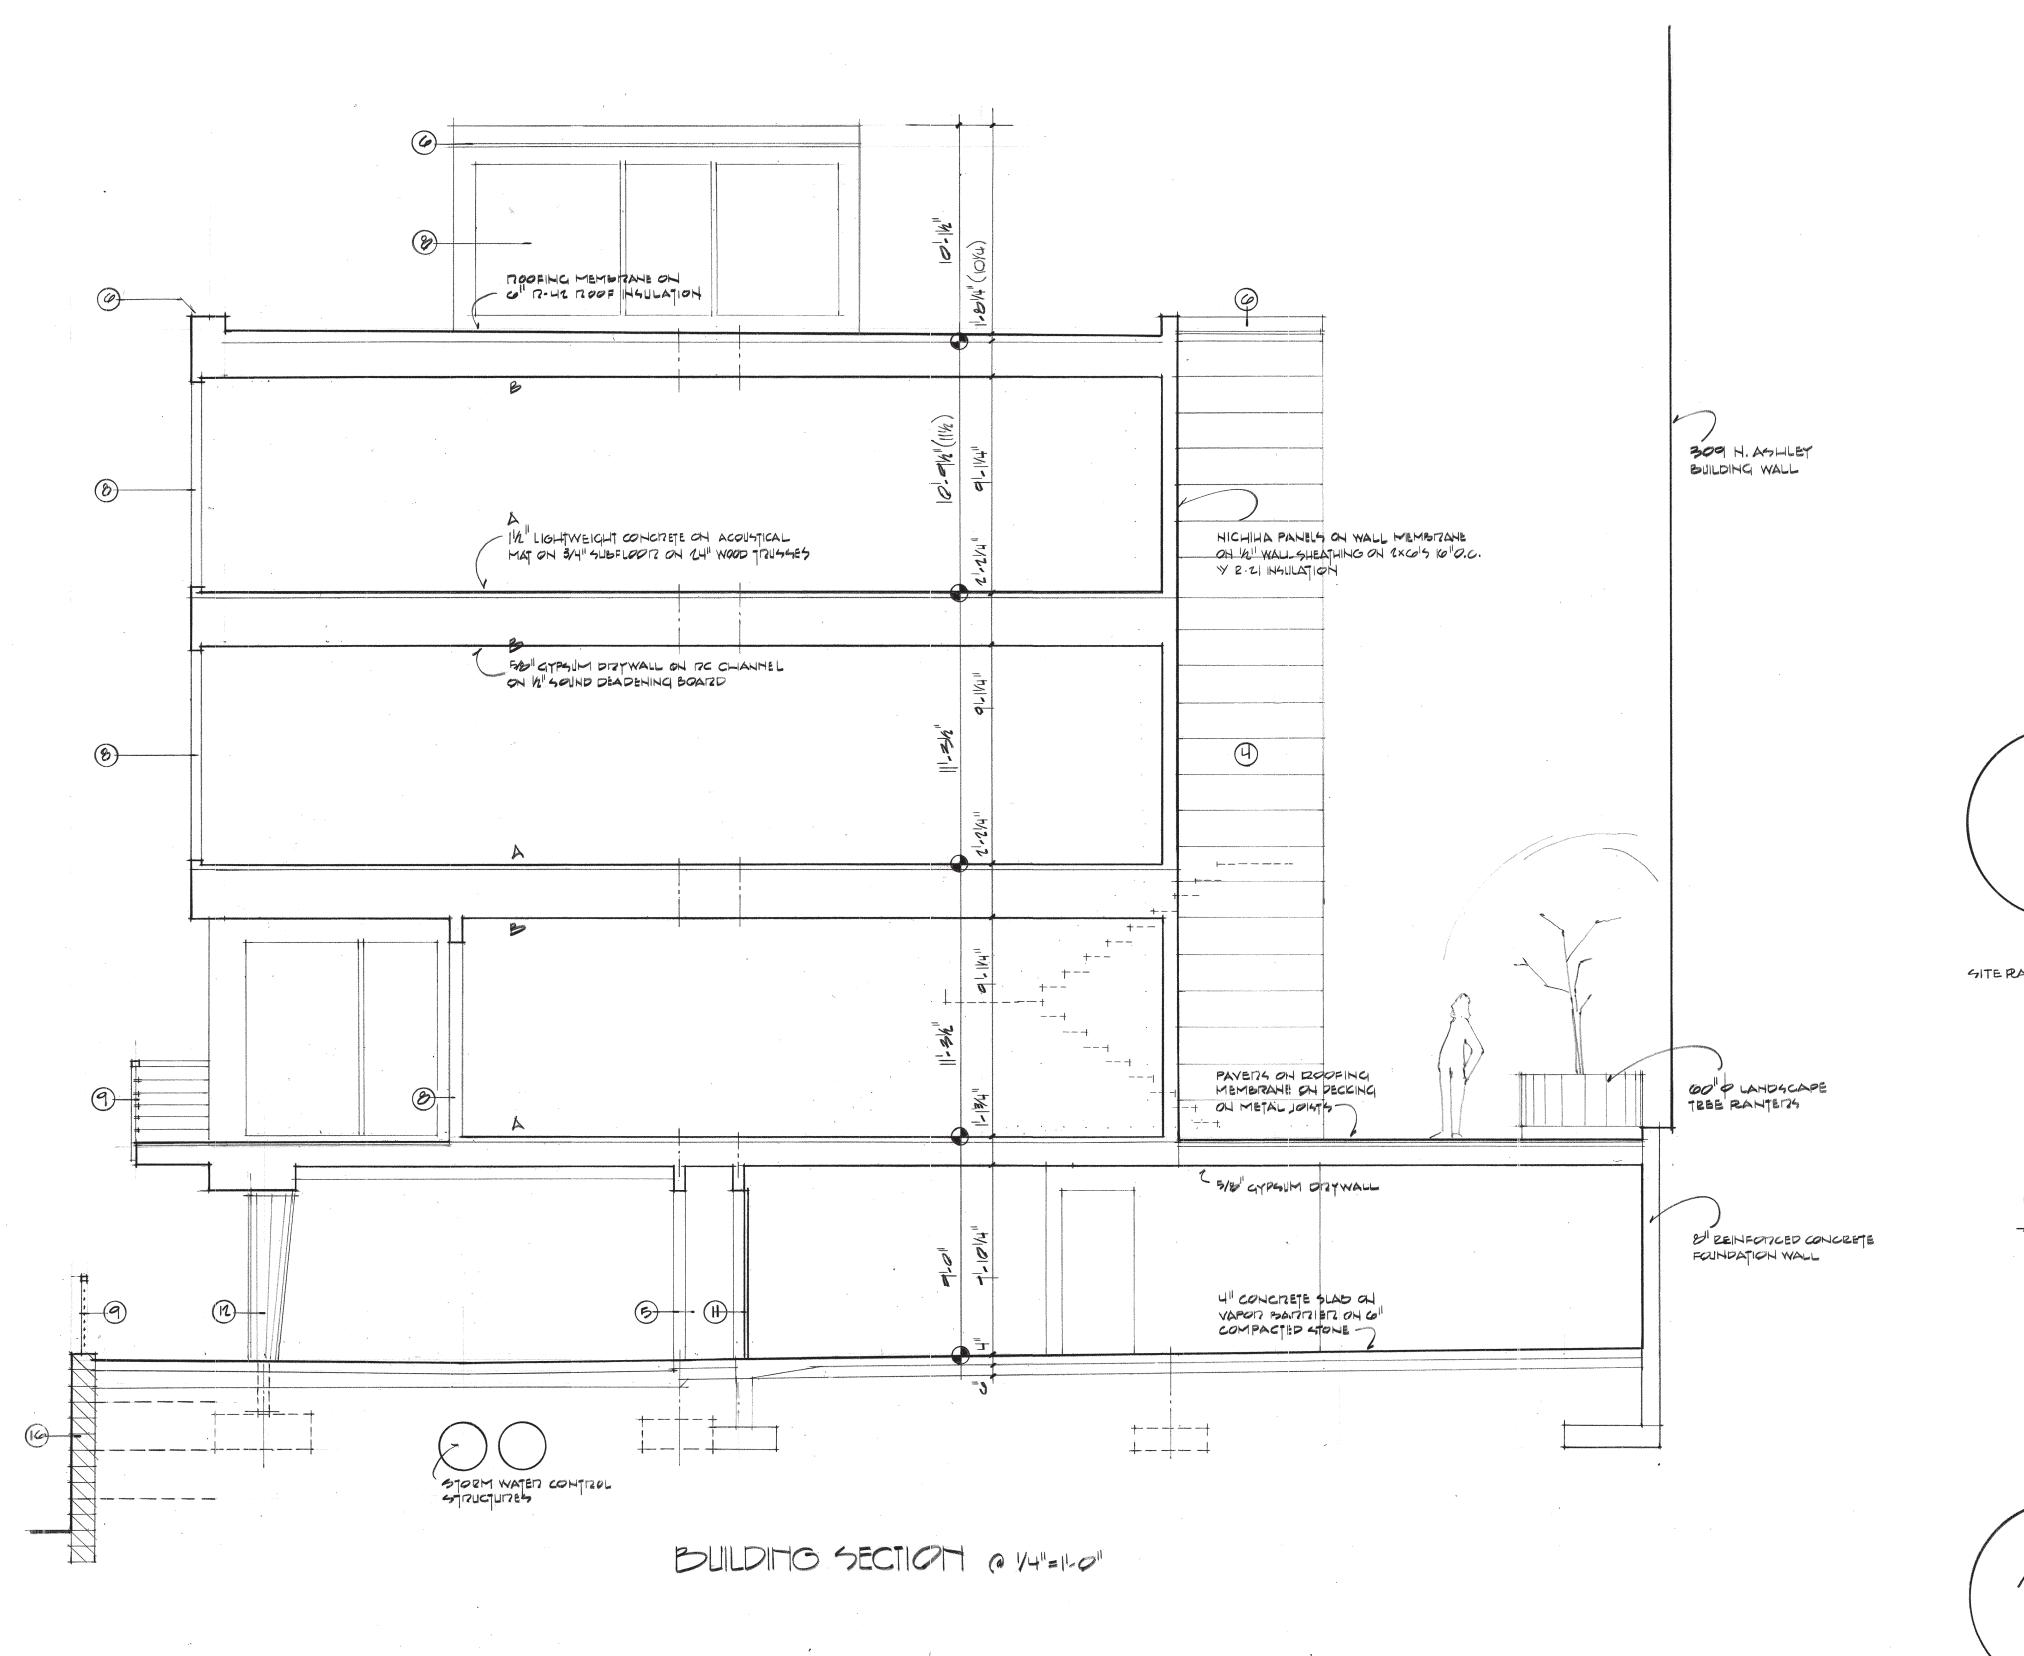
- 1. SAND BLASTED EXPOSED NATURAL CONCRETE
- 2. RUSTICATED WHITE UNIT MASONRY
- 3. NICHIHA ARCHITECTURAL WALLPANEL SYSTEM: SILVER GREY
- 4. NICHIHA ARCHITECTECTURAL WALL PANEL SYSTEM: OPAL WHITE
- 5. NICHIHA ARCHITECTURAL WALL PANEL SYSTEM: GRAPHITE
- 6. TERNE COATED STAINLESS STEEL: SOFT GREY
- 7. STANDING SEAM COPPER ENTRY ROOF: WEATHERED
- 8. BLACK FRAMED INSULATED GLASS WINDOWS
- 9. POWDER COATED STEEL GUARD RAILS & BALUSTERS
- 10. INSULATED GLAZED ENTRY DOOR: GRAPHITE 11. INSULATED OVERHEAD GARAGE DOOR: GRAPHITE
- 12. COMPOSITE COLUMN SURROUND: GREY
- 13. WOOD PRIVACY FENCE STRUCTURE: WEATHERED GREY 14. GREEN ECO LIVING LANDSCAPED PRIVACY FENCE STRUCTURE: IVY GREEN
- 15. GLASS BLOCK WINDOW CLEAR GLASS
- 16. UNIT MASONRY RETAINING WALL SYSTEM: EARTHTONED

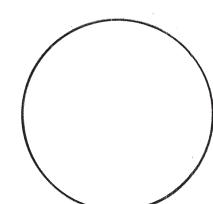




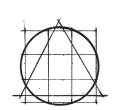


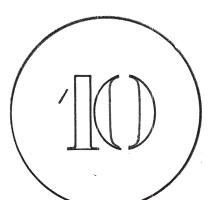


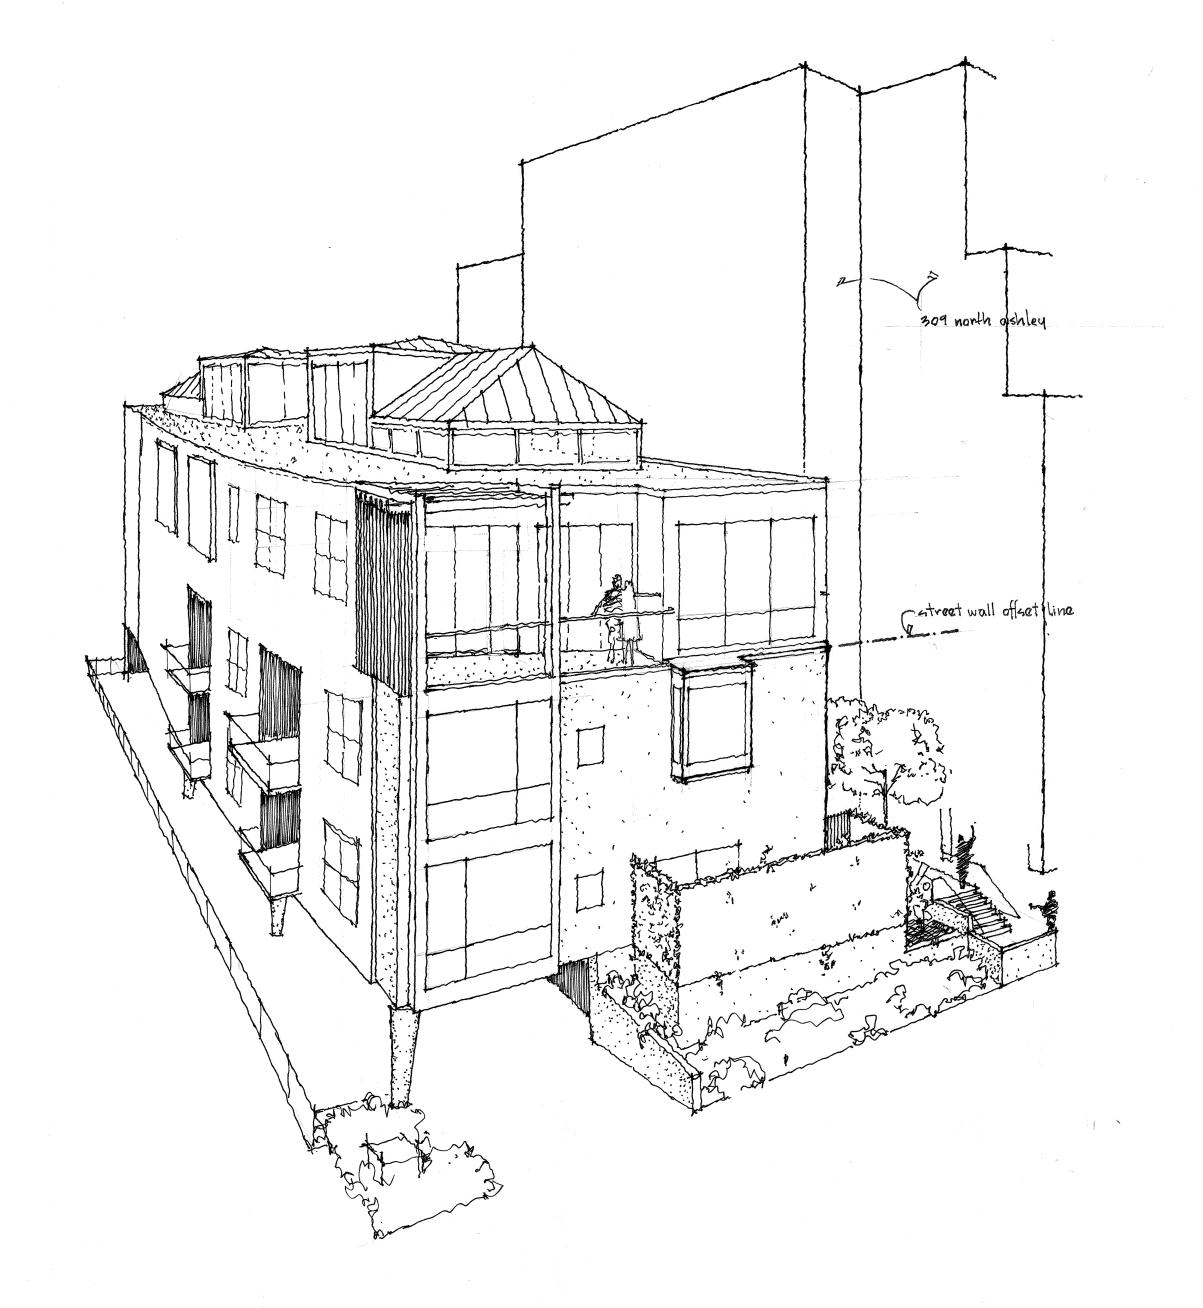




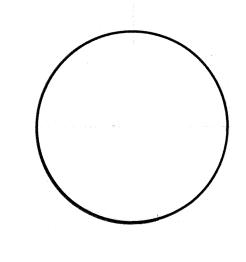
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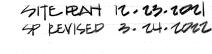









BUILDING PERSPECTIVE FROM SOUTHWEST







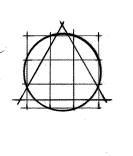


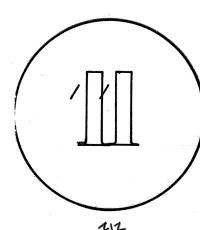

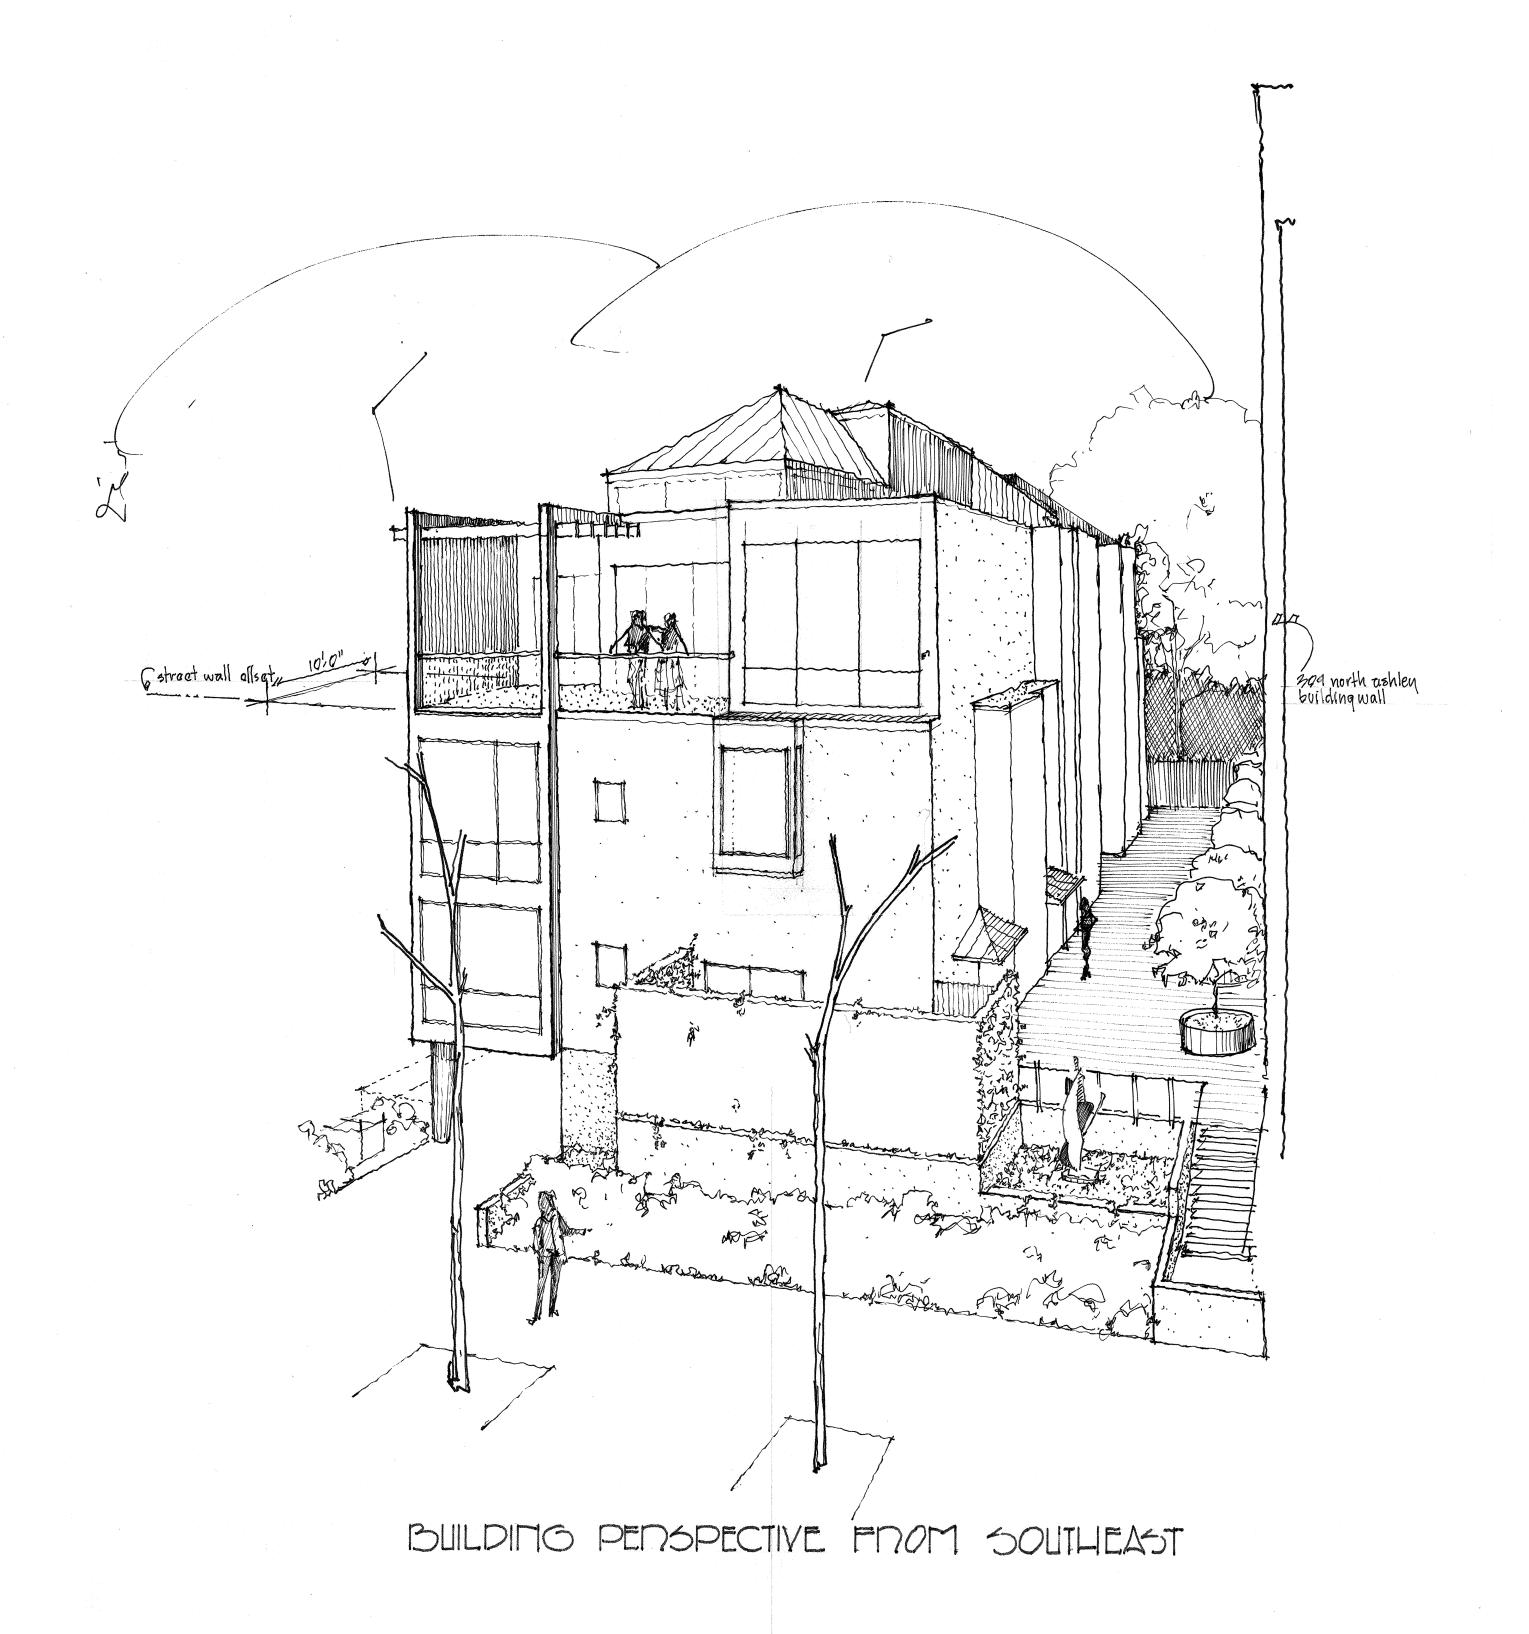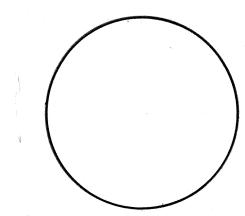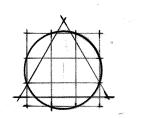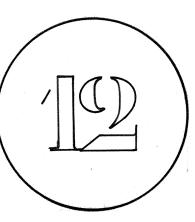







EXTERIOR LIGHTING FIXTURE KEY

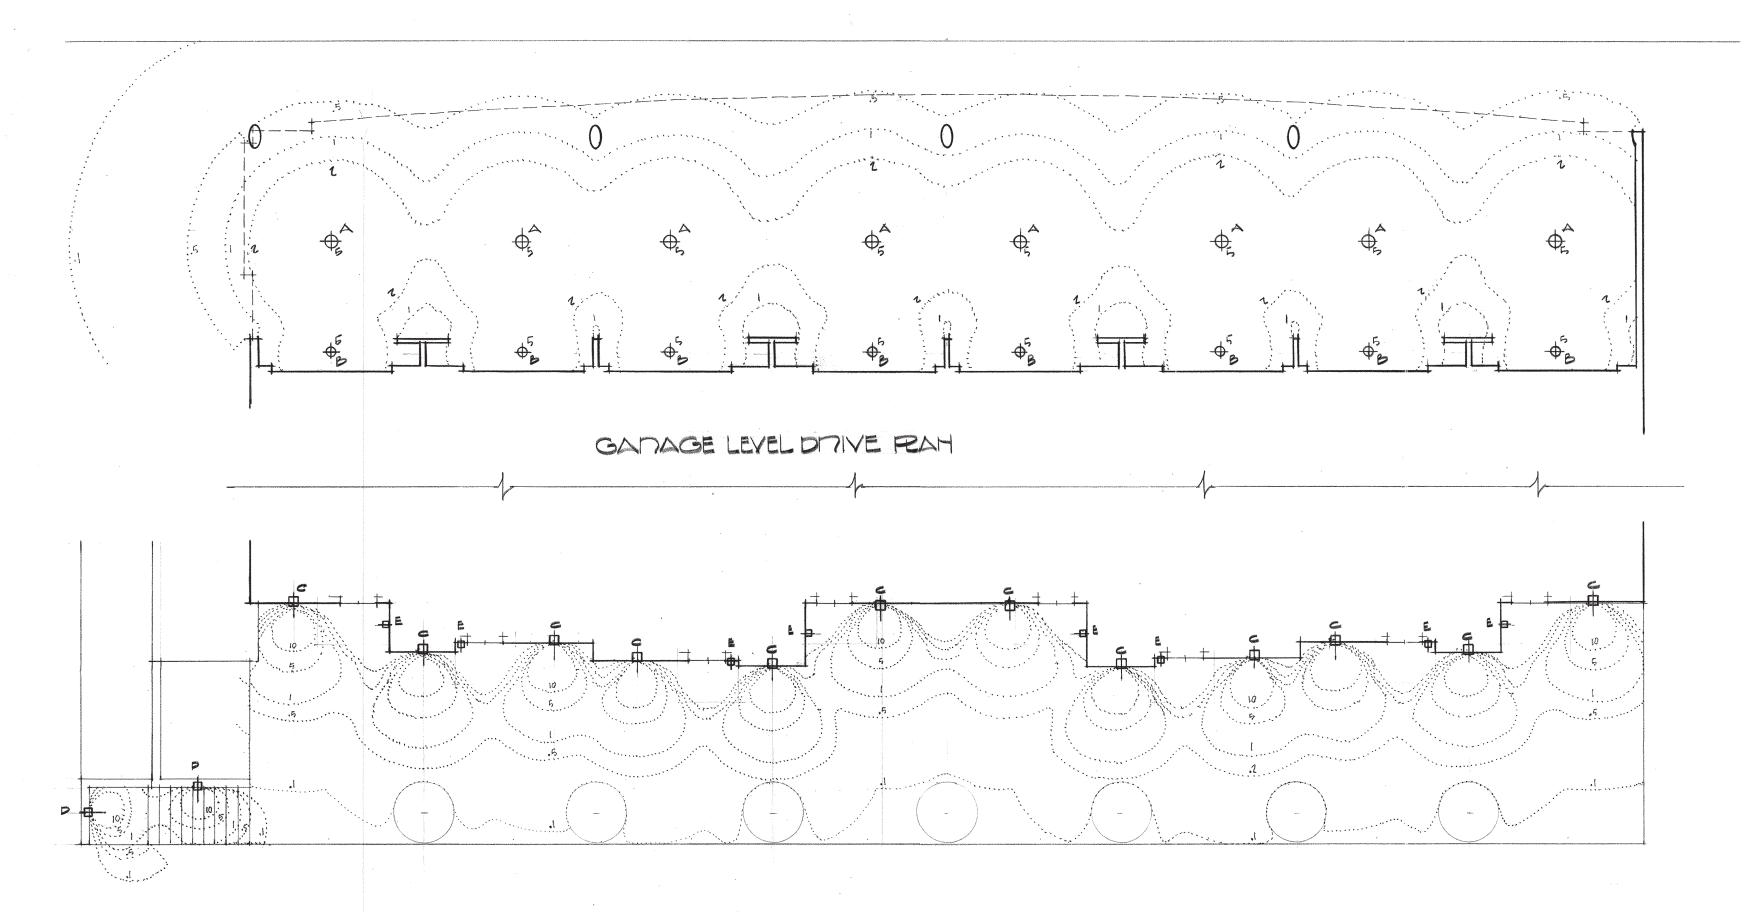
A. JUNO JSF 13IN 18LM 20.2w LED 3000K SOFFIT FIXTURE B. JUNO JSF 5IN 07LM 7.2w LED 3000K SOFFIT FIXTURE

90 CRI DOWNLIGHT 90 CRI DOWNLIGHT

C. BEGA 24211 D. BEGA 24202

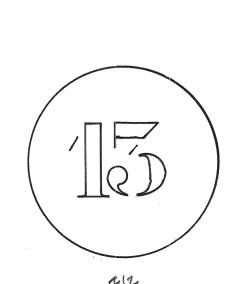
4.8w LED 3000K RECESSED WALL FIXTURE 82 CRI HORIZONTAL SPREAD 2.9w LED 3000K RECESSED WALL FIXTURE 82 CRI HORIZONTAL SPREAD

E. BEGA 33405 3.9w LED 3000K ENTRY WALL SCOUNCE 90 CRI ACCENT DOWNLIGHT

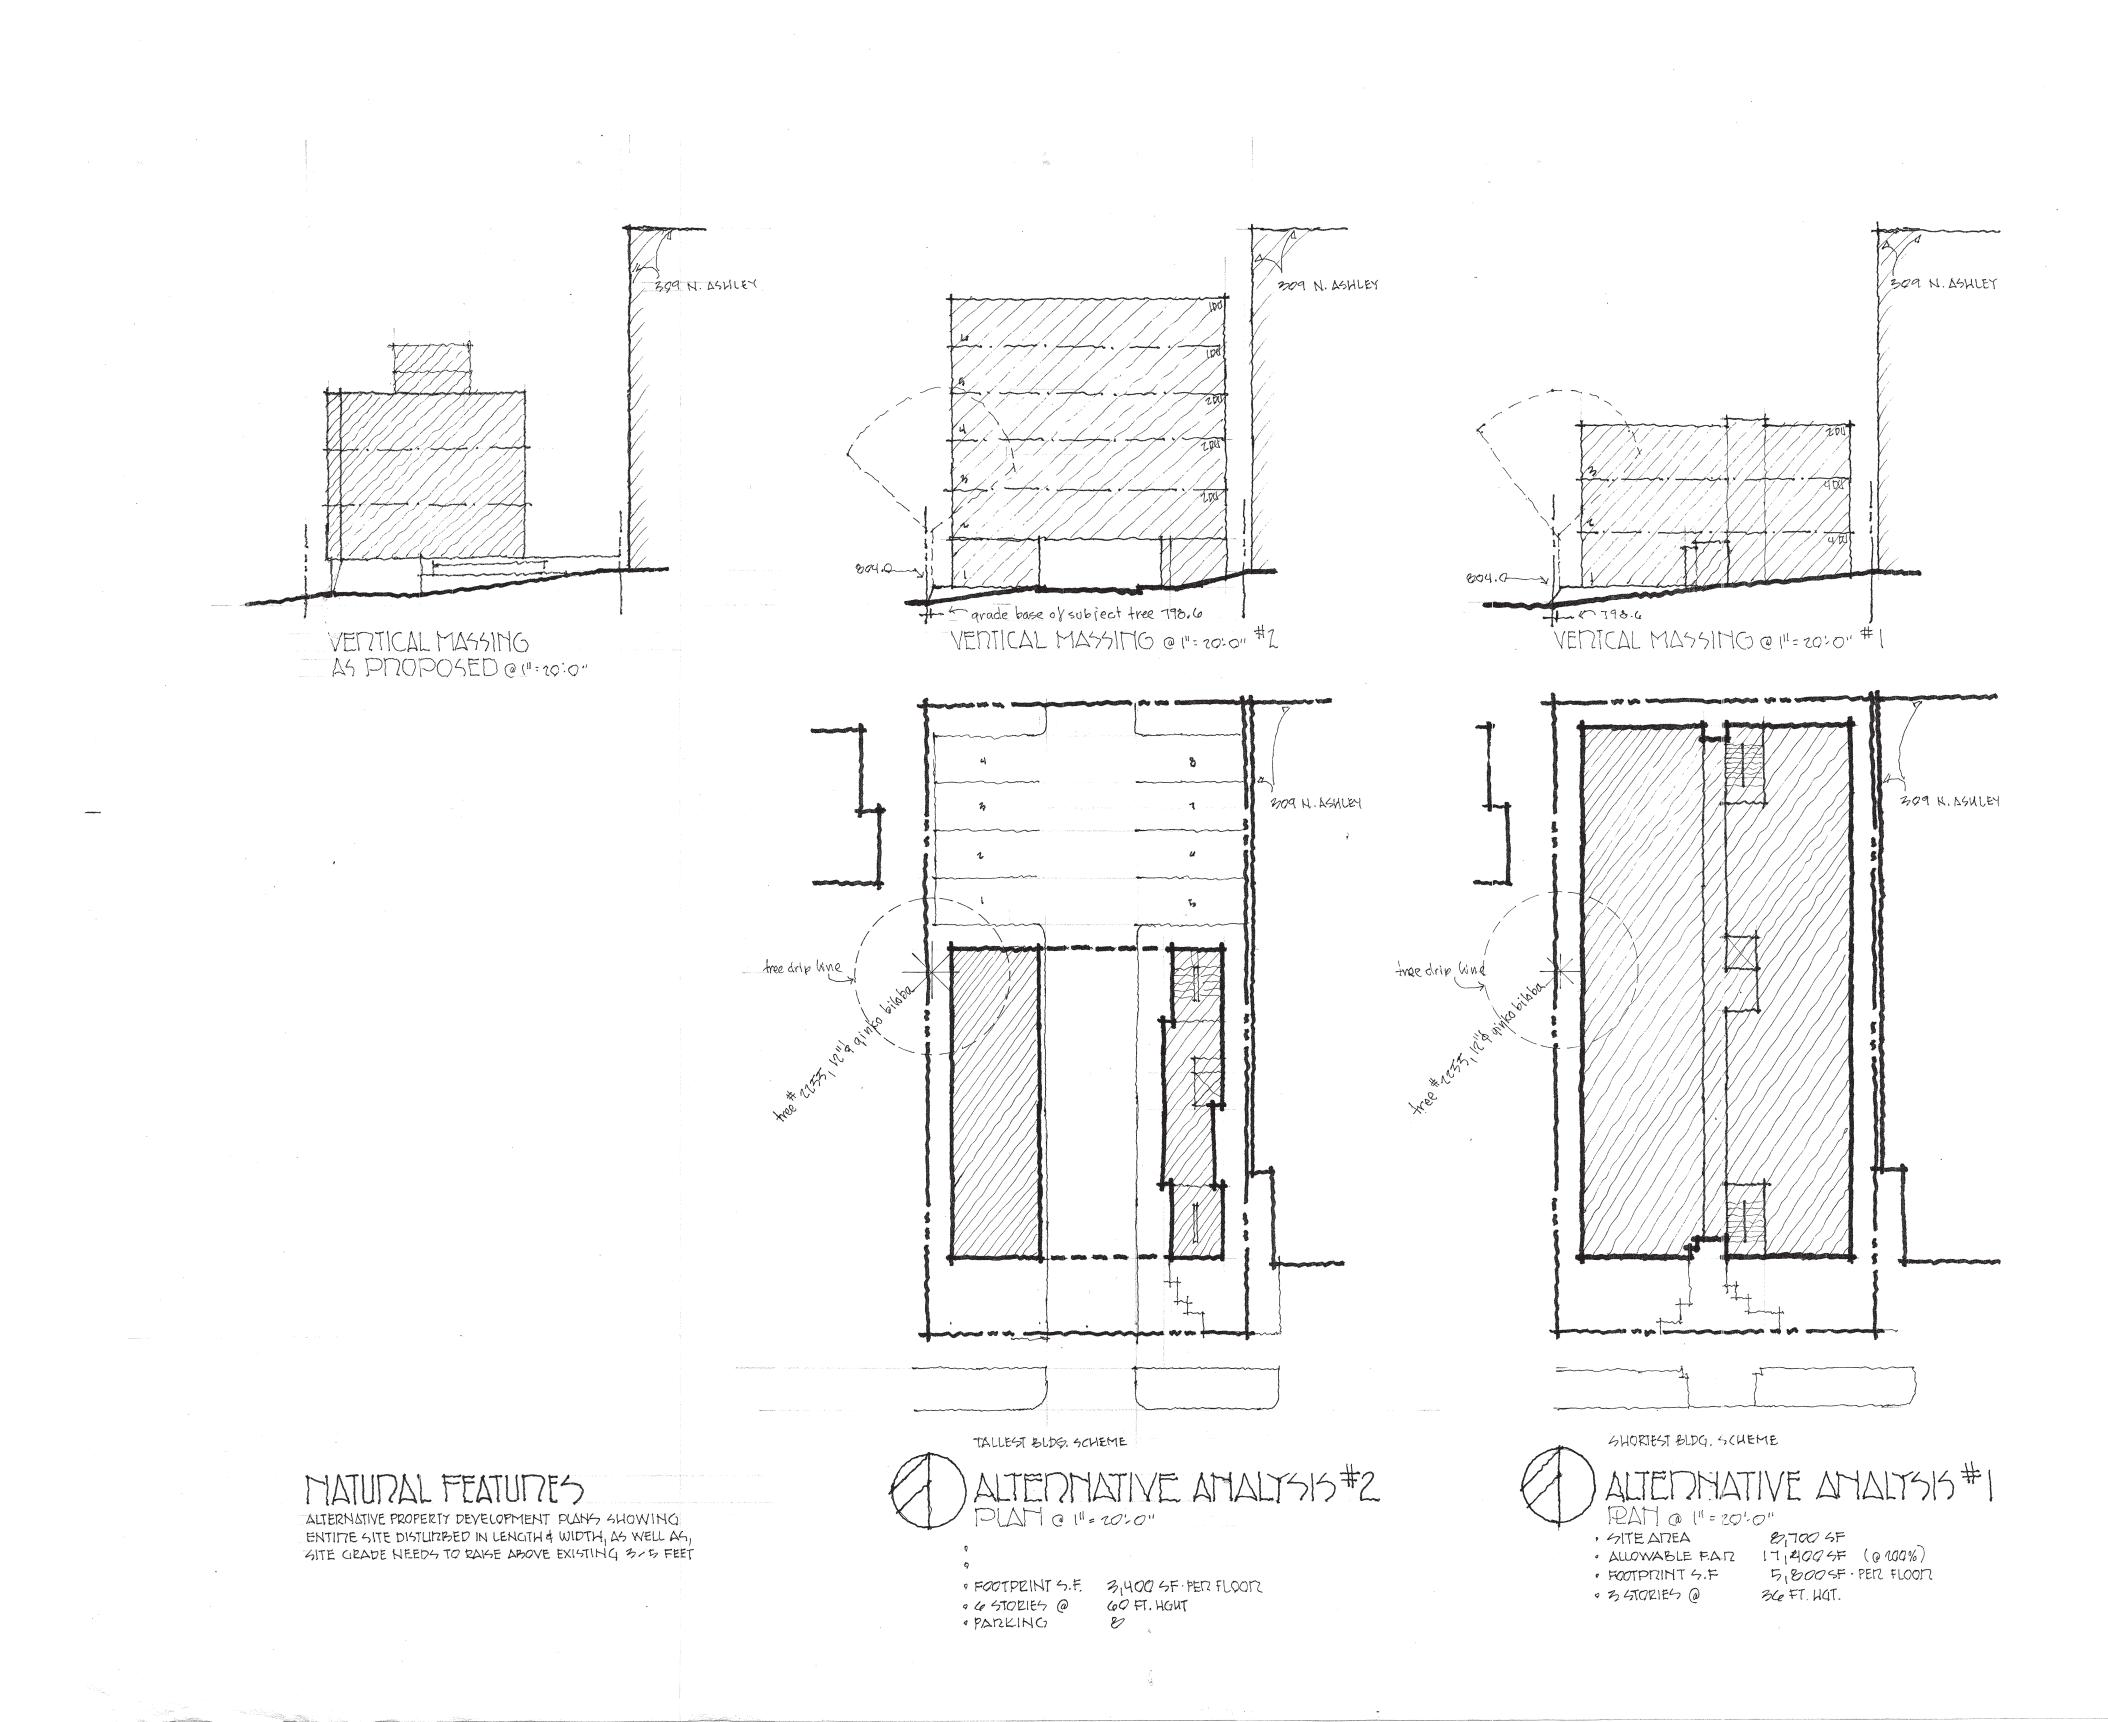








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