# **DIRECTORY**

## PROJECT OWNER

HEBREW DAY SCHOOL 2937 BIRCH HOLLOW DR ANN ARBOR, MICHIGAN, 48108 (734) 971-4633

## PROJECT ADDRESS

JEWISH COMMUNITY CENTER OF GREATER ANN ARBOR 2935 BIRCH HOLLOW DR ANN ARBOR, MICHIGAN, 48108 (734) 971-0990

# **ARCHITECT**

DANIELS AND ZERMACK ARCHITECTS, LLC SETH PENCHANSKY, AIA 2080 S STATE ST ANN ARBOR, MICHIGAN, 48104 (734) 761-2090 FAX (734) 761-6607

## INTERIOR DESIGNER

DANIELS AND ZERMACK ARCHITECTS, LLC SETH PENCHANSKY, AIA 2080 S STATE ST ANN ARBOR, MICHIGAN, 48104 (734) 761-2090 FAX (734) 761-6607

## LANDSCAPE ARCHITECT

INSITE DESIGN STUDIO, INC SHANNAN GIBB-RNADALL, PLA 412 LONGSHORE DR ANN ARBOR, MICHIGAN, 48105 (734) 995-4194

## SURVEY AND ENGINEERS

MONUMENT ENGINEERING GROUP ASSOCIATES, INC DAVID GILLETTE, PS DAVID DAVIS, PE 298 VETERANS DRIVE FOWLERVILLE, MICHIGAN, 48836 (517) 223-3512

## GEOTECHNICAL CONSULTANT

G2 CONSULTING GROUP 1350 EISENHOWER PL ANN ARBOR, MICHIGAN, 48108 (734) 390-9330 FAX (734) 390-9331

#### **GENERAL PROJECT INFORMATION:**

The Jewish Community Center of Greater Ann Arbor and the Hebrew Day School are looking for a relocation and expansion of the Hebrew Day School Library currently located elsewhere within the existing building. The project would be a 630 sqft addition to enclose a courtyard that currently hold a memorial garden, the memorial garden would be migrated to the East of the new addition on the property. In addition the Jewish Community Center of Greater Ann Arbor would like to place a 540 sqft storage shed in the North yard of the property, East of the woodlands area, and West of the storm water detention basin. The library is currently housed in one of the classrooms located on the East side of the building, the addition will allow an expansion of the libraries collection, return the classroom to its intended use, and provide the Hebrew Day School and the JCC a space for programs and lectures.

The development currently provides adequate parking, ingress and egress, storm water management, pedestrian connections, and all other required site elements. The proposed project will be scheduled to begin construction upon approval from the city and completion is expected in early 2024.

#### **DEVELOPMENT PROGRAM:**

The Jewish Community Center of Greater Ann Arbor (JCC) was founded in 1984 and quickly acquired the property at 2935 Birch Hollow Drive, Ann Arbor, Michigan and the 30,893 sf public school building from the Ann Arbor Public Schools in 1986 at which time the property was rezoned into a P.U.D. to accommodate the various mixed use needs of the various local Jewish organizations. These uses have remained unchanged and include: the Hebrew Day School (HDS), a K-5 Private Religious School; the JCC Early Childhood Education, a pre-school serving children from ages 2-5; JCC summer day camp programs; Community Meeting and Program Space for all age groups including specific programs for teens and seniors; Jewish Family Services who provides on-site services for seniors; office space for the Washtenaw Jewish News, Jewish Cultural Society, Ann Arbor Reconstructionist Congregation, and Jewish Federation of Greater Ann Arbor which is the fundraising entity for the Jewish Community.

In 1997 the P.U.D. was amended to add a 13,089 sf addition to the building and to expand parking from 38 to 62 spaces at which time an additional 37 spaces were indicated as deferred. This addition primarily added 4 additional Early Childhood classrooms and 4 additional HDS classrooms to replace existing portable classrooms. At this time a commercial kitchen was installed, and various size meeting rooms and office space and a new entrance lobby were added. A detention basin was also added to accommodate the added impervious area and deferred parking.

Since 1997 there have been a dozen internal renovations of the building to office space, meeting rooms, the gymnasium, and classrooms as well as improvements to the envelope of the building such as blast resistant Low-E glazing and other security improvements. The mechanical system of the building is a combination of the original 1968 boiler and various roof top units and heat pumps. One of the previous renovations added a 12-ton geothermal field to serve a renovated area of the building with a desire to eventually replace the boiler system with a geothermal system for the entire building. The JCC is a member of the Ann Arbor 2030 district and is working to reduce energy consumption by 50% by 2030.

At this time the Hebrew Day School has acquired a grant to expand the Library from 800 sf to 1600 sf and the JCC requires additional storage space, but the existing P.U.D. does not contemplate expansion of the building, so the JCC is proposing to amend the PUD to allow for current and future expansion including the JCC's strategic plan that proposes increasing programming in the future and would require additional classrooms, office space, café, theater, athletic facilities and possibly assisted living facilities.

A major future expansion of the building would be designed in a multi-story configuration to provide additional parking under the structure and adequate roof structure for a green roof to minimize the impervious area and maximize the site for playgrounds with a combination of surface and underground stormwater management strategies to coordinate with a geothermal well field to replace the existing 1968 boiler system.

The Jewish Community Center of Greater Ann Arbor does not own any land contiguous to this site.

## **COMMUNITY ANALYSIS:**

The Jewish Community Center is a Facility that provides space for multiple uses such as but not limited to: Hebrew Day School, Jewish Cultural Society, programming for senior citizens, a preschool, Washtenaw Jewish News, Jewish Family Services, The Jewish Federation of Greater Ann Arbor, and miscellaneous other functions.

The proposed project is located on the North side of Birch Hollow Dr, between Stone School Rd and Pebble Creek Dr, West of Clinton Park. The properties directly to the North, South, and West are zoned R1C. The property to the East is zoned PL. The property to the South across Birch Hollow Dr. is zoned R4A.

The project will have no effect on the public school system, air, or water quality. Vehicular and pedestrian circulation patterns will remain the same with vehicular traffic entering only on Birch Hollow Dr and exiting only onto Pebble Creek Dr. Parking will remain at the current volume as we do not anticipate a noticeable increase in attendance. Vegetative screening will be maintained on each side of the southerly parking area to augment the buffering already provided by existing screen fences and tall yew hedges.

## **GENERAL DESCRIPTION OF NATURAL FEATURES:**

There are no endangered species habitats, floodplains, steep slopes, or watercourses on the site. 0.87 acres at the Northwestern part of the site is woodland and will remain untouched by the proposed development. Trees within the woodland near proposed development will be protected during construction (see L2.0 for tree fence layout). A wetland is present on site, however the area outside of the woodland that it comprises is highly disturbed and is over 100' from construction. However, to comply with CLUB code, some shrubs will need to be planted within the setback (refer to L1.1). For information on existing landmark trees, refer to the natural features landscape plan (L2.0).

## **NATURAL FEATURES STATEMENT OF IMPACT:**

There are no natural feature located in the immediate vicinity of the project area. The existing grades will be maintained to reduce any impact to trees on adjacent properties.

## **SOLID WASTE DISPOSAL PLAN:**

The development currently provides one (1) six (6) cubic yard trash dumpster and one (1) six (6) cubic yard recycling dumpster stored in a screened area at the West end of the parking lot near the exit onto Pebble Creek Drive. We believe this is sufficient for the development as we do not anticipate a significant increase in occupancy or production of solid waste.

#### **DETENTION ANALYSIS:**

The facility was originally constructed in 1968 as a public elementary school when the Ann Arbor Public Schools developed the property along with the 4.75-acre site to the east for athletic fields (which was a separate lot). The original storm water drainage design utilized the natural drainage of the site and included storm water structures at natural low points of the site. Two structures 80' and 180' north of the building exited the site north via an 18" conductor to the storm water main in Pebble Creek Rd. Additionally, the 2 structures approximately 25' east of the building and one 100' west of the building, connected to the storm water piping for the 44 space parking lot south of the building which also accommodated the stormwater from the 23,000 sf internally drained roof before exiting the site to the west into the stormwater sewer in Pebble Creek Drive. The building and property excluding the 4.75-acre athletic fields was conveyed to the current owner in 1986 and subsequently the 4.75-acre site to the east was conveyed to the city of Ann Arbor for a public park. The resulting property line east of the building separating the subject parcel from the park parcel is only 2' east of the building and the two storm structures are on the park parcel. Due to the fact that the stormwater system connects both parcels, the jurisdiction over the system is the Washtenaw County Water Resources Commission (WCWRC). The original justification for the PUD was the mixed use of the building by a private entity and the 2' setback on the east side of the building.

When the building was planned to be expanded in 1997, the existing detention basin was designed to detain storm water runoff from new impervious surfaces (22,670 SF). This included 13,089 SF of building additions (East, West & Central Wings), and 9,581 SF of pavement. The design tributary area of the existing detention basin is 1.19 Acres, the basin bottom elevation is 819' and the high-water elevation is 820.75'. The 1997 required detention volume was 6,140 CF.

Using the current Washtenaw County Water Resources Commission 's (WCWRC) current standards the required volume for the existing and proposed conditions is 6,850 CF, and 7,405 CF, respectively (Including the 20% penalty). The as-built provided volume of the existing detention basin is 9,254 CF; calculated by topographic contour area. This volume is provided between 819' (basin bottom) to 821' (max storage elevation), with a freeboard elevation of 822'. Therefore, the existing detention basin has capacity to accept the additional storm water runoff from the proposed building addition.

The original detention basin design included an outlet control structure, overflow structure and a solid orifice plate. However, no outlet control structure nor solid orifice plate were observed in the field. To achieve the necessary volume (per current WCWRC requirements) an outlet control structure with a restricted outlet will be constructed as part of the proposed improvements.

If the outlet control structure rim is set at 821 (max storage elevation) the basin has 2,404 CF of spare volume, this corresponds to approximately 5,200 SF of additional impervious area that could be added to the tributary area of the existing detention basin. The proposed conditions add 1,210 SF of additional impervious area of the available 5,200 SF.

The stormwater management strategy for future additions to the impervious area is to enlarge the basin and/or provide underground detention. The existing soils of the site below 7' are sand and gravel, making underground detention a viable option in the future to be coordinated with proposed geothermal wells. Additionally, expansion of the building in the future is intended to be designed in a multi-story configuration to provide additional parking under the structure and adequate roof structure for a green roof to minimize the impervious area and maximize the site for playgrounds.

(The storm water analysis sheet and calculations will be submitted to Washtenaw County's Water Resources Commissioner's Office for approval.)

## **SOIL TYPES:**

Soil types on site are Sebewa Loam, Matherton Sandy Loam, and Boyer Loamy Sand per the Washtenaw County soil

## **SUSTAINABILITY:**

The current project will not drastically affect the performance of the building. The goal of revising the PUD zoning is to allow for future developments to the site. The goal is to improve the current facility and build additional spaces that comply with Ann Arbor's Living Carbon Neutrality Plan. Within two years the goal is to replace the 1968 boiler that currently heats most of the building with a geothermal system that will serve the HVAC and electricity that will power the Hot Water Heating needs for the building. With new additions being added to the building we can populate the otherwise unused roof area with solar panels or green roof space. With new additions comes the ability to expand the services that the Jewish Community Center of Greater Ann Arbor provides, including independent living and its complimentary services.

## **TRAFFIC IMPACT ANALYSIS:**

The development is not anticipating an increase in traffic. The existing drive approach will remain with an entrance on Birch Hollow Dr., and an exit on Pebble Creek Dr. No traffic study is required at this time.

## **LEGAL DESCRIPTION:**

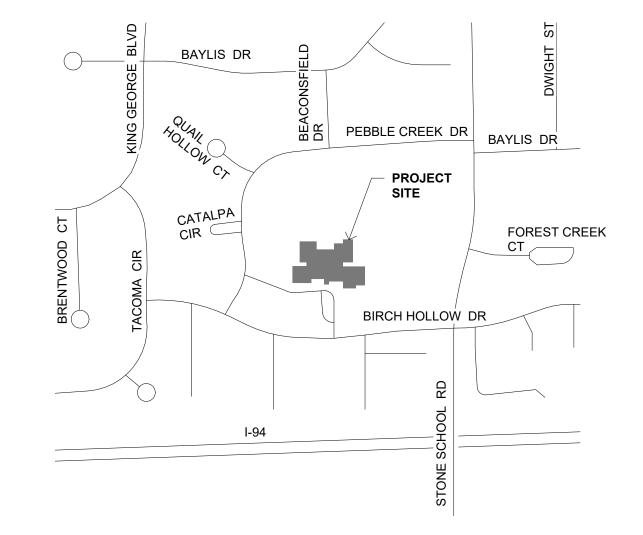
TAX ID 09-12-09-100-004

COMMENCING AT THE EAST 1/4 CORNER OF SECTION 9, TOWN 3 SOUTH, RANGE 6 EAST, CITY OF ANN ARBOR WASHTENAW COUNTY, MICHIGAN, THENCE ALONG THE EAST LINE OF SAID SECTION, NORTH 1° 18' WEST 1290.58 FEET; THENCE SOUTH 87° 00' WEST 47.09 FEET; THENCE SOUTH 83° 10' WEST 135.0 FEET FOR A PLACE OF BEGINNING; THENCE SOUTH 1° 07' EAST 507.20 FEET, THENCE SOUTH 85° 07' WEST 100.79 FEET; THENCE SOUTH 5° 30' EAST 139.0 FEET; THENCE WESTERLY ALONG THE ARC OF A CIRCULAR CURVE CONCAVE TO THE NORTH, RADIUS 829.43 FEET, CHORD BEARING SOUTH 88° 00' WEST 217.96 FEET; THENCE NORTH 7° 50' EAST 127.0 FEET; THENCE NORTH 82° 20' WEST 67.0 FEET; THENCE NORTH 73° 00' WEST 115.0 FEET; THENCE NORTH 67° 51' WEST 69.44 FEET; THENCE NORTHERLY ALONG THE ARC OF A CIRCULAR CURVE CONCAVE TO THE WEST, RADIUS 275.55 FEET, CHORD BEARING NORTH 4° 39' 30" EAST 127.01 FEET; THENCE NORTH 8° 40' WEST 63.0 FEET; THENCE NORTH 81° 20' EAST 130.0 FEET; THENCE NORTH 8° 40' WEST 80.0 FEET; THENCE NORTH 7° 56' EAST 80.0 FEET; THENCE NORTH 41° 08' EAST 80.00 FEET; THENCE NORTH 71° 42' EAST 67.58 FEET; THENCE NORTH 85° 40' EAST 62.0 FEET; THENCE NORTH 2° 33' WEST 130.0 FEET; THENCE NORTH 87° 27' EAST 60.00 FEET; THENCE SOUTH 2° 33' EAST 130.0 FEET; THENCE NORTH 85° 40' EAST 152.0 FEET TO THE PLACE OF BEGINNING, BEING A PART OF THE NORTHEAST 1/4 OF SAID SECTION 9.

NOW KNOWN AS: OUTLOT A SPRUCE KNOB SUBDIVISION

## **STANDARD SIDEWALK REPAIR AND MAINTENANCE NOTE:**

All sidewalks are to be kept and maintained in good repair by the owner of the land adjacent to an abutting the same. Prior to the issuance of the final certificate of occupancy for this site, all existing sidewalks in need of repair must be repaired in accordance with city standards.





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A2.2	SHED ELEVATIONS
A2.3	EXTERIOR VIEWS

A3.1 BUILDING SECTIONS


Required Bicycle Parking

Required Vehicle Parking


COMPARISON CHART			
	EXISTING PUD	PROPOSED PUD	
Zoning District	1997 PUD	2023 PUD	
Lot Area	261,650 SF	261,650 SF	
Lot Width	528 FT	528 FT	
Total Floor Area	43,995 SF	200,000 SF	
Floor Area Ratio (FAR)	0.17	0.80	
Front Setback	30 FT	30 FT	
Side Setback	30FT	30FT	
East Side Setback (along Clinton park)	2 FT	2 FT	
Parking Setback	20 FT	15 FT	
Maximum Building Height	23 FT	50 FT (3 Stories)	

(including 5 Barrier Free spaces)

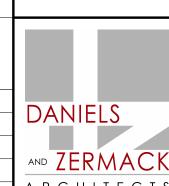
Jewish PUD Ar



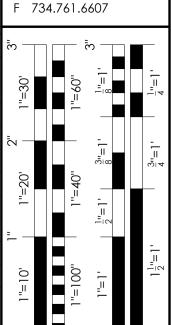ARCHITECTS 2080 S State Street Ann Arbor, MI 48104 O 734.761.2090



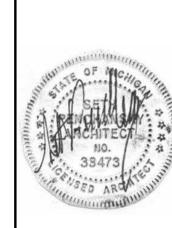EVISIONS Revision Description ISSUED FOR SITE PLAN APPROVAL 20 APRIL



2022-95 PROJECT: 03/20/23 DRAWN: CHECKED: **DETAIL SYMBOL** DETAIL NUMBER

REFERENCE

20 Class C

4 Class B

1 space per 400 SF

TITLE SHEET

4/20/2023 11:52:20 AM G:\D+ Z PROJECT FILES\\202\\202\\2022-95 HD\$ Librarv\Revit\\23.04.06 HD\$ BASE PLAN.rv

## LEGAL DESCRIPTION (AS PROVIDED)

(PER TITLE AGENCY: LIBERTY TITLE AGENCY. TITLE COMMITMENT NO: LIB182827, EFFECTIVE DATE: 3/9/2023)

#### SCHEDULE C DESCRIPTION:

THE LAND REFERRED TO IN THIS COMMITMENT IS LOCATED IN THE CITY OF ANN ARBOR, COUNTY OF WASHTENAW, STATE OF MICHIGAN, AND DESCRIBED AS FOLLOWS:

LOT(S) OUTLOT A, SPRUCE KNOB, ACCORDING TO THE PLAT THEREOF, AS RECORDED IN LIBER 18 OF PLAT(S), PAGES 43 AND 44, WASHTENAW COUNTY RECORDS.

FURTHER DESCRIBED BY WARRANTY DEED AS RECORDED IN LIBER 2104, PAGE 418, WASHTENAW COUNTY RECORDS AS FOLLOWS:

COMMENCING AT THE EAST 1/4 CORNER OF SECTION 9, TOWN 3 SOUTH, RANGE 6 EAST, CITY OF ANN ARBOR, WASHTENAW COUNTY, MICHIGAN, THENCE ALONG THE EAST LINE OF SAID SECTION, NORTH 1° 18' WEST 1290.58 FEET; THENCE SOUTH 87° 00' WEST 347.09 FEET; THENCE SOUTH 83° 10' WEST 135.0 FEET FOR A PLACE OF BEGINNING; THENCE SOUTH 1° 07' EAST 507.20 FEET, THENCE SOUTH 85° 07' WEST 100.79 FEET; THENCE SOUTH 5° 30' EAST 139.0 FEET; THENCE WESTERLY ALONG THE ARC OF A CIRCULAR CURVE CONCAVE TO THE NORTH, RADIUS 829.43 FEET, CHORD BEARING SOUTH 88° 00' WEST 217.96 FEET; THENCE NORTH 7° 50' EAST 127.0 FEET; THENCE NORTH 82° 20' WEST 67.0 FEET; THENCE NORTH 73° 00' WEST 115.0 FEET; THENCE NORTH 67° 51' WEST 69.44 FEET; THENCE NORTHERLY ALONG THE ARC OF A CIRCULAR CURVE CONCAVE TO THE WEST, RADIUS 275.55 FEET, CHORD BEARING NORTH 4° 39' 30" EAST 127.01 FEET; THENCE NORTH 8° 40' WEST 63.0 FEET; THENCE NORTH 81° 20' EAST 130.0 FEET; THENCE NORTH 8° 40' WEST 80.0 FEET: THENCE NORTH 7° 56' EAST 80.0 FEET: THENCE NORTH 41° 08' EAST 80.00 FEET; THENCE NORTH 71° 42' EAST 67.58 FEET; THENCE NORTH 85° 40' EAST 62.0 FEET; THENCE NORTH 2° 33' WEST 130.0 FEET; THENCE NORTH 87° 27' EAST 60.00 FEET; THENCE SOUTH 2° 33' EAST 130.0 FEET; THENCE NORTH 85° 40' EAST 152.0 FEET TO THE PLACE OF BEGINNING, BEING A PART OF THE NORTHEAST 1/4 OF SAID SECTION 9.

**NOW KNOWN AS:** OUTLOT A, SPRUCE KNOB SUBDIVISION, CITY OF ANN ARBOR, WASHTENAW COUNTY, STATE OF MICHIGAN ACCORDING TO THE PLAT THEREOF AS RECORDED IN LIBER 18 OF PLATS AT PAGES 43 AND 44, WASHTENAW COUNTY RECORDS.

#### 2935 BIRCH HOLLOW DRIVE

SUBJECT TO ALL APPLICABLE BUILDING AND USE RESTRICTIONS IMPOSED BY ANY GOVERNMENTAL AUTHORITY, AND EASEMENTS AND RESTRICTIONS OF RECORD, AND THE RIGHTS OF THE PUBLIC AND OF ANY GOVERNMENTAL UNIT TO ANY PART THEREOF TAKEN, USED OR DEEDED FOR STREET, ROAD OR HIGHWAY PURPOSES.

## BEARING REFERENCE

BEARINGS ARE BASED ON PROJECT COORDINATE SYSTEM: MICHIGAN STATE PLANE COORDINATE SYSTEM, NAD83 (CONUS) (MOL) (GRS80), SOUTH ZONE 2113, INTERNATIONAL FEET, GROUND (LAT: 42°14'23.16" N, LON: 83°43'18.34" W, ELEV: 824, SCALE FACTOR: 1.00006948).

## UTILITY/REFERENCE INFO

WM:	CITY OF ANN ARBOR
PHONE:	734-812-7932
RECEIVED:	2/7/23
SAN:	CITY OF ANN ARBOR
PHONE:	734-812-7932
RECEIVED:	2/7/23
STORM:	CITY OF ANN ARBOR
PHONE:	734-812-7932
RECEIVED:	2/7/23
GAS:	DTE ENERGY
PHONE:	248-318-7839
RECEIVED:	2/7/23
ELEC:	DTE ENERGY

313-407-5364 PHONE: **RECEIVED:** 2/16/23 PHONE/CABLE:

PHONE: 800-778-9140 **RECEIVED:** 2/15/23

PHONE/CABLE: COMCAST PHONE: 855-962-85250 RECEIVED: 2/16/23

## UTILITY NOTES

- 1. ALL UTILITIES SHOWN ARE BASED ON; A. MISS DIG MARKINGS LOCATED AT TIME OF SURVEY, OR; B. UTILITY MAPS PROVIDED TO THE SURVEYOR AT THE TIME OF THE SURVEY.
- 2. THE LOCATIONS AND ELEVATIONS OF EXISTING UNDERGROUND UTILITIES AS SHOWN ON THIS DRAWING ARE ONLY APPROXIMATE. NO GUARANTEE IS EITHER EXPRESSED OR IMPLIED AS TO THE COMPLETENESS OR ACCURACY THEREOF. THE CONTRACTOR SHALL BE EXCLUSIVELY RESPONSIBLE FOR DETERMINING THE EXACT UTILITY LOCATIONS AND ELEVATIONS PRIOR TO THE START OF CONSTRUCTION.

## SCHEDULE B-SECTION II EXCEPTIONS

TITLE AGENCY: LIBERTY TITLE AGENCY TITLE COMMITMENT NO: LIB182827 EFFECTIVE DATE: 3/9/2023

- GRANT OF EASEMENT IN FAVOR OF CITY OF ANN ARBOR, AS RECORDED IN LIBER 2103, PAGE 716, WASHTENAW COUNTY (PLOTTED & SHOWN HEREIN)
- SITE DEVELOPMENT AGREEMENT AND THE TERMS AND PROVISIONS CONTAINED THEREIN, AS RECORDED IN LIBER 2124, PAGE 730, WASHTENAW COUNTY RECORDS. (AFFECTS SUBJECT PROPERTY BUT IS NOT PLOTTABLE)
- GRANT OF EASEMENT IN FAVOR OF CITY OF ANN ARBOR, AS RECORDED IN LIBER 3505, PAGE 958, WASHTENAW COUNTY RECORDS.

(PLOTTED & SHOWN HEREIN)

SHEET INDEX

V-1.1 = ALTA TOPO SURVEY

V-3.0 = ALTA TREE SURVEY

V-1.0 = ALTA COVER

CITY OF ANN ARBOR WASTENAW COUNTY E EISENHOWER PKWY CREEK DR /

**LOCATION MAP** 

## SURVEYOR'S OBSERVATIONS

AT THE TIME OF THIS SURVEY. EVIDENCE WAS OBSERVED OF POTENTIAL ENCROACHMENTS. OTHER ENCROACHMENTS MAY OR MAY NOT STILL EXIST ON OR OFF THE SUBJECT PROPERTY.

THE FOLLOWING OBSERVATIONS WERE MADE AT THE TIME OF SURVEY:

OVERHEAD ELECTRIC LINE CROSSES THE NORTHERN AREA OF SUBJECT'S PROPERTY 130'± SOUTH OF PEBBLE CREEK DRIVE.

OVERHEAD ELECTRIC LINE APPEARS TO LIE A MAXIMUM DISTANCE OF 2 FEET OVER SUBJECT'S NORTHWEST-NORTH PROPERTY LINE.

## TABLE A ITEM NOTES

(FOR TABLE "A" ITEMS NOT LISTED BELOW, SEE PLAN VIEW ON ALT-X SHEET FOR MORE INFORMATION)

THE POSTED ADDRESS ON SITE IS 2935 BIRCH HOLLOW DRIVE.

ITEM 3: FLOOD ZONE FEMA MAP SCALES DO NOT SUPPLY SUFFICIENT LEVEL OF DETAIL TO PLOT ACCURATELY. ZONES IF PLOTTED HEREIN ARE APPROXIMATE.

BY SCALED MAP LOCATION AND GRAPHIC PLOTTING ONLY, THE SUBJECT PROPERTY APPEARS TO LIE ENTIRELY IN ZONE (X) AREA DETERMINED TO BE OUTSIDE OF THE 0.2% ANNUAL CHANCE FLOOD PLAIN ACCORDING TO THE FLOOD INSURANCE RATE MAP FOR THE COUNTY OF WASHTENAW, COMMUNITY PANEL NO. (26161C0401E), EFFECTIVE DATE APRIL 3, 2012.

#### ITEM 6(a) and 6(b):ZONING

A ZONING REPORT OR LETTER WAS NOT PROVIDED TO THE SURVEYOR AS REQUIRED BY 2021 ALTA/NSPS STANDARDS TABLE A ITEMS 6(A) & 6(B).

THIS ZONING INFORMATION SHOWN HEREIN WAS TAKEN FROM THE CITY OF ANN ARBOR ZONING ORDINANCE, EFFECTIVE DATE: NOVEMBER 17, 2019.

ZONING CLASSIFICATION: (PUD) (ZONING DESCRIPTION)

THE BUILDING SETBACK REQUIREMENTS ARE SUBJECT TO FURTHER INTERPRETATION BY THE LOCAL ZONING AUTHORITY LISTED ABOVE AND ARE NOT PLOTTED OR SHOWN HEREIN. FOR FURTHER INTERPRETATION OF THE BUILDING SETBACK REQUIREMENTS OR OTHER APPLICABLE ZONING REGULATIONS, PLEASE REFER TO THE LOCAL ZONING AUTHORITY LISTED ABOVE.

ITEM 9: EXISTING PARKING

NUMBER AND TYPE (E.G., DISABLED, MOTORCYCLE, REGULAR, AND OTHER MARKED SPECIALIZED TYPES) OF CLEARLY IDENTIFIABLE PARKING SPACES ON SURFACE PARKING AREAS, LOTS, AND IN PARKING STRUCTURES. STRIPING OF CLEARLY IDENTIFIABLE PARKING SPACES ON SURFACE PARKING AREAS AND LOTS.

54 REGULAR SPACES 5 BARRIER FREE SPACES XX BARRIER FREE SPACES

59 TOTAL PARKING SPACES

ITEM 16: AT THE TIME OF THIS SURVEY "EVIDENCE OF RECENT EARTH MOVING WORK, BUILDING CONSTRUCTION, OR BUILDING ADDITIONS OBSERVED IN THE PROCESS OF CONDUCTING THE FIELDWORK" WAS NOT OBSERVED.

ITEM 17: AT THE TIME OF THIS SURVEY, INFORMATION REGARDING PROPOSED CHANGES TO RIGHT OF WAY LINES WAS NOT MADE AVAILABLE BY THE CONTROLLING JURISDICTION. EVIDENCE OF RECENT STREET OR SIDEWALK CONSTRUCTION OR REPAIRS WAS NOT OBSERVED IN THE PROCESS OF CONDUCTING THE FIELDWORK.

CERTIFICATE OF INSURANCE TO BE FURNISHED UPON REQUEST, BUT THIS ITEM SHALL NOT BE ADDRESSED ON THE FACE OF THE PLAT OR MAP.

## MISCELLANEOUS NOTES

- 1. THERE IS DIRECT ACCESS TO THE SUBJECT PROPERTY VIA BIRCH HOLLOW DRIVE & PEBBLE CREEK DRIVE, BOTH ARE PUBLIC RIGHT-OF-WAYS.
- 2. THE PROPERTY SURVEYED AND SHOWN HEREIN IS THE SAME PROPERTY DESCRIBED IN SCHEDULE C OF TITLE AGENCY: LIBERTY TITLE AGENCY, TITLE COMMITMENT NO: LIB182827, EFFECTIVE DATE: 3/9/2023, ALSO FURTHERMORE DESCRIBED IN WARRANTY DEED AS RECORDED IN LIBER 2104, PAGE 419, WASHTENAW COUNTY RECORDS.

## CERTIFICATION

TO: LIBERTY TITLE AGENCY, WESTCOR LAND TITLE INSURANCE COMPANY, JEWISH COMMUNITY CENTER OF GREATER ANN ARBOR, A MICHIGAN NON-PROFIT ORGANIZATION:

THIS IS TO CERTIFY THAT THIS MAP OR PLAT AND THE SURVEY ON WHICH IT IS BASED WERE MADE IN ACCORDANCE WITH THE 2021 MINIMUM STANDARD DETAIL REQUIREMENTS FOR ALTA/NSPS LAND TITLE SURVEYS, JOINTLY ESTABLISHED AND ADOPTED BY ALTA AND NSPS, AND INCLUDES ITEMS 1, 2, 3, 4, 5, 6(a), 6(b), 7(a), 7(b1), 8, 9, 11, 13, 16, 17 & 19 OF TABLE A THEREOF.

THE FIELD WORK WAS COMPLETED ON 3/01/2023.

DAVID P. GILLETTE, PS PROFESSIONAL SURVEYOR NO. 4001041916

4/19/2023 DATE OF PLAT OR MAP:

THIS SURVEY PLAT WAS PREPARED FOR THE EXCLUSIVE USE OF THE PERSON, PERSONS, OR ENTITY NAMED IN THE CERTIFICATION HEREON. SAID CERTIFICATION DOES NOT EXTEND TO ANY UNNAMED THIRD PERSON WITHOUT AN EXPRESS RECERTIFICATION BY THE SURVEYOR NAMING SAID THIRD PERSON.

& ENGINEERING SOLUTIONS

INNOVATIVE GEOSPATIAL

298 VETERANS DRIVE FOWLERVILLE. MICHIGAN 48836 (OFFICE) 517-223-3512 MONUMENTENGINEERING.COM

SERVICE DISABLED VETERAN OWNEL SMALL BUSINESS (SDVOSB) OF MIC



Call MISS DIG 3 full working days before you di 1-800-482-7171

www.missdig.org WWW.ITHISSUIB.UIB
THE LOCATIONS AND ELEVATIONS
EXISTING UNDERGROUND UTILITIES AS SHO
DN THIS DRAWING ARE ONLY APPROXIMA
NO GUARANTEE IS EITHER EXPRESSED
MPLIED AS TO THE COMPLETENESS
ACCURACY THEREOF. THE CONTRACT
SHALL BE EXCLUSIVELY RESPONSIBLE F
DETERMINING THE EXACT UTILITY LOCATIO
AND ELEVATIONS PRIOR TO THE START
CONSTRUCTOR

CLIENT:

DANIELS AND **ZERMACK ARCHITECTS** 

SETH PENCHANSKY, AIA 2080 SOUTH STATE ST ANN ARBOR, MI 48104 PH: 734-761-2090

CURRENT ISSUE DATE:

4/19/2023

PROJECT NO: 23-016 SCALE: 1" = 40'

1/2" FIELD: AH, RZ DRAWN BY: DC DESIGN BY:

CHECK BY: DG, AP

**V-1.0** 

#### PEBBLE CREEK DRIVE STRUCTURE SCHEDULE (60 FT. WD. - PUBLIC - R/W) APPROX. 6" WATER MAIN (PER CITY PLANS) EX. SANITARY SEWER APPROX. SANITARY SEWER (PER, CITY PLANS) STRUCTURE RIM ELEV. PIPES 12" S IE= 803.73 RIM=821.56 \_(16193) (15706) SMH | 822.20 12" N IE= 808.63 \_\_ RIM=821.03 8" E IE= 811.33 12" SW IE= 809.1 (15761) SMH | 821.92 12" N IE= 809.10 12" E IE= 812.07 (15987) SMH | 825.73 12" W IE= 812.09 8" W IE= 818.54 LOT 36 (16187) SMH 823.74 8" E IE= 818.54 LOT 38 LOT 39 4" E IE= 821.74 LOT 37 12" S IE= 806.49 LOT 40 - WETLAND SOILS PER ---(16191) SMH | 821.56 12" W IE= 804.59 EGLE WETLAND MAPPER - PRIVATE EASEMENT 12" N IE= 804.49 FOR PUBLIC UTILITIES S83°10'00"W(R) EX. STORM SEWER N83°27'07"E(M) LOT 41 STRUCTURE RIM ELEV. PIPES N85°57'07"E(M) 12" E IE= 817.29 (15036) CBB 819.79 12" SE IE= 816.24 18" N IE= 816.15 (15241) CBR 12" NW IE= 818.28 821.53 LOT 42 (15391) CBR 12" S IE= 818.08 WELDED SHUT (15429) STMH 826.75 AT TIME OF SURVEY 8" N IE= 818.23 (15430) CBB 822.68 12" W IE= 816.93 12" E IE= 816.98 (15686) CBS 16" N IE= 815.89 36" S IE= 812.68 (15722) STMH 36" N IE= 812.54 24" SE IE= 815.35 12" RCP STRAIGHT (15821) CBS 819.60 SHEØ DOWN, NO INVERT 24" NW IE= 815.86 (15829) STMH 24" E IE= 815.90 15" S IE= 816.00 12" RCP STRAIGHT (15830) CBS DOWN, NO INVERT 12" RCP STRAIGHT (15849) CBS DOWN, NO INVERT (15241)- WETLAND SOILS PER ----(PINCHED) RHM=821.53 12" NE IE= 820.27 EGLE WETLAND MAPPER (16188) CBR 8" W IE= 820.29 6" S IE= 820.01 (16189) CBS 12" E IE= 813.60 24" S IE= 815.13 36" W IE= 808.73 (16190) STMH 36" E IE= 808.65 12" SE IE= 815.43 12" N IE= 814.66 (16193) CBS 12" NW IE= 815.63 (16195) CBS 12" W IE= 815.46 12" E IE= 816.86 24" W IE= 816.72 (16196) STMH (BENT EAST)- HOOP 16" S IE= 816.99 12" N IL= 816.95 4" N IE= 819.01 (50111) CBB 4" NE IE= 818.41 12" NW IE= 817.84 (50252) CBS 4" S IE= 818.34 SUBJECT PROPERTY NOW OR FORMERLY 16" N IE= 817.39

## **EXISTING LEGEND**


NE COR. 🚄

SEC. 9

T3S-R6E

S87°16'52"W(M)

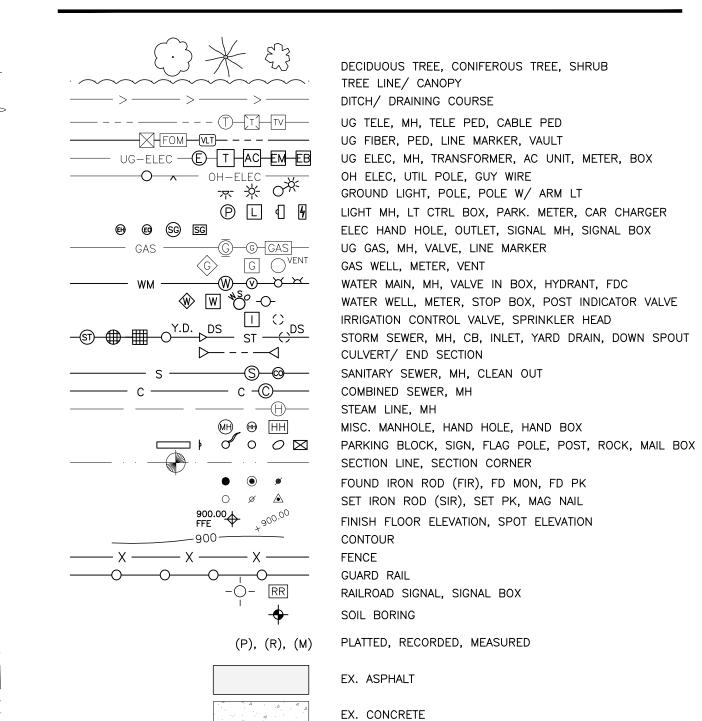135.00'(R&M) 347.09'(R&M) .



## **BENCHMARKS**

ه ست مصادمت المتاث

CITY OF ANN ARBOR DATUM BM NO.: AARGS #0011A NGS PID: AA5162 ELEV = 858.76

SITE BMs

ARROW ON HYDRANT, 196'± NORTH OF CENTERLINE BIRCH HOLLOW DRIVE & 11'± EAST OF SOUTH ACCESS DRIVE TO SUBJECT PROPERTY. ELEV = 826.08

EX. GRAVEL

BM B:

ARROW ON HYDRANT, 233'± EAST OF CENTERLINE PEBBLE CREEK DRIVE & 20'± NORTH OF WEST ACCESS DRIVE TO SUBJECT PROPERTY. ELEV = 825.32

## WETLAND NOTE

ACCORDING TO THE DEPARTMENT OF ENVIRONMENT, GREAT LAKES, AND ENERGY (EGLE) WEBSITE (HTTPS://WWW.MCGI.STATE.MI.US/WETLANDS/MCGIMAP.HTML), THERE ARE NOTED WETLAND SOILS ON THE SUBJECT PARCEL.

WETLAND FLAGGING WAS NOT OBSERVED DURING THE FIELD SURVEY. AN OFFICIAL STUDY FOR THE PRESENCE OF WETLANDS WAS NOT CONDUCTED BY MONUMENT ENGINEERING GROUP ASSOCIATES.

	LINE TABLE						
LINE #	BEARING	DISTANCE					
L1	N82°04'02"W(M) N82°20'00"W(R)	67.04'(M) 67.00'(R)					
L2	N72°43'24"W(M) N73°00'00"W(R)	115.08'(M) 115.00'(R)					
L3	N67°34'24"W(M) N67°51'00"W(R)	69.51'(M) 69.44'(R)					
L4	N8°25'19"W(M) N8°40'00"W(R)	62.96'(M) 63.00'(R)					
L5	N81°37'49"E(M) N81°20'00"E(R)	130.00'(R&M)					
L6	N8°26'13"W(M) N8°40'00"W(R)	80.00'(R&M)					
L7	N8°14'27"E(M) N7°56'00"E(R)	80.00'(R&M)					
L8	N41°26'27"E(M) N41°08'00"E(R)	80.00'(R&M)					
L9	N72°04'28"E(M) N71°42'00"E(R)	67.54'(M) 67.58'(R)					
L10	N86°02'22"E(M) N85°40'00"E(R)	61.96'(M) 62.00'(R)					
L11	N2°19'43"W(M) N2°33'00"W(R)	130.00'(R&M)					
L12	N87°36'35"E(M) N87°27'00"E(R)	60.00'(R&M)					
L13	S2°19'43"E(M) S2°33'00"E(R)	130.00'(R&M)					

CURVE TABLE							
JRVE #	LENGTH	RADIUS	DELTA	CHORD			
C1	218.60'(M)	829.48'(M) 829.43'(R)	15°05'59"(M)	S88°17'37"W(M) S88°00'00"W(R) 217.96'(R&M)			
C2	128.25'(M)	275.72'(M) 275.55'(R)	26°39'01"(M)	N04°54'12"E(M) 127.10'(M) N04°39'30"E(R) 127.01'(R)			

& ENGINEERING SOLUTIONS ing Group

INNOVATIVE GEOSPATIAL

298 VETERANS DRIVE FOWLERVILLE. MICHIGAN 48836 (OFFICE) 517-223-3512 MONUMENTENGINEERING.COM SERVICE DISABLED VETERAN OWNE SMALL BUSINESS (SDVOSB)

OF MIC DAVID GILLETTE License No. 4001041916 ) I P. Kalle Call MISS DIG

3 full working days before you dig One-Call

One-Call 1-800-482-7171 www.missdig.org THE LOCATIONS AND ELEVATIONS
EXISTING UNDERGROUND UTILITIES AS SHO
DIN THIS DRAWING ARE ONLY APPOXIMA
NO GUARANTEE IS EITHER EXPRESSED
MPLIED AS TO THE COMPLETENESS
ACCURACY THEREOF. THE CONTRACT
SHALL BE EXCLUSIVELY RESPONSIBLE F
DETERMINING THE EXACT UTILITY LOCATIO
AND ELEVATIONS PRIOR TO THE START
CONSTRUCTOR

CLIENT:

**DANIELS AND** ZERMACK ARCHITECTS

SETH PENCHANSKY, All 2080 SOUTH STATE ST ANN ARBOR, MI 48104 PH: 734-761-2090

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4/19/2023 PROJECT NO: 23-016

SCALE: 1" = 40'

FIELD: AH, RZ DRAWN BY: DC DESIGN BY: CHECK BY: DG, AP

**V-1.1** 

FILE:P:\Projects\2023\23-016 Ann Arbor Jewish Community Center\Dwg\Survey\23-016\_ALTA.dwg PLOT DATE:4/19/2023 4:03 PM

12" SE IE= 817.44

12" W IE= 818.43

12" E IE= 818.43

18" S IE= 815.77

24" N IE= 815.72

12" E IE= 815.92

(50275) CBS

(50804) STMH

SOILS INFO

• MdA: MATHERTON SANDY LOAM, 0-4% SLOPES

• Sb: SEBEWA LOAM, DISINTEGRATION MORAINE, 0-4% SLOPES

(50791) CBR OVERFLOW 820.20

\* (50111): 12" CLAY STRAIGHT DOWN, NO INVERT

SOIL TYPES ARE ACCORDING TO THE USDA SOIL SURVEY WEB SITE (https://websoilsurvey.sc.egov.usda.gov/App/HomePage.htm) BnB: BOYER LOAMY SAND, 1-6% SLOPES

LOT 47

WETLAND SOILS PER -

EGLE WETLAND MAPPER,

LOT 48

#2931

BIRCH HOLLOW DRIVE

TAX ID: 09-12-09-100-004

JEWISH COMM CTR OF GREATER ANN ARBOR

2935 BIRCH HOLLOW DR

261,664 SF

6.007 ACRES

(ZONE: PUD)

EX. BUILDING

43,995 SF

FOR PUBLIC UTILITIES

LOT 51


LOT 50

RIM = 821.79\_(50252) RIM=821.84

ENCLOSED BY 2'

HIGH WOOD WALL

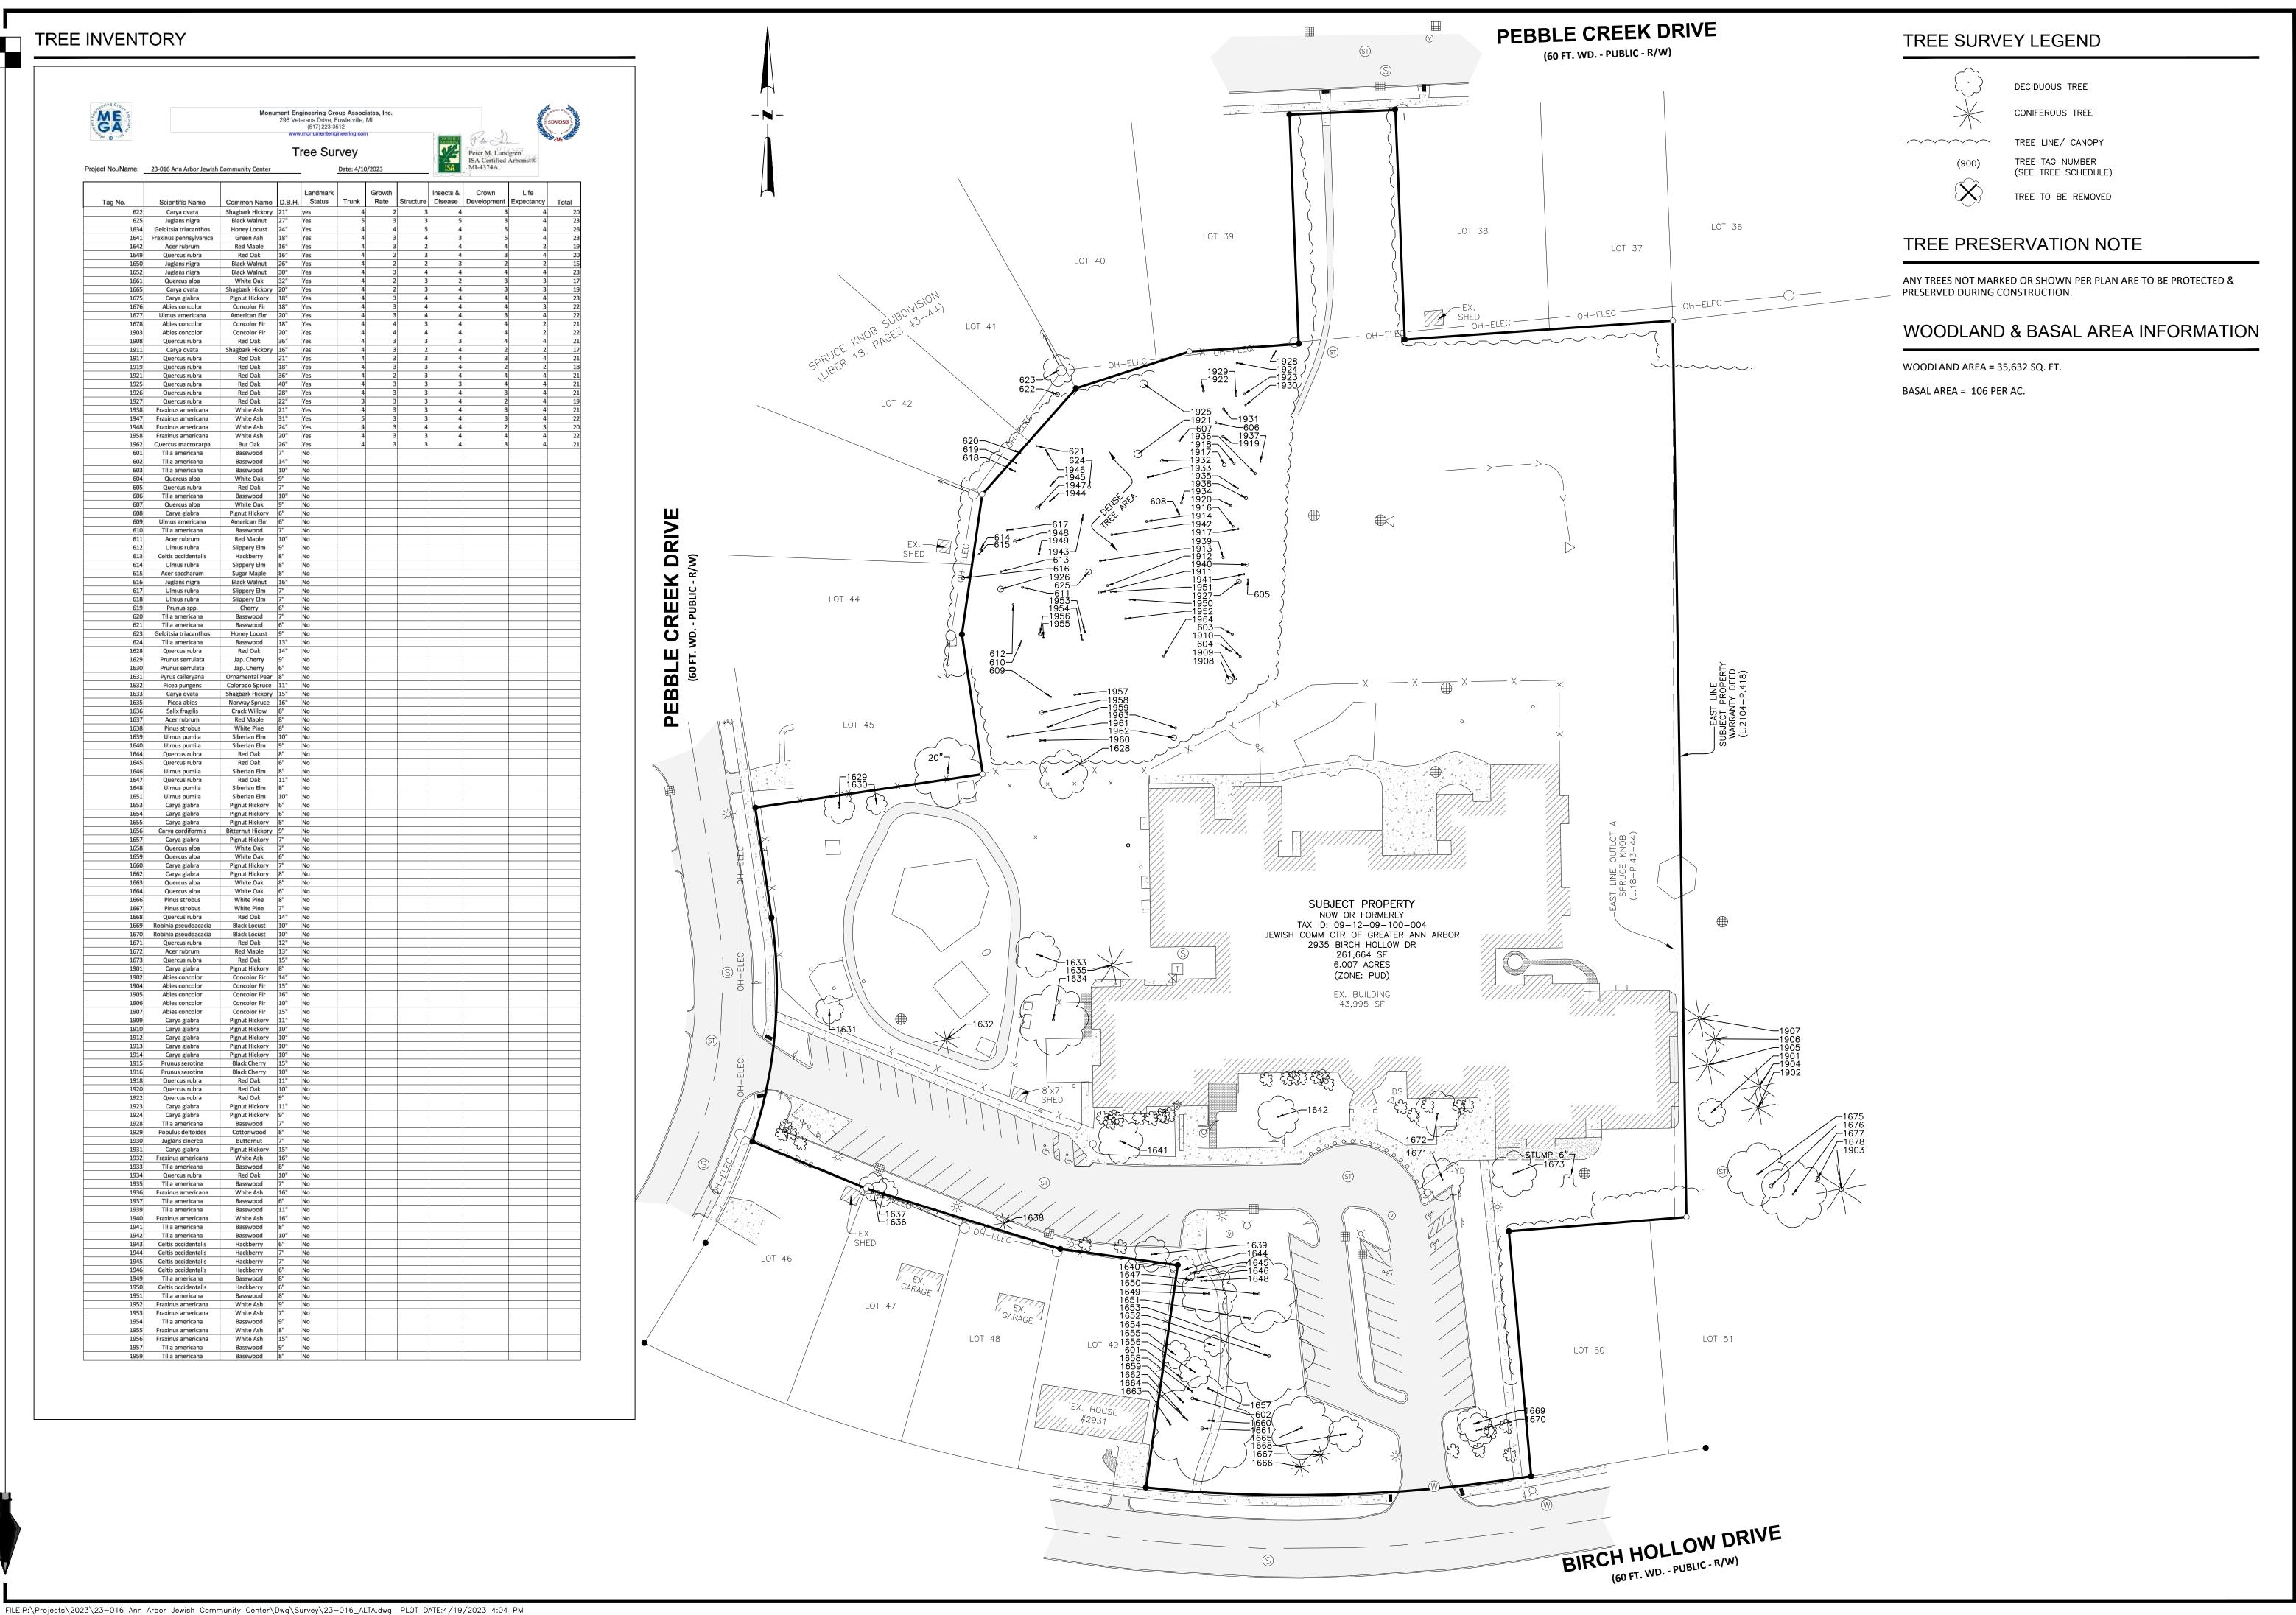E 1/4 COR. SEC. 9 T3S-R6E G-04



& ENGINEERING SOLUTIONS 298 VETERANS DRIVE

INNOVATIVE GEOSPATIAL

FOWLERVILLE, MICHIGAN 48836 (OFFICE) 517-223-3512 MONUMENTENGINEERING.COM SERVICE DISABLED VETERAN OWNE SMALL BUSINESS (SDVOSB)

DAVID **GILLETTE** License No 4001041916 Call MISS DIG

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**V-3.0** 



Proposed canopy tree: parking lot island

NOTE: Refer to survey for elements not listed above.

Restored Lawn Landmark Tree CRZ Wetland Setback Non-Landmark Tree Proposed canopy tree: street tree Tree not on survey Proposed canopy tree: mitigation Shrub not on survey Proposed canopy tree: right-of-way screening Proposed shrub: conflicting land use buffer

Proposed shrub: right-of-way screening

## NOTES

- Refer to Plant List table for size and species of existing trees.
- Decompact any compacted soil areas before planting.
- All proposed plantings that exceed a mature height greater than 6-inches shall be planted a minimum of 5 feet from fire hydrants.
- All proposed trees shall be planted a minimum of 15 feet from fire hydrants.
- Snow storage to remain in same location(s) as in previous site plans.
- All vegetation species deviation from the approved site plan must be approved ahead of time in writing by the City of
- 7. The City of Ann Arbor has adopted an ordinance limiting phosphorus in fertilizer. Applications of fertilizer beyond the initial topsoil and seeding shall be a fertilizer with no phosphorus.
- 8. Contact designer before changing any proposed plants on any landscape sheets

#### LANDSCAPE MAINTENANCE PROGRAM

- 1. All diseased, damaged, or dead material shown on the Landscape Plan as proposed plantings shall be replaced by the end of the following planting season as a continuing obligation for the duration of the site plan. 2. Snow cannot be pushed into interior landscape islands unless they are designated on previous landscape plans for snow
- 3. No chemicals are allowed in the stormwater features or buffer zones with the following exception: invasive species may be treated wtih chemicals by a certified applicator.

## PUD: LANDSCAPE MITIGATIONS TO CITY CODE

#### RIGHT OF WAY SCREENING

Presently, the proposed vehicular use areas are situated along a 150' right-of-way (ROW) street frontage, necessitating the installation of 5 ROW trees and 150' of continuous screening. The petitioner has made every effort to place the proposed ROW trees and shrubs in a manner that provides effective screening while working within the limitations of existing utilities, infrastructure, and sightlines. The proposed ROW screening represents the maximum feasible amount of screening within these constraints. No ROW trees are proposed due to sufficient existing trees in the areas adjacent to the vehicular use

## CONFLICTING LAND USE BUFFER

As per the current city code requirements, the strip that separates the parking lot from the residential properties to the Southwest falls short of the 15' minimum width, rendering it unable to comply with the CLUB (Conflicting Land Use Buffer) screening requirements. Furthermore, considering the presence of an existing fence between these parcels and several shrubs/trees in the said area, the petitioner has proposed CLUB screening to address any gaps in the current conditions.

In addition, at the Northwestern-most edge of the parking lot, the petitioner requests an exception to the CLUB screening requirements, taking into consideration the substantial quantity of existing shrubs and trees present between this edge and the adjacent residential parcels.

## PARKING LOT ISLANDS

The petitioner respectfully seeks an exemption from the bioretention requirements for the parking lot, citing that the scope of the project does not have any impact on the parking lot.

## STREET TREES

In accordance with the city code requirements, a total of 9 street trees are mandated. The petitioner has proposed the maximum number of street trees feasible, taking into careful consideration the presence of existing street trees, utilities/infrastructure, and sight-lines from the parking lot areas.

# Center

InSite Design Studio, Inc.

412 Longshore Drive Ann Arbor, Michigan

Phone: 734.995.4194

Fax: 734.668.2525

Date: Issued for:

4/20/2023 Site Plan Submission

Scale: 1" = 40'-0" Drawn by: KT & SGR



Sheet:

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LANDSCAPE REQUIREMENTS

		Required by Code	Existing	Proposed by PU
RIGHT-OF-WAY SCREENING				
Public right-of-way street frontage (LF)	150			
Deciduous or shade trees		5	6	0
1 tree per every 30 LF of frontage				
Continuous screening (LF)		150		
Min. 30" in height and 10' wide		*See PUD La	indscape N	lodifications
INTERIOR LANDSCAPE ISLANDS				
Vehicular use area (SF)	27,007			
Landscape island area (SF)		1,350	1,345	
1:20 landscape area to vehicular use area ratio				
Landscape island bioretention area (SF)		*See PUD La	ndscape M	lodifications
50% of the required interior landscape island				
Landscape island trees		5	4	1
1 tree per every 250 SF of required interior landscape island				
CONFLICTING LAND USE BUFFER Portion of vehicular use area adjacent to public park (LF)				
Portion of parcel adjacent to residential zoning (LF)	547			
Continuous screening (LF)	31,	547		
Min. 4' in height; min. 15' wide		*See PUD La	indscape N	lodifications
Trees		36		,
One tree for every 15 LF of abutting land		*See PUD La	indscape M	lodifications
Evergreen trees		18		,
50% of the trees shall be evergreen		*See PUD La	ındscape M	lodifications
STREET TREES				
Public right-of-way street frontage (LF)	415			
Street trees		10	4	6
1 tree per every 45 LF of frontage				
1 tree per every 45 Li of frontage				
NATURAL FEATURES MITIGATION	0			
NATURAL FEATURES MITIGATION  Woodland and landmark trees to be removed (see NF-1)  Mitigation Trees	0	0		0

## PLANT LIST

Type*										
Total #	L	S	R	С	ID	Botanical Name	Common Name	Size	Spacing	Notes
TREES										
1	1				CV	Crataegus viridis	Winter King Hawthorn	2" cal.	as shown	
2		2			GD	Gymnocladus dioicus	Kentucky Coffeetree	2" cal.	as shown	
3		3			PA	Platanus x. acerifolia	London Planetree	2" cal.	as shown	
1		1			UF	Ulmus 'Frontier'	Frontier Hybrid Elm	2" cal.	as shown	
	1	6	0	0						

Total #	L	S	R	С	ID	Botanical Name	Common Name	Size	Spacing	Notes
SHRUBS										
16			6	10	ca	Clethra alnifolia 'Pink Spire'	Pink Spire Summersweet	3 gal.	as shown	
12				12	cs	Cornus sericea	Redtwig Dogwood	3 gal.	as shown	
10			10		hv	Hamamelis virginiana	Common Witch-Hazel	5 gal.	as shown	
4				4	vl	Virburnum lantana	Wayfaring tree	5 gal.	as shown	
6				6	vpt	Viburnum plicatum tomentosum 'Mariesii'	Doublefile Viburnum	5 gal.	as shown	

\* Type Legend

0 0 16 32

- L = Interior Landscape Island Tree
- S = Street Tree R = Right-of-way Screening Tree/ Refuse Screening C = Conflicting Land Use Buffer





Tilia americana

Tilia americana

Fraxinus americana

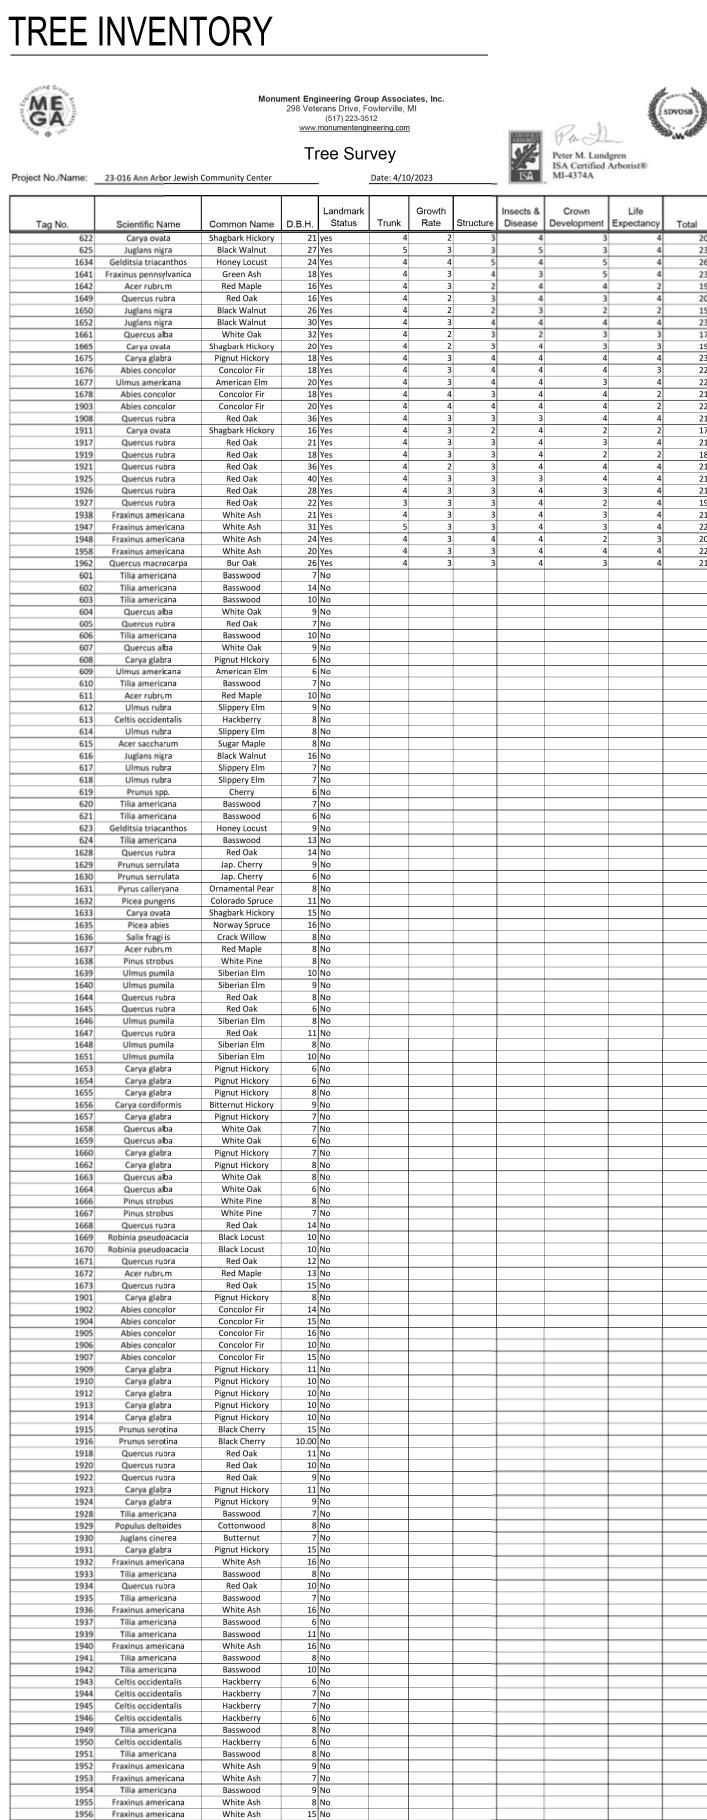
Celtis occidentalis

Ulmus americana

White ASh

Hackberry

American Elm Basswood



Woodland Boundary · - · - · - · - · - · - · - · - · -Soil type boundary

InSite Design Studio, Inc.

NOTE: Refer to survey for elements not listed above.



412 Longshore Drive Ann Arbor, Michigan

Phone: 734.995.4194 Fax: 734.668.2525

# NATURAL FEATURES

### WOODLAND DESCRIPTION

The site consists of 6.01 acres of land situated North of Birch Hollow Drive, West of Stone School Road, and East/South of Pebble Creek Drive. The site also borders Clinton Park off of Stone School Road. The Northern portion of the site has remained relatively open as green space for the community center and school while maintaining 0.87 acres of mostly high quality woodland consisting of several native tree/shrub species with minimal invasives and some understory growth. Native trees within the woodland consist of Oaks, Maples, Elms, Walnuts, Ash, and Hickories (See tree survey for the full list). The quality remains consistent with some decrease in quality near the edges. The woodland has a basal area of 88.7 sqft., or 0.0020 acres. Thus the woodland basal area ratio is 0.0023 acres/acre.

Landmark Tree CRZ

Non-Landmark Tree

Tree not on survey

Shrub not on survey

According to the NRCS soil survey, the soils on site include:

Sb - Sebewa, 0 to 2 percent slopes MdA - Matherton Sandy Loam, 0 to 4 percent slopes

BnB - Boyer loamy sand, 1 to 6 percent slopes

### WETLAND REPORT

There is an area of poorly drained wetland soils (Sebewa loam, Sb) that runs North-South along the western side of the subject's property. The northern portion of the wetland soils area is a relatively undisturbed woodland fragment (the westernmost portion of the woodland) that contains a mix of Walnut, White and Red oak, American Linden, and Hickory (see species list). None of the tree species were obligate wetland plants, and there was no evidence of hydrology at the surface when visited in March after a rainy period early this spring. Once the wetland soils leave the woodland to the south, it becomes highly disturbed and manipulated from it's previous use as a public school and its current use as the Jewish Community Center. The wetland soils broaden out as they travel south through the playground for the early childhood center and under the western portion of the parking lot.

The proposed construction activities will not take place in close proximity to the wetland on site. However, alterations to the wetland area will occur due to the proposed planting of CLUB shrubs at the Southwest parking lot. Though this strip between the parking lot and neighboring residential properties is designated as wetland, the area is highly disturbed and shows no indication of wetland ecological function other than the historical soil data.

For this reason, the petitioner requests an exception from obtaining a wetland permit to plant CLUB shrubs within this area.

Date: Issued for:

4/20/2023

Scale: 1" = 40'-0"

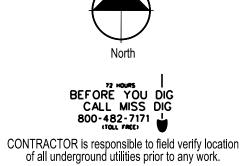
Drawn by: KT & SGR


Site Plan Submission


Sheet:

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## NOTE: Refer to survey for elements not listed above.

## SEQUENCE OF CONSTRUCTION

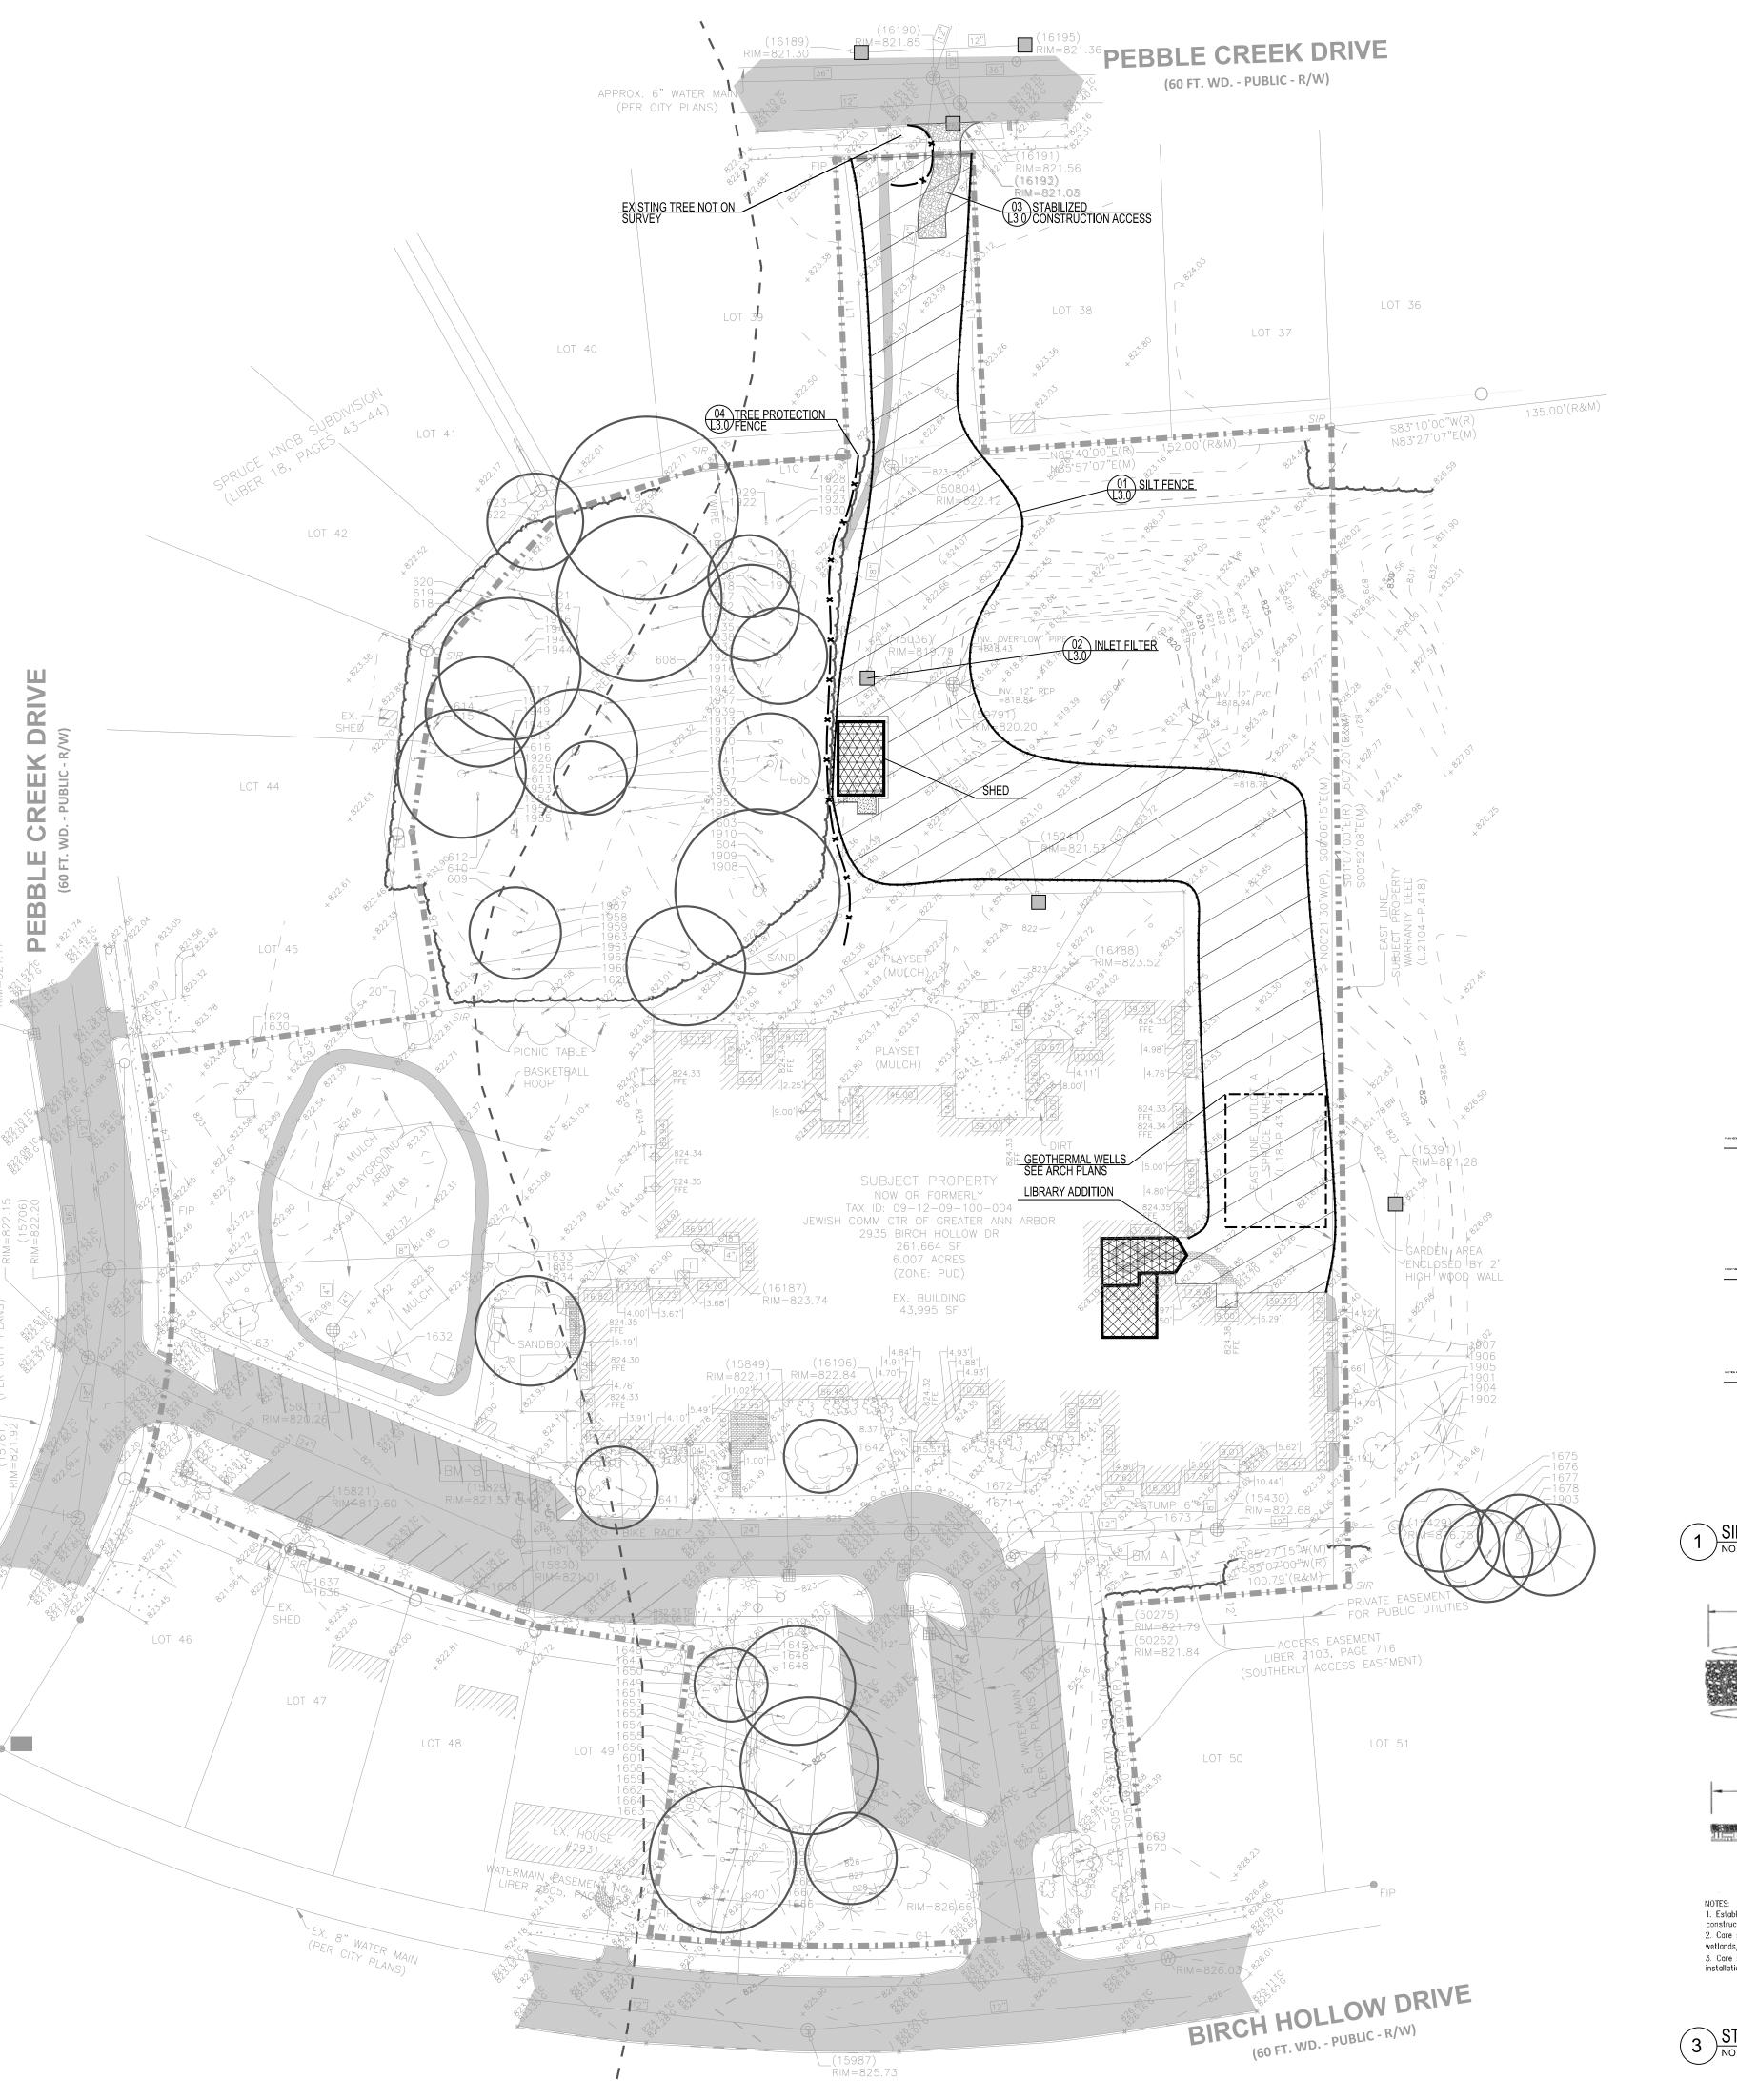 Soil erosion control - 1 Day
 Install inlet filters, tracking surface, silt fence - 1 Day
 Install underground utilities - 4 Weeks
 Building construction - 12 Months Maintain soil erosion control measures as necessary - Ongoing
 Complete construction of buildings - 1 Week 7. Repair any sidewalks damaged during construction - 1 Day 8. Remove temporary erosion controls


## SOIL EROSION COST ESTIMATE

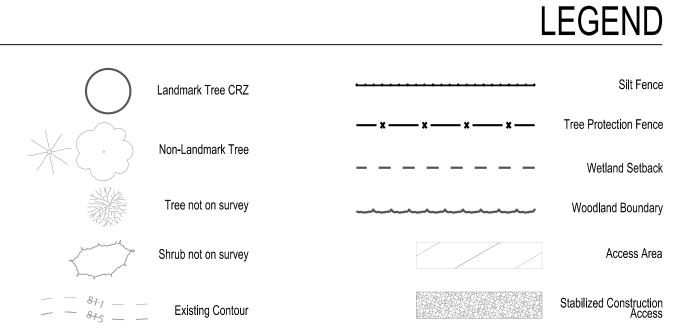SOIL EROSION CONTROL COST ESTIMATE							
					TC	TAL PRICE	
SILT FENCE	1250	LF	\$	2.00	\$	2,500.00	
SILT SACS	7	EA	\$	65.00	\$	455.00	
MUD TRACKING	11	SY	\$	50.00	\$	550.00	
TOTAL					\$	3,505.00	
DROTECTING EXPOS	ED SLIREAC	FS	Γ		ς	2 000 00	, and the second


## NOTES

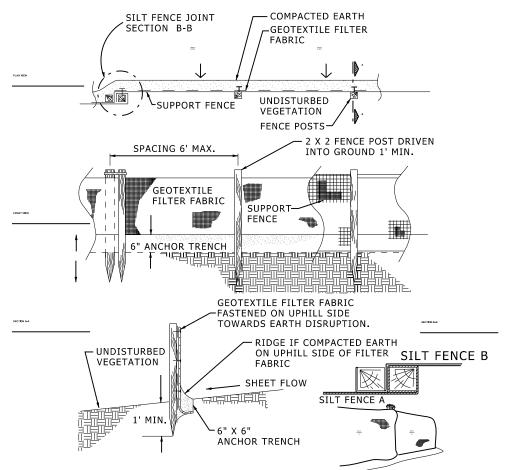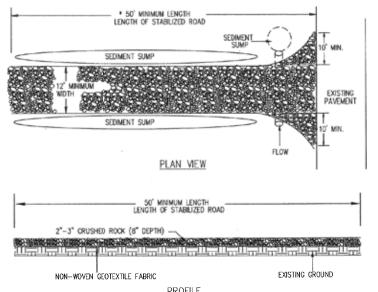 Northernmost property border off of Pebble Creek Drive to be used as construction access.
 Contractor is responsible for restoring any damages to existing sidewalk, road, grass/planted Contractor is responsible for restoring any damages to existing sidewalk, road, grass/planted areas, and culvert due to construction activities.
 Contractor is responsible for erosion and sediment control measures for any disturbed soils.
 Contractor is responsible for dewatering excavated areas.
 See Sheet L1.1: Landscape Plan for permanent seeding rates.
 Monitor silt fence to ensure general flow is not impeded in swale along Rosedale Road.
 Soil Erosion Control Blankets be constructed of Natural or Bio and Photodegradable materials.
 Contractor is responsible for properly installing all tree protection fences, silt fences, and inlet filters to protect existing site features.

Sb - Sebewa, 0 to 2 percent slopes MdA - Matherton Sandy Loam, 0 to 4 percent slopes BnB - Boyer loamy sand, 1 to 6 percent slopes









1. Establish stabilized construction entrance prior to the initiation of site 2. Care should be taken to prevent material movement into adjacent wetlands/waterbodies. Care should be taken to maintain existing roadside drainage via culvert installation, with sediment sump placed downflow of culvert.

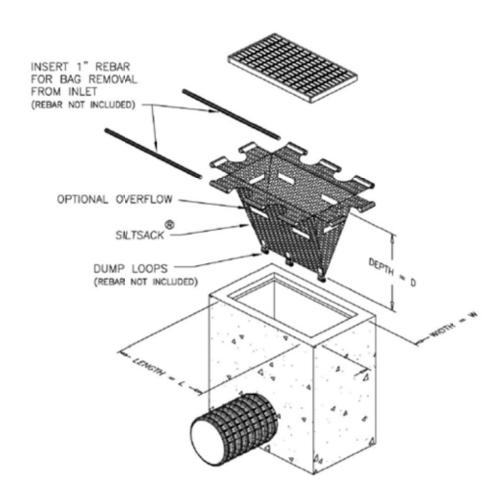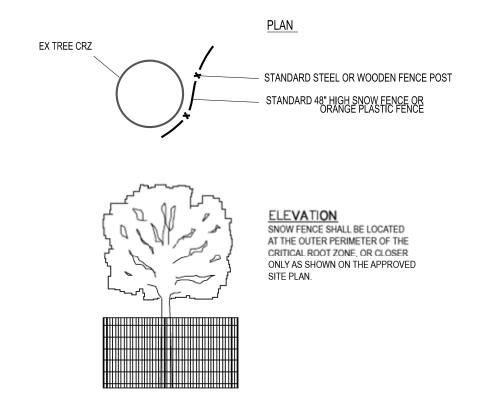3 STABILIZED CONSTRUCTION ACCESS
NO SCALE














412 Longshore Drive Ann Arbor, Michigan

Phone: 734.995.4194 Fax: 734.668.2525



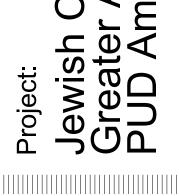According to the NRCS soil survey, the soils on site include:



Date: Issued for: 4/20/2023 Site Plan Submission

Scale: 1" = 40'-0" Drawn by: KT & SGR

Sheet:

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4/20/2023 10:14:34 AM

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## GENERAL NOTES

- REFER TO CIVIL SHEETS FOR ADDITIONAL SITE INFORMATION, GRADING, LAYOUT PARKING QUANTITIES AND DETAILING
- REFER TO LANDSCAPE DRAWINGS FOR LANDSCAPE LOCATIONS, QUANTITIES AND REQUIREMENTS



SCHOO!

DAY

HEBREW

DANIELS

AND ZERMACK

ARCHITECT

2080 S. State Street

O 734.761.2090

F 734.761.6607

REVISIONS

ISSUED FOR XXXXX XX XXX XX

Ann Arbor, MI 48104

Know what's below .

Call before you dig.

## LEGEND

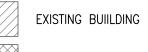
- LIGHT POLE
- FLAG POLE
- SITE SIGNAGE
- ELEC TRANSFORMER
- TELEPHONE RISER
- TRASH DUMPSTER
- RECYCLING DUMPSTER
- UTILITY POLE

- SANITARY MANHOLE
- STORM WATER MANHOLE
- STORM WATER MANHOLE

#### PROPERTY LINE, REFER TO CIVIL

## -OH—ELEC- OVERHEAD UTILITIES

- ----ST--- STORM WATER SEWER
- ----WM---- WATER MAIN
- ----S--- SANITARY SEWER
- ——— FENCE LINE



RENOVATED AREA OF BUILDING

NEW ADDITION TO BUILDING

EXISTING CONCRETE

EXISTING GRAVEL

EXISTING ASPHALT

NEW CONCRETE

NEW LANDSCAPING AREA

EXISTING LANDSCAPE
PAVING/SEMI-PERMEABLE SURFACE

TREE STUMP

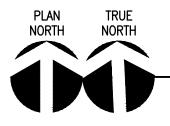


EXISTING TREE

EXISTING SHRUBS



NOT FOR CONSTRUCTION



DIMENSIONAL LAYOUT PLAN SCALE: 1" = 40'-0"

JOB 2022-95 DATE XX XXX XX DRAWN XXX

> CHECKED XXX/XXX DETAIL SYMBOL DETAIL NUMBER

> > REFERENCE SHEET

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DANIELS AND ZERMACK ARCHITECTS 2080 S. State Street Ann Arbor, MI 48104 O 734.761.2090 F 734.761.6607

REVISIONS ISSUED FOR SITE PLAN APPROVAL 20 APRIL 23

JOB 2022-95

DRAWN TL

CHECKED SP

DATE 20 APR 2023

DETAIL SYMBOL

DETAIL NUMBER

NEW TREE

GENERAL NOTES

AND DETAILING

LEGEND

LIGHT POLE

FLAG POLE

SITE SIGNAGE

UTILITY POLE

ELEC TRANSFORMER

TELEPHONE RISER TRASH DUMPSTER

RECYCLING DUMPSTER

SANITARY MANHOLE

STORM WATER MANHOLE

STORM WATER MANHOLE

PROPERTY LINE, REFER TO CIVIL

EXISTING BUILDING

EXISTING CONCRETE

NEW CONCRETE

EXISTING GRAVEL

EXISTING ASPHALT

EXISTING TREE

EXISTING SHRUBS

TREE STUMP

NEW LANDSCAPING AREA

EXISTING LANDSCAPE
PAVING/SEMI-PERMEABLE SURFACE

RENOVATED AREA OF BUILDING

NEW ADDITION TO BUILDING

-OH—ELEC- OVERHEAD UTILITIES

----WM---- WATER MAIN

——O— FENCE LINE

----S---- SANITARY SEWER

----ST--- STORM WATER SEWER

REFER TO CIVIL SHEETS FOR ADDITIONAL SITE

REFER TO LANDSCAPE DRAWINGS FOR LANDSCAPE

LOCATIONS, QUANTITIES AND REQUIREMENTS

INFORMATION, GRADING, LAYOUT PARKING QUANTITIES

Know what's **below** . **Call** before you dig.





PEBBLE CREEK DRIVE

(60 FT. WD. - PUBLIC - R/W)

LOT 37

\_ New \addition\

LOT 50

- RENOVATED INTERIOR SPACE GARDEN AREA ENCLOSED BY 2' HIGH WOOD WALL

LOT 51

BIRCH HOLLOW DRIVE

(60 FT. WD. - PUBLIC - R/W)

30' SETBACKS \_\_ \_

LOT 38

SHED TREE LINE

NEW ACCESSORY

STORAGE BUILDING

NEW CONCRETE SLAB

(50327) RIM=823.53

PLAYSET

(MUĆCH)

PLAYSET

(MULCH)

EXISTING 43,995 SQFT SCHOOL TO RECEIVE PROPOSED ADDITIONS

LOT 39

LOT 40

TREE LINE

EX. HOUSE #2931

LOT 41

LOT 42

EX. SHED

LOT 44

DRIV.

LOT 36

AREA OF GEOTHERMAL WELLS (TO BE VEREIED)

NOT FOR CONSTRUCTION

REFERENCE SHEET

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Ann Arbor, MI 48104 O 734.761.2090 F 734.761.6607

ARCHITECT

2080 S. State Street

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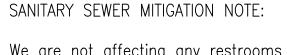
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NOT FOR CONSTRUCTION



UTILITY PLAN



PEBBLE CREEK DRIVE

- APPROX. SANITARY SEWER

(PER, CITY PLANS)

PRIVATE EASEMENT FOR PUBLIC UTILITIES

RIM=821.56 \_(16192)

RIM=821.08 \_(16193)

RIM=821.03
— ACCESS EASEMENT

LOT 38

\_\_(15036) / RIM=819.79 /

SUBJECT PROPERTY
NOW OR FORMERLY

TAX ID: 09-12-09-100-004 JEWISH COMM CTR OF GREATER ANN ARBOR

2935 BIRCH HOLLOW DR 261,664 SF 6.007 ACRES

(ZONE: PUD)

EX. BUILDING 43,995 SF

RIM=826.66

\_(15987) RIM=825.73

(15849)\_ RIM=822.11

RIM=822.84

\_(50791) ŘIM=820.20

\_(15241)

8"S (50327) RIM=823.53

\_(16188) RIM=823.52

LIBER 2103, PAGE 716 (NORTHERLY EASEMENT)

APPROX. 6" WATER MAIN )

(PER CITY PLANS)

LOT 40

LOT 42

LOT 44

LOT 45

EX. SHED

DRIVE (w)

LOT 39

(60 FT. WD. - PUBLIC - R/W)

LOT 37

\_\_INV. 12" PVC =818.78

RIM=822.68

ACCESS EASEMENT
LIBER 2103, PAGE 716
(SOUTHERLY ACCESS EASEMENT)

BIRCH HOLLOW DRIVE

(60 FT. WD. - PUBLIC - R/W)

\_RIM=821.79 \

LOT 50

\_/(50252) / RIM=821.84

LOT 36

ÉAREÀ OF GEØTHERMAL WELLS

∽ (TO BE VERIFIED)

\_(15391) RIM=821.28

PRIVATE EASEMENT
FOR PUBLIC UTILITIES

LOT 51

TECH FELECH = ELECH = EDEC

We are not affecting any restrooms or adding any additional connections to the existing sanitary sewer lines. We do not anticipate a significant increase in occupancy or use that would require changes to be made to the existing sanitary sewer system at this

REFER TO CIVIL SHEETS FOR ADDITIONAL SITE INFORMATION, GRADING, LAYOUT PARKING QUANTITIES AND DETAILING

GENERAL NOTES

REFER TO LANDSCAPE DRAWINGS FOR LANDSCAPE LOCATIONS, QUANTITIES AND REQUIREMENTS



# LEGEND

LIGHT POLE

FLAG POLE

TR

RE

SITE SIGNAGE

ELEC TRANSFORMER TELEPHONE RISER

TRASH DUMPSTER

RECYCLING DUMPSTER

UTILITY POLE

FIRE HYDRANT

CATCH BASIN SANITARY MANHOLE

STORM WATER MANHOLE

STORM WATER MANHOLE

PROPERTY LINE, REFER TO CIVIL

-OH-ELEC- OVERHEAD UTILITIES ----ST--- STORM WATER SEWER

----WM---- WATER MAIN

-----S----- SANITARY SEWER

——O— FENCE LINE

EXISTING BUILDING RENOVATED AREA OF BUILDING

NEW ADDITION TO BUILDING

EXISTING CONCRETE NEW CONCRETE

EXISTING GRAVEL

NEW LANDSCAPING AREA EXISTING LANDSCAPE

PAVING/SEMI-PERMEABLE SURFACE

EXISTING ASPHALT

了 TREE STUMP

EXISTING TREE

EXISTING SHRUBS





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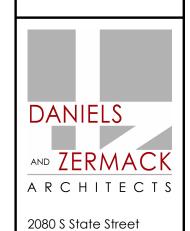
SHED

LOT 47


LOT 48

EX. HOUSE #2931

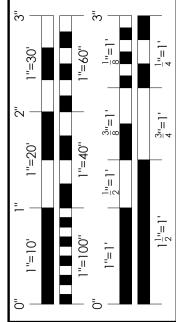WATERMAIN EASEMENT NO. 2. LIBER 2505, PAGE 958



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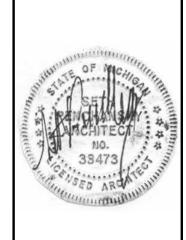


REVISIONS

Revision Desc

No. Revision Description & Date

1 ISSUED FOR SITE PLAN APPROVAL 20 APRIL 2023




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DETAIL SYMBOL

DETAIL NUMBER

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F.A.R. CALCULATIONS NOTE:


The building is currently 43,995 SF with a FAR of 0.17. The proposed addition would add 630 SF to the FAR of the building and 540 SF for the storage shed in the North yard making the new FAR 0.173, a negligable difference.

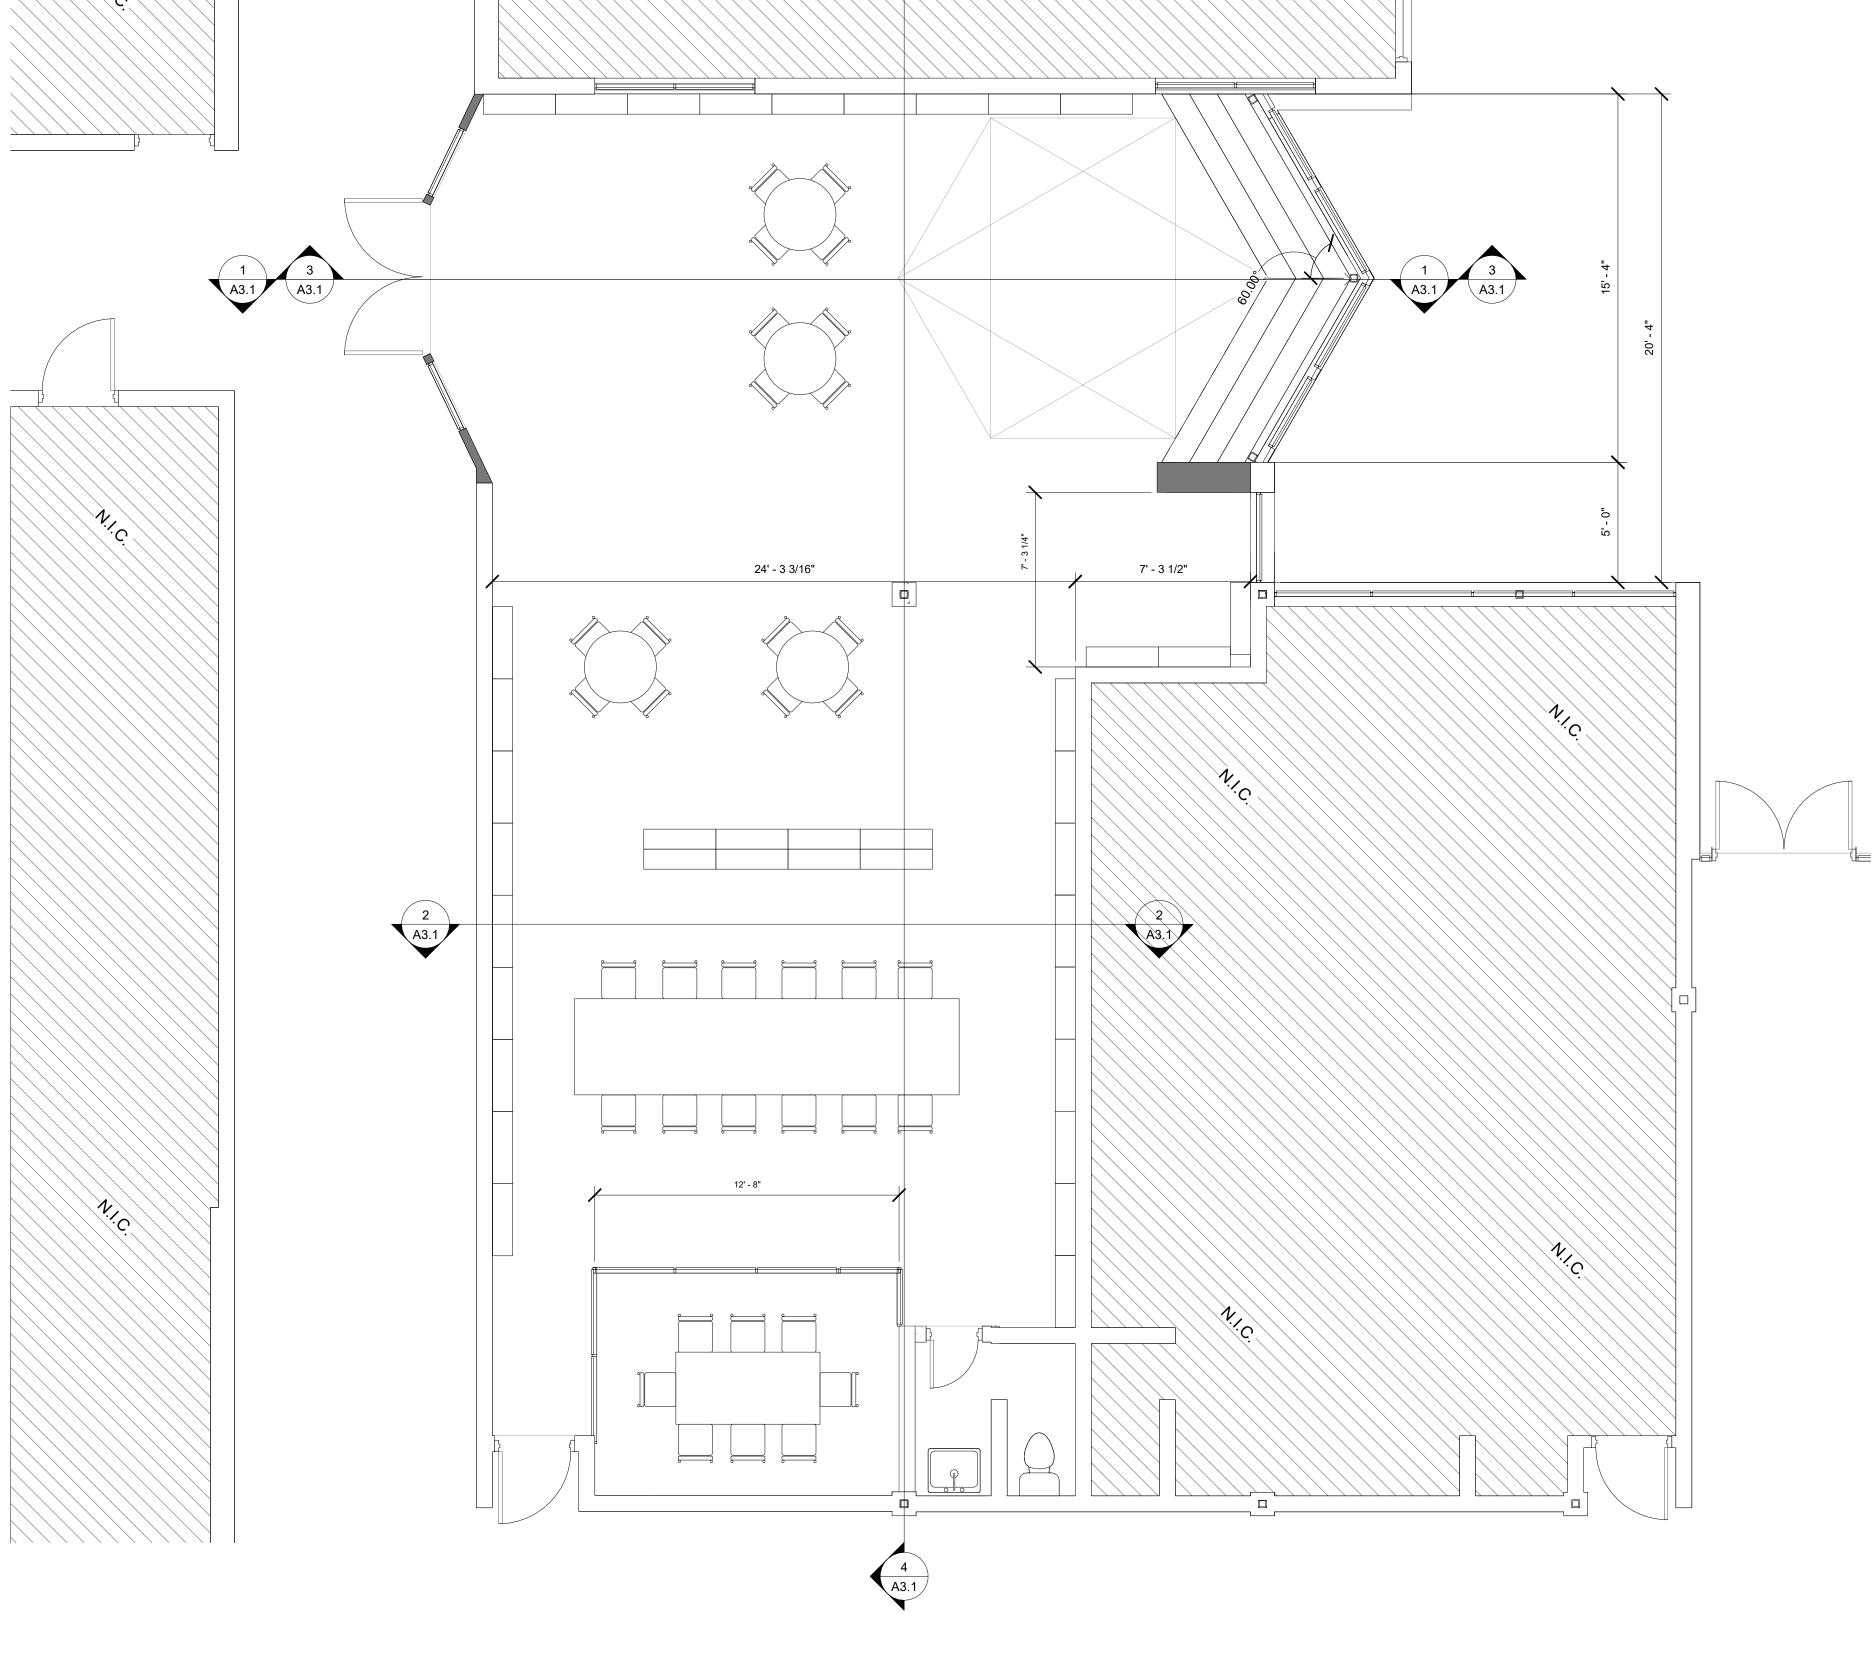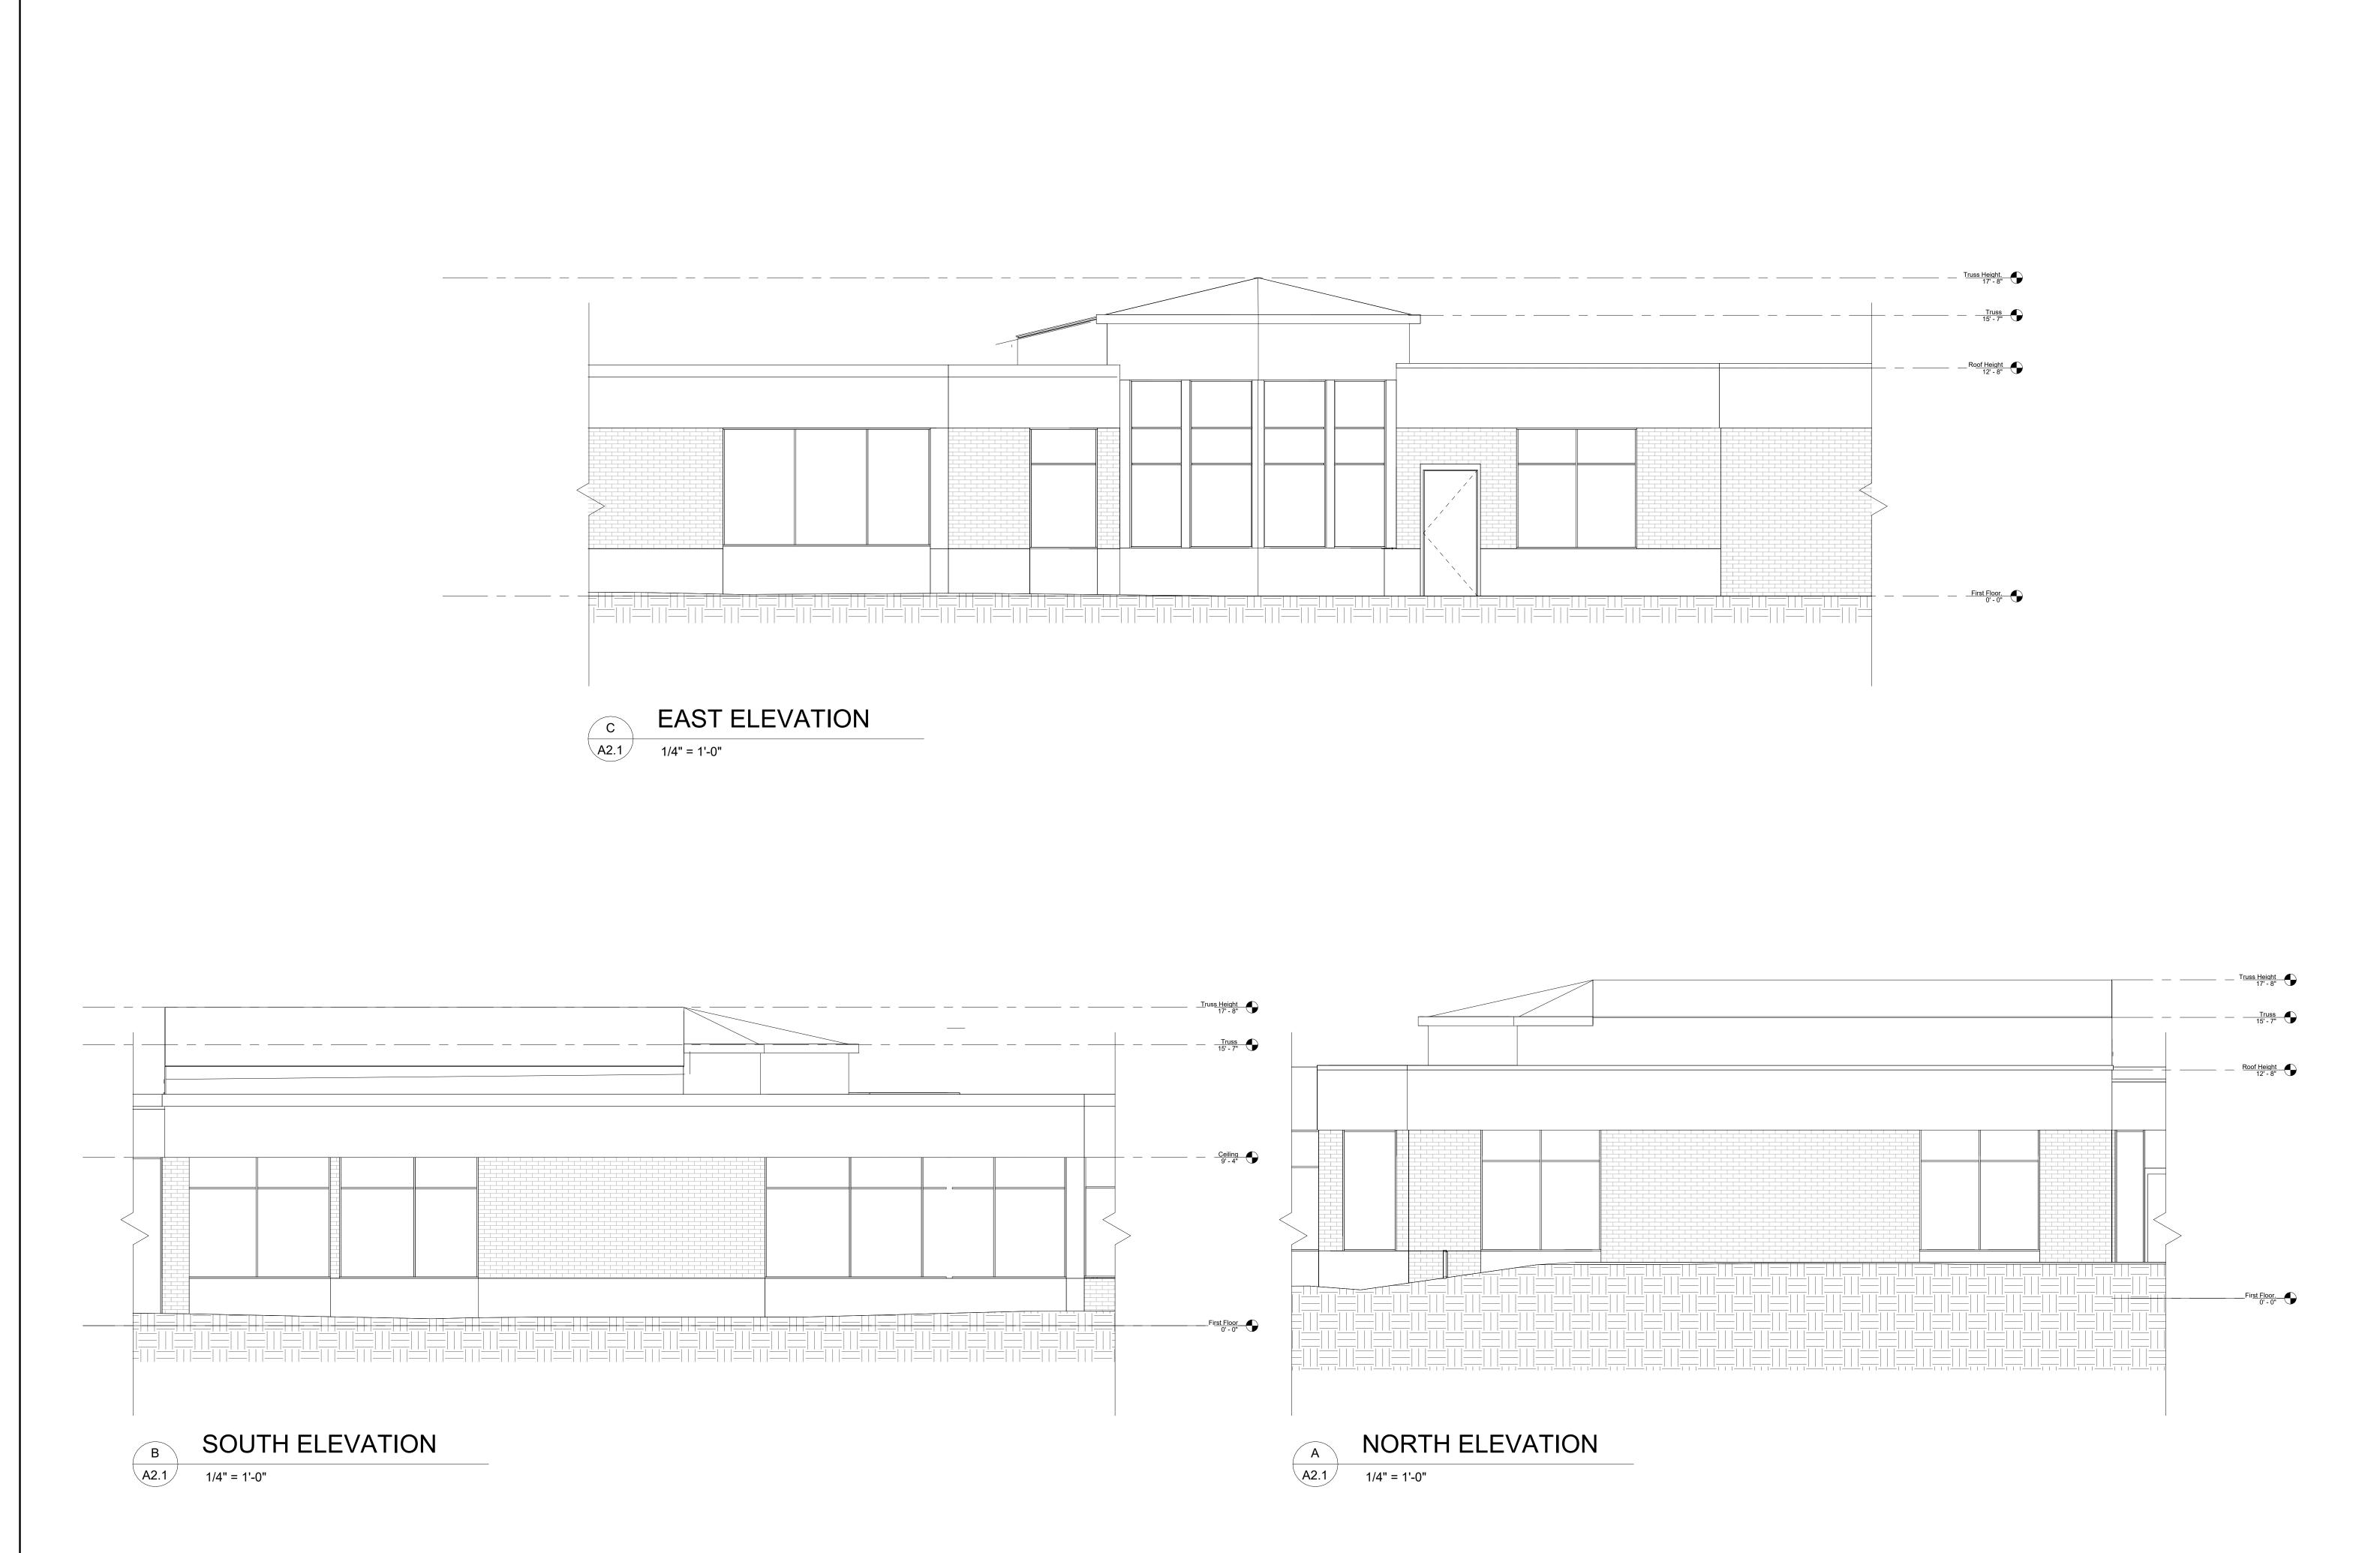FIRST FLOOR PLAN

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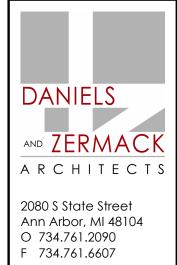
FIRST FLOOR PLAN




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Jewish Comminity Center of Greater Ann Arbo PUD Amendment






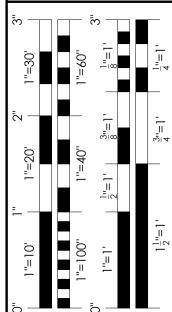REVISIONS

No. Revision Description & Date

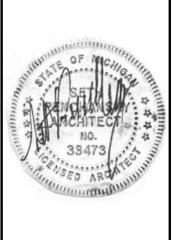1 ISSUED FOR SITE PLAN APPROVAL 20 APRIL 2023



PROJECT:	2022-95				
DATE:	03/16/23				
DRAWN:	HK				
CHECKED:	Checker				
DETAIL SYMBOL					
DETAIL NUMBER					

REFERENCE SHEET

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EXTERIOR ELEVATIONS

DANIELS

AND ZERMACK
ARCHITECTS

2080 S State Street
Ann Arbor, MI 48104
O 734.761.2090
F 734.761.6607

Greater

of

Center

Jewish Comminity PUD Amendment

REVISIONS

No. Revision Description & Date

1 ISSUED FOR SITE PLAN APPROVAL 20 APRIL 2023



PROJECT: 2022-95

DATE: 03/16/23

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DETAIL SYMBOL

DETAIL
NUMBER

REFERENCE
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DANIELS

AND ZERMACK

ARCHITECTS

Date

ISSUED FOR SITE PLAN
APPROVAL 20 APRIL
2023

2080 S State Street Ann Arbor, MI 48104 O 734.761.2090 F 734.761.6607



1 A2.3

3D East Elevation View



2 A2.3 3D North East Elevation View

A2.3

2022-95

03/16/23

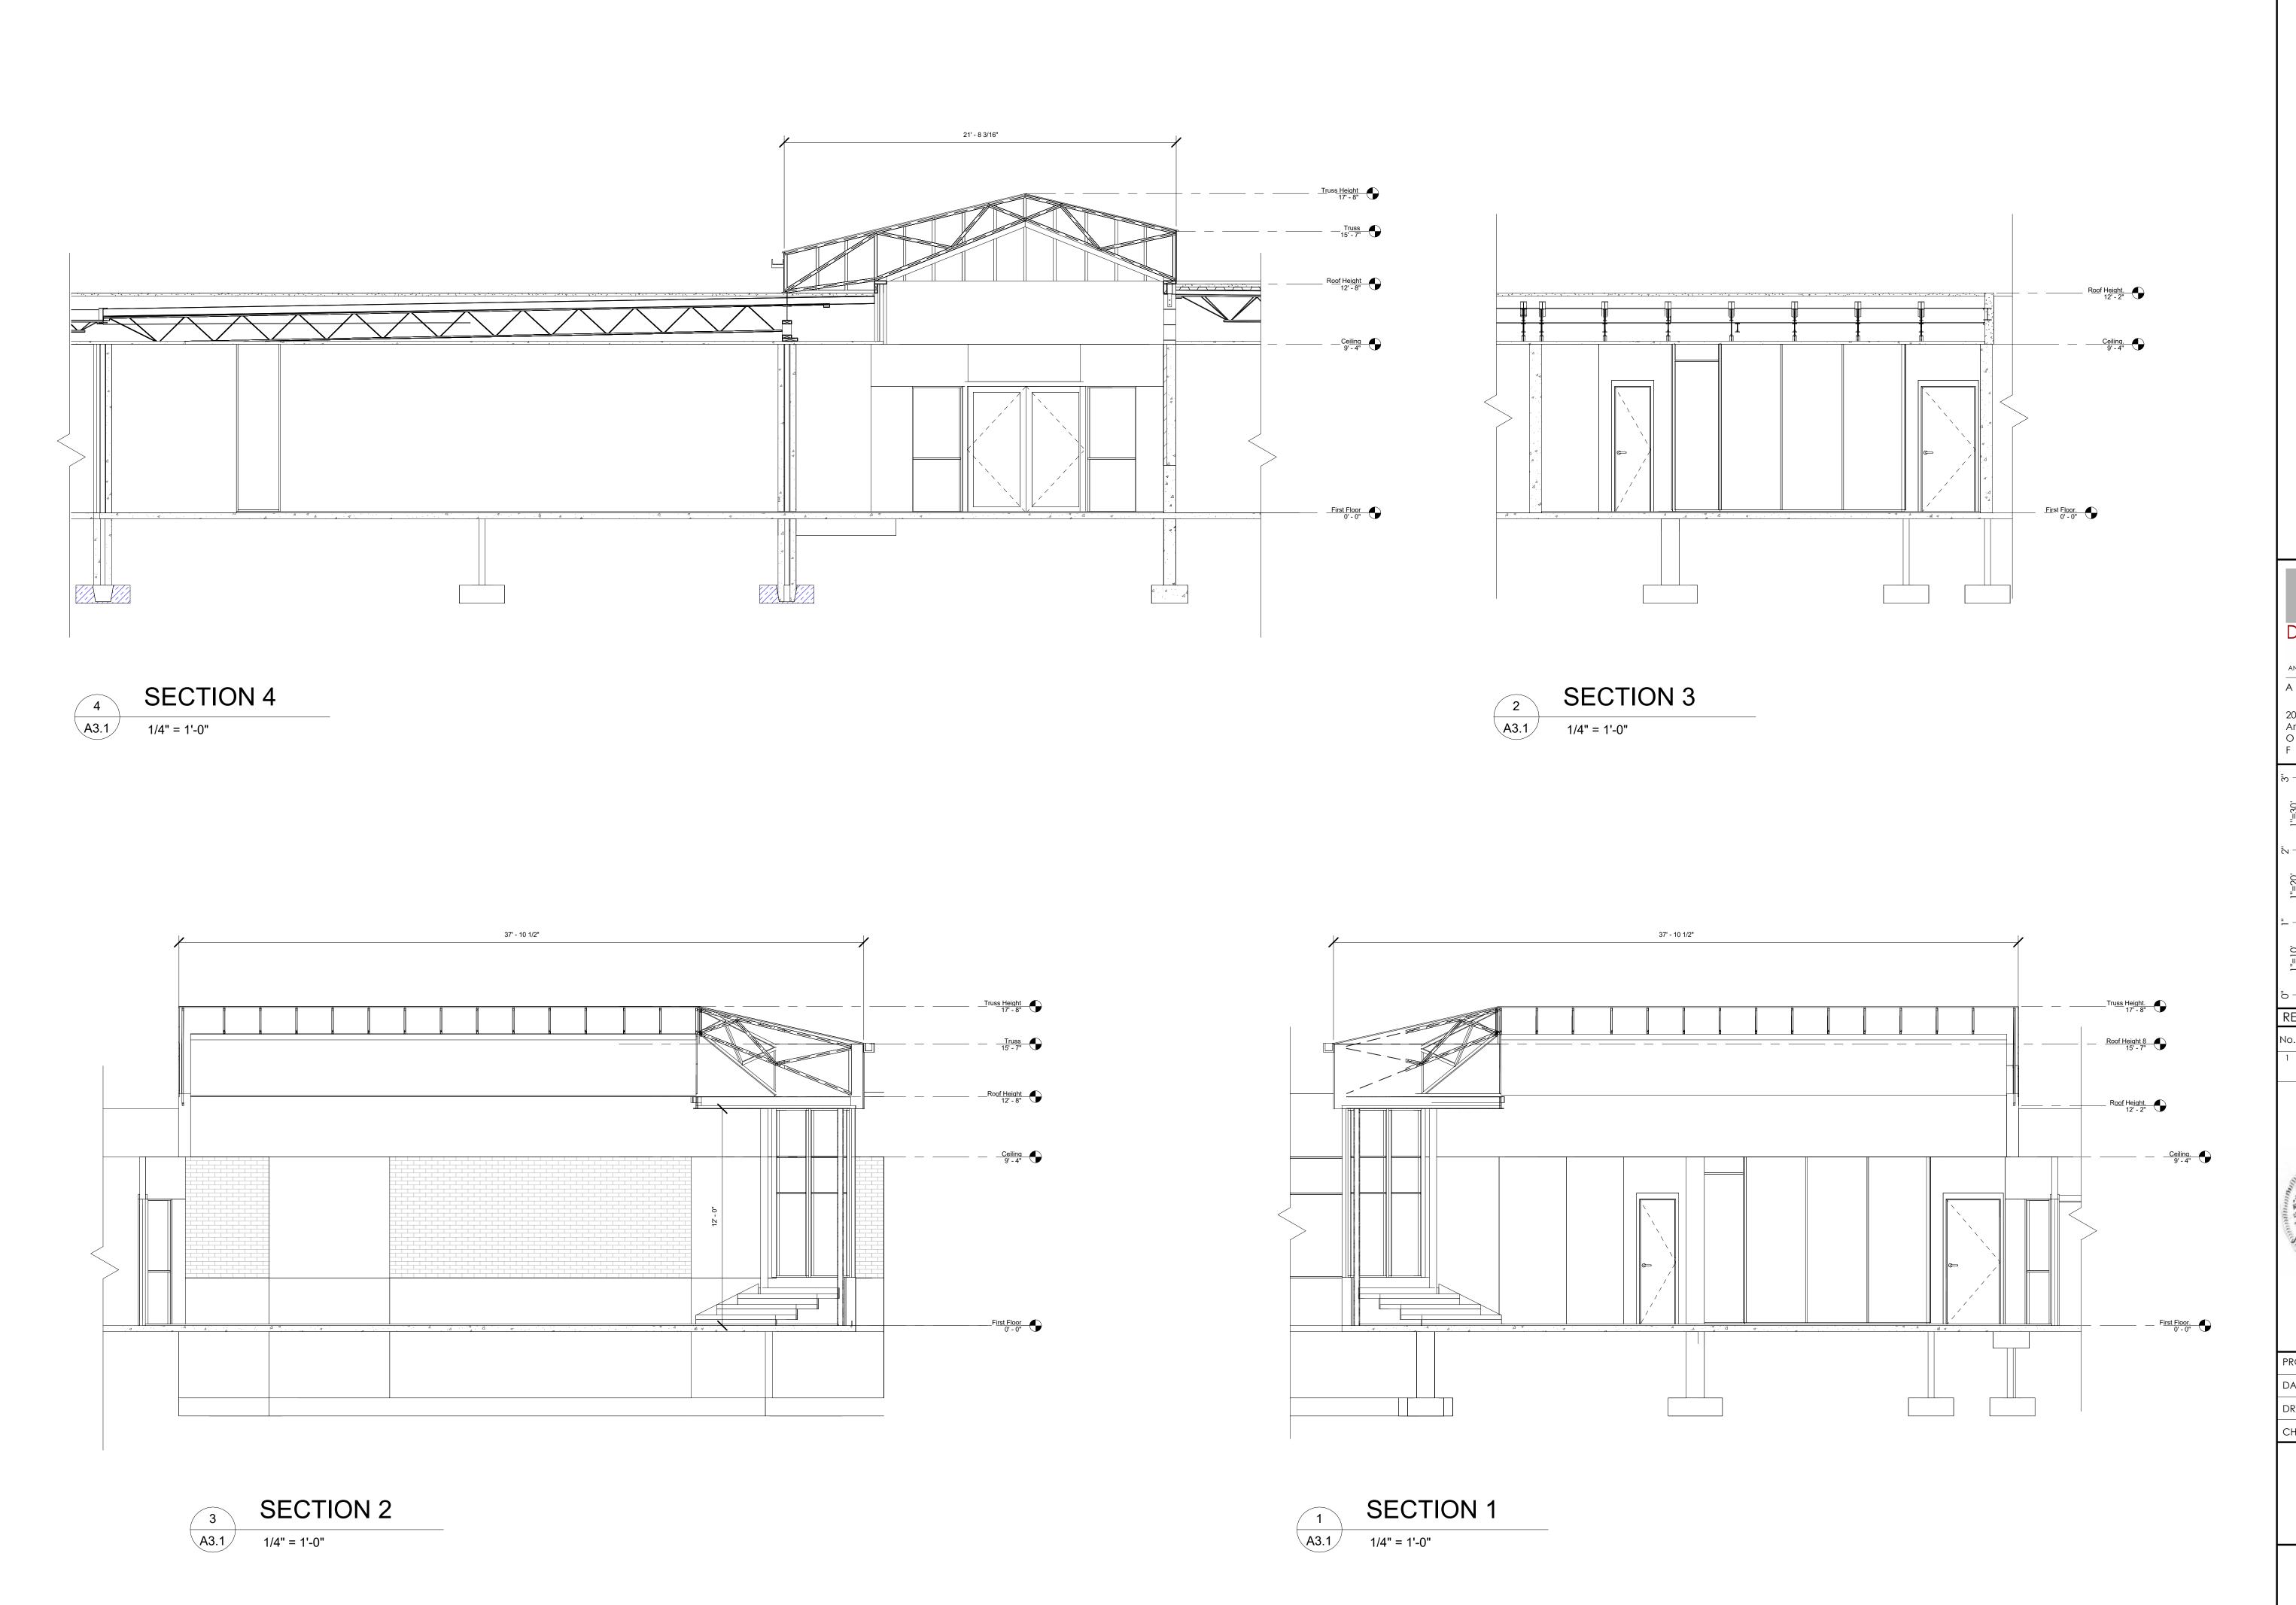
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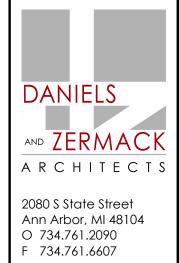
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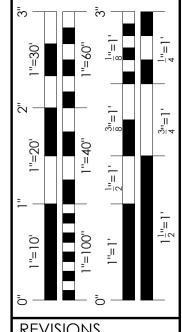
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Jewish Comminity Center of Greater Ann Arb PUD Amendment





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