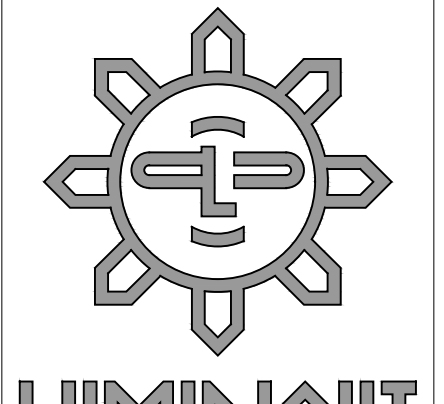


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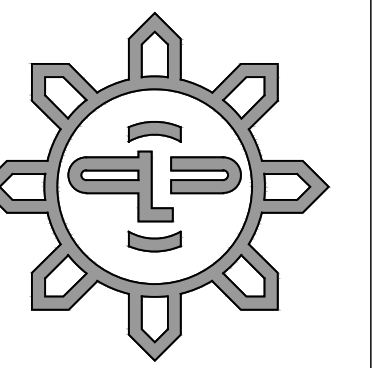
Project Title
**Pavilion at Glacier Hills
IL Conversion Renovation
Detached Garage Addition**
1200 Earhart Rd.
Ann Arbor, Michigan 48106

PRELIMINARY
NOT FOR CONSTRUCTION
This drawing is for review purposes only.

Issue:	Pricing Set	12-09-2022
Revision		

Sheet Title
Architectural Site Plan
Project No. 21006
Drawn By: BL, RA, MB, ALS, BP
Reviewed By: MK, AS, BP
Scale: As Noted
Sheet No.

A0.01



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513.345.8410
Contact: Craig Daugherty

Project Title

Pavilion at Glacier Hills
IL Conversion Renovation
Detached Garage Addition

1200 Earhart Rd.
Ann Arbor, Michigan 48105

PRELIMINARY
NOT FOR CONSTRUCTION

This drawing is for
review purposes only.

Issue: Pricing Set 12-09-2022

Revision

1. Revisions 02.21.2023

Sheet Title

Overall Plan and Elevation

Project No. 21006

Drawn By: BL, RA, MS, ALS

Reviewed By: MK, AS

Scale: As Noted

Sheet No. A1.00

KEYNOTES:

- 1 4" THICK CONCRETE SLAB ON GRADE, WITH 6#6-W2.9W2.9 (2x4) MESH OVER COMPACTED GRANULAR BASE, AND VAPOR BARRIER, CONTRACTION JOINTS AT 10'-0" O.C., MAX. SLOPE SLAB - REFER ALSO TO CIVIL DRAWINGS
- 2 CONTINUOUS 4" HIGH CONCRETE CURB, OCCURS ALONG PERIMETER, AND BETWEEN GARAGE DOOR OPENINGS - REFER TO DETAILS, THIS SHEET
- 3 PRE-FINISHED ALUMINUM DOWNSPOUTS, TYP
- 4 RATED UNIT SEPARATION PARTITION WALL: SILL PLATE SHALL BE (2) PRESSURE TREATED 2X4'S, HOLD OVER 1 1/2" OFF GARAGE SLAB. WALL SHALL BE BUILT ACCORDING TO UL ASSEMBLY U305: 5/8" TYPE-X GWB EACH SIDE OF 2X4 STUDS @ 16" O.C.
- 5 WITHIN THE ATTIC, PROVIDE 5/8" GWB DRAFT STOPPING FROM GYPSUM BOARD CEILING TO UNDERSIDE OF ROOF DECK IN LINE WITH UNIT SEPARATION WALL, BELOW
- 6 PROVIDE 4" CONCRETE WALK - FLUSH WITH GARAGE OPENING (MAX. 1/2" LIFT) OVER GRAVEL BASE
- 7 NEW AUTOMATIC GARAGE DOOR OPENER AND LIGHT KIT
- 8 PROVIDE (1) WATERPROOF EXTERIOR OUTLET AT EACH GARAGE BAY
- 9 3'-0" x 7'-0" 4-PANEL EXTERIOR RATED STEEL ENTRY DOOR (PRE-HUNG) WITH STAINLESS HARDWARE

KEYNOTES: (elevation)

- E1 PREFINISHED ALUM DOWNSPOUTS AND GUTTERS
- E2 CONTINUOUS RIDGE VENT (SHINGLE OVER)
- E3 8'-0" x 7'-0" STEEL GARAGE DOOR (PANELED) WHITE
- E4 1X WRAPPED W/ ALUM FASCIA
- E5 BRICK SOLDIER COURSE
- E6 JAMES ALLEN KENT 14" TALL WALL OUTDOOR SCIENCE - WESTERN BRONZE FINISH - Model: MWNS0720WR2
- E7 EXPOSED CONC. FOUNDATION



SHEET GENERAL NOTES:

- A. ALL DIMENSIONS TO FACE OF STUD, MASONRY OR CENTER OF UNIT SEPARATION WALL
- B. ALL FRAMING DIMENSIONS TO BE VERIFIED BY JOISTS/TRUSS MANUFACTURER
- C. EXTERIOR MATERIALS SHOWN ARE REPRESENTATIVE OF THE ENTIRE ELEVATION
- D. REFER TO SITE / CIVIL DWGS PROVIDED BY OWNER FOR GRADING AND DOWNSPOUT CONNECTIONS TO STORM LINES


EXTERIOR FINISH KEY:

- BR 1 THIN BRICK
BASIS OF DESIGN:
-MFR: BELDEN
-TYPE: 5/8" FLAT BACK
-COLOR: 470-479 DARK RANGE SMOOTH
- LS 1 3" LAP SIDING
BASIS OF DESIGN:
-MFR: JAMES HARDIE
-TYPE: FLAT
-COLOR: PAINT TO MATCH TRIM
- PT 1 EXTERIOR PAINT FOR TRIM AND COLUMNS
BASIS OF DESIGN:
-MFR: SHERWIN WILLIAMS
-TYPE: EGGSHELL - EXTERIOR ACRYLIC
-COLOR: SW7004 - SNOWBOUND
- RS 1 ROOF SHINGLES
BASIS OF DESIGN:
-MFR: TAMKO
-COLOR: ANTIQUE SLATE


KEY PLAN:

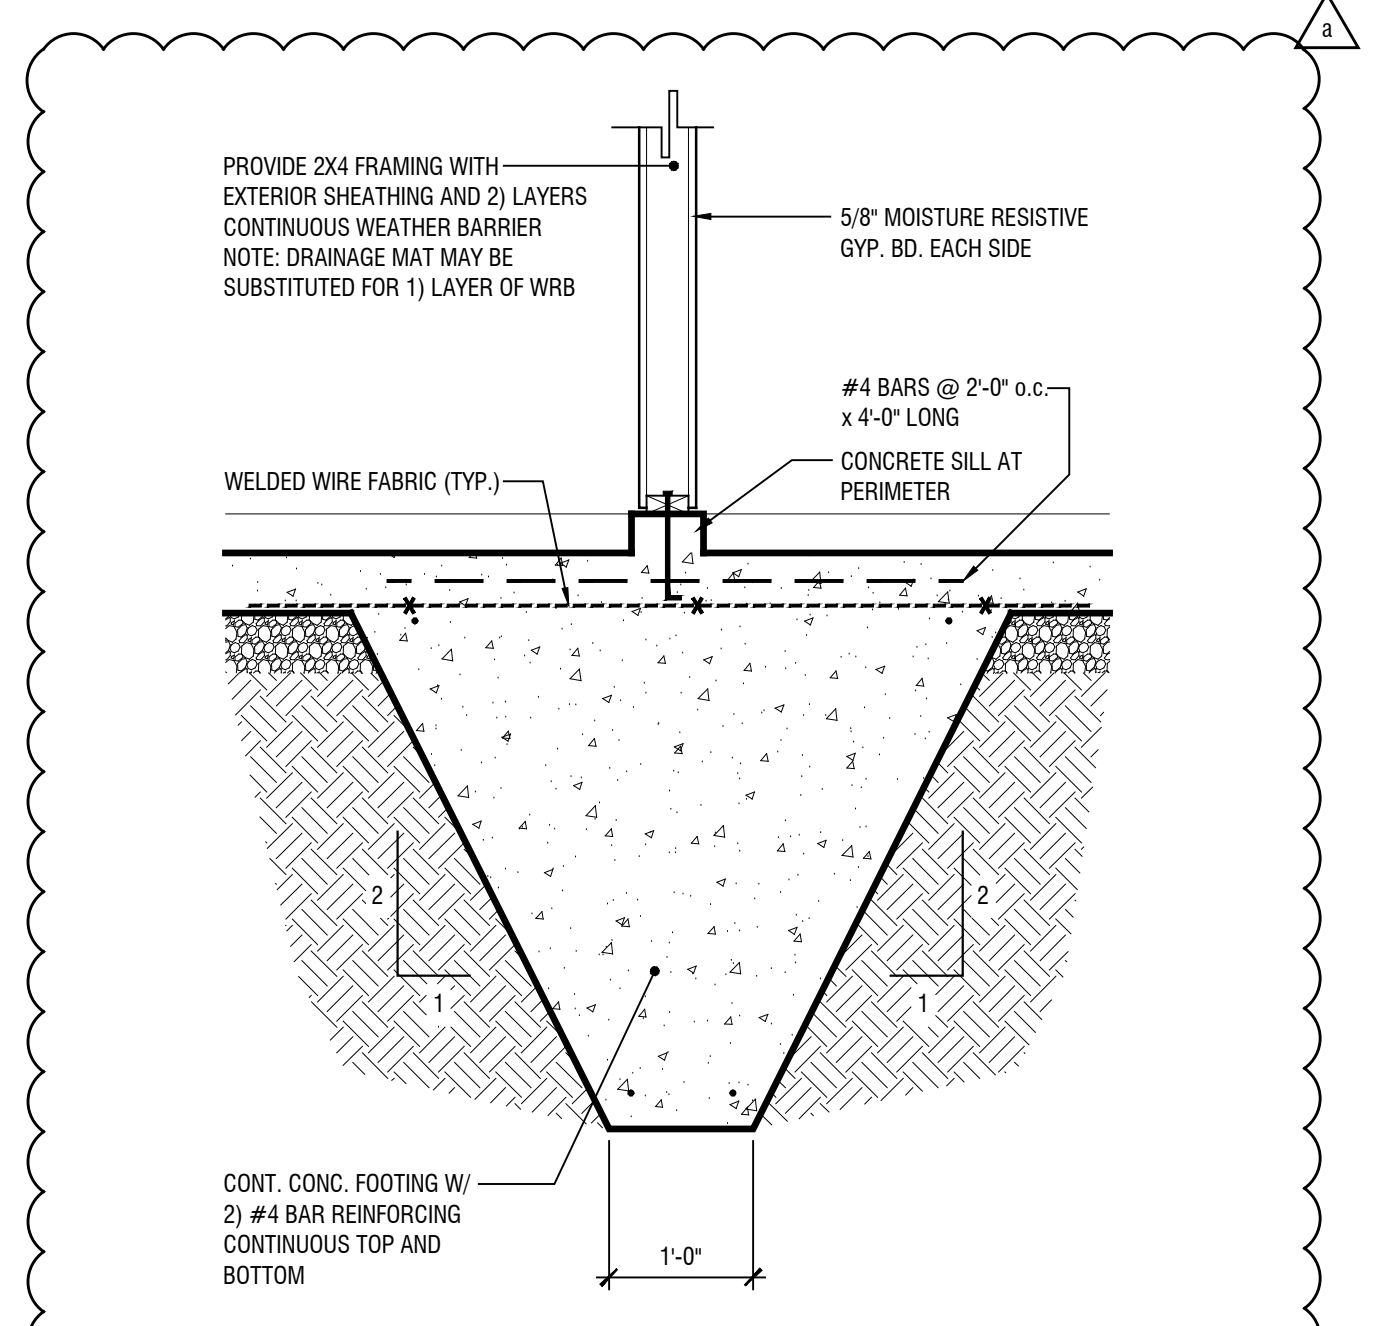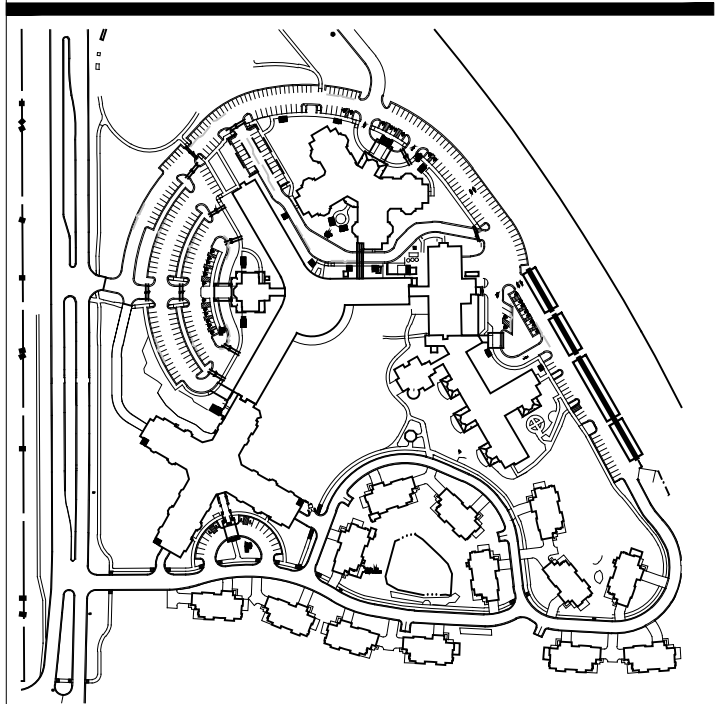


5H DETAIL AT THICKENED SLAB TYP.
A1.00 3/4" = 1'-0"

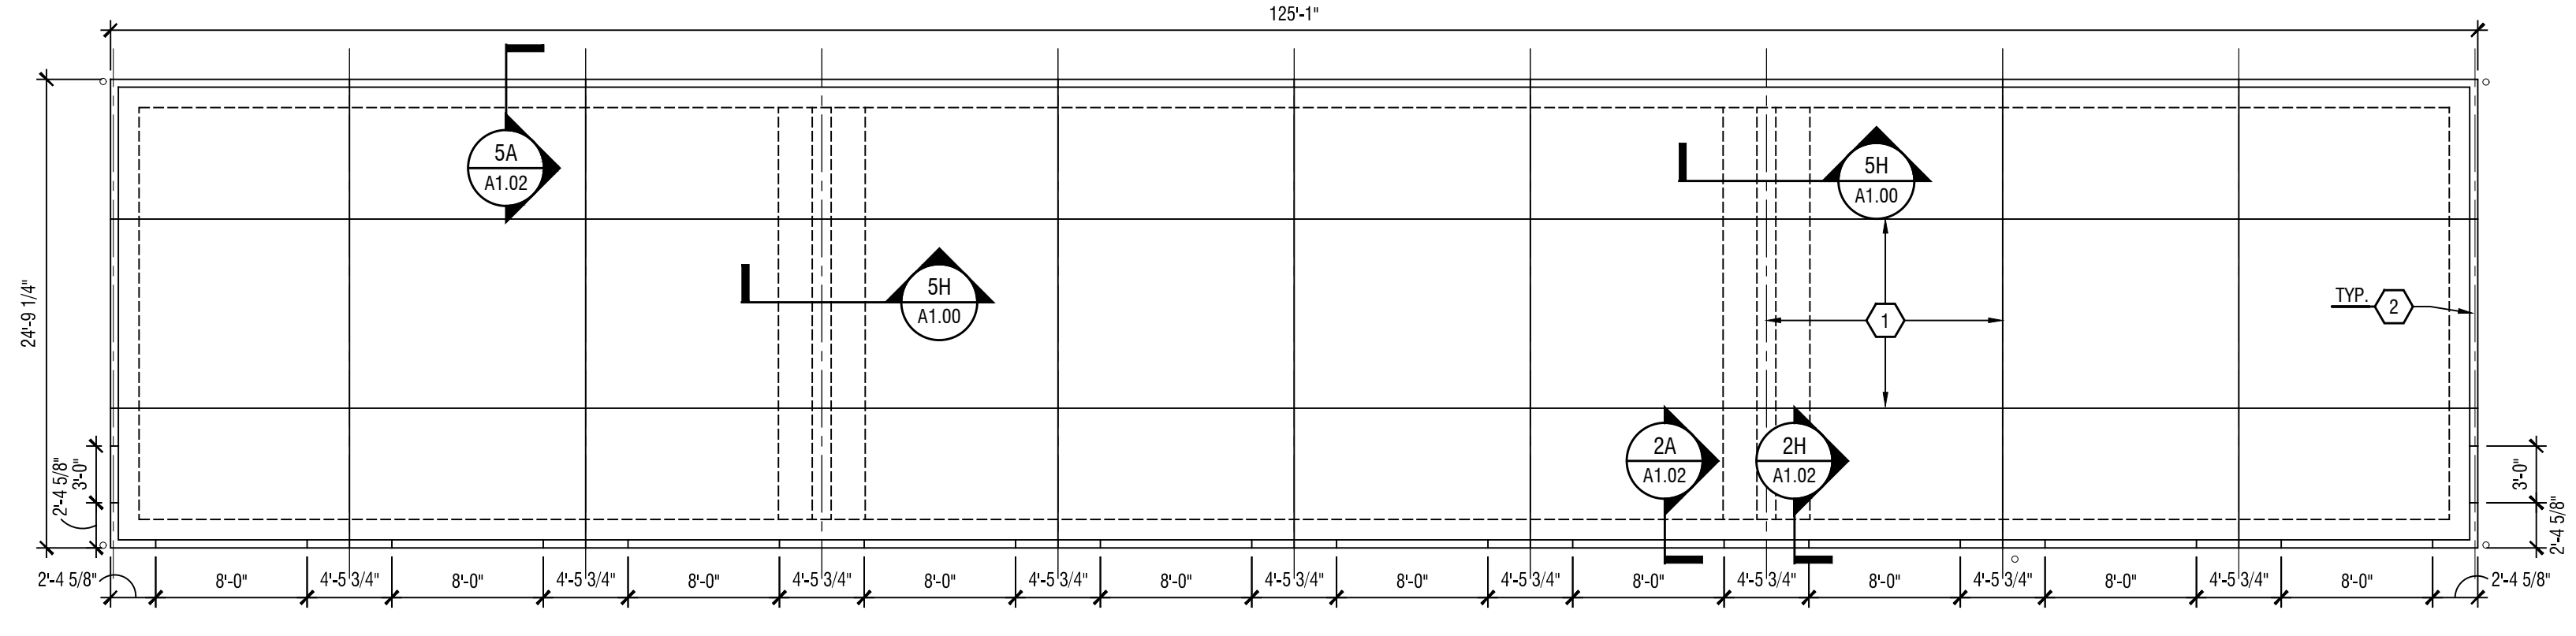


8H FOUNDATION PLAN
A1.00 1/8" = 1'-0"

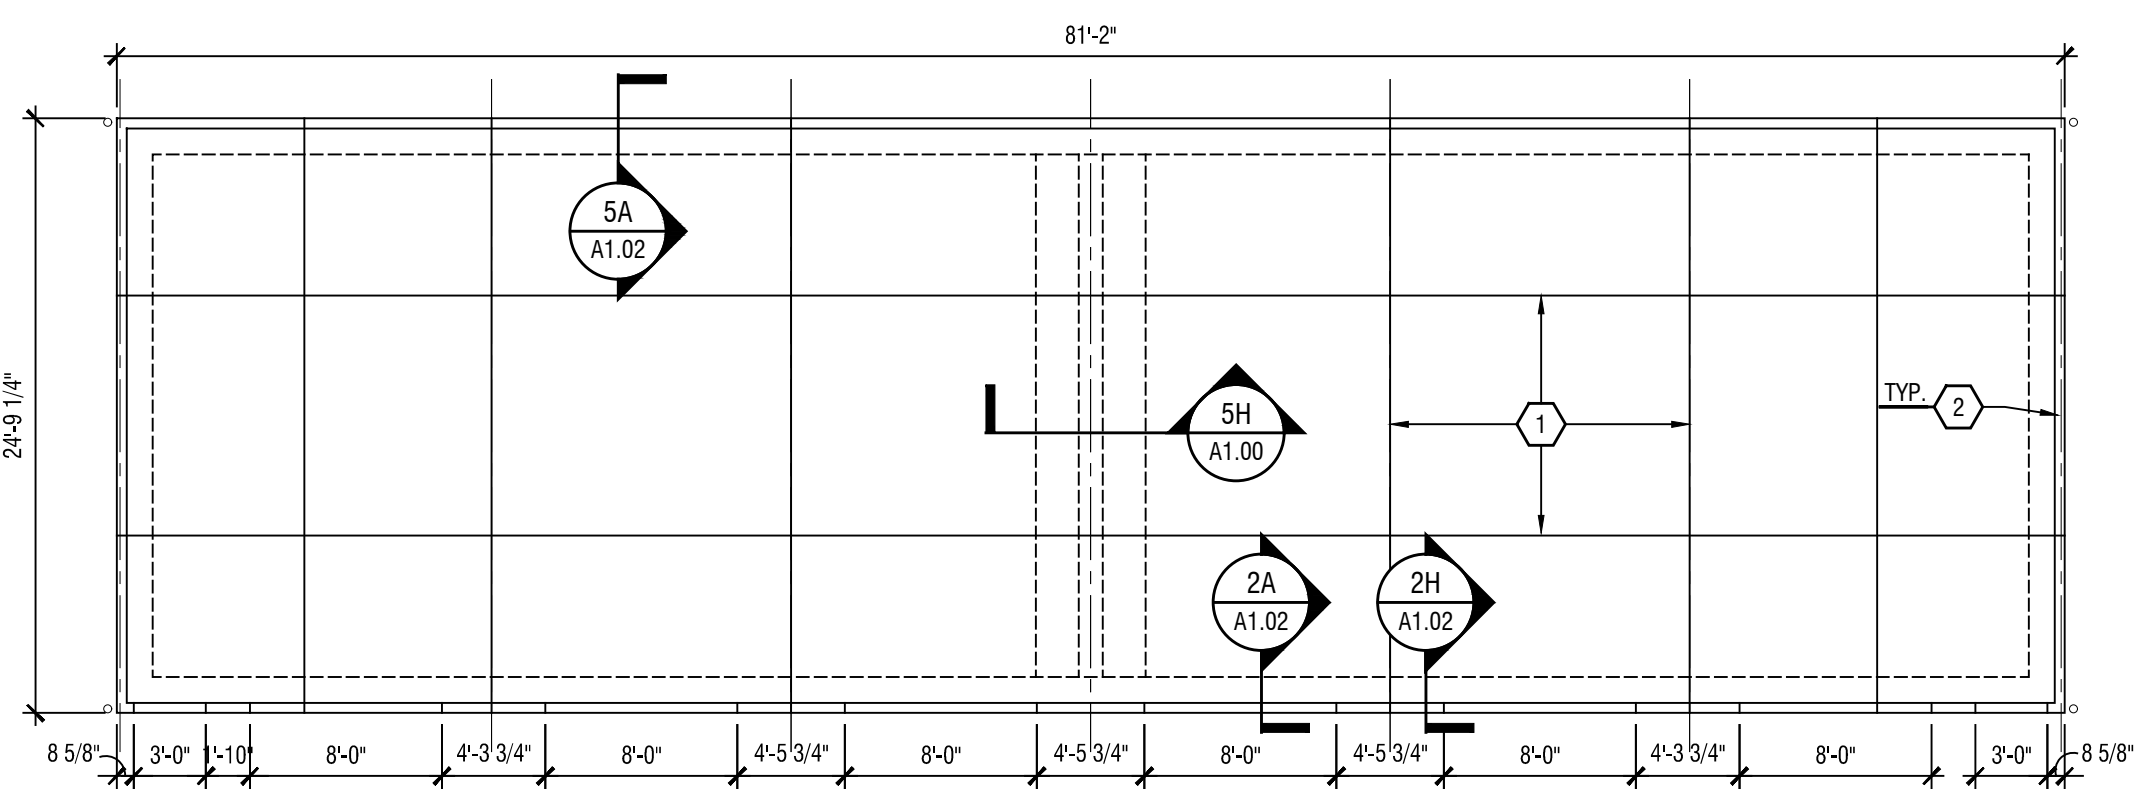


5E FOUNDATION PLAN
A1.00 1/8" = 1'-0"

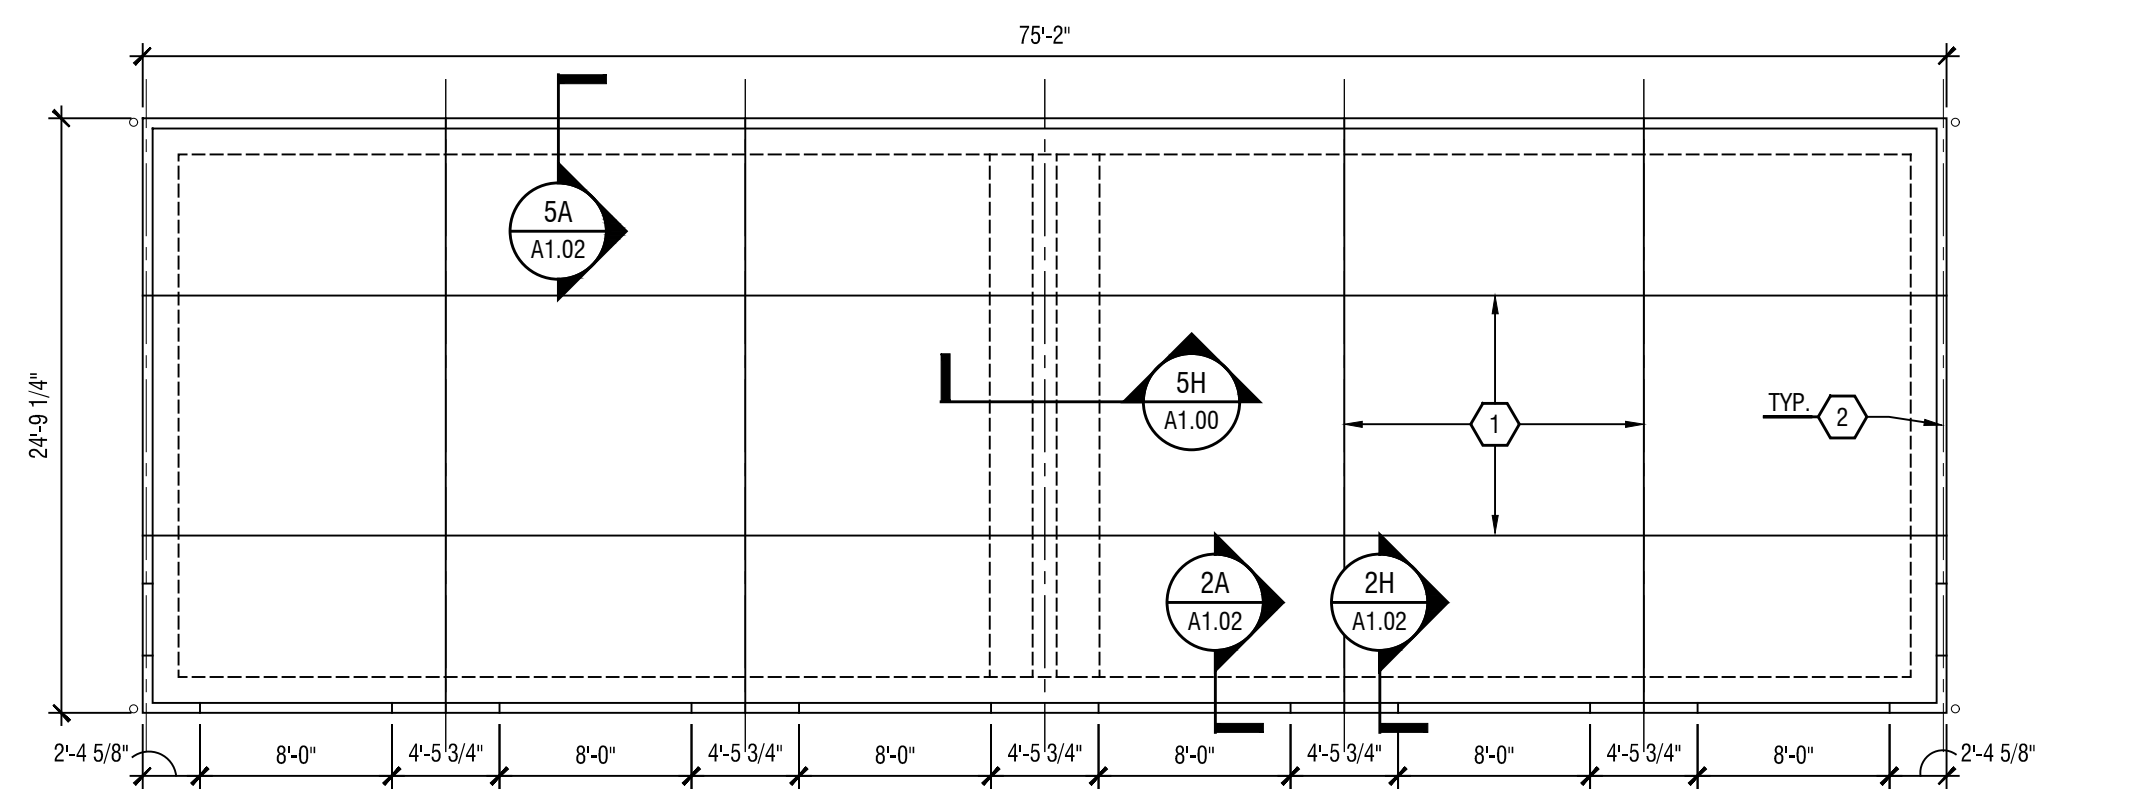

11E FOUNDATION PLAN
A1.00 1/8" = 1'-0"

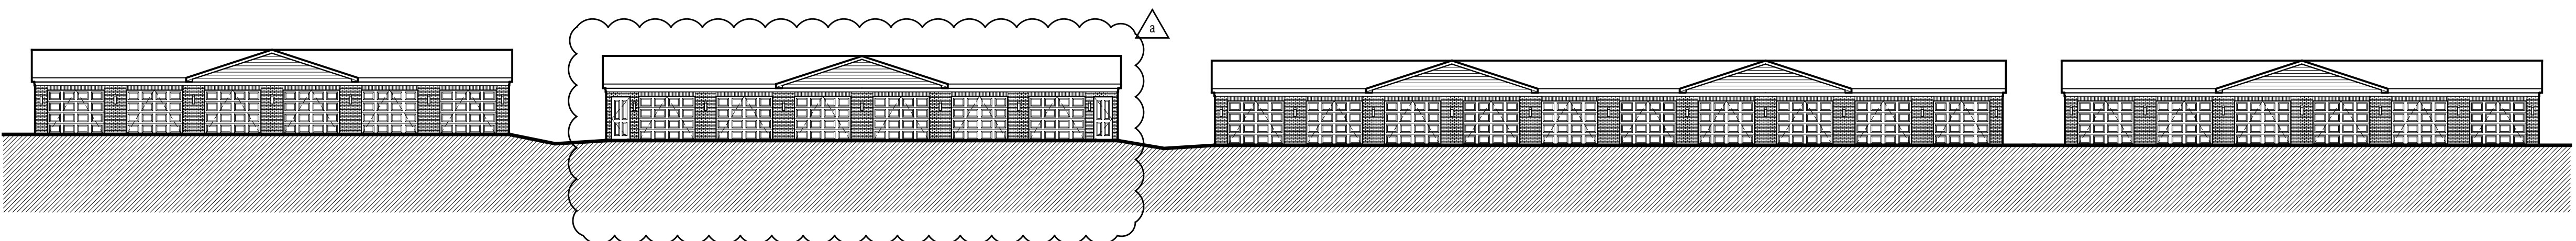

4C OVERALL ELEVATION
A1.00 1/16" = 1'-0"

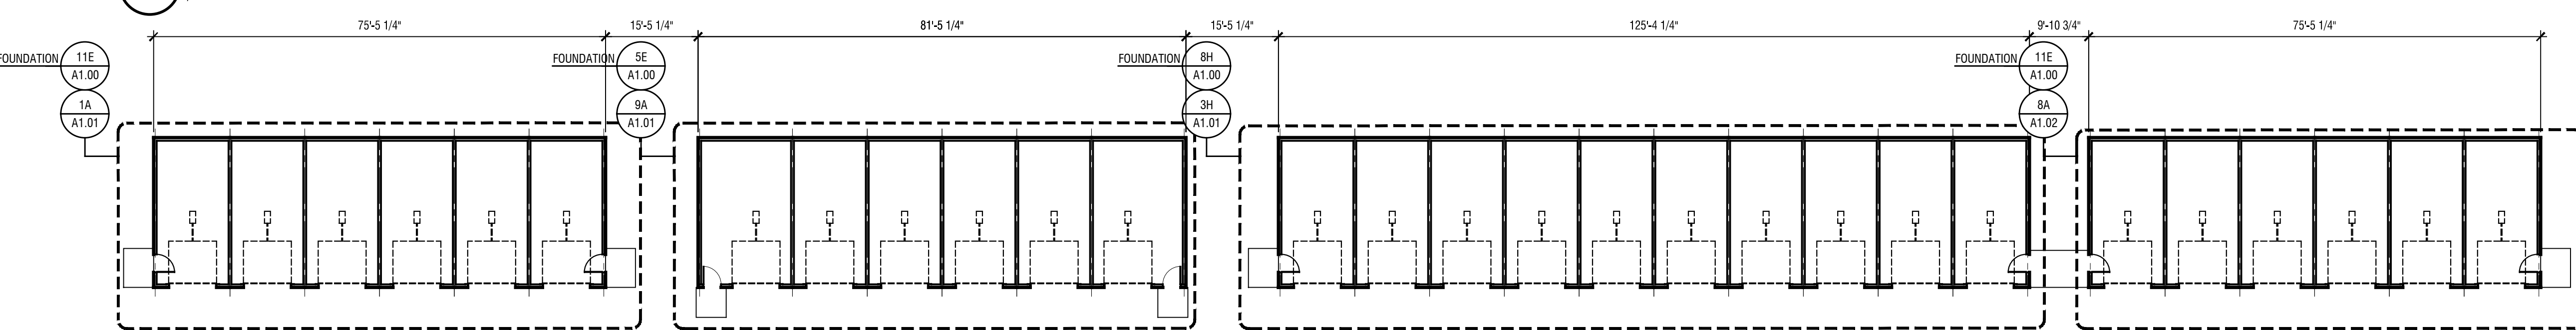

4A OVERALL PLAN
A1.00 1/16" = 1'-0"

COPYRIGHT © 2023 LUMINAUT, INC. - 02/21/2023 3:48 PM - P:\21006 Garage Add. The Pavilion, Conversion\Proj\GarageAdd_0100_OverallPlan.dwg

KEYNOTES:

- 4" THICK CONCRETE SLAB ON GRADE, WITH 6#6-W2.9@2.9 (42#) MESH OVER COMPACTED GRANULAR BASE, AND VAPOR BARRIER, CONTRACTION JOINTS AT 10'-0" O.C., MAX. SLOPE SLAB - REFER ALSO TO CIVIL DRAWINGS
- CONTINUOUS 4" HIGH CONCRETE CURB, OCCURS ALONG PERIMETER, AND BETWEEN GARAGE DOOR OPENINGS - REFER TO DETAILS, THIS SHEET
- PRE-FINISHED ALUMINUM DOWNSPOUTS, TYP.
- RATED UNIT SEPARATION PARTITION WALL:** SILL PLATE SHALL BE (2) PRESSURE TREATED 2X4'S, HOLD OVER 1 1/2" OFF GARAGE SLAB. WALL SHALL BE BUILT ACCORDING TO UL ASSEMBLY U300; 5/8" TYPE-X GWB EACH SIDE OF 2X4 STUDS @ 19" O.C.
- WITHIN THE ATTIC, PROVIDE 5/8" GWB DRAFT STOPPING FROM GYPSUM BOARD CEILING TO UNDERSIDE OF ROOF DECK IN LINE WITH UNIT SEPARATION WALL, BELOW
- PROVIDE 4" CONCRETE WALK - FLUSH WITH GARAGE OPENING (MAX. 1/2" LIFT OVER GRAVEL BASE)
- NEW AUTOMATIC GARAGE DOOR OPENER AND LIGHT KIT
- PROVIDE 1) WATERPROOF EXTERIOR OUTLET AT EACH GARAGE BAY
- 3'-0" x 7'-0" 4-PANEL EXTERIOR RATED STEEL ENTRY DOOR (PRE-HUNG) WITH STAINLESS HARDWARE

KEYNOTES: (elevation)

- PRE-FINISHED ALUM DOWNSPOUTS AND GUTTERS
- CONTINUOUS RIDGE VENT (SHINGLE OVER)
- 8'-0" x 7'-0" STEEL GARAGE DOOR (PANELED) WHITE
- 1X WRAPPED W/ ALUM FASCIA
- BRICK SOLDER COURSE
- JAMES ALLEN KENT 14" TALL WALL OUTDOOR SCIENCE - WESTERN BRONZE FINISH - Model: MANS3720WBR2
- EXPOSED CONC. FOUNDATION

SHEET GENERAL NOTES:

- ALL DIMENSIONS TO FACE OF STUD, MASONRY OR CENTER OF UNIT SEPARATION WALL
- ALL FRAMING DIMENSIONS TO BE VERIFIED BY JOISTS/TRUSS MANUFACTURER
- EXTERIOR MATERIALS SHOWN ARE REPRESENTATIVE OF THE ENTIRE ELEVATION
- REFER TO CIVIL DWGS PROVIDED BY OWNER FOR GRADING AND DOWNSPOUT CONNECTIONS TO STORM LINES



EXTERIOR FINISH KEY:

BR 1 1 THIN BRICK
BASIS OF DESIGN:
-MFR: BELDEN
-TYPE: 5/8" FLAT BACK
-COLOR: 470-479 DARK RANGE SMOOTH


LS 1 1 3" LAP SIDING
BASIS OF DESIGN:
-MFR: JAMES HARDIE
-TYPE: FLAT
-COLOR: PAINT TO MATCH TRIM

PT 1 1 EXTERIOR PAINT FOR TRIM AND COLUMNS
BASIS OF DESIGN:
-MFR: SHERWIN WILLIAMS
-TYPE: EGGSHELL - EXTERIOR ACRYLIC
-COLOR: SW7004 - SNOWBOUND


RS 1 1 ROOF SHINGLES
BASIS OF DESIGN:
-MFR: TAMKO
-COLOR: ANTIQUE SLATE

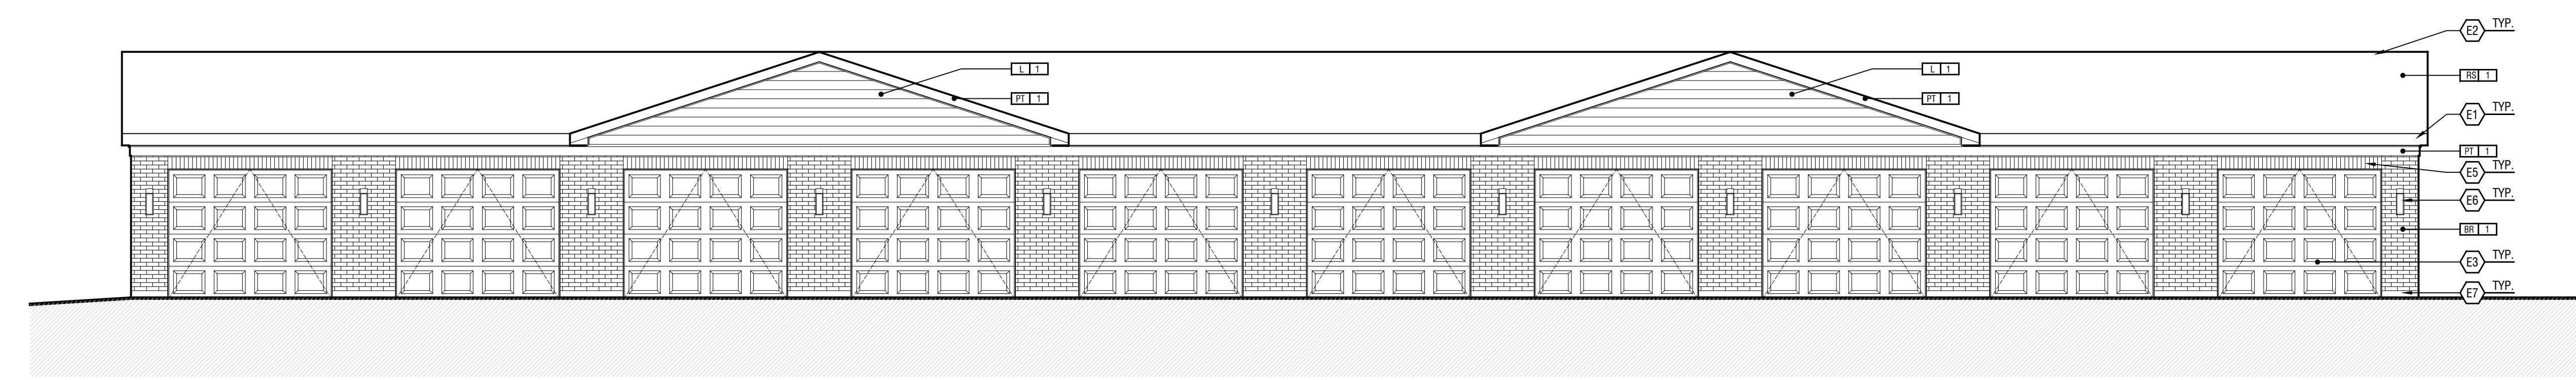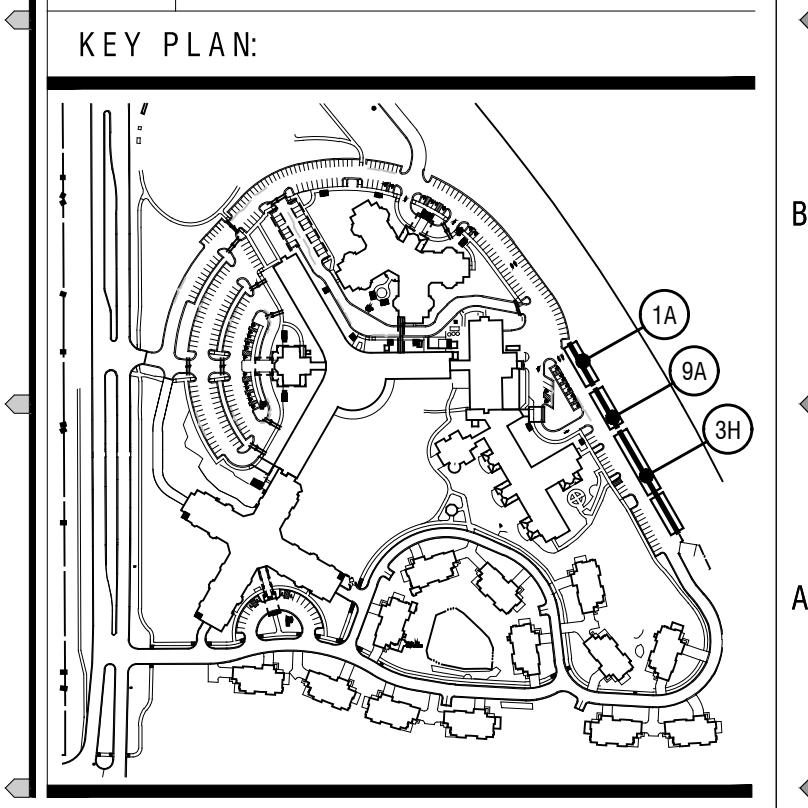

3M ELEVATION - BUILDING 03
A1.01 3/16" = 1'-0"


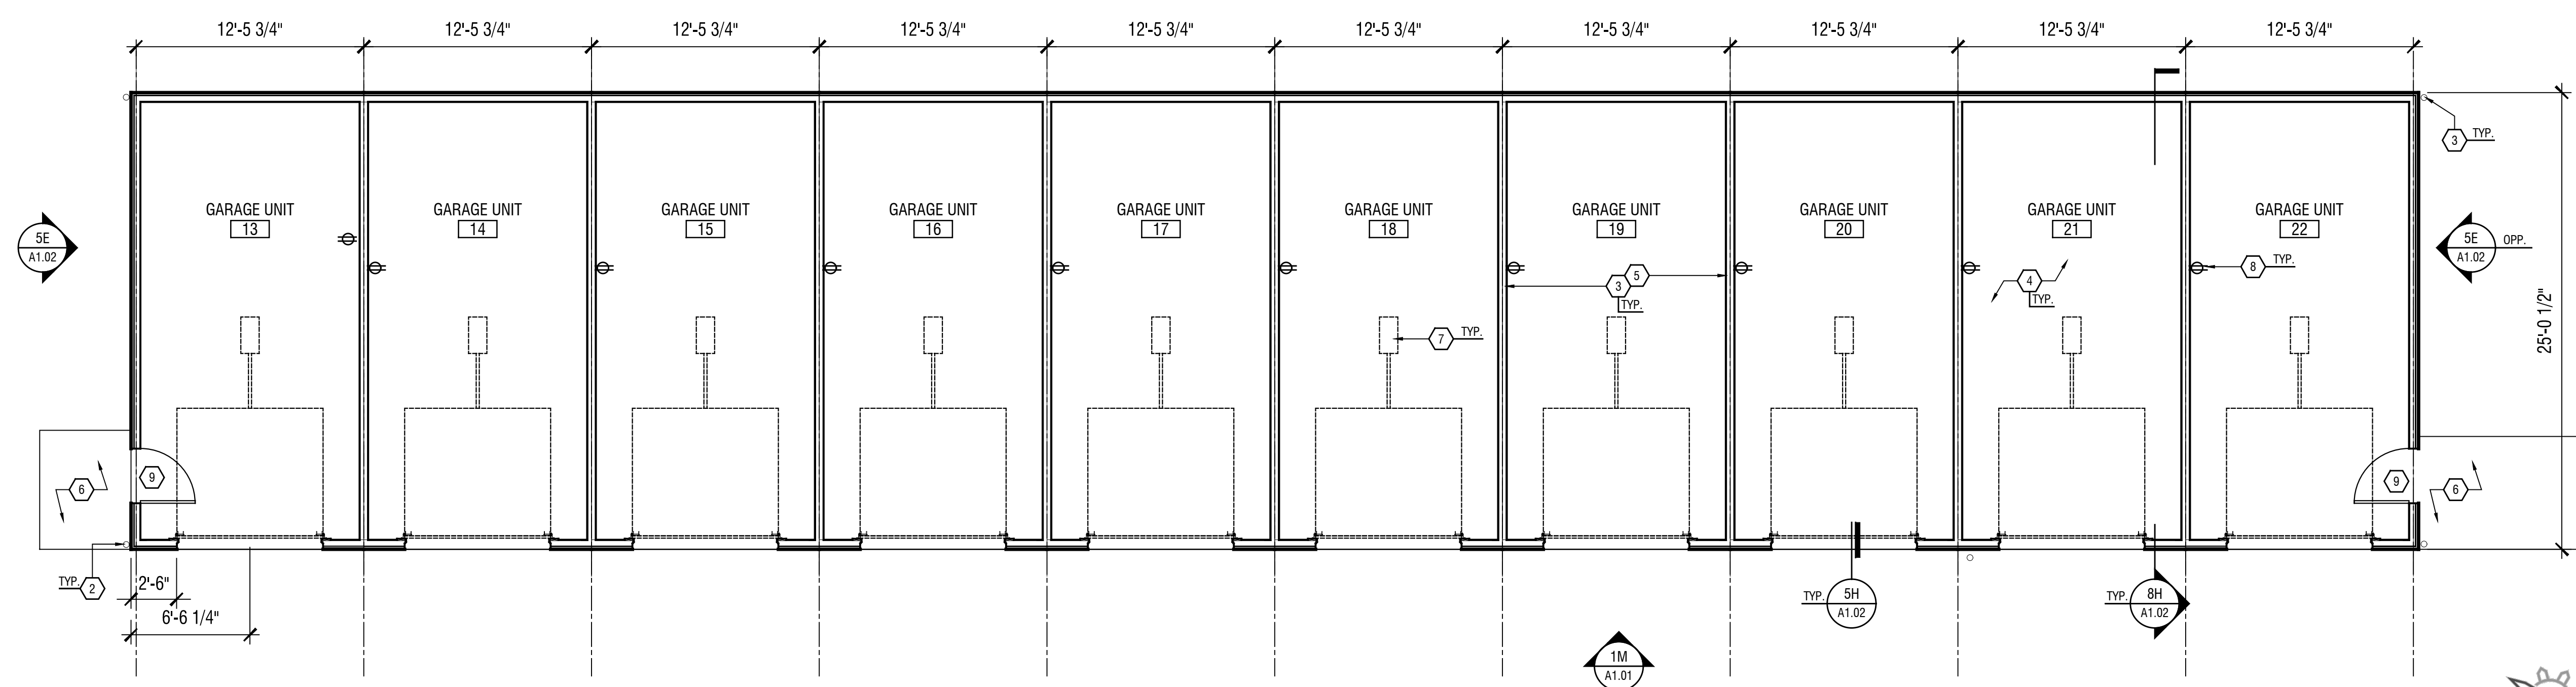


3H FLOOR PLAN - BUILDING 03
A1.01 3/16" = 1'-0"

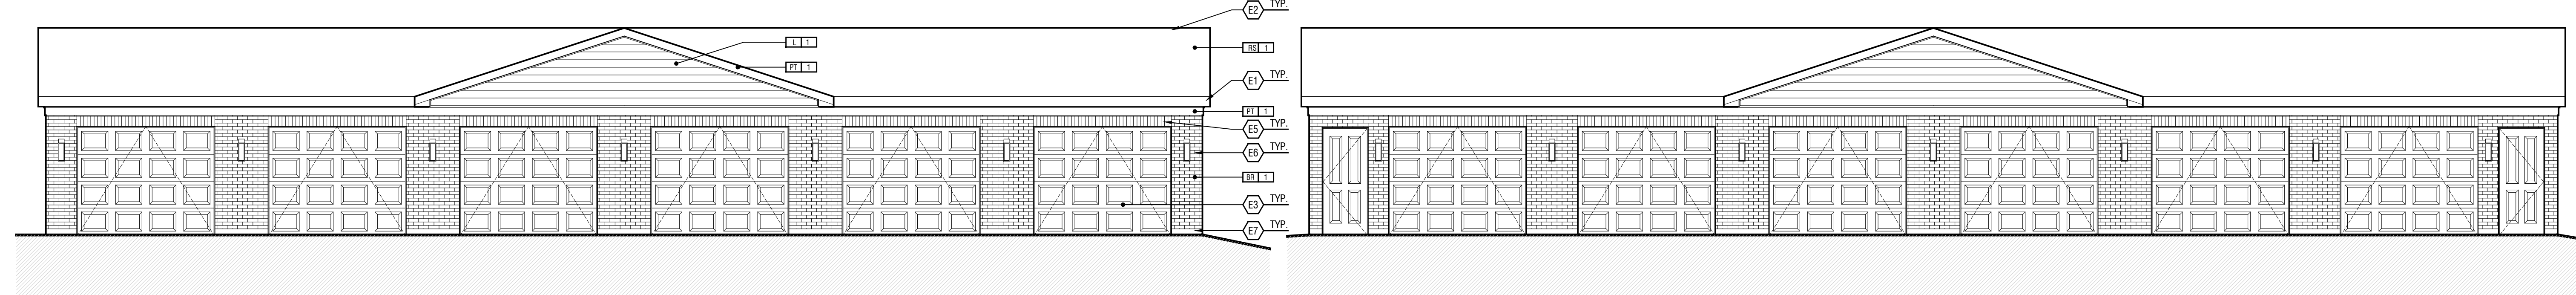


1E ELEVATION - BUILDING 01
A1.01 3/16" = 1'-0"

9E ELEVATION - BUILDING 02
A1.01 3/16" = 1'-0"

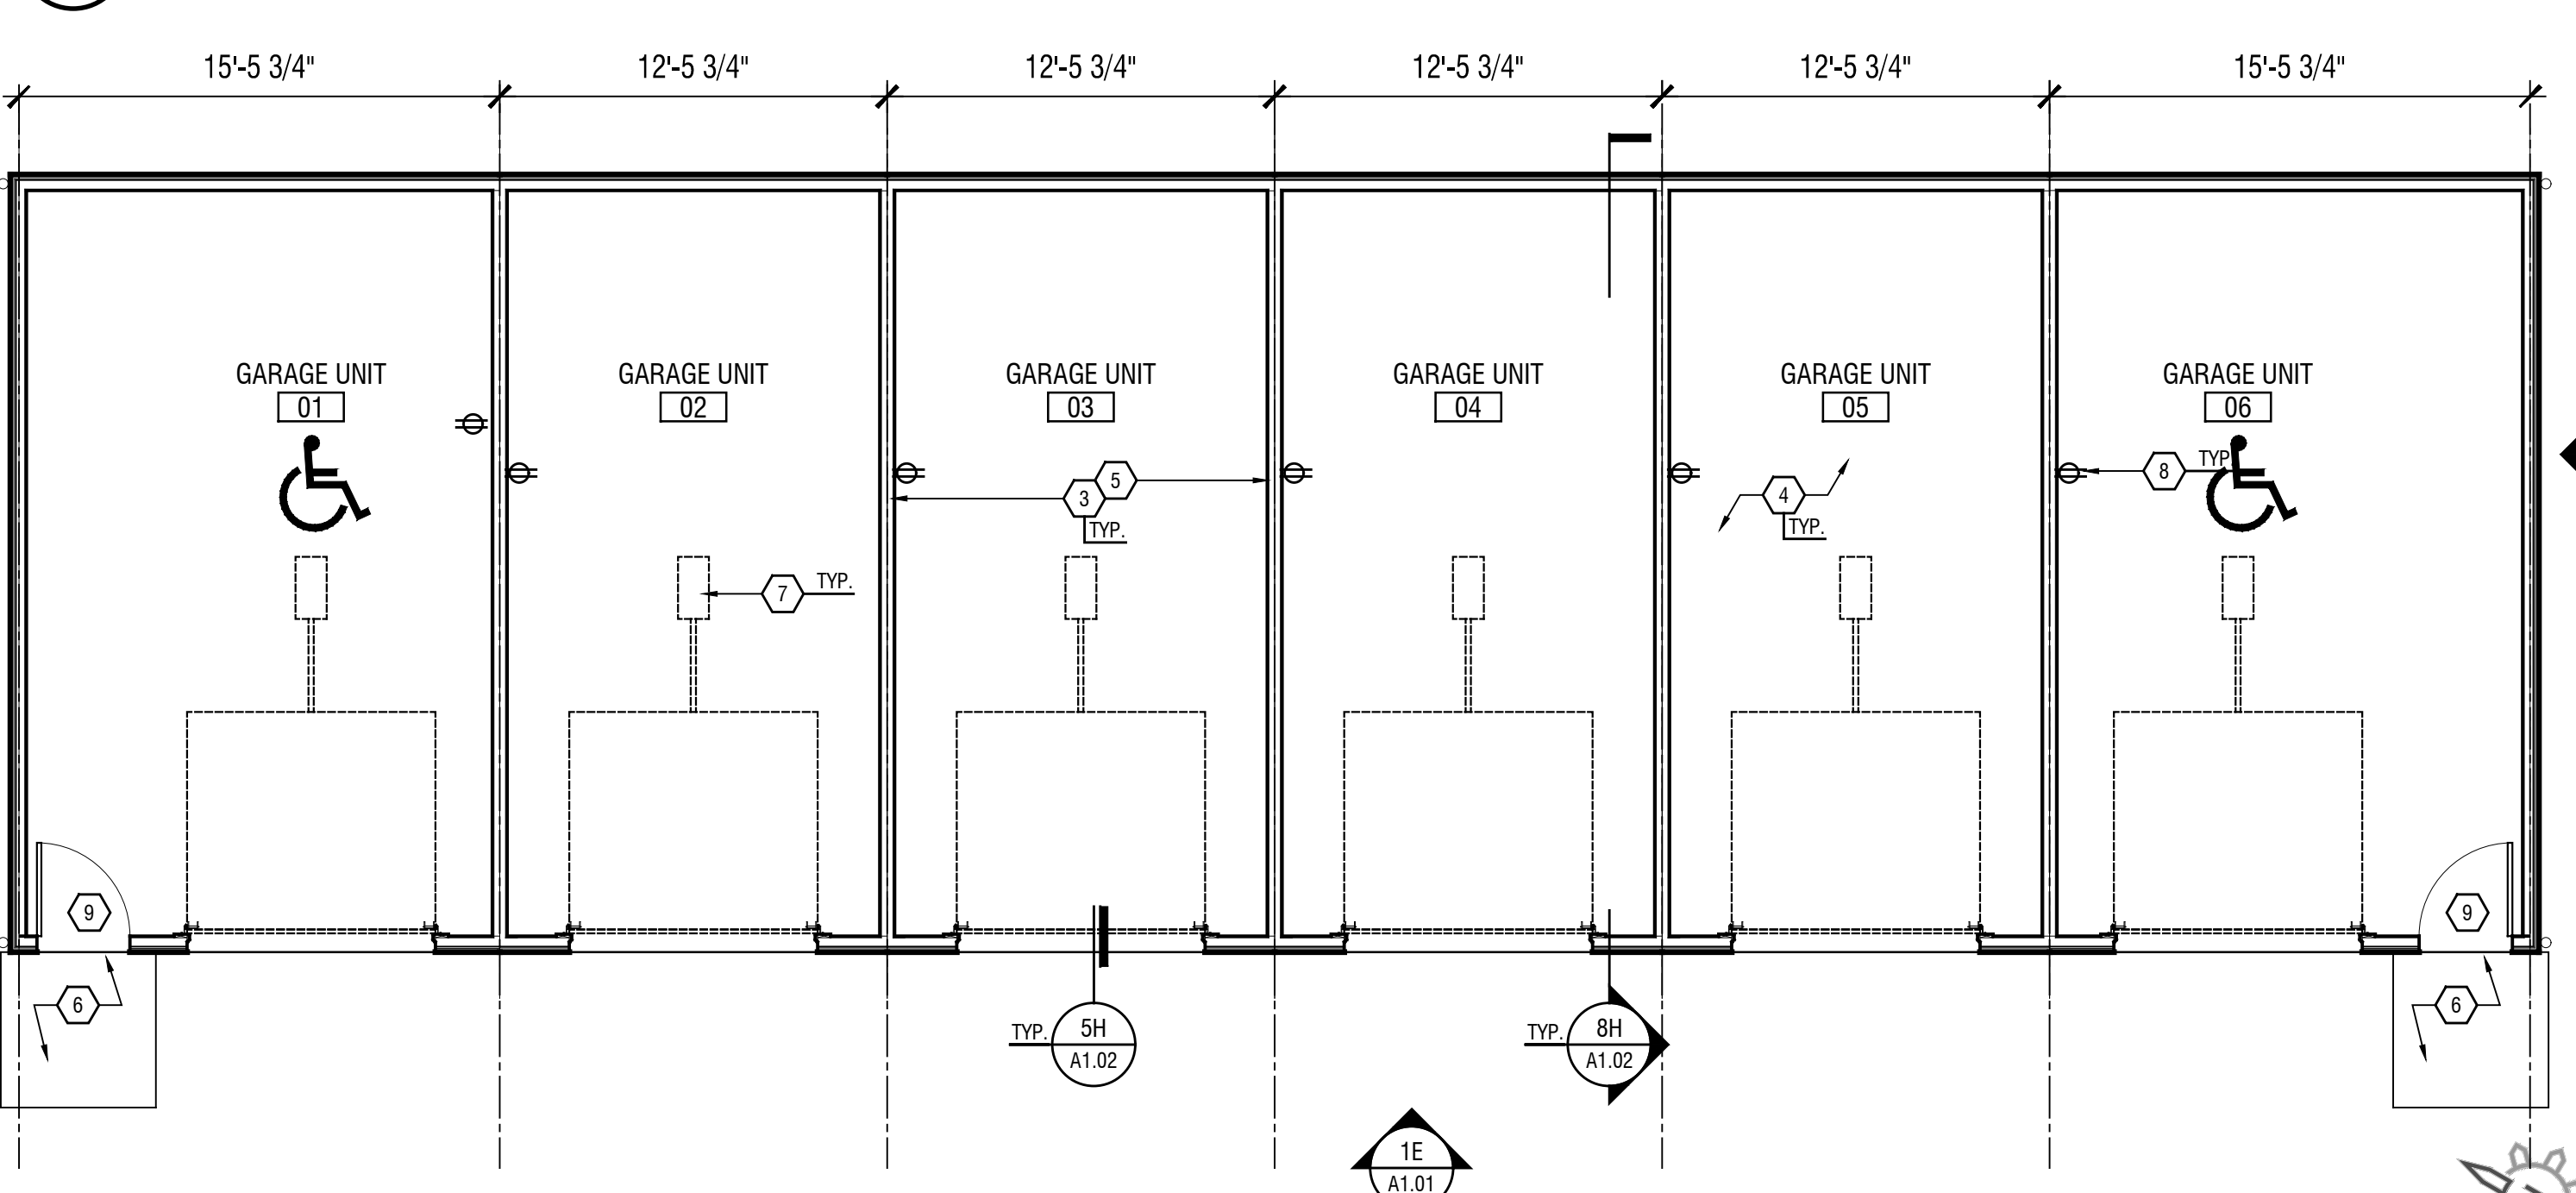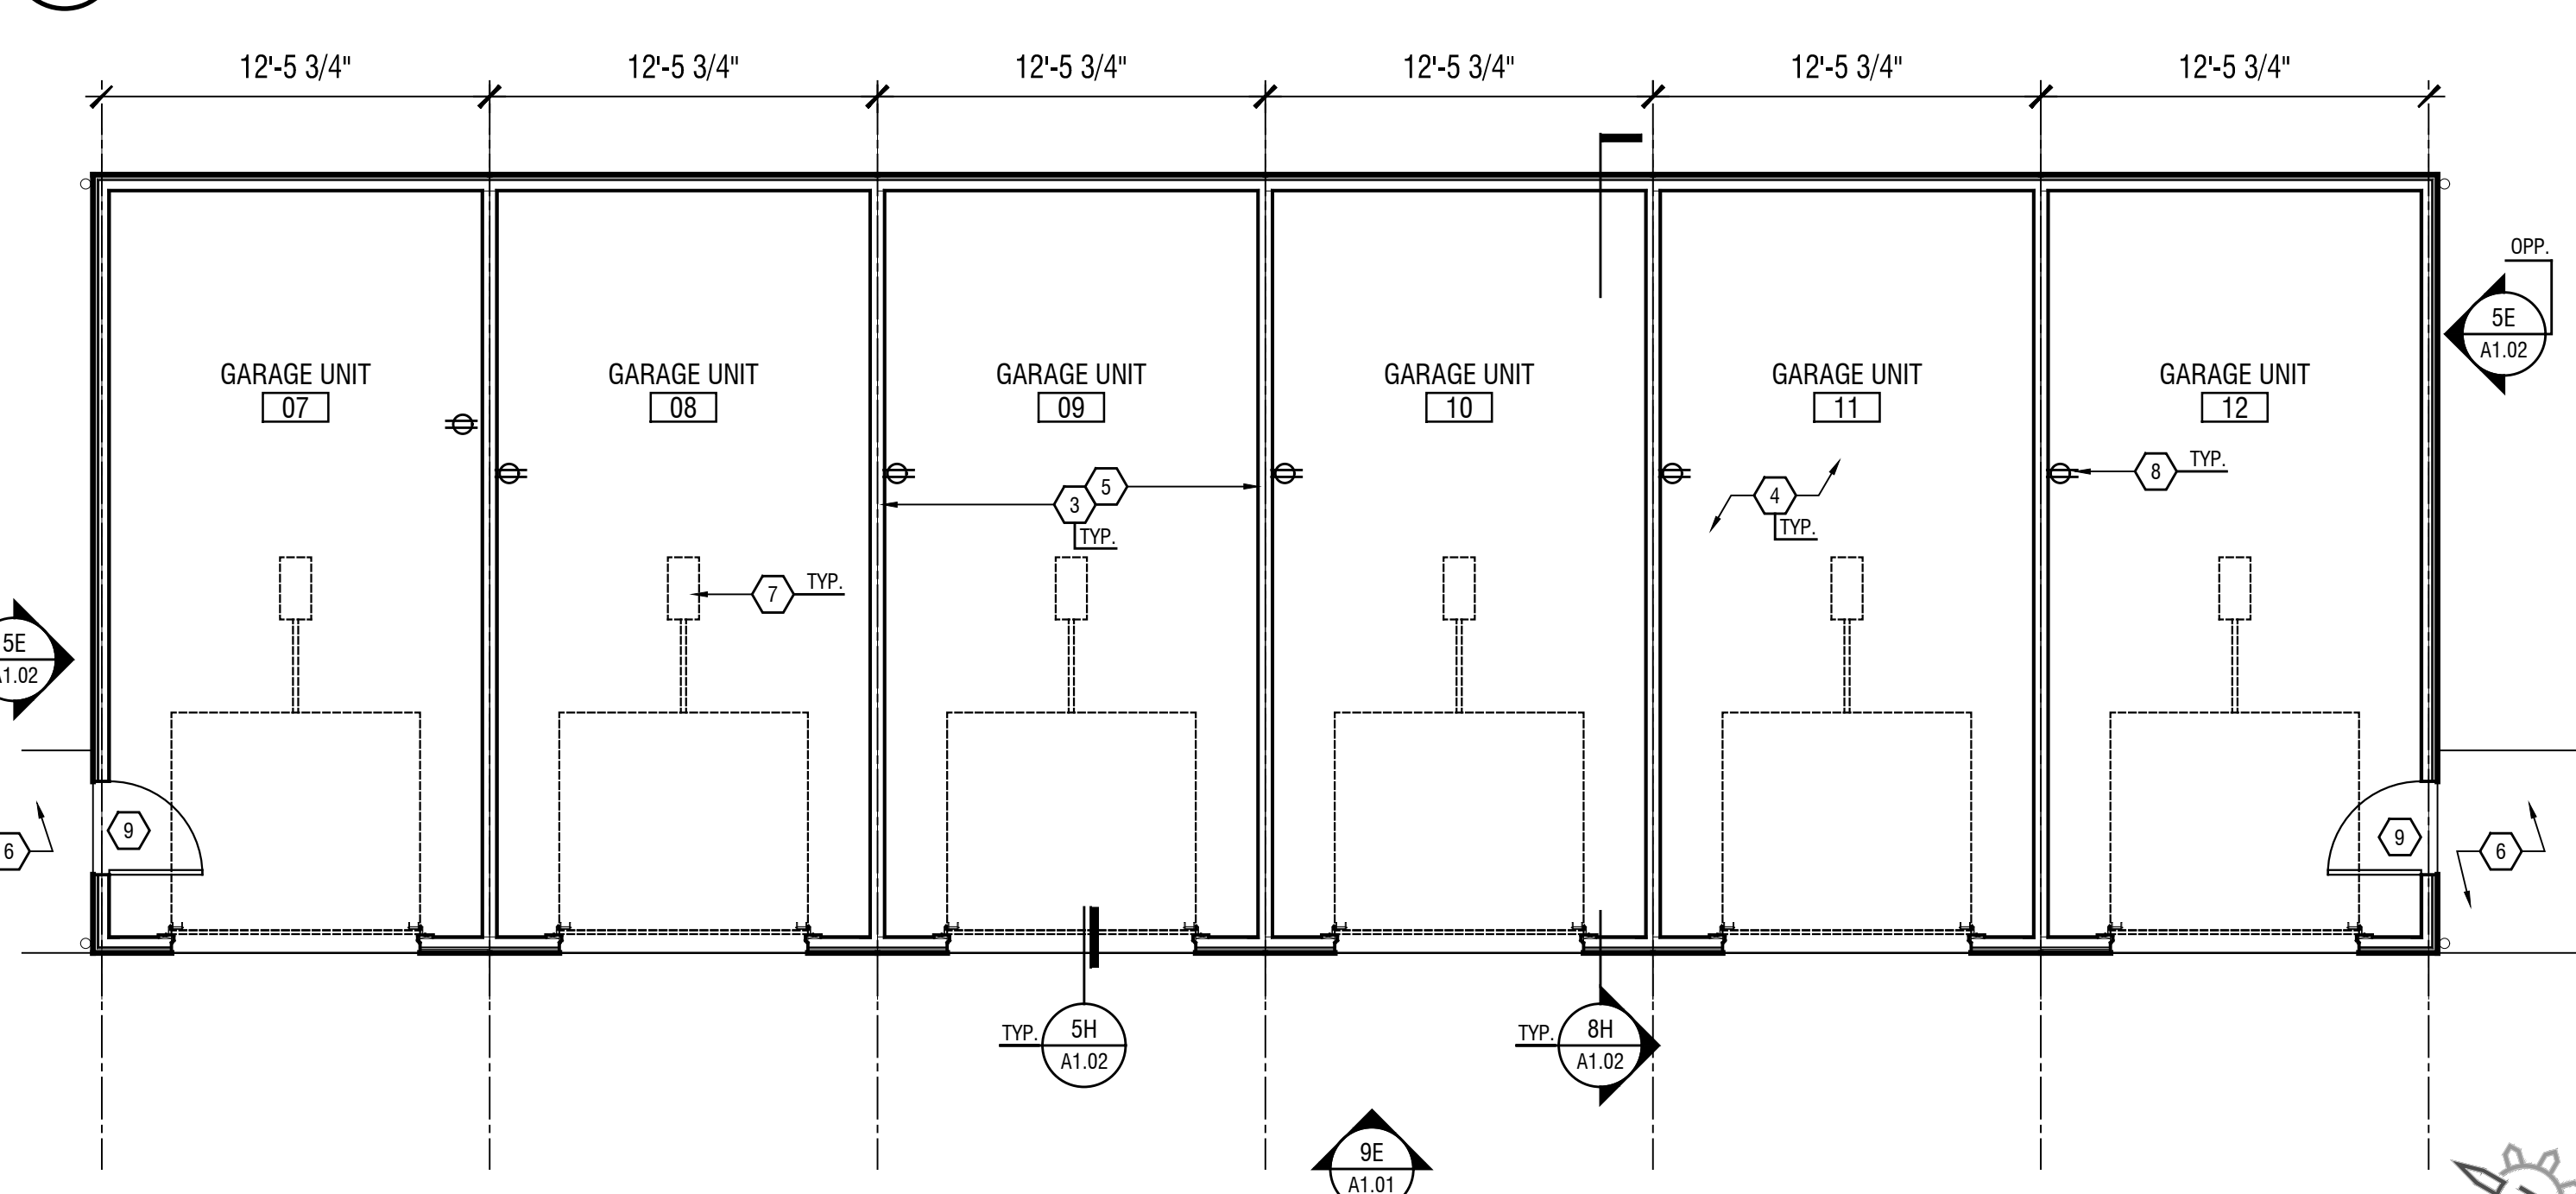

1A FLOOR PLAN - BUILDING 01
A1.01 3/16" = 1'-0"

9A FLOOR PLAN - BUILDING 02
A1.01 3/16" = 1'-0"

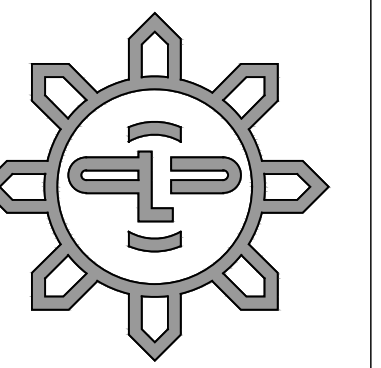

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Project Title

Pavilion at Glacier Hills
IL Conversion Renovation
Detached Garage Addition

1200 Earhart Rd.
Ann Arbor, Michigan 48105

PRELIMINARY
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Issue: Pricing Set 12-09-2022

Revision

Revision 1 02.21.2023

Sheet Title

Overall Construction Plan:

Project No. 21006

Drawn By: BL, RA, MS, ALS

Reviewed By: MK, AS

Scale: As Noted

Sheet No. A1.02

KEYNOTES:

- 1 4" THICK CONCRETE SLAB ON GRADE, WITH 6#6-W2.9@2.9 (42#) MESH OVER COMPACTED GRANULAR BASE, AND VAPOR BARRIER. CONTRACTION JOINTS AT 10'-0" O.C., MAX. SLOPE SLAB - REFER ALSO TO CIVIL DRAWINGS
- 2 CONTINUOUS 4" HIGH CONCRETE CURB, OCCURS ALONG PERIMETER, AND BETWEEN GARAGE DOOR OPENINGS - REFER TO DETAILS, THIS SHEET
- 3 PRE-FINISHED ALUMINUM DOWNSPOUTS, TYP.
- 4 RATED UNIT SEPARATION PARTITION WALL: SILL PLATE SHALL BE (2) PRESSURE TREATED 2X4'S, HOLD OVER 1 1/2" OFF GARAGE SLAB. WALL SHALL BE BUILT ACCORDING TO UL ASSEMBLY U300; 5/8" TYPE-X GWB EACH SIDE OF 2X4 STUDS @ 19" O.C.
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- 8 PROVIDE (1) WATERPROOF EXTERIOR OUTLET AT EACH GARAGE BAY
- 9 3'-0" x 7'-0" 4-PANEL EXTERIOR RATED STEEL ENTRY DOOR (PRE-HUNG) WITH STAINLESS HARDWARE

KEYNOTES: (elevation)

- E1 PRE-FINISHED ALUM DOWNSPOUTS AND GUTTERS
- E2 CONTINUOUS RIDGE VENT (SHINGLE OVER)
- E3 8'-0" x 7'-0" STEEL GARAGE DOOR (paneled) WHITE
- E4 1X WRAPPED W/ ALUM FASCIA
- E5 BRICK SOLDIER COURSE
- E6 JAMES ALLEN KENT 14" TALL WALL OUTDOOR SCIENCE - WESTERN BRONZE FINISH - Model: MWNS3720WR2
- E7 EXPOSED CONC. FOUNDATION



SHEET GENERAL NOTES:

- A. ALL DIMENSIONS TO FACE OF STUD, MASONRY OR CENTER OF UNIT SEPARATION WALL
- B. ALL FRAMING DIMENSIONS TO BE VERIFIED BY JOISTS/TRUSS MANUFACTURER
- C. EXTERIOR MATERIALS SHOWN ARE REPRESENTATIVE OF THE ENTIRE ELEVATION
- D. REFER TO SITE / CIVIL DWGS PROVIDED BY OWNER FOR GRADING AND DOWNSPOUT CONNECTIONS TO STORM LINES


EXTERIOR FINISH KEY:

- BR 1 THIN BRICK
BASIS OF DESIGN:
-MFR: BELDEN
-TYPE: 5/8" FLAT BACK
-COLOR: 470-479 DARK RANGE SMOOTH
- LS 1 3" LAP SIDING
BASIS OF DESIGN:
-MFR: JAMES HARDIE
-TYPE: FLAT
-COLOR: PAINT TO MATCH TRIM
- PT 1 EXTERIOR PAINT FOR TRIM AND COLUMNS
BASIS OF DESIGN:
-MFR: SHERWIN WILLIAMS
-TYPE: EGGSHELL - EXTERIOR ACRYLIC
-COLOR: SW7004 - SNOWBOUND
- RS 1 ROOF SHINGLES
BASIS OF DESIGN:
-MFR: TAMKO
-COLOR: ANTIQUE SLATE


KEY PLAN:

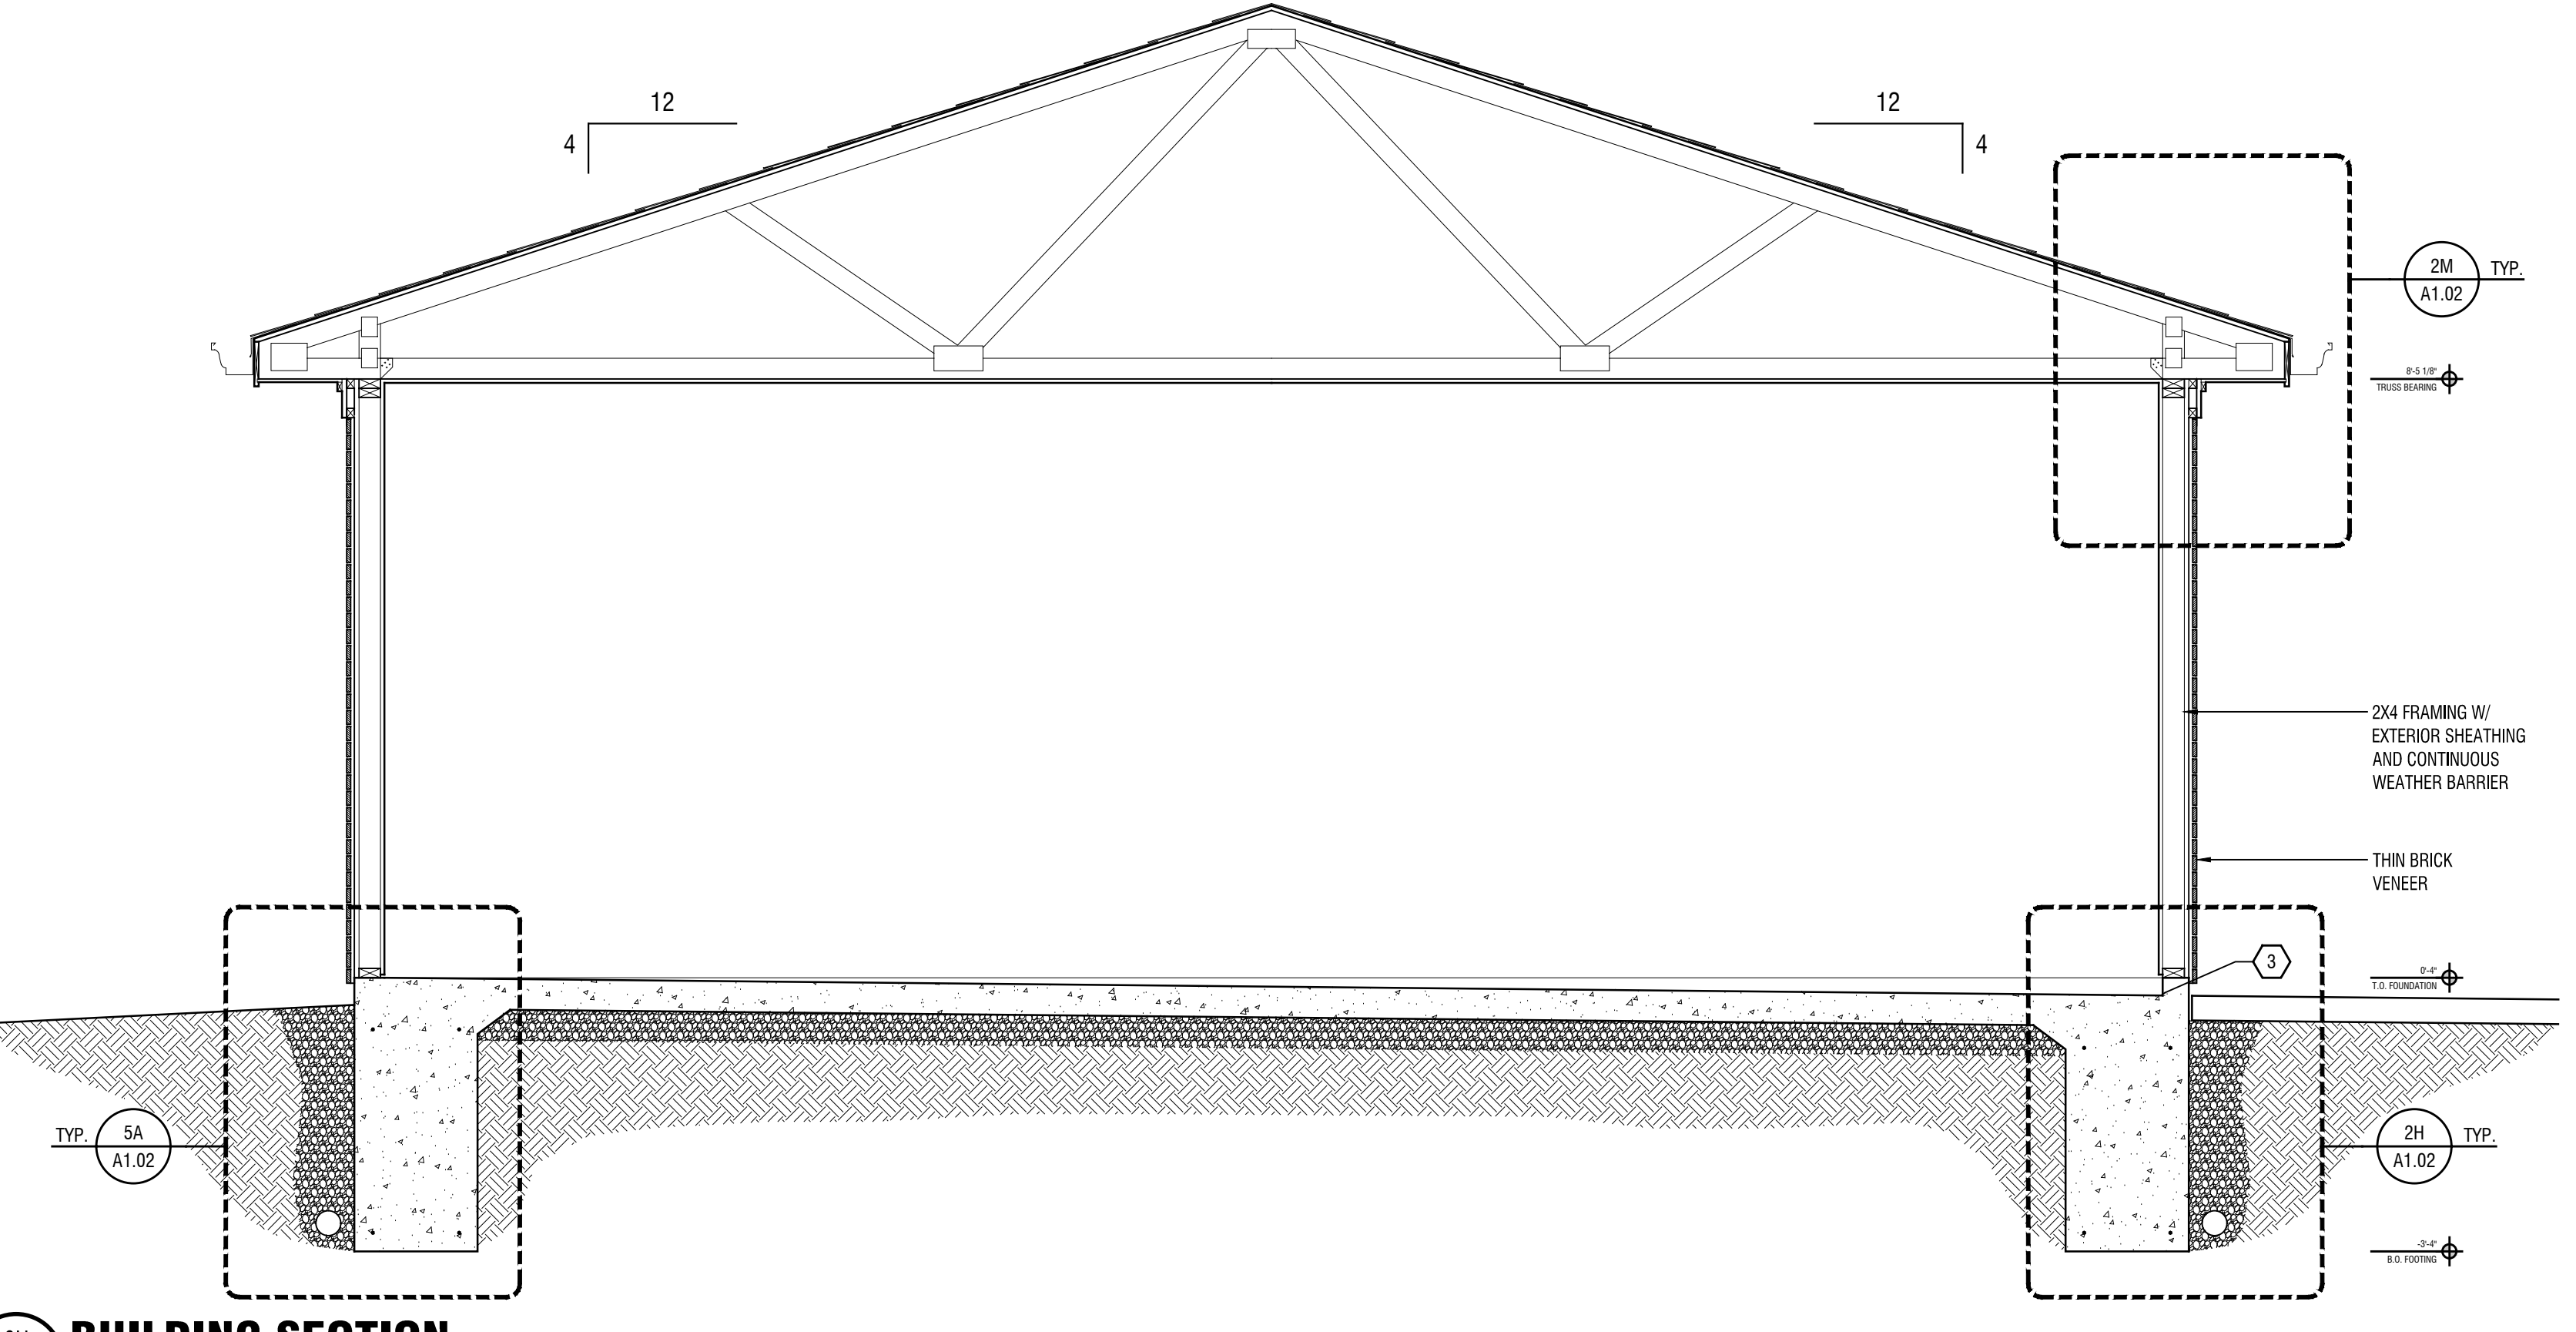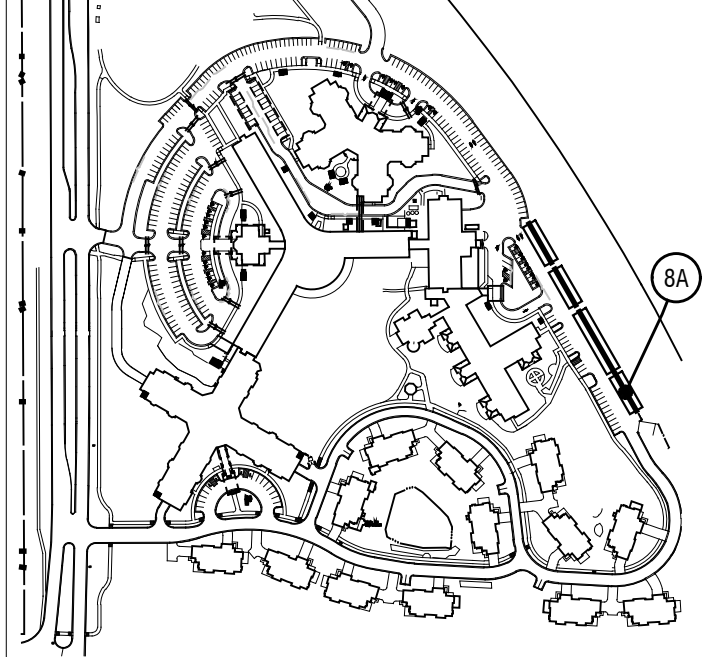


8H BUILDING SECTION
A1.02 1/2" = 1'-0"

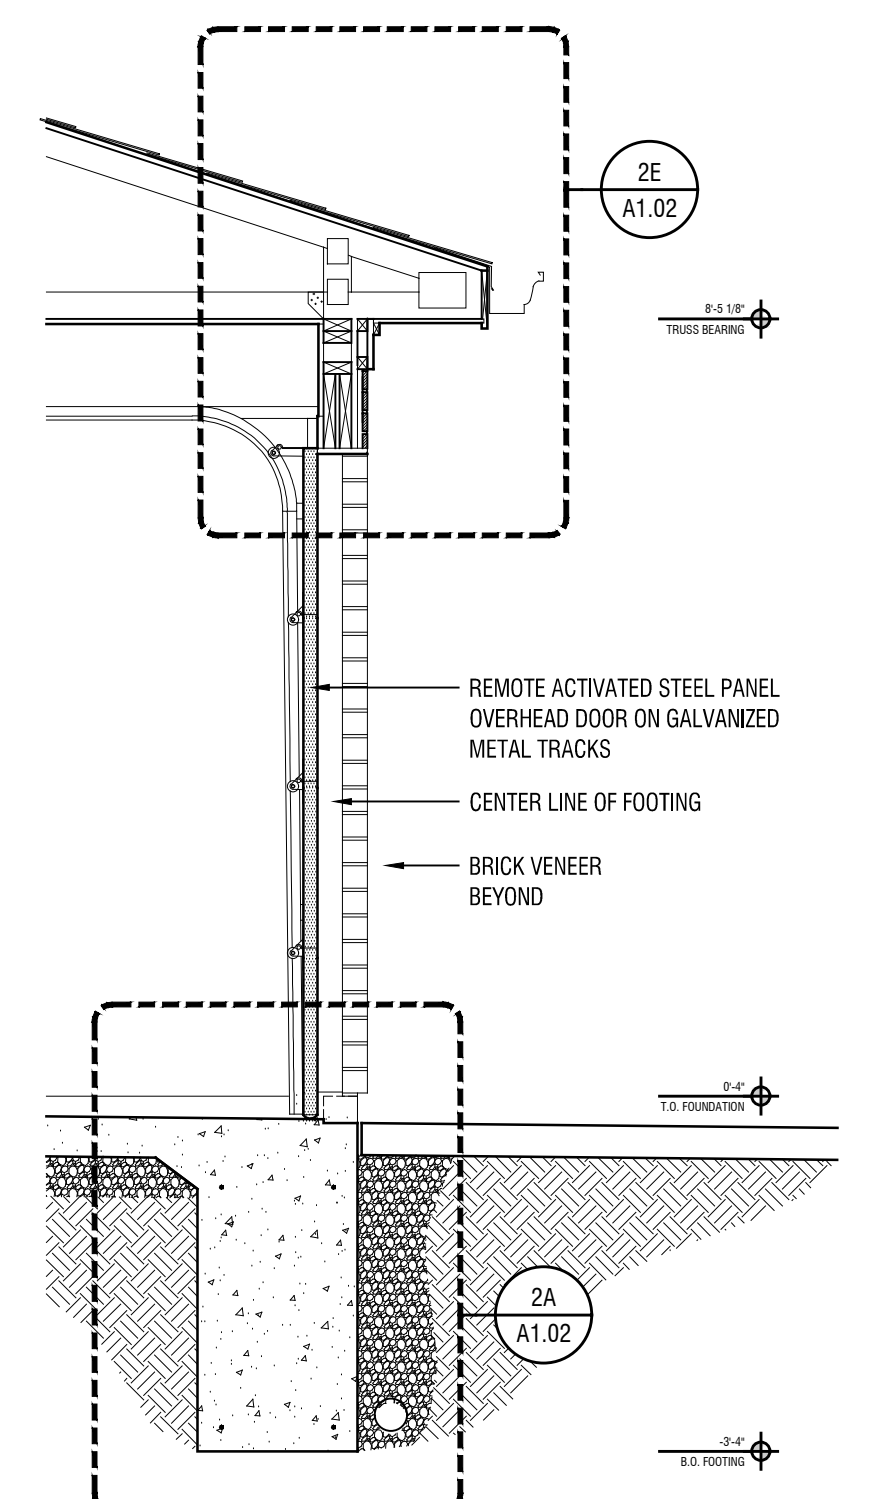


6H WALL SECTION
A1.02 1/2" = 1'-0"

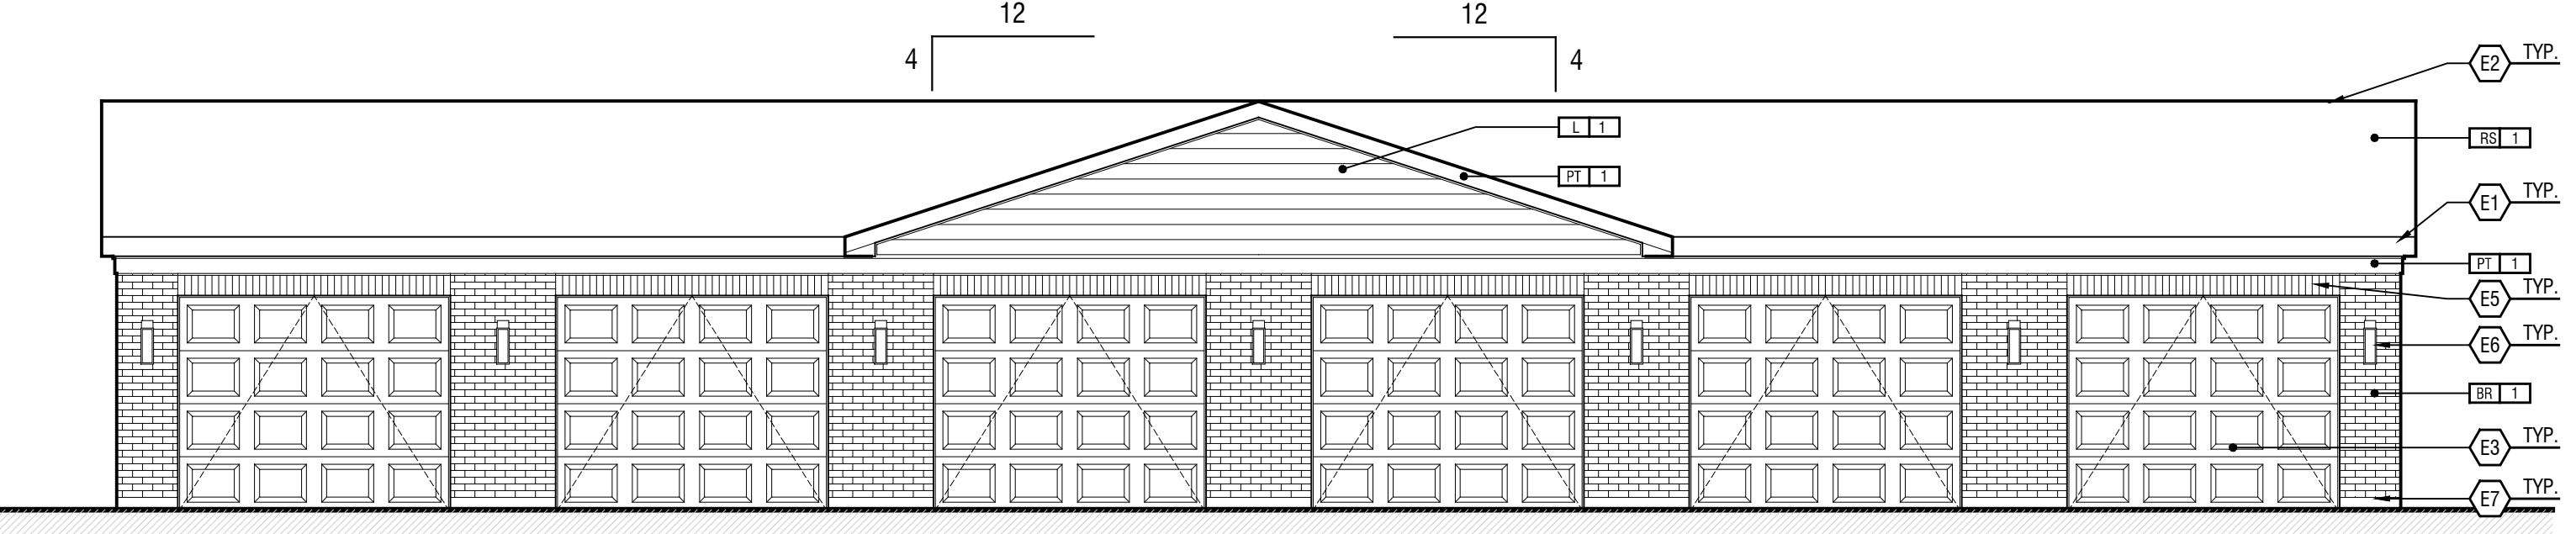


8E ELEVATION - BUILDING 04
A1.02 3/16" = 1'-0"

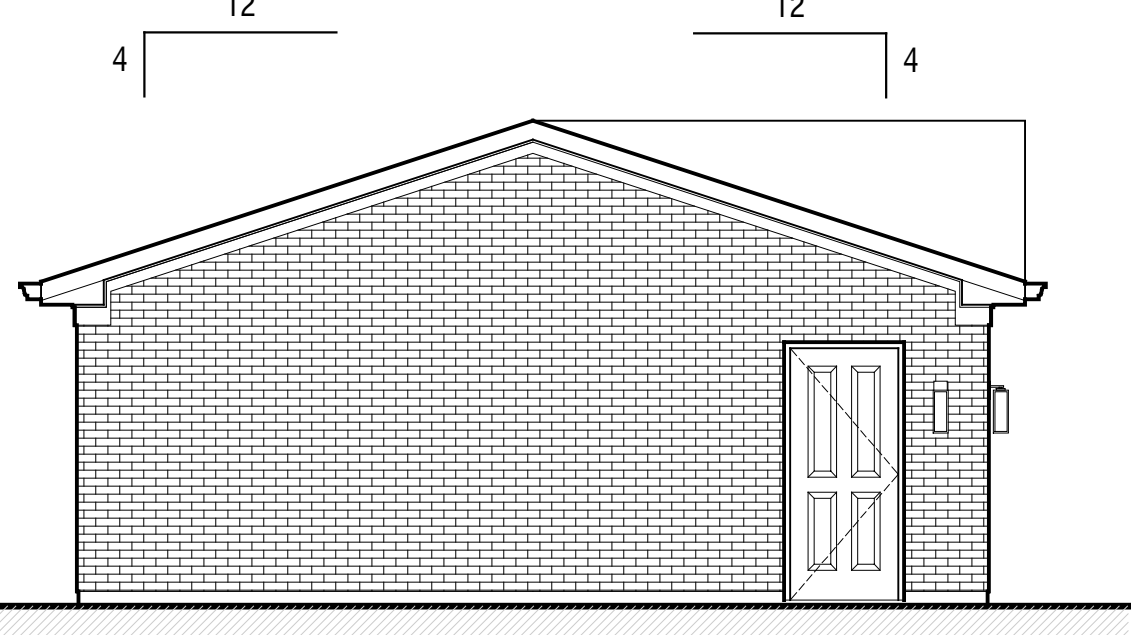


5E ELEVATION
A1.02 3/16" = 1'-0"

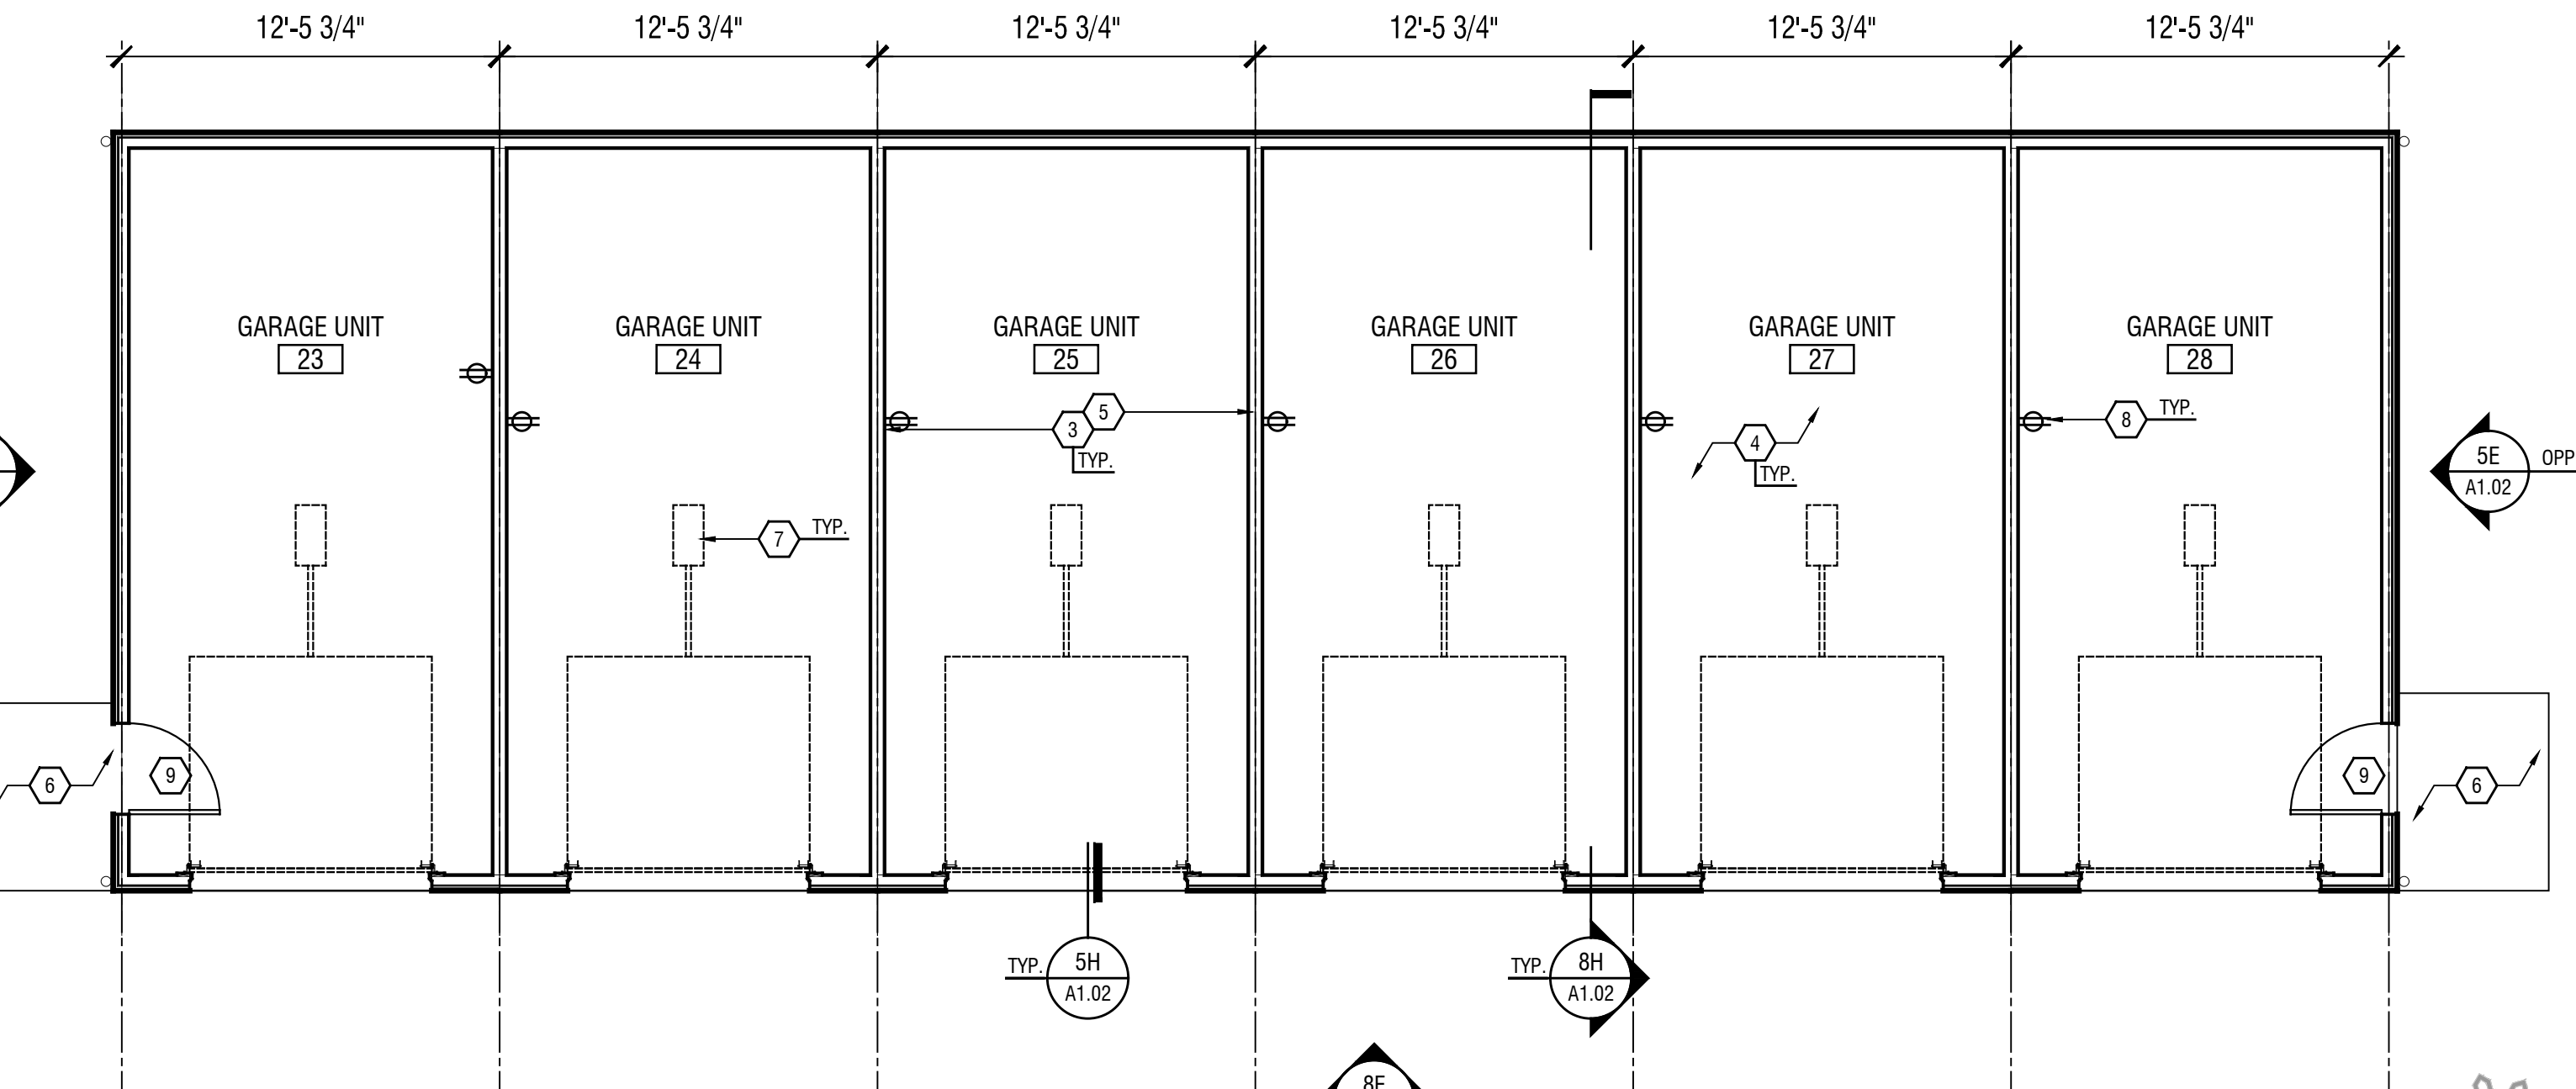


8A FLOOR PLAN - BUILDING 04
A1.02 3/16" = 1'-0"

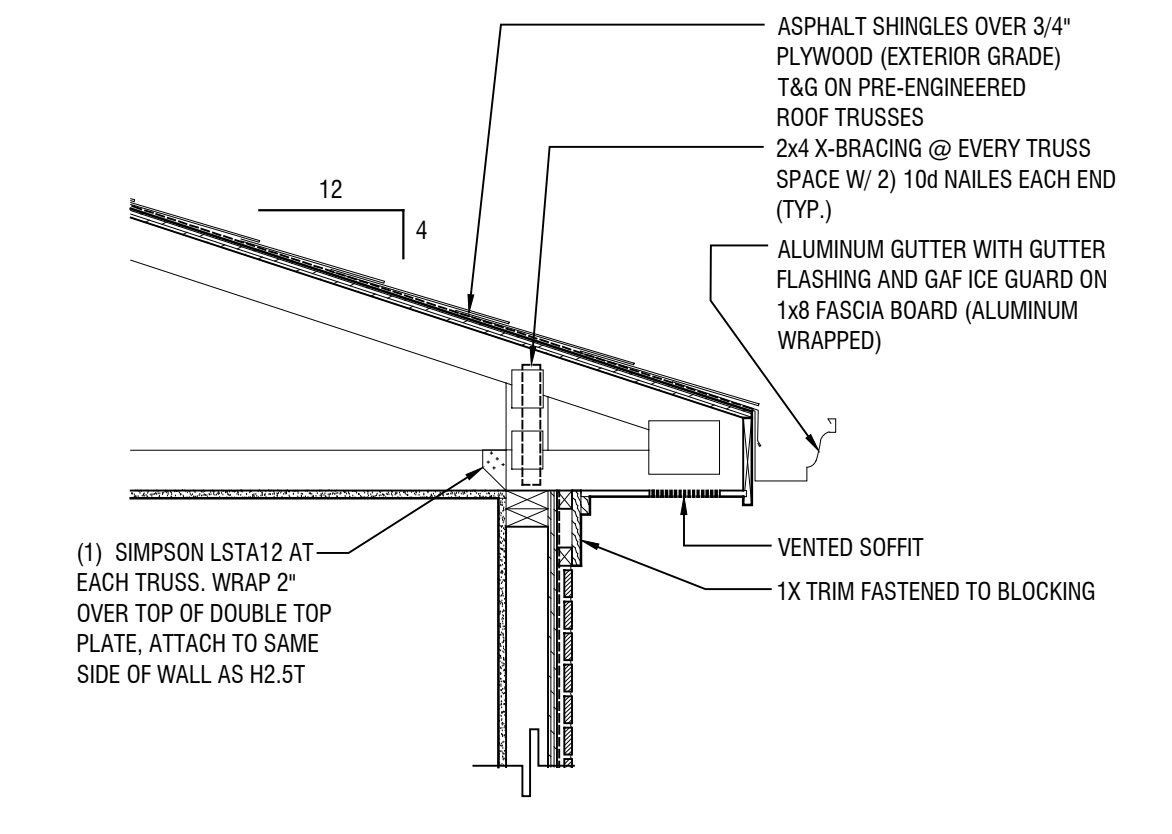


2M DETAIL TYPICAL EAVE
A1.02 3/4" = 1'-0"

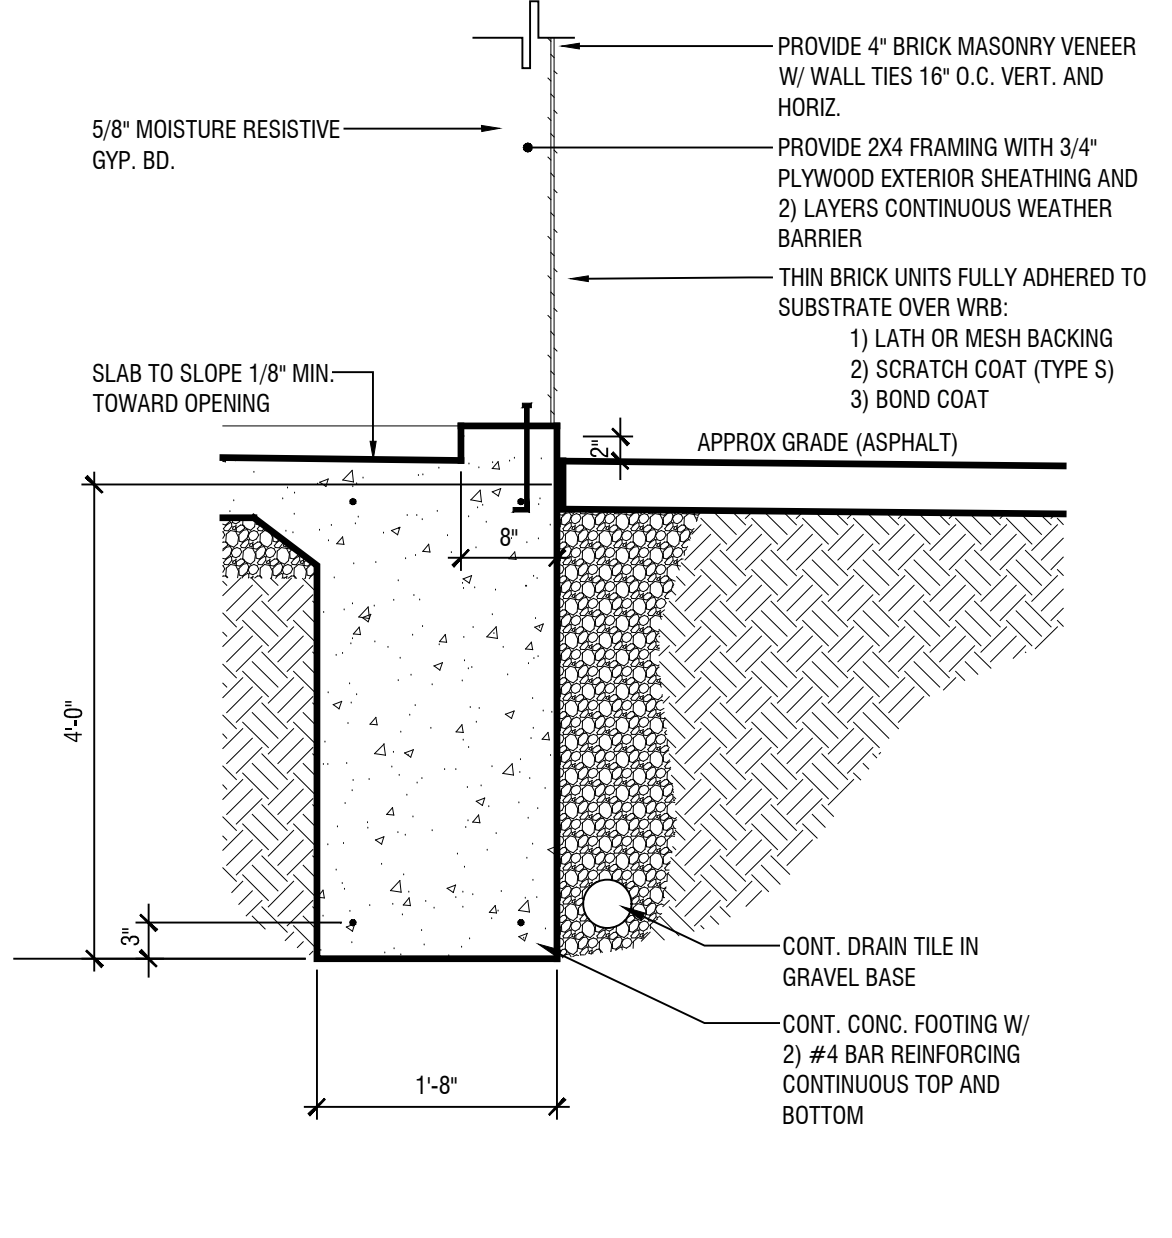


2H DETAIL AT FOUNDATION TYP.
A1.02 3/4" = 1'-0"

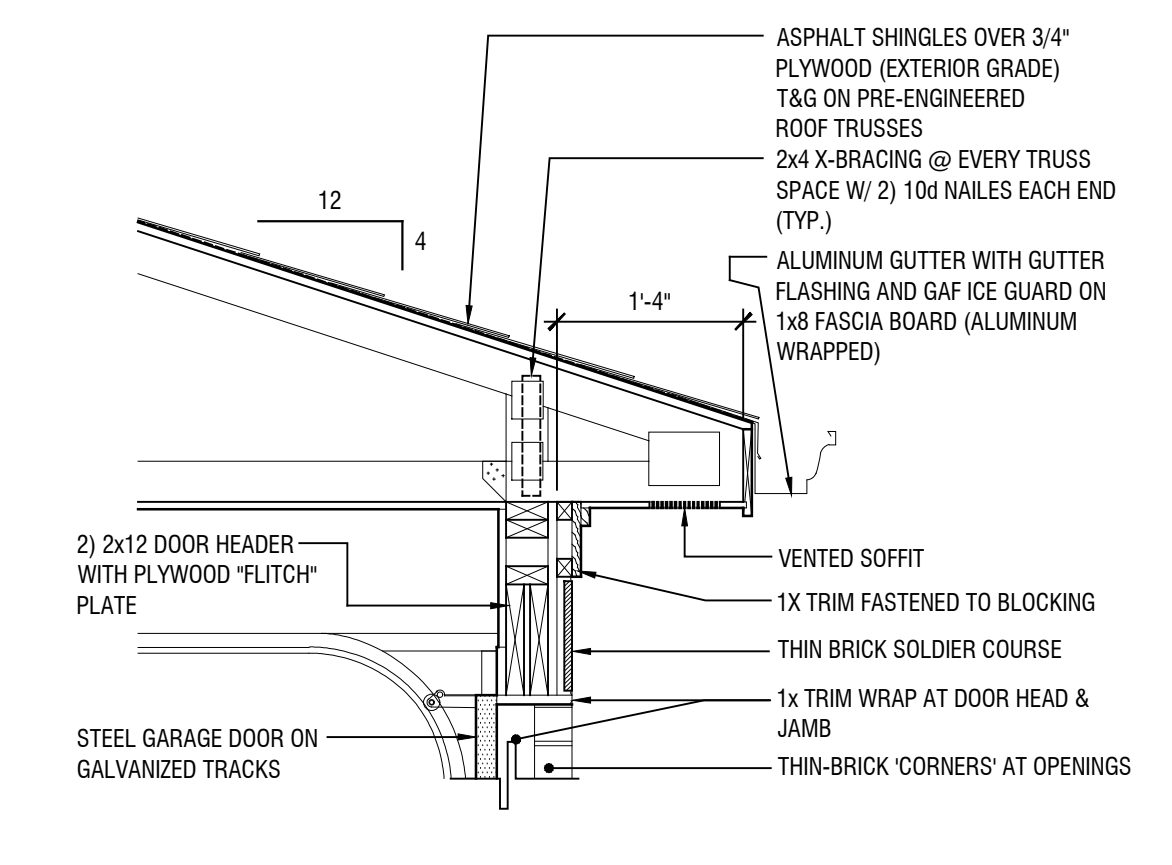

2K DETAIL GARAGE DOOR HEAD
A1.02 3/4" = 1'-0"

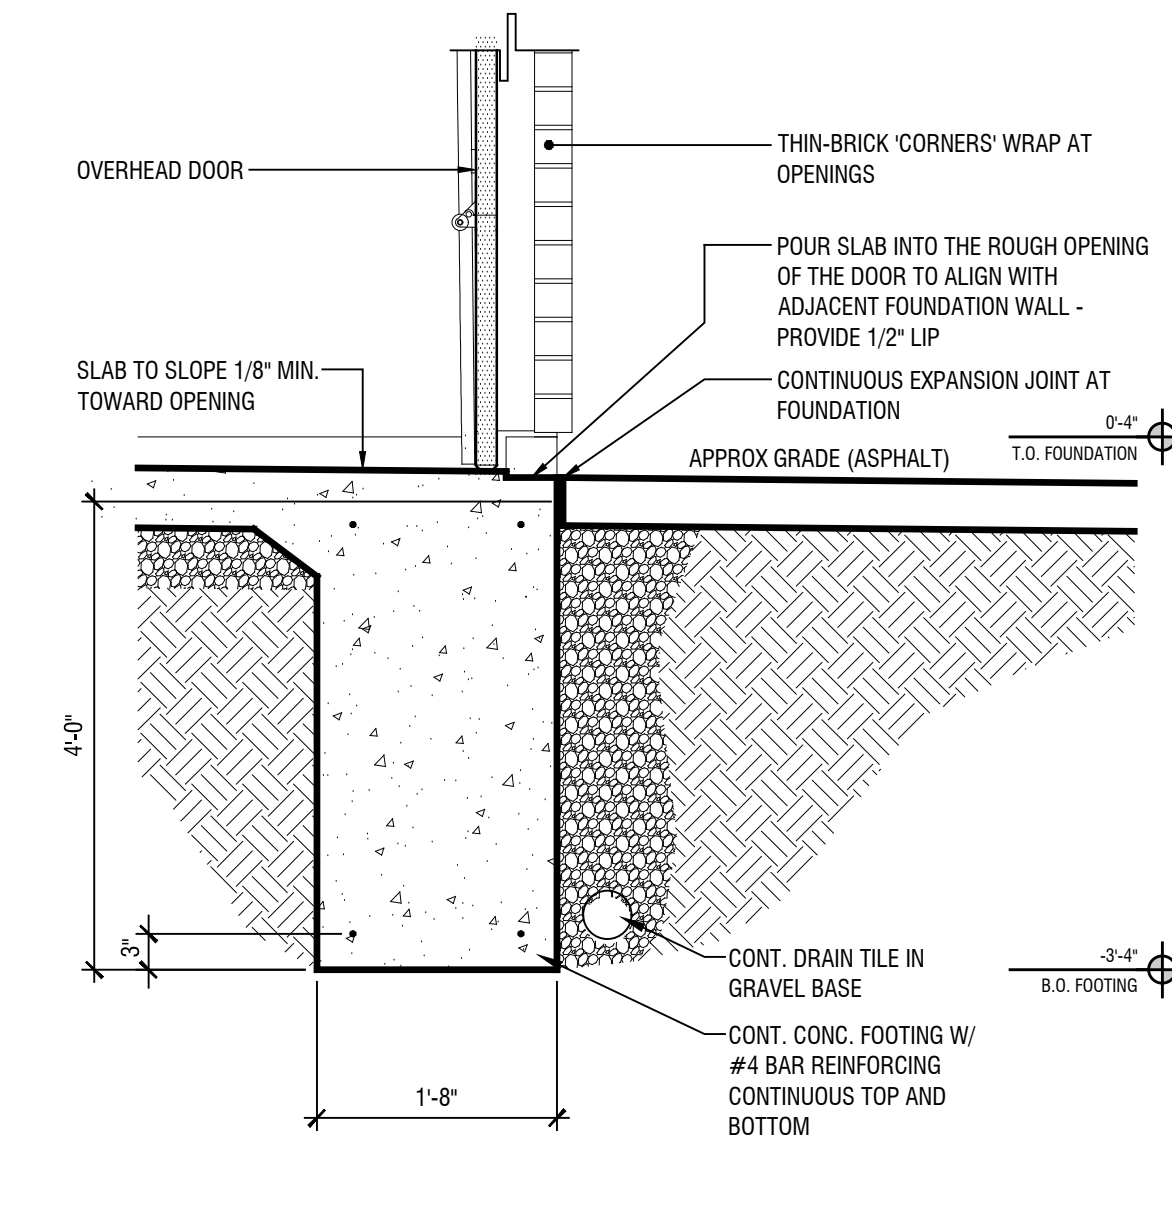

2A DETAIL AT GARAGE OPENING
A1.02 3/4" = 1'-0"

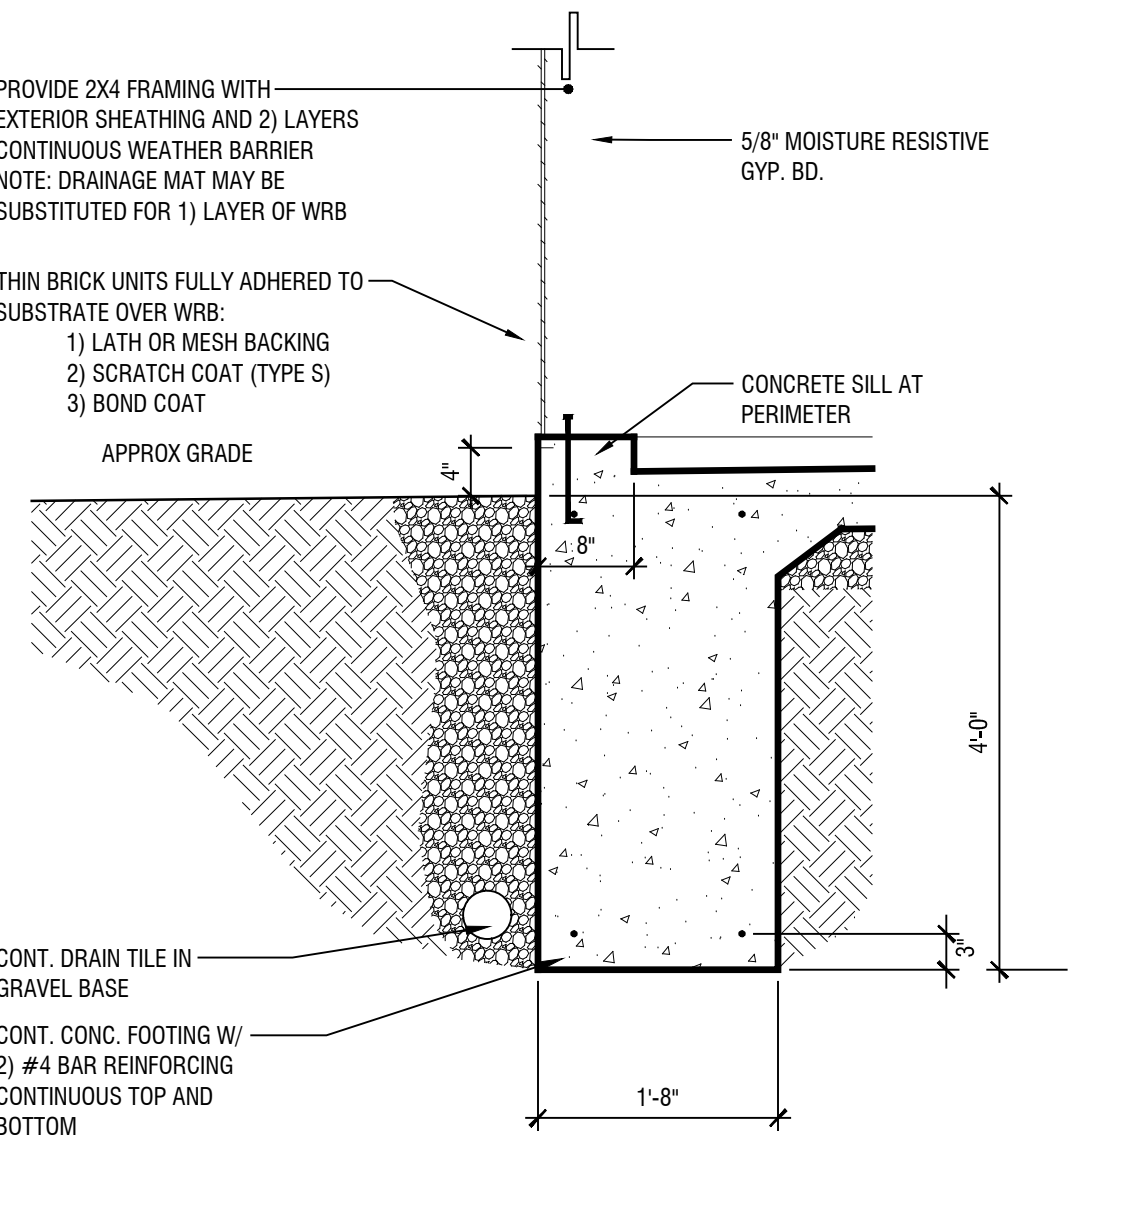

5A DETAIL AT FOUNDATION TYP.
A1.02 3/4" = 1'-0"

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