MIXED-USE DEVELOPMENT

340 DEPOTST
ANN ARBOR, MICHGAN

REV SITE PLAN SUBMITTAL 04/14/2022



REV SITE PLAN SUB 04/14/2022
REV SITE PLAN SUB 01/14/2022
SITE PLAN SUBMITTAL 10/21/2021

DATE ISSUE

CHECKED BY

TECTS
www.hobbs-black.com

ARCH
30 N. State St.
And Arbor, MI 48104

SE DEVELOPMENT

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PROJE

CONSULTANT

TITLE DATA/ INDEX SITE LOC'N

20-810

PROJECT NUMBER

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A-0

PROJECT TEAM:

DEVELOPER


EARMARK CONSULTANTS LLC 340 DEPOT ST ANN ARBOR, MI 48104 (312) 988-9825

CIVIL ENGINEER/LANDSCAPE ARCHITECT

MIDWESTERN CONSULTING INC 3815 PLAZA DRIVE ANN ARBOR, MI 48108 (734) 995-0200

ARCHITECTURAL

HOBBS + BLACK ASSOCIATES, INC. 100 N. STATE STREET ANN ARBOR, MICHIGAN 48104 (734) 663-4189

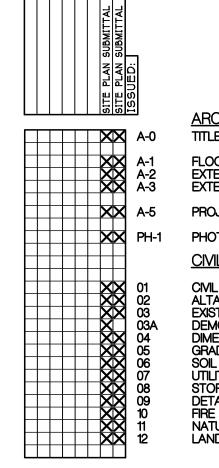

DRAWING INDEX:

ARCHITECTURAL

A-0 TITLE, DATA, INDEX & SITE LOC'N


A-1 FLOOR PLANS
A-2 EXTERIOR ELEVATIONS
A-3 EXTERIOR ELEVATIONS

A-5 PROJECT RENDERINGS

PH-1 PHOTOMETRIC PLAN

CIVIL & LANDSCAPE

O1 CML COVER SHEET
O2 ALTA
O3 EXISTING CONDITIONS
O3A DEMO PLAN
O4 DIMENSIONAL SITE PLAN
O5 GRADING AND SOIL EROSION CONTROL PLAN
O6 SOIL EROSION CONTROL NOTES & SPECIFICATIONS
O7 UTILITY PLAN
O8 STORMWATER MANAGEMENT PLAN
O9 DETAIL SHEET
OHNOR OF THE PROTECTION AND REFUSE PLAN
ON THE PROTECTION AND DETAILS

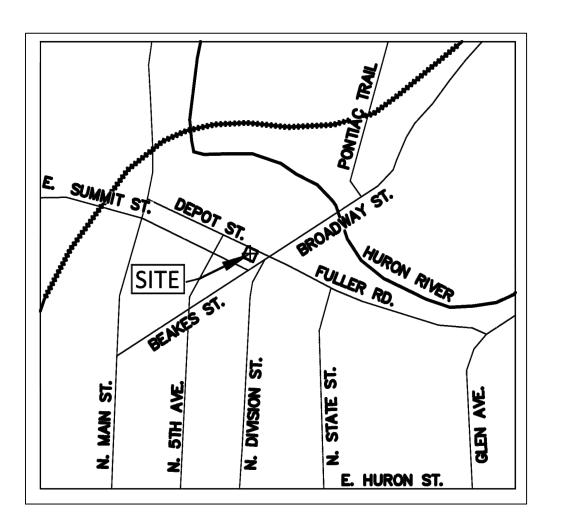

SITE VICINITY
SCALE - NTS

STATEMENT OF INTEREST IN LAND: EARMARK CONSULTANTS, LLC IS ACTING AS THE OWNER, PETITIONER AND DEVELOPER OF THE SITE.

DEVELOPMENT PROCESS

THE PROPOSED DEVELOPMENT WILL BE MIXED-USE BUILDIG WITH APPROXMIATELY 650 SF OF RETAIL, 730 SF OF OFFICE, 4 RESIDENTIAL UNITS AND A ROOF TOP TERRACE. THERE WILL BE (6) COVERED PARKING SPACES PROVIDED ON THE FIRST LEVEL FOR THE BUILDING. THE DEVELOPMENT HAS BEEN PLANNED TO PROVIDE A MIX OF USES IN THE C1-B DISTRICT TO FURTHER ENHANCE THE SUPPORTING AREA. ADEQUATE PARKING ACCES, PEDESTRIAN CONNECTIONS AND AN ACTIVATED STREET WALL HAVE BEEN INCORPORATED INTO THE PROJECT. THE SITE IS TO BE DEVELOPED IN ONE PHASE. THE PROPOSED PROJECT IS SCHEDULED TO BEGIN UPON APPROVAL AND BE COMPLETED IN 2023. PRELIMINARY DEVELOPMENT COSTS ARE CURRENTLY ESTIMATED AT \$1,600,000.

OMMUNITY ANALYSIS

THE PROPOSED PROJECT IS LOCATED ON DEPOT STREET JUST WEST OF CAREY STREET AND ACROSS THE STREET FROM THE AMTRAK TRAIN STATION. THE SITE IS ZONED C1-B. THE PROPOSED REZONING IS A PLANNED UNIT DEVELOPMETN (PUD). THERE IS AN EXISTING BUILDING ON THE SITE THAT WILL BE REMOVED. THE USE OF THE PROPOSED BUILDING IS MIXED-USE INCLUDING RESIDENTIAL, RETAIL AND OFFICE. THE RESIDENTIAL WILL BE MARKETED TO YOUNG PROFESSIONALS AND EMPTY NESTERS, WHILE THE RETAIL SPACE WILL AIM TO SERVE AS A SUPPORTING AMENITY TO THE NEIGHBORING USES. THE OFFICE SPACE IS INTENDED FOR A SMALL OFFICE TENANT LOOKING TO BE NEAR DOWNTOWN. THE PROPOSED DEELOPOMENT WILL NOT HAVE A NEGATIVE IMPACT ON THE PUBLIC SCHOOLS, AIR OR WATER QUALITY. THERE ARE NO HISTORICAL SITES OR STRUCTURES ON THE SITE. THE GENERAL DESCRIPTION OF NATURAL FEATURES DESCRIBES IN DETAIL THE IMPACTS TO THE NATURAL FEATURES THAT ARE LIMITED ON THE SITE. THERE ARE NO LANDMARK TREES ON

THE PROPOSED DEVELOPMENT WILL BE AN IMPROVEMENT TO THE EXISTING SITE WHICH INCLUDES AN OLDER BUILDING. THE INTENDED USES WILL BE CONSISTENT AND SUPPORTIVE OF OTHER USES IN THE NEIGHBORHOOD. THE DESIGN OF THE PROJECT WILL BE HARMONIOUS AND CONTEXTUAL WITH THE OTHER PROPERTYES IN THE AREA AND WILL NOT HAVE A NEGATIVE IMPACT TO THE SURROUNDING DEVLOPMENTS.


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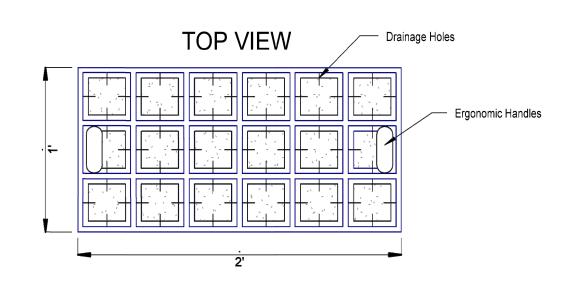
SHEET NUMBER


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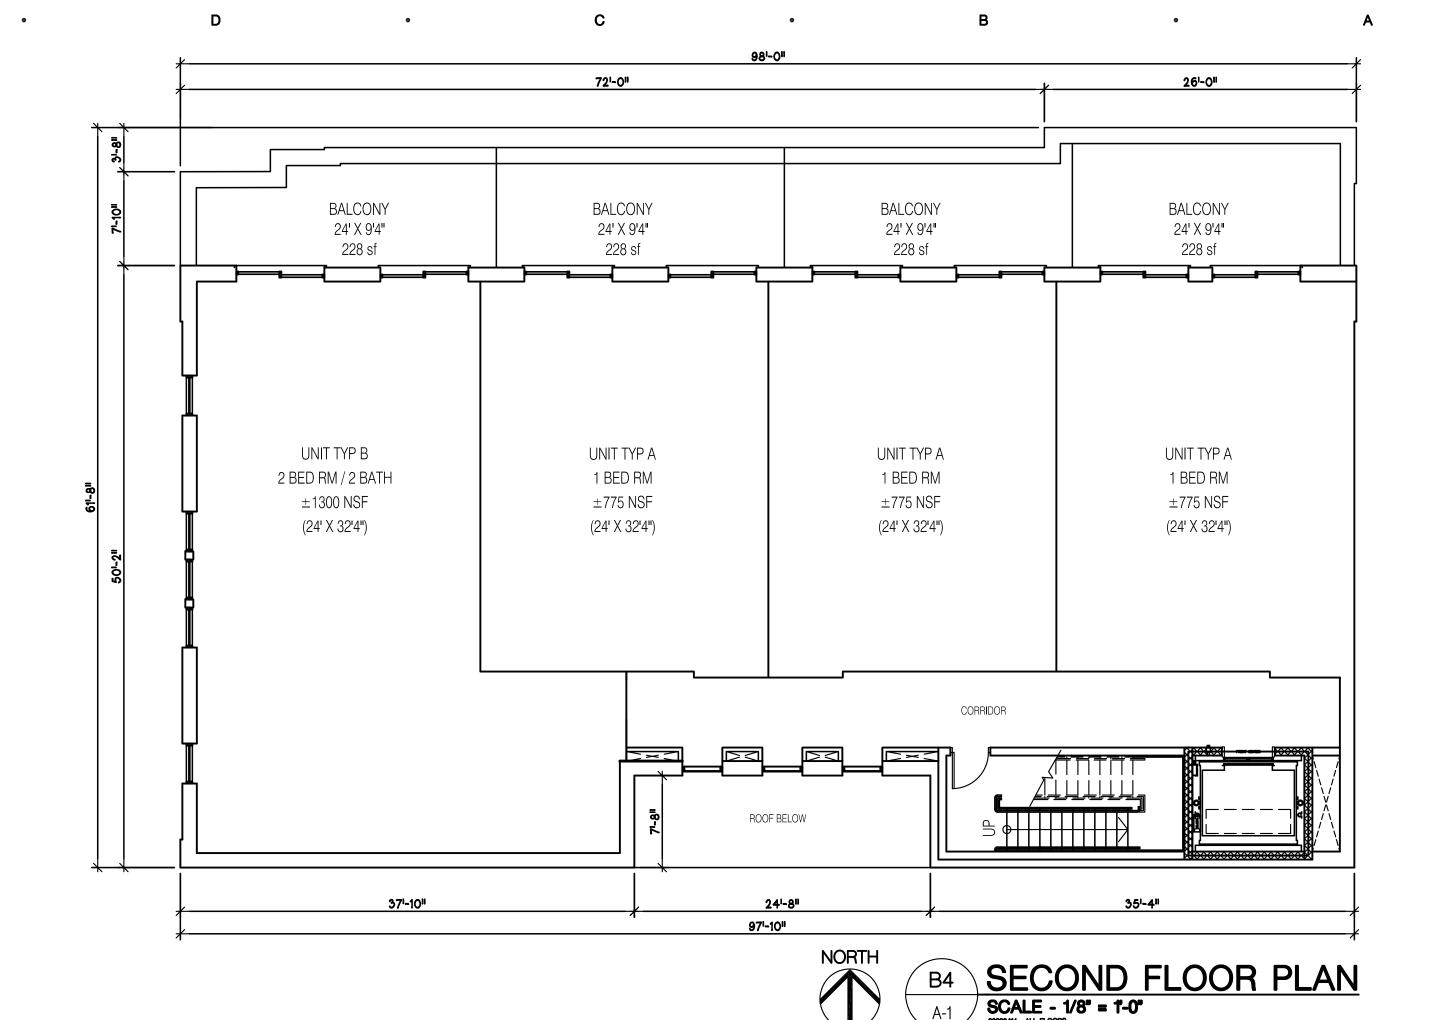
LiveRoof DEEP SYSTEM


Over Conventional Roofing Assembly





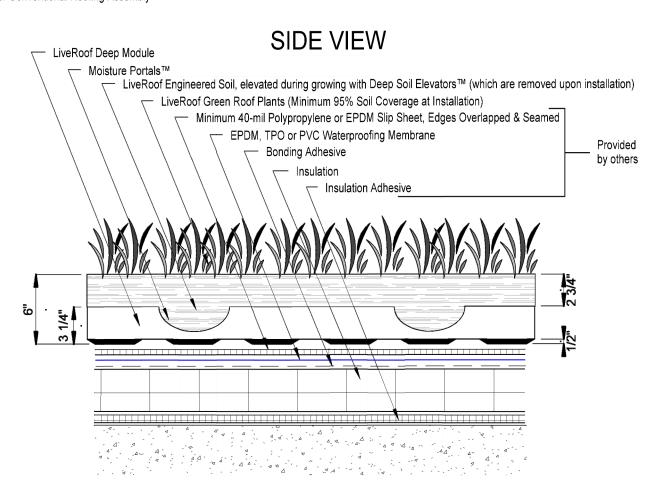

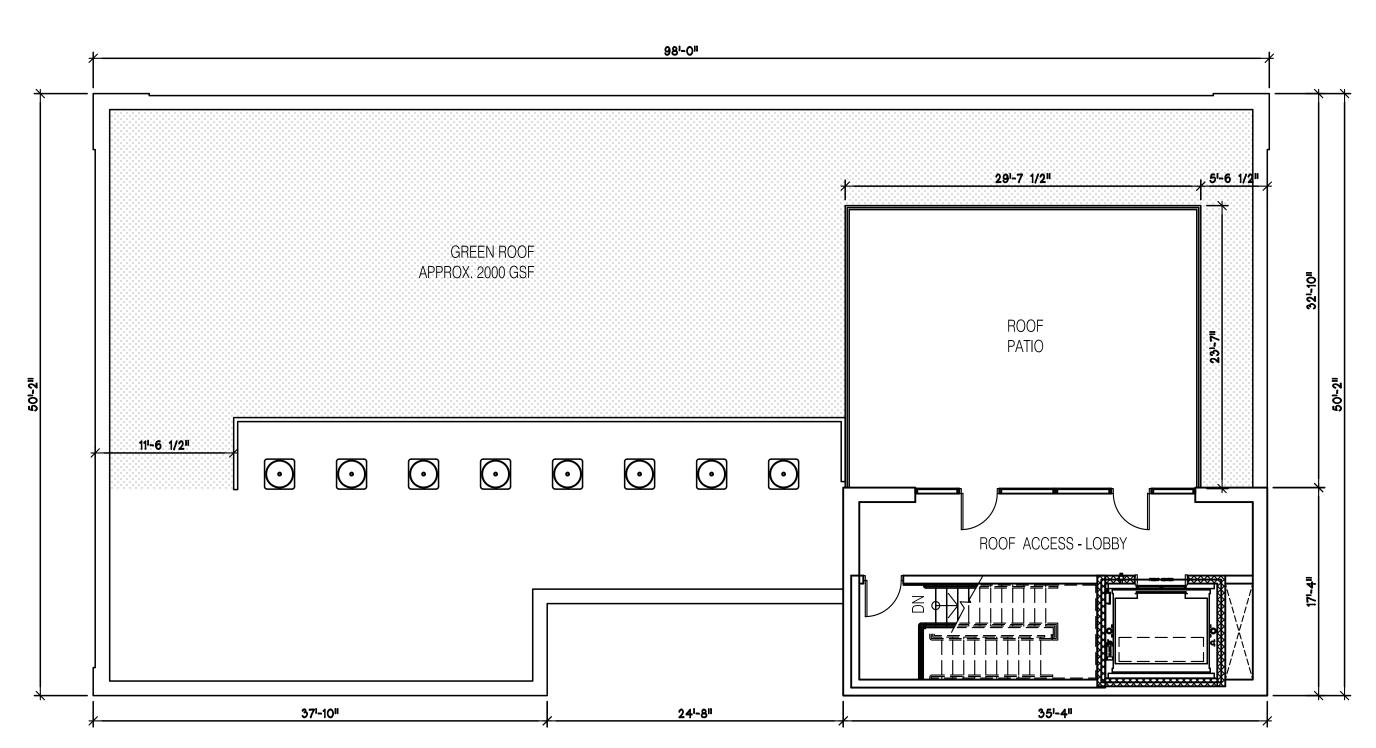

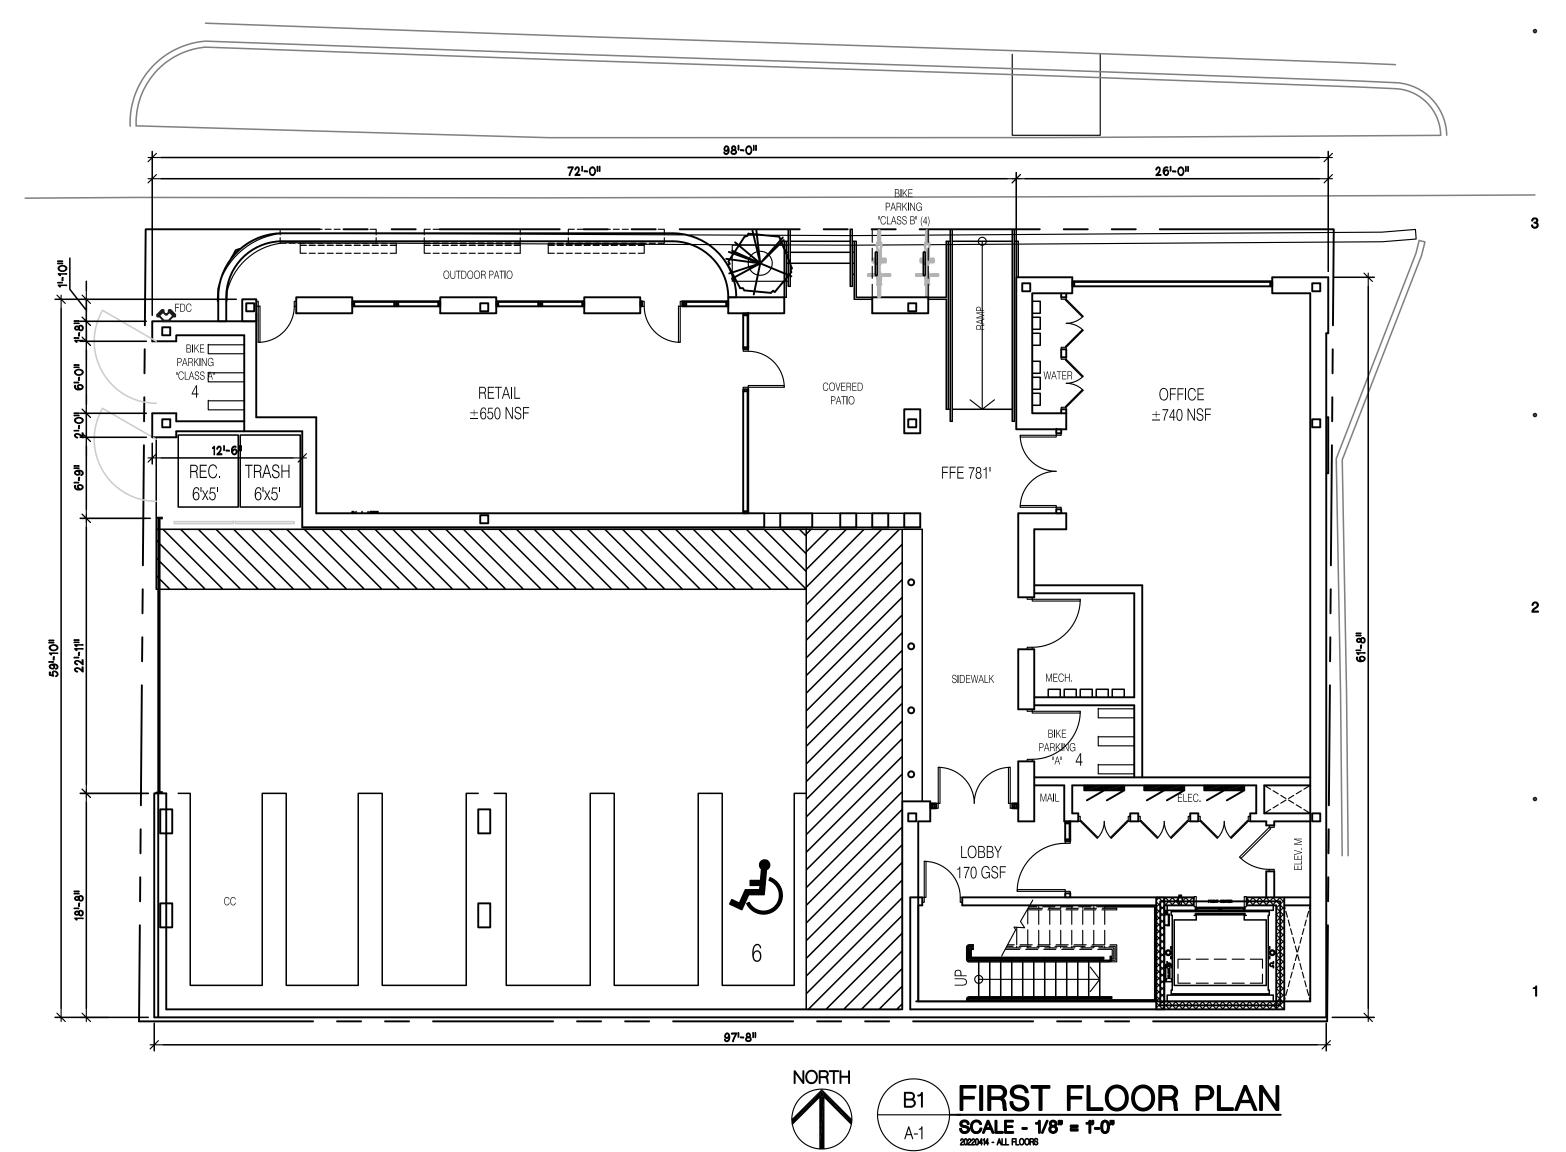

T HOBBS+BLAC ARCHITECT

Sheet Size - 24x36

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 REV SITE PLAN SUB
 04/14/2022

 REV SITE PLAN SUB
 01/14/2022

 SITE PLAN SUBMITTAL
 10/21/2021

DATE ISSUED

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CHECKED BY

340 DEPOT ST 340 DEPOT ST

PROJ

CONSULTANT

FLOOR PLANS

SHEET TITLE

PROJECT NUMBER

20-810


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SHEET NUMBER

E1 ROOF PLAN

SCALE - 1/8" = 1-0"

20220414 - ALL RLOORS

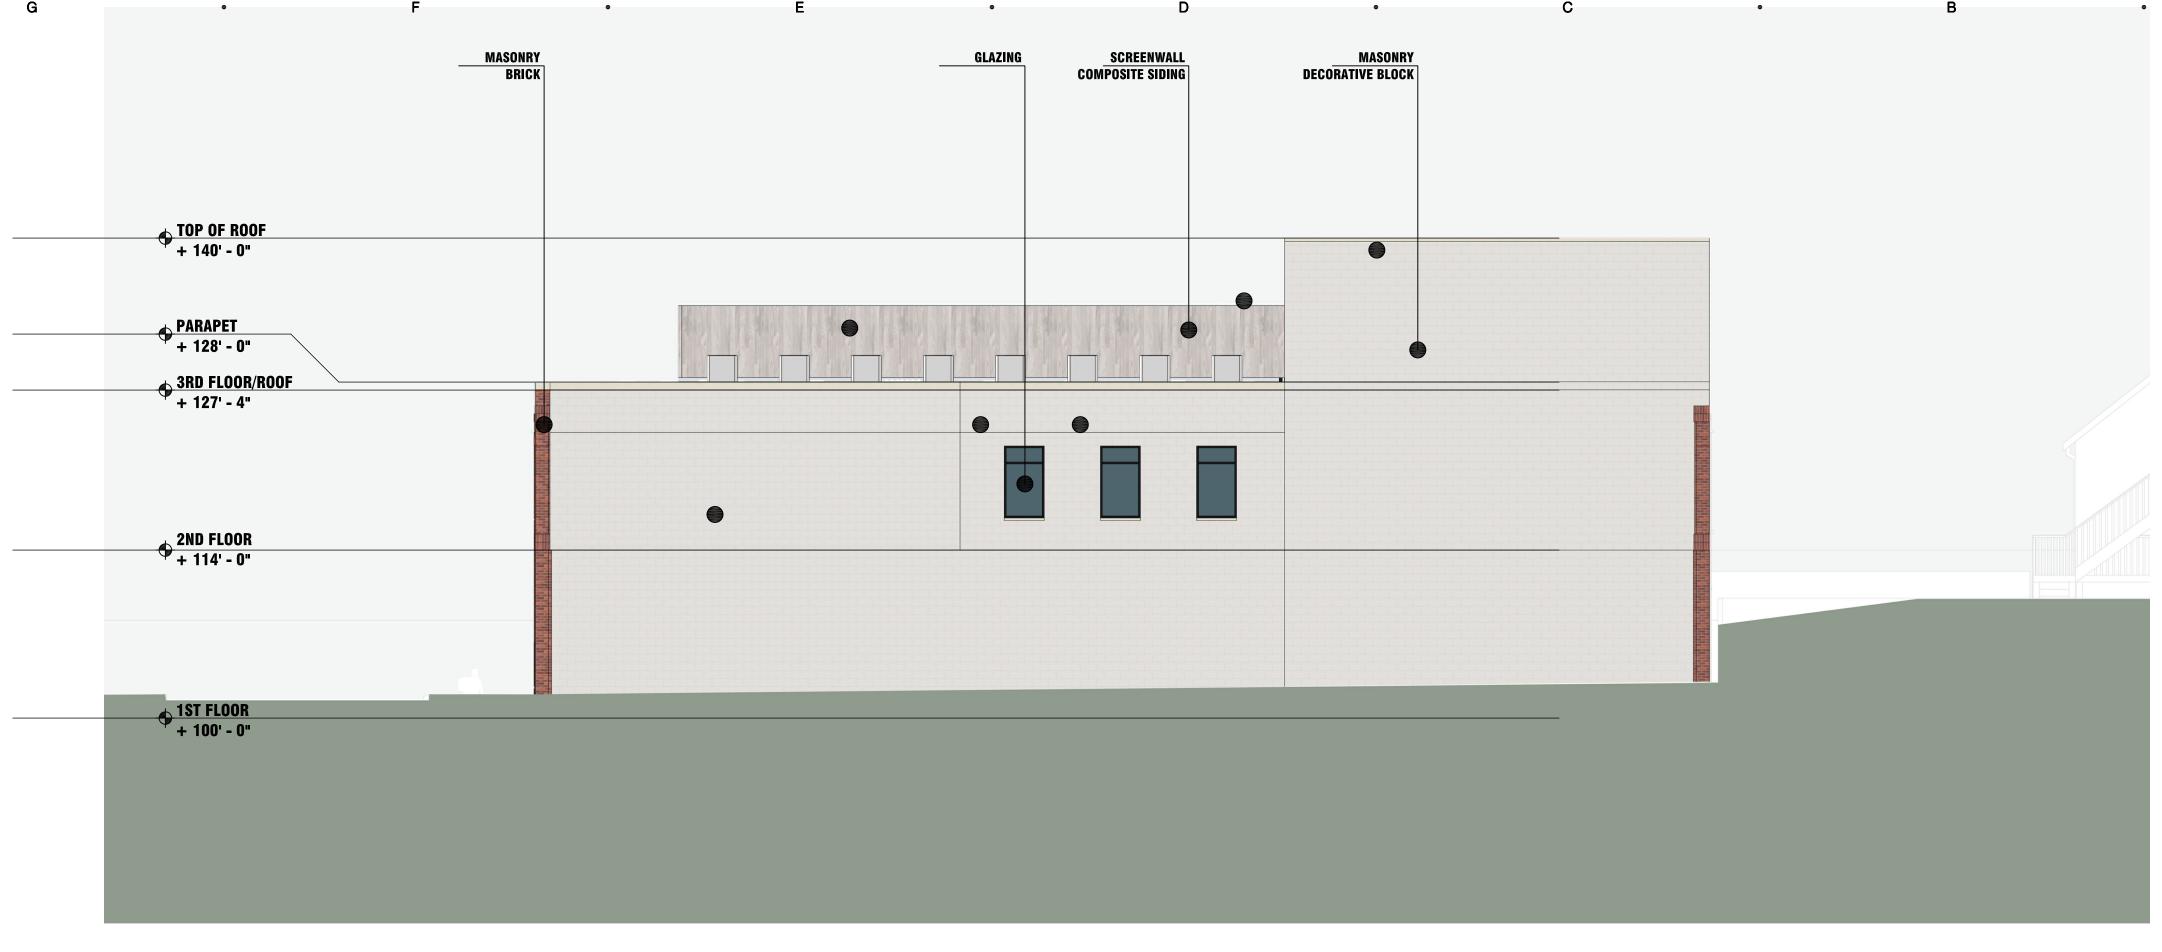

G4 SOUTH ELEVATION

SCALE - 1/8" = 1'-0"



С

G1 NORTH ELEVATION
SCALE - 1/8" = 1'-0"

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HHFCTS

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100 N. State St. Ann Arbor, MI 48104 P.734.663.4189

MXED-USE DEVELOPMENT 340 DEPOT ST ANN ARBOR, MICHIGAN

PROJECT

CONSULTANT

EXTERIOR ELEVATIONS

SHEET TITLE

20-810

PROJECT NUMBER

A-2

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G1 WEST ELEVATION

SCALE - 1/8" = 1'-0"



C1 EAST ELEVATION

SCALE - 1/8" = 1'-0"

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SITE PLAN SUBMITTAL 10/21/2021

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(ED-USE DEVELOPMENT 340 DEPOT ST

PROJECT

CONSULTANT

EXTERIOR ELEVATIONS

PROJECT NUMBER

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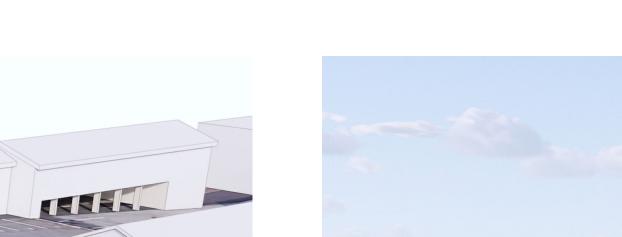
A-3

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VIEW 3
SCALE - NTS
FILENAME









VIEW 4
SCALE - NTS
FILENAME



PROJECT RENDERINGS SHEET TITLE

20-810

REV SITE PLAN SUB 04/14/2022

SITE PLAN SUBMITTAL 10/21/2021

DATE ISSUED

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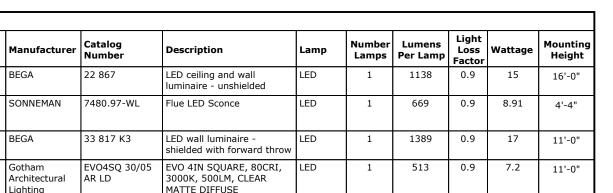
PROJECT NUMBER

A-5

SHEET NUMBER

CONSULTANT

2



Statistics Min | Max/Min Avg/Min Avg/Max Description Max Symbol Avg + 0.5 fc 27.7 fc 0.0 fc N/A N/A 0.0:1 OVERALL @ GRADE

EX. GAS MH RIM=777.28 310 DEPOT ST. ANN ARBOR, MI 48104 TAX ID 09-09-20-415-001

 $^{+}0.0$ $^{+}$

 $^{+}0.0$ $^{+}$

 $^{+}0.0$ $^{+}0.0$ $^{+}0.0$ $^{+}0.0$ $^{+}0.0$ $^{+}0.0$ $^{+}0.0$ $^{+}0.0$ $^{+}0.0$ $^{+}0.1$ $^{+}$

EX. FLOODPLAIN LINE (PER FEMA FIS: ELEV:779.7) $^{+}0.0$ $^{+}0.0$ $^{+}0.0$ $^{+}0.0$ $^{+}0.0$ $^{+}0.1$ $^{+}0.2$ $^{+}0.3$ $^{+}0.7$ $^{+}1.6$ $^{+}2.0$ EX. ELEC MH RIM=779.83 N-S T/COND=776.83 EX. FLOODPLAIN LINE (PER FEMA FIRM MAP)

 $^{+}0.0$ $^{+}0.0$ $^{+}0.0$ $^{+}0.0$ $^{+}0.0$ $^{+}0.0$ $^{+}0.0$ $^{+}0.0$ $^{+}0.0$ $^{+}0.1$ $^{+}0.1$ // EASEMENT L. 1694, P. 8

LOT 8 BLOCK

> – ex. Strm inlet RIM=786.49 FULL OF DEBRIS LOT 2

> > ORMSBY & PAGE'S ADDITION

TO THE CITY OF ANN ARBOR L. 36, P. 666 BLOCK

Schedule

Symbol

Quantity

Liahtina

EX. FLOODPLAIN LINE

EX. ELEC MH

RIM=778.97

N-W T/COND=776.47

(PER FEMA FIS: ELEV:779.7)

Alternates Note

THE USE OF FIXTURE ALTERNATES MUST BE RESUBMITTED TO THE CITY FOR APPROVAL.

CALCULATED AS THE MOUNTING HEIGHT LESS BASE

Mounting Height Note MOUNTING HEIGHT IS MEASURED FROM GRADE TO FACE OF FIXTURE. POLE HEIGHT SHOULD BE

HEIGHT.

General Note

1. SEE SCHEDULE FOR LUMINAIRE MOUNTING HEIGHT. 2. CALCULATIONS ARE SHOWN IN FOOTCANDLES AT: 0' - 0"

THE ENGINEER AND/OR ARCHITECT MUST DETERMINE APPLICABILITY OF THE LAYOUT TO EXISTING / FUTURE FIELD CONDITIONS. THIS LIGHTING LAYOUT REPRESENTS ILLUMINATION LEVELS CALCULATED FROM LABORATORY DATA TAKEN UNDER CONTROLLED CONDITIONS IN ACCORDANCE WITH ILLUMINATING ENGINEERING SOCIETY APPROVED METHODS. ACTUAL PERFORMANCE OF ANY MANUFACTURER'S LUMINAIRE MAY VARY DUE TO VARIATION IN ELECTRICAL VOLTAGE, TOLERANCE IN LAMPS, AND OTHER VARIABLE FIELD CONDITIONS. MOUNTING HEIGHTS INDICATED ARE FROM GRADE AND/OR FLOOR UP.

THESE LIGHTING CALCULATIONS ARE NOT A SUBSTITUTE FOR INDEPENDENT ENGINEERING ANALYSIS OF LIGHTING SYSTEM SUITABILITY AND SAFETY. THE ENGINEER AND/OR ARCHITECT IS RESPONSIBLE TO REVIEW

UNLESS EXEMPT, PROJECT MUST COMPLY WITH LIGHTING CONTROLS REQUIRMENTS DEFINED IN ASHRAE 90.1 2013. FOR SPECIFIC INFORMATION CONTACT GBA CONTROLS GROUP AT ASG@GASSERBUSH.COM OR 734-266-



SONNEMAN - A Way of Light | 151 Airport Drive, Wappingers Falls, NY 12590 | www.sonnemanawayofight.com

351 x 10" x 9"

Carton 1 L x W x H

Carton 1 GW

Coordinated Apertures I Multiple Layers of Light

page 1 uf 8

Multiple Layers of Light

General Illumination Square Downlight

LED wall luminaire : shelded with forward throw

LED wall luminaire - shielded with forward throw

various mounting heights. Downlight applications only.

(s.0.3% copper content) A380.0 aluminum alloy lear safety glass with optical texture

High temperature silicone gasket Mechanically captive stainless steel fasteners

Protection class IP64

Weight 3.7 lbs

Operating voltage:

System wattage Controllability

LED module wattage

Color rendering index

Lifetime at Ta = 50°C

LED color temperature

☐ 4000K - Product number + K4

3500K - Product number + K35

3000K - Product number + K3

Luminaire lumans Lifetime at Ta = 15°C

Minimum start temperature

Bestrical

his wall mounted LED luminaire features a forward throw light distribution

and is designed for the general illumination of pathways and walkways from

Luminaire housing constructed of die-cast marine grade, copper free

NRTL listed to North American Standards, suitable for wet locations

DEGA can supply you with suitable LED replacement modules for up to

All BEGA standard finishes are matte, lextured polyester powder coat with

□ Bronze (BRZ) □ Silver (SU) □ CUS:

Available colors III Black (BUIQ III White (WHT) III RAL:

20 years after the purchase of LED luminaires - see website for details

13.9 W 17 W

0-10V dimmable

1659 lumens (3000K)

>500,000 h (L70)

101,000 h (L70)

BEGA Product:

Project: Modified:

BEGA 1000 BEGA Way, Carpinteria, CA 53013 (505) 684-0533 Info@bega-us.com

(set to the dynamic nature original products are the associated behnologies, luminosis data on this break is subject to change at the observator of BIGA North-America. For the most current behnologies, please other to large us some to reproper BIGA 2018.

LED ceiling and wall luminaire - unshielded

The material thickness and strong polycarbonate diffuser makes this impact-resistant LED luminaire extremely robust. Arranged individually or in groups, they are great design elements for a host of lighting applications. Materials

Luminaire housing and guard constructed of die-cast marine grade, copper free (s 0.3% copper content) A360.0 aluminum alloy Impact resistant polycarbonate diffuser High temperature silicone gasket Mechanically captive stainless steel fasteners

NRTL listed to North American Standards, suitable for wet locations Yotection class IP65 Weight 3.8 lbs Electrical

120-277VAC -30°C 11.8W Operating voltage Minimum start temperature LED module wattage System wattage Controllability 0-10V dimmable Color rendering index 1138 lumens (3000K) Luminaire lumens Lifetime at Ta = 15°C Lifetime at Ta = 50°C 500,000 h (L70) 507,000 h (L70)

LED color temperature ☐ 4000K - Product number + K4 3500K - Product number + K35 3000K - Product number + K3

2700K - Product number + K27 BEGA can supply you with suitable LED replacement modules for up to 20 years after the purchase of LED luminaires - see website for details.

All BEGA standard finishes are matte, lextured polyester powder coat with minimum 3 mil thickness. Available colors III Black (BUIQ III White (WHT) III RAL: □ Bronze (BPQ) □ Silver (SUI) □ CUS:

BEGA Product:

Project:

Modified:

BEGA

LED ceiling and wall luminaire - unshelded

Bounding Ray™ optical design 2.5 SDCM; 85 CRI typical, 90+ CRI optional Unitized optics mechanically attach the light Fintures are wet location, covered ceiling engine to the lower reflector for complete opti-ENERGY STAR* certified product cal alignment Available with 10% dimming, 1% dimming, or 45" cutoff to source and source image Fully serviceable and upgradeable lensed LED Batwing distribution with feathered edges light engine provides even illumination on horizontal and 70% lumen maintenance at 60,000 hours vertical surfaces Distribution TESTINA TESTINA Superior Performance Delivered Lamenc* 271 573 808 1000 1527 1994 2580 1010 1012 Methage 31 72 78 88 107 195 257 302 384 Lamino per Walt 87.4 79.5 192.3 113.8 111.5 192.3 190.4 59.7 54.1

Luminaire Type:

General Illumination Layer I EVO High Center Beam Layer I Incita EVO + Incito — Multiple Layers of Light sillip (T) (I) (C) 0 Support Patient Room EVOISQ-II-DEEN COTIAN ARCHTECTURAL DOWNLOATING | 1400 Under Read Conyect, GA 30012 | P-800-705-5289 (TSTR) | gethamighting.com

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A B C

BEGA 1000 REGA Way, Carpoteria, CA 50013 (500) 654-0533 (eficilities us core

Designer TV/KB Date Scale

9 10/21/2021 Not to Scale Drawing No. #21-67963-V1 1 of 1



MW-7

<u>Plan View</u> Scale - 1" = 16ft

EX. GAS VENTS

EX. GAS MH

RIM=777.11

Ordering Note FOR INQUIRIES CONTACT GASSER BUSH AT QUOTES@GASSERBUSH.COM OR 734-266-6705.

Drawing Note

THIS DRAWING WAS GENERATED FROM AN ELECTRONIC IMAGE FOR ESTIMATION PURPOSE ONLY. LAYOUT TO BE VERIFIED IN FIELD BY OTHERS.

FOR MICHIGAN ENERGY CODE AND LIGHTING QUALITY COMPLIANCE.