
ISSUED FOR: SITE PLAN APPROVAL FOR CITY COUNCIL



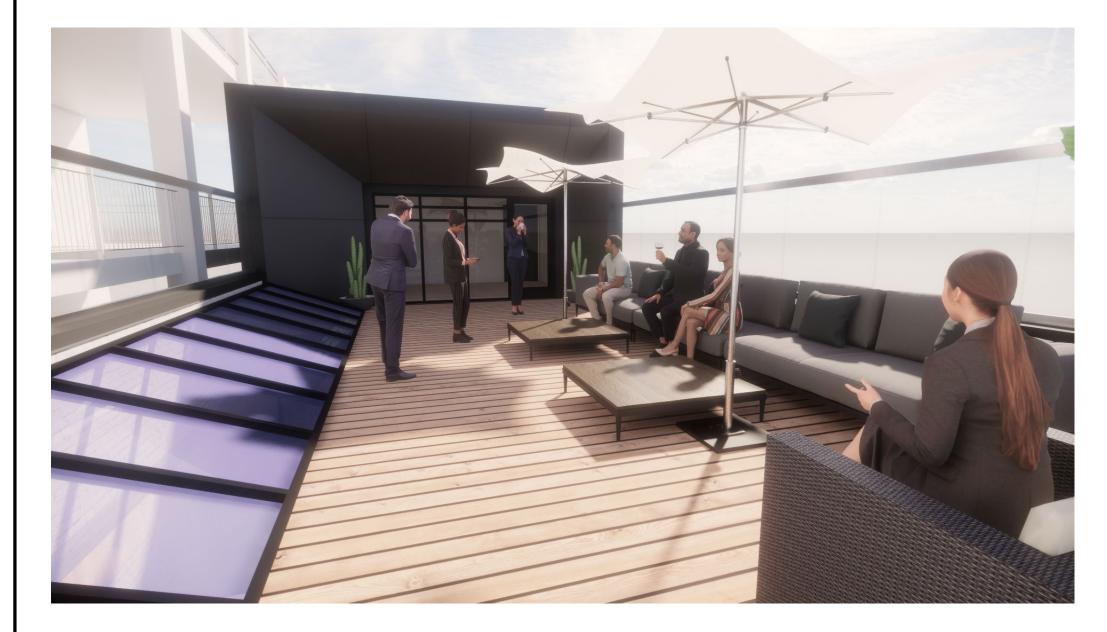

OVERHEAD PERSPECTIVE 02

PATIO VIEW


FOURTH AVE. - STREET VIEW 02

REFERENCE SYMBOLS

TITLE IDENTIFICATION

SECTION IDENTIFICATION NUMBER SCALE: ?


ELEVATION LOCATION IDENTIFICATION

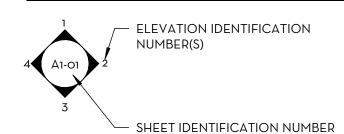

SECTION LOCATION IDENTIFICATION

SECTION IDENTIFICATION NUMBER (SAME NUMBER ON SHEET WHERE


BUILDING SECTION

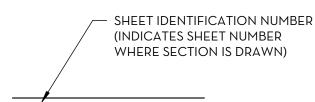

DETAIL SECTION

ELEVATION INDICATION

COLUMN INDICATION

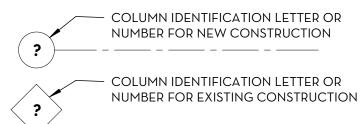

COLUMN IDENTIFICATION LETTER OR NUMBER FOR FUTURE CONSTRUCTION

DETAIL LOCATION IDENTIFICATION

IDENTIFICATION NUMBER WHERE DRAWN) -SHEET IDENTIFICATION NUMBER (INDICATES SHEET NUMBER WHERE PLAN OR SECTION DETAIL IS


PARTITION TYPE INDICATION

WALL TAG

MATERIAL OR WORK DIVISION INDICATION



ROOF OR RAMP PITCH INDICATION

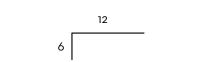

ROOF OR RAMP SLOPE INDICATION

SLOPE _

ROOM NAME AND NUMBER INDICATION

ROOM NAME ROOM IDENTIFICATION NUMBER

DOOR NUMBER INDICATION

KEYED NOTE SYMBOLS

MATCH LINE - REFER TO SHEET X/XX-00

PROJECT DESCRIPTION & INFORMATION

THE BUILDING HAS GONE THROUGH MANY CHANGES. THE ORIGINAL 2 STORY WOOD ERROCOTTA FASADE. IN 1949 A 2ND ADDITION WAS ADDED ON THE REAR OF THE BUILDING PUTTING IT IN ITS FORM WE SEE TODAY.

NEW ADDITION ADDING 2 STORYS ON THE REAR (EAST) SIDE OF THE EXISTING BUILDING, AND ROOF TOP DECK. THE INTERIOR WILL BE COMPLETELY RENOVATED FOR THE NEW OWNER. ALL HISTORIC WINDOWS WILL BE RESOTRED AND STOMS WILL BE ADDED TO PROTECT THE INVESTMENT. POINTING WORK WILL BE DONE TO THE NORTH AND SOUTH BRICK WALLS AS WELL AS THE WEST LIMESTONE FASADE. THE BUILDING IS A LISTED HISTORIC BUILDING AND

ANN ARBOR ZONEING ORDINANCE

PROPERTY ID - 09-09-29-126-006 ZONEING DISTRICT - D1 DOWNTOWN CORE DISTRICT OVERLAY DISTRICT - AREA 6 - MAINSTREET USE (TABLE 5-15) GENERAL OFFICE - PERMITTED USE

FIRST FLOOR SECOND FLOOR 2,114 SF PENTHOUSE

CURRENT SF - 5,247 SF SECOND FLOOR ADDITION - 455 SF THIRD FLOOR ADDITION - 455 SF TOTAL ADDITION - 910 SF PROPOSED TOTAL SF - 6,157 SF

MAX FAR = 400 (TABLE 5:17-4)

GROSS LOT AREA 2,200 SF

STREETWALL HEIGHT (TABLE 5:17-6) - MIN. 2 STORIES, MAX. 4 STORIES

OFFSET AT TOP OF STREET WALL REQUIRED AVERAGE (TABLE 5:17-4) - 5'-0" PROVIDED - 72'-3 1/2"

MAX BUILDING HEIGHT (TABLE 5:17-4) - 180'-0" PROVIDED - 38'-2"

SIDE & REAR SET BACKS(§ 5.17.6) - NONE PROVIDED - NONE PROVIDED (EXISTING STRUCTURE) FRONT SETBACK(§ 5.17.7) - MIN. O'-O" MAX. 1'-O" AT STREET WALL PROVIDED - NONE PROVIDED (EXISTING STRUCTURE)

OFF STREET PARKING(§ 5.19.3a) - NONE REQUIRED PROVIDED - NONE PROVIDED BIKE PARKING (§ 5.19.3c) - NONE REQUIRED

PROVIDED - NONE PROVIDED

SOLID WASTE STATEMENT: SOLID WASTE & RECYCLING BINS WILL EXIT THORUGH THE REAR DOOR (EAST) ON SERVICE DAY AND BE STORED INSIDE THE BUILDING. THE NEW OWNER WILL SET UP SERVICE WITH THE CITY ONCE THE BUILDING IS OCCUPIED. REFER TO SITE PLAN FOR

TRAFFIC STATEMENT: THERE WILL BE NO CHANGE TO THE EXISTING VEHICULAR, BICYCLE OR PEDESTRIAN PEAK USAGE, BASED ON THE USE.

<u>PUBLIC SIDEWALK MAINTENANCE STATEMENT:</u> ALL SIDEWALKS SHALL BE KEPT AND MAINTAINED IN GOOD REPAIR BY THE OWNER OF THE LAND ADJACENT TO AND ABUTTING THE SAME. PRIOR TO THE ISSUANCE OF THE FINAL CERTIFICATE OF OCCUPANCY FOR THIS SITE, ALL EXISTING SIDEWALKS IN NEED OF REPAIR MUST BE REPAIRED IN ACCORDANCE WITH CITY STANDARDS.

SIDEWALK CLOSURE STATEMENT: FOR A PERIOD OF +/- 3MO. DURING THE ACTIVE CONSTRUCTION PHASE IT WILL BE REQUIRED THAT THE PARKING METERS BE BAGGED FOR STAGING OF MATERIALS. WE WILL GO THROUGH THE NECESSARY APPROVALS AND PERMITS.

PRE-CONSTRUCTION - 6-10 WEEKS ACTIVE CONSTRUCTION - 20-32 WEEKS

ESTIMATED CONSTRUCTION COST:

MYSTIC FALLS LLC, MANAGING PARTNER

ARCHITECT

DOUG NECCI, AIA 50850 APPLEBROOK DRIVE NORTHVILLE, MI 48167 (248) 880-6523

MECHANICAL ENGINEER CLIMATEK

NITIN PUROHIT CLIMATEK2007@YAHOO.COM

CLIMATEK

CIVIL ENGINEER

TIMOTHY ZIMMER 3300 S. OLD US HWY 23 BRIGHTON, MI 48114

CONSTRUCTION MANAGER

J&N CONTRACTING JASON COOPER (734) 827-4292

PROJECT TEAM

DRN ARCHITECTS

DNECCI@DRNARCHITECTS.COM

FRACTAL DESIGNS LLC DAVID MURPHY, NCARB, AIA 930 W. HURON STREET ANN ARBOR, MI 48103 DAVID@FRACTAL-DESIGNS.COM

STRUCTURAL ENGINEER

(248) 318-0598 **ELECTRICAL ENGINEER**

NITIN PUROHIT

CLIMATEK2007@YAHOO.COM (248) 318-0598

LIVINGSTON ENGINEERING

TIM@LIVINGSTONENG.COM (810) 225-7100

JASON@JNCONTRACTING.COM

SHEET# REVISION 01 GENERAL INFORMATION COVER SHEE DRN ARCHITECTS NOTES & MOUNTING DETAILS BUILDING CODE ANALYSIS MRCEB 2015 DRN ARCHITECTS LIVINGSTON ENGINEERING STRUCTURAL STRUCTURAL FRAMING PLAN DRN ARCHITECTS ARCHITECTURAL DEMOLITION FLOOR PLANS DRN ARCHITECTS FLOOR PLANS DRN ARCHITECTS ELEVATIONS DRN ARCHITECTS SECTIONS & WALL SECTIONS DRN ARCHITECTS ENLARGED FLOOR PLANS DRN ARCHITECTS

DRAWING INDEX - PROJECT

APPROVAL RECIEVED MARCH 9TH, 2021

COMMUNITY ANALYSIS: THE LAND TITLE BUILDING WILL HAVE A POSITIVE IMPACT ON THE COMMUNITY OF ANN ARBOR. ONCE COMPLETE THE ADVERTISING AGENCY "HOOK" WILL BE OCCUPYING THE SPACE. THEY CURRENTLY HAVE 36 EMPLOYEES. A STATEMENT HAS BEEN PROVIDED BY HOOK

DRN ARCHITECTS

DRN ARCHITECTS

DRN ARCHITECTS

STAIR DETAILS

SCHEDULES

INTERIOR RENDERING

DETAILS

DEGREES IN DESIGN.

WITH OUR VISION TO BE EVERYONE'S FAVORITE AGENCY, WE'VE PLACED A LOT OF IMPORTANCE ON THE EMPLOYEE EXPERIENCE. AND THE PART OF OUR CULTURE THAT REALLY DEFINES US_THAT BRINGS OUT THE BEST IN US, AND EXCITES OUR PEOPLE—IS THE WORK WE DO FOR OTHERS.

OVER THE PAST FEW YEARS, WE'VE NARROWED THAT WORK TO FOCUS ON THE CAUSES OUR ENTIRE TEAM CAN RALLY AROUND-MOST NOTABLY, EXPOSING YOUNG PEOPLE IN OUR LOCAL COMMUNITIES TO CREATIVE OPPORTUNITIES.

IN SUPPORT OF THE ANN ARBOR ARTS CENTER, WE PROVIDE FUNDING, PROGRAMMING

AND STAFFING THROUGHOUT THEIR ANNUAL SUMMER CAMPS. WE MAKE CLAYMATION MOVIES, TIE-DYE HUNDREDS OF TEES, AND TEACH PRACTICAL TOOLS FOR EXPRESSING AND DEVELOPING CREATIVITY. FOR YEARS WE'VE WORKED WITH TEEN CENTER, THE NEUTRAL ZONE, TO HELP

FURTHER THEIR MISSION TO PROMOTE PERSONAL GROWTH THROUGH ARTISTIC

EXPRESSION AND COMMUNITY LEADERSHIP. WE SEE A BIT OF OURSELVES IN THEIR

MEMBERS, AND HAVE JUMPED IN TO TEACH THE KIDS HOW TO DESIGN AND MAINTAIN AN ORGANIZATION WEBSITE. AND WE'RE CURRENTLY MENTORING THEM IN THE LAUNCH OF A WRITING PROGRAM. DUE TO OUR TEAM'S GROWING INTEREST IN PARTICIPATING IN INITIATIVES LIKE THIS, WE HAVE EXPANDED OUR MENTORSHIP OUTREACH TO INCLUDE A MULTIFACETED CURRICULUM WITH ALEXANDER HAMILTON HIGH SCHOOL IN CULVER CITY, CA AS WELL

AS A PEN PAL-STYLE PROGRAM, PAIRING HOOK TEAM MEMBERS WITH STUDENTS FROM

HBCUS AND LOCAL COMMUNITY COLLEGES PURSUING CERTIFICATES OR ASSOCIATE


THROUGH THIS WORK, WE HOPE TO INCREASE THE RACIAL, GENDER, AND SOCIOECONOMIC DIVERSITY OF OUR INDUSTRY, WHILE ALSO DEVELOPING EMERGING LEADERS ON OUR TEAM.

IN ADDITION TO THIS COMPANY-WIDE FOCUS ON YOUTH EMPOWERMENT, WE SET ASIDE TIME ON EVERYONE'S SCHEDULE TO USE THEIR CREATIVE TALENTS FOR GOOD, AND OUR TEAMS CHOOSE THE ISSUES THEY WANT TO SUPPORT. AS A RESULT:

HTTPS://BYHOOK.COM/WORK/THE-BIG-DEAL-2018

WE WORKED WITH THE US VOTE FOUNDATION TO LAUNCH A DIGITAL CAMPAIGN TO HELP ENCOURAGE PEOPLE TO GET OUT AND VOTE IN THE 2018 MIDTERM ELECTIONS: IN 2019, EFFORTS WERE FOCUSED ON THE CLIMATE CRISIS—CREATING AN ANIMATED FILM AND SITE TO INSPIRE OTHERS TO EDUCATE THEMSELVES ABOUT THE URGENCY OF THE SITUATION AND SEEK OPPORTUNITIES TO GET INVOLVED IN THE SOLUTION: INCASEYOUHAVENTNOTICED.COM

IN 2020, WE TURNED OUR FOCUS TO THE COVID-19 PANDEMIC. WE REPURPOSED OUR TECHNICAL SKILLS TO DESIGN AND 3D PRINT FACE SHIELDS FOR FRONTLINE WORKERS, AND OUR CREATIVE TEAM HELPED DEVELOP A DIGITAL CAMPAIGN TO PROMOTE A2 HELPS, A CHARITY CREATED TO SUPPORT LOCAL BUSINESSES AND FRONT-LINES WORKERS IN OUR HOMETOWN.

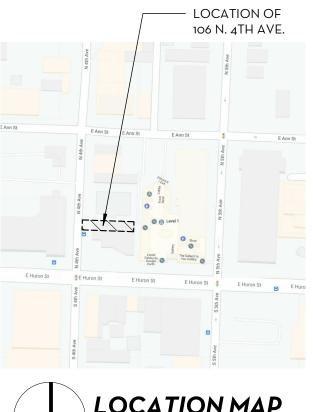

LOCATION MAP NOT TO SCALE


SHEET NO.

 $\frac{Z}{\Box}$

BUIL

GI-01

ALTA/NSPS LAND TITLE SURVEY

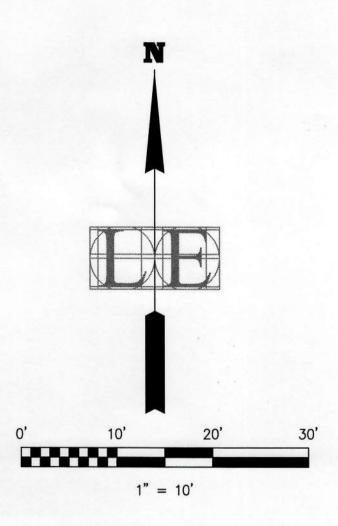


GAS SHUTOFF VALVE

ELECTRIC HANDHOLE WATER SHUTOFF VALVE


SIGN

UGHT POLE PARKING METER FOUND IRON ROD

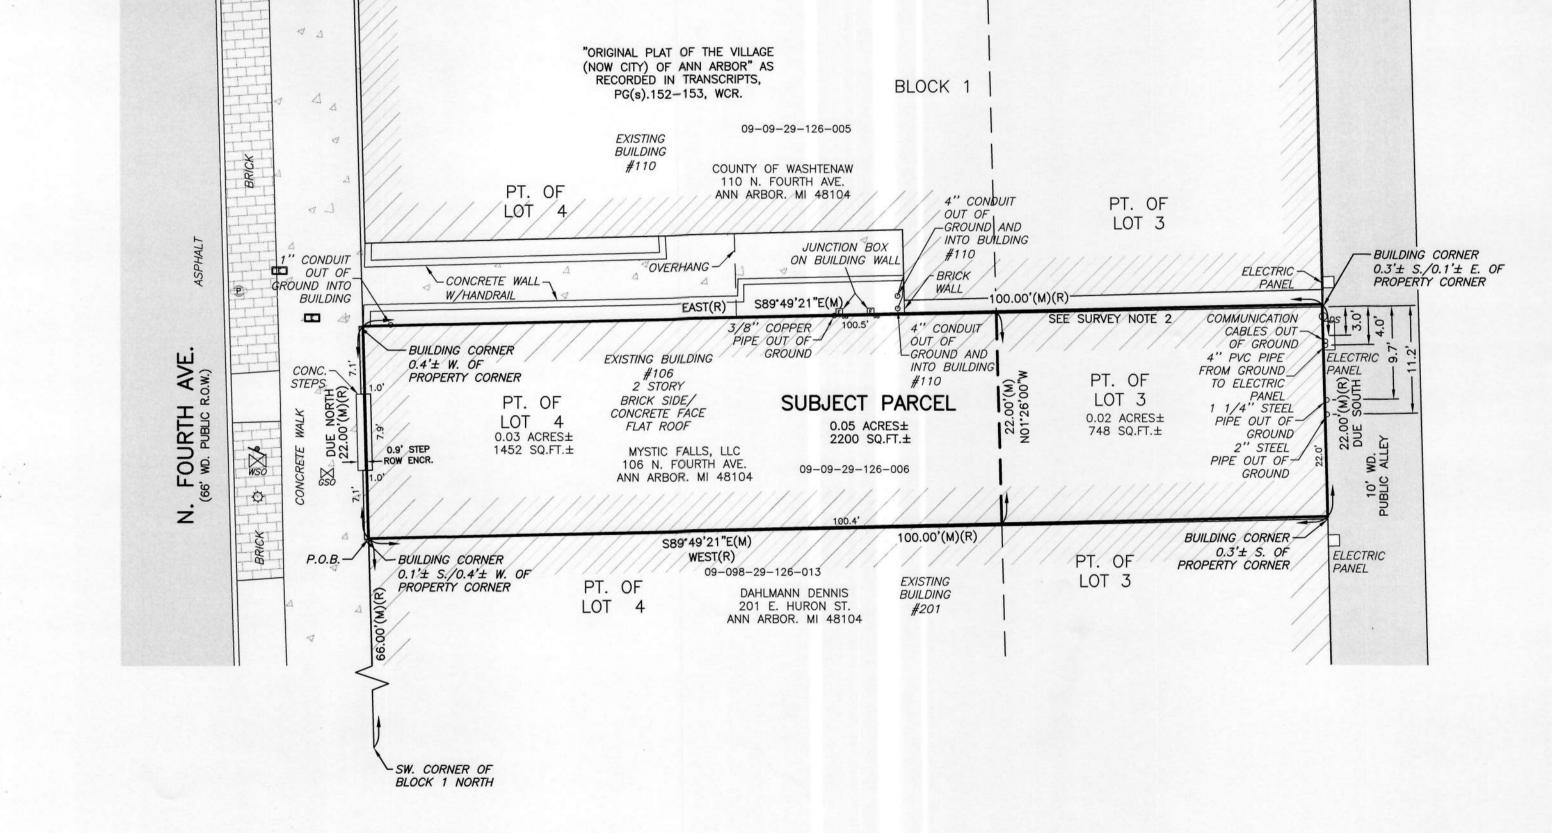

SURVEY NOTES:

- 1) As to Table A Item 1, No property corners were found or set. The corners were inaccessible, or the corners fell inside the building walls. The Survey shows the relationship of the building corners with respect to the property line.
- 2) There are utility conduits and wires, that run along the outside of the subject property's North and East building wall lines. These appear to service both the subject building and the neighboring buildings.

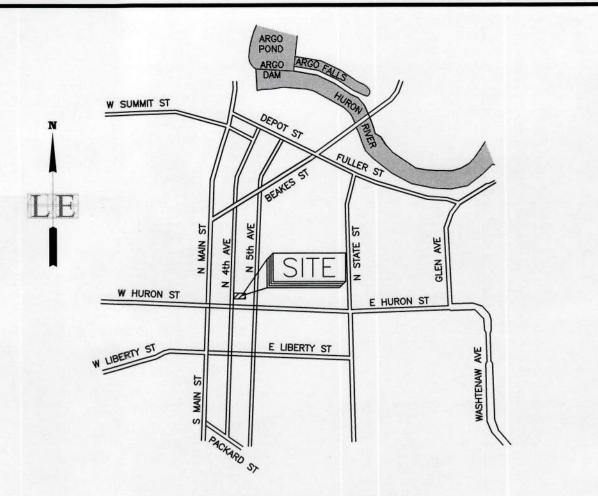

ENGINEERING SURVEYING PLANNIN

LIVINGSTON

SURVE

LAND

ALTA/NSPS

LOCATION MAP

LEGAL DESCRIPTION (As provided by One Republic National Title Insurance Company, Policy No. OX-13229482, Effective Date: April 1, 2020 @

Commencing on the East line of Fourth Avenue at a point 66 feet North of the Southwest corner of Block I North of Huron Street, Range 5 East, and running thence North 22 feet; thence East 100 feet to a North alley; thence South 22 feet; thence West 100 feet to the Place of Beginning, being a part of Lots 3 and 4 in Block I North of Huron Street, Range 5 East, Original Plat of the Village (now City) of Ann Arbor, as recorded in Transcripts, Pages 152 and 153, Washtenaw County Records.

SCHEDULE B-Section II Exceptions (As provided by One Republic National Title Insurance Company, Policy No. OX-13229482, Effective Date: April 1, 2020 @ 5:00 p.m.)

NO SURVEY MATTERS LISTED

TABLE A ITEMS

more or less (2192 sft)

As to Table A Item 8, substantial features observed as of June 19, 2021 have been shown on the survey.

As to Table a Item 13, as of June 30, 2021, we have shown the names of adjoining platted property owners based on available online tax records at "https://gisappsecure.ewashtenaw.org/mapwashtenaw/".

CERTIFICATION


To: ONE REPUBLIC NATIONAL TITLE INSURANCE COMPANY & MYSTIC FALLS, LLC;

This is to certify that this map or plat and the survey on which it is based were made in accordance with the 2021 Minimum Standard Detail Requirements for ALTA/NSPS Land Title Surveys, jointly established and adopted by ALTA and NSPS, and includes Items 1, 2, 4 (in square feet or acres), 8 & 13 of Table A thereof. The fieldwork was completed on June 19, 2021.


Date of Plat or Map: July 1, 2021

Signed: Dennis J. Long, P.S. Michigan P.S. #50913



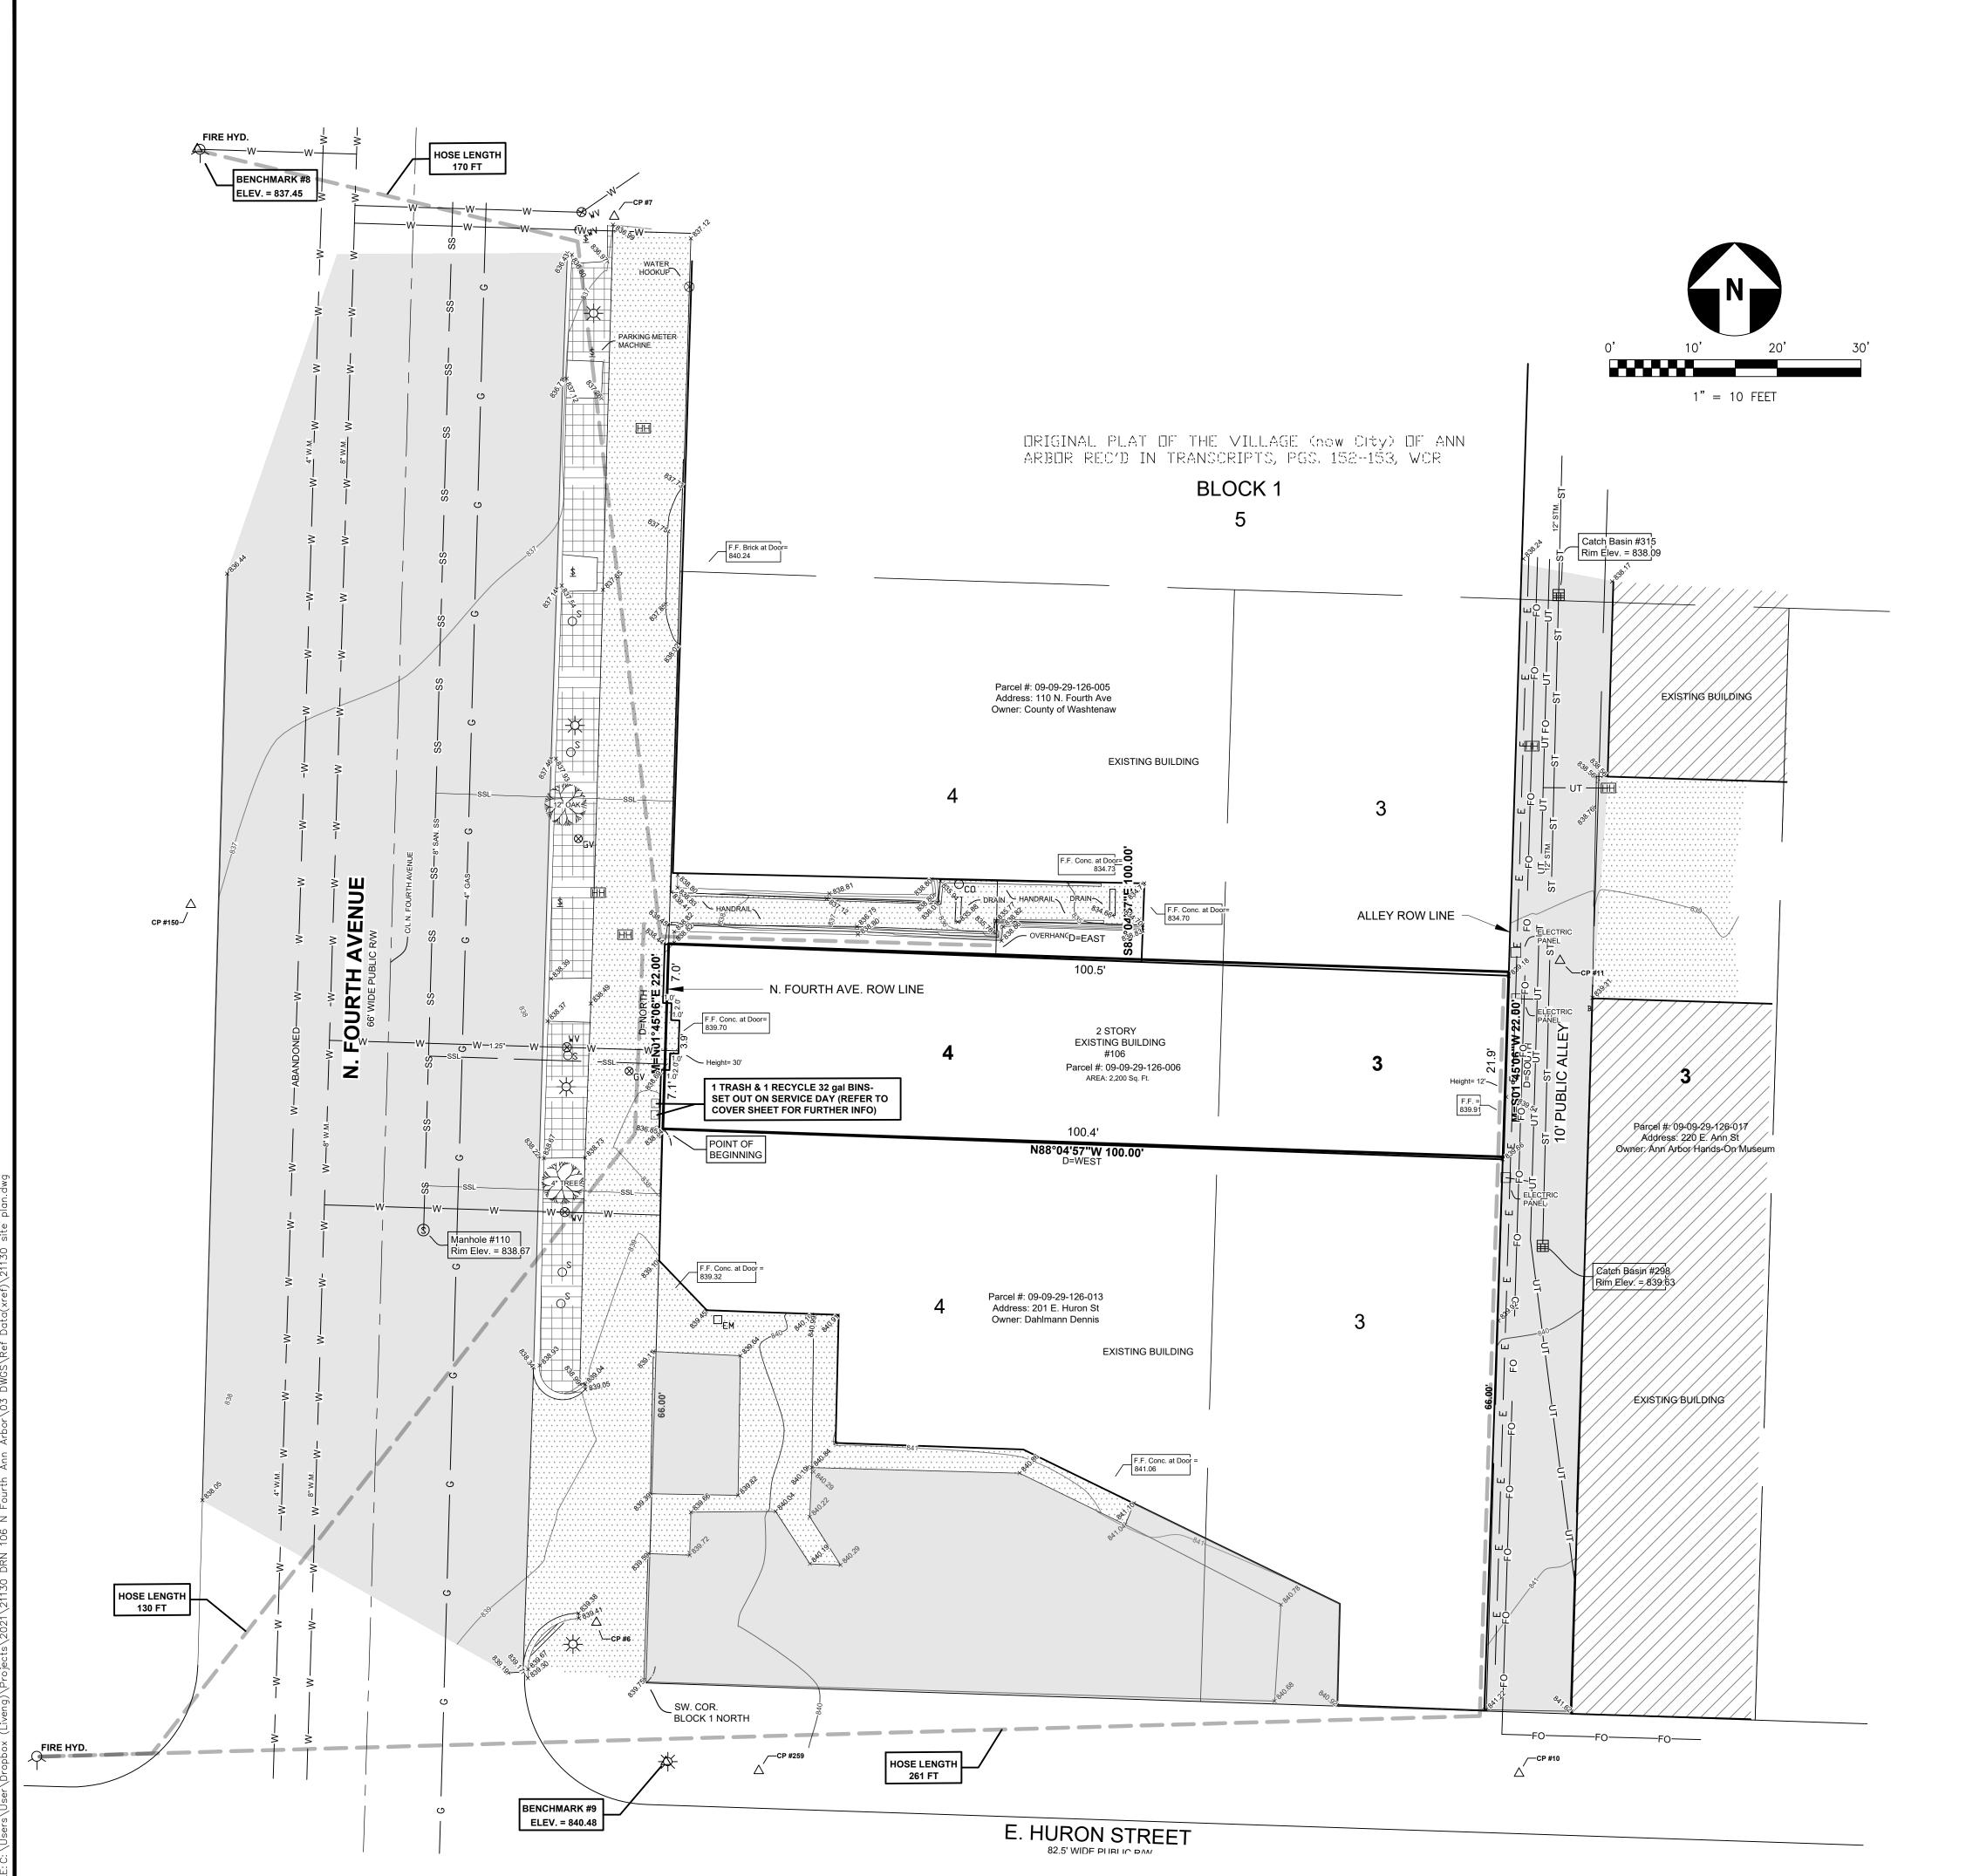

LEGEND Deciduous Tree Electric Meter Gas Valve Hand Hole Hydrant Light Pole Parking Meter — FO — Fiber Optic

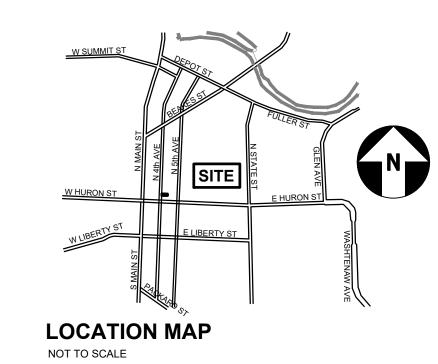

ENGINEERIN

BENCHMARKS

BENCHMARK #8 ELEV. = 837.45 (NAVD88)

Fire Hose Lay Route

— UT — Underground Telephone

Concrete

Existing Building

West bolt painted black on hydrant 190' +/- North of E. Huron Street on the West side of N. Fourth Avenue 8' +/-Est of retaining wall.

BENCHMARK #9 ELEV. = 840.48 (NAVD88)

Northwest bolt painted pink on light pole at the Northeast corner of E. Huron Street and N. Fourth Avenue 4' +/-North of edge of concrete and 18' +/- Southeast of light pole.

DESCRIPTION

Property located in the City of Ann Arbor, Washtenaw County, Michigan: Commencing at the East line of Fourth Avenue at a point 86 feet North of the Southwest corner of Block 1 North of Huron Street, Range 5 East, and running thence North 22 feet; thence East 100 feet to a North alley; thence South 22 feet; thence West 100 feet to the Place of Beginning, being a part of Lots 3 and 4 in Block 1 North of Huron Street, Range 5 East, Original Plat of the Village (now City) of Ann Arbor, as recorded in Transcripts, Pages 152 and 153, Washtenaw

(Warranty Deed as recorded in Liber 4788, Page 899, Washtenaw County Records.)

*NOTE: There appears to be a typo in the description provided; <u>86</u> feet should be <u>66</u> feet, further deed research is recommended.

SURVEYOR'S NOTES

- 1) Flood Zone Classification: An examination of the National Flood Insurance Program's Flood Insurance Rate Map for Community Number 260213, Map Number 26161C0263E, with an Effective Date of April 3, 2012, shows this parcel to be located in Zone X.
- 2) Lacking excavation, the exact location of underground features cannot be accurately, completely, and reliably depicted. In addition, in some jurisdictions, 811 or other similar utility locate requests from surveyors may be ignored or result in an incomplete response. Where additional or more detailed information is required, the client is advised that
- 3) NOTE TO CONTRACTORS: 3 (THREE) WORKING DAYS BEFORE YOU DIG, CALL MISS DIG AT TOLL FREE 1-800-482-7171 FOR UTILITY LOCATIONS ON THE

excavation and/or a private utility locate request may be necessary.

SITE PLAN NOTES:

- 1. TOPOGRAPHIC INFORMATION SHOWN ON SITE PLAN IS BASED ON SURVEY PREPARED BY NEDERVELD INC., PROJECT NO. 205000028, DATED 03/06/2020, AND PROVIDED BY OWNER.
- 2. NO SITE WORK MODIFICATIONS OR IMPROVEMENTS ARE PROPOSED AS PART OF THIS SITE PLAN.
- 3. BUILDING SHALL BE SERVICED BY EXISTING UTILITY CONNECTIONS.
- 4. BASED ON TITLE WORK PROVIDED BY THE OWNER THERE ARE NO EASEMENTS ON THE SUBJECT PROPERTY.
- 5. BOOSTER PUMPS WILL NOT BE USED FOR THE BUILDING WATER SERVICE LEAD.
- 6. THERE IS NOT AN EXISTING FIRE SERVICE SPLIT OFF THE WATER SERVICE LEAD INSIDE OF THE BUILDING.
- 7. NO FIREWALLS EXIST OR WILL BE CONSTRUCTED AS PART OF THIS PROJECT.
- 8. ALL SIDEWALKS SHALL BE KEPT AND MAINTAINED IN GOOD REPAIR BY THE OWNER OF THE LAND ADJACENT TO AND ABUTTING THE SAME. PRIOR TO THE ISSUANCE OF THE FINAL CERTIFICATE OF OCCUPANCY FOR THIS SITE, ALL EXISTING SIDEWALKS IN NEED OF REPAIR MUST BE REPAIRED IN ACCORDANCE WITH CITY STANDARDS.

SANITARY FLOW OFFSET MITIGATION CALULATION:

TYPE OF FACILITY / USE: DESIGN DRY WEATHER FLOW RATE: GROSS FLOOR AREAS:

NON-MEDICAL OFFICE SPACE 0.06 gpd/sq.ft. of gross floor area 4,296 SF (EXSTING) + 455 SF (new building area) 4,751 SF Total (PROPOSED)

Existing Development has 4,296 sf x .06 GPD/sf Proposed Development has $4,751 \text{ sf } \times .06 \text{ GPD/sf} = 285 \text{ GPD}$ Net increase from proposed development (285-258) = 27 GPD

Peak Flow = 27 GPD x 4 (peaking factor) x 1.1 (System Recovery Factor) = 119 GPD

(119 GPD x 1 day/24 hrs x 1 hour/60 mins) = .08 GPM Peak Flow to be mitigated





DRN & ASSOCIATES, ARCHITECTS

© COPYRIGHT DRN AI


LAND TITLE BUILDING

106 N. FOURTH STREET
ANN ARBOR, MI 48103


FLOOR PLANS


DATE: 04/21/2021 SHEET NO.

A1-02

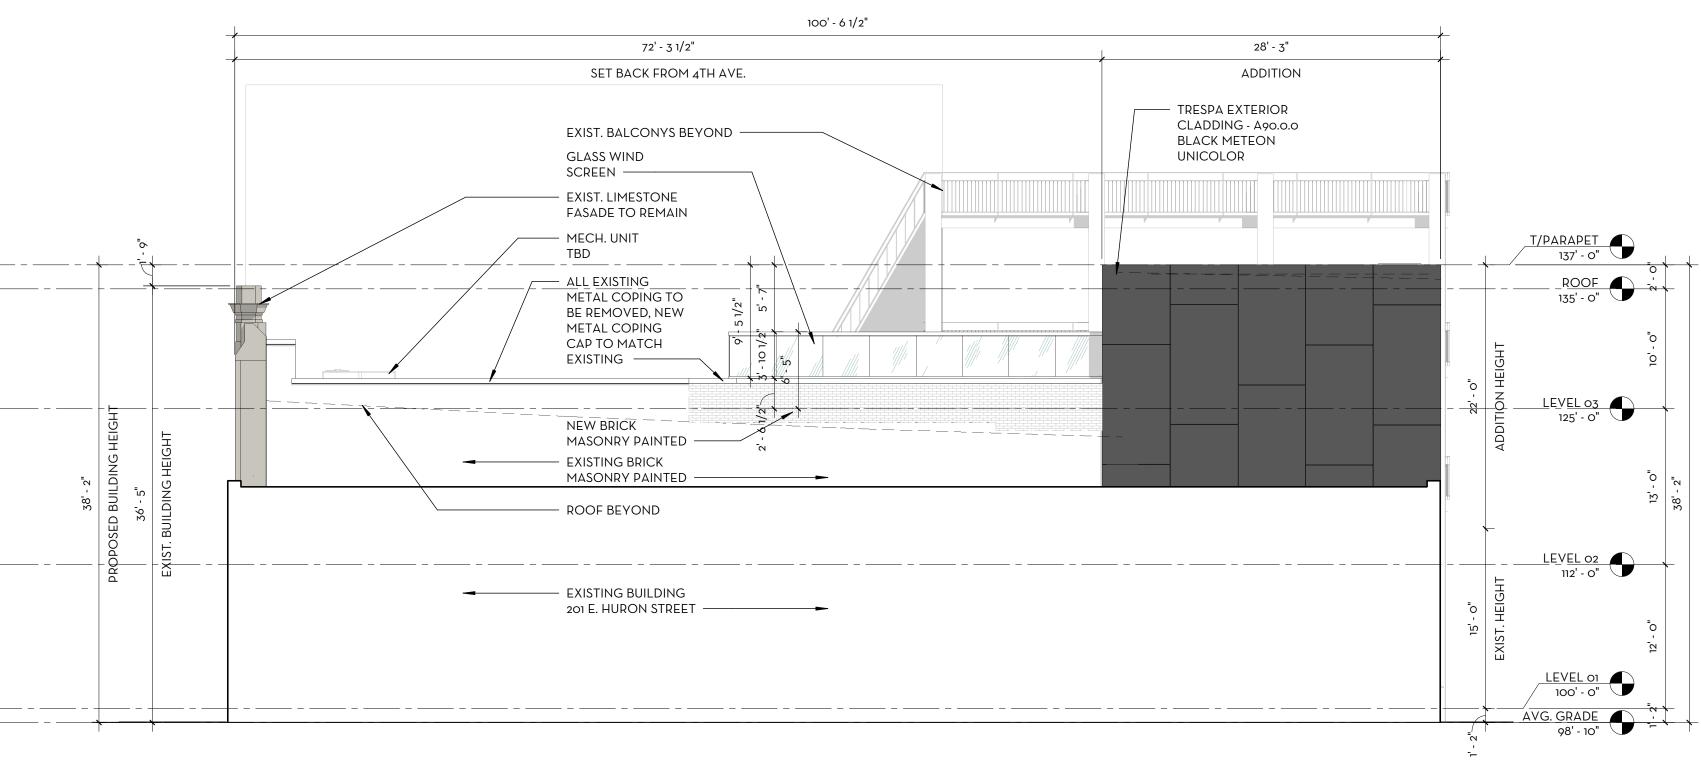


5 | SOUTH ELEVATION SCALE: 1/8" = 1'-0"

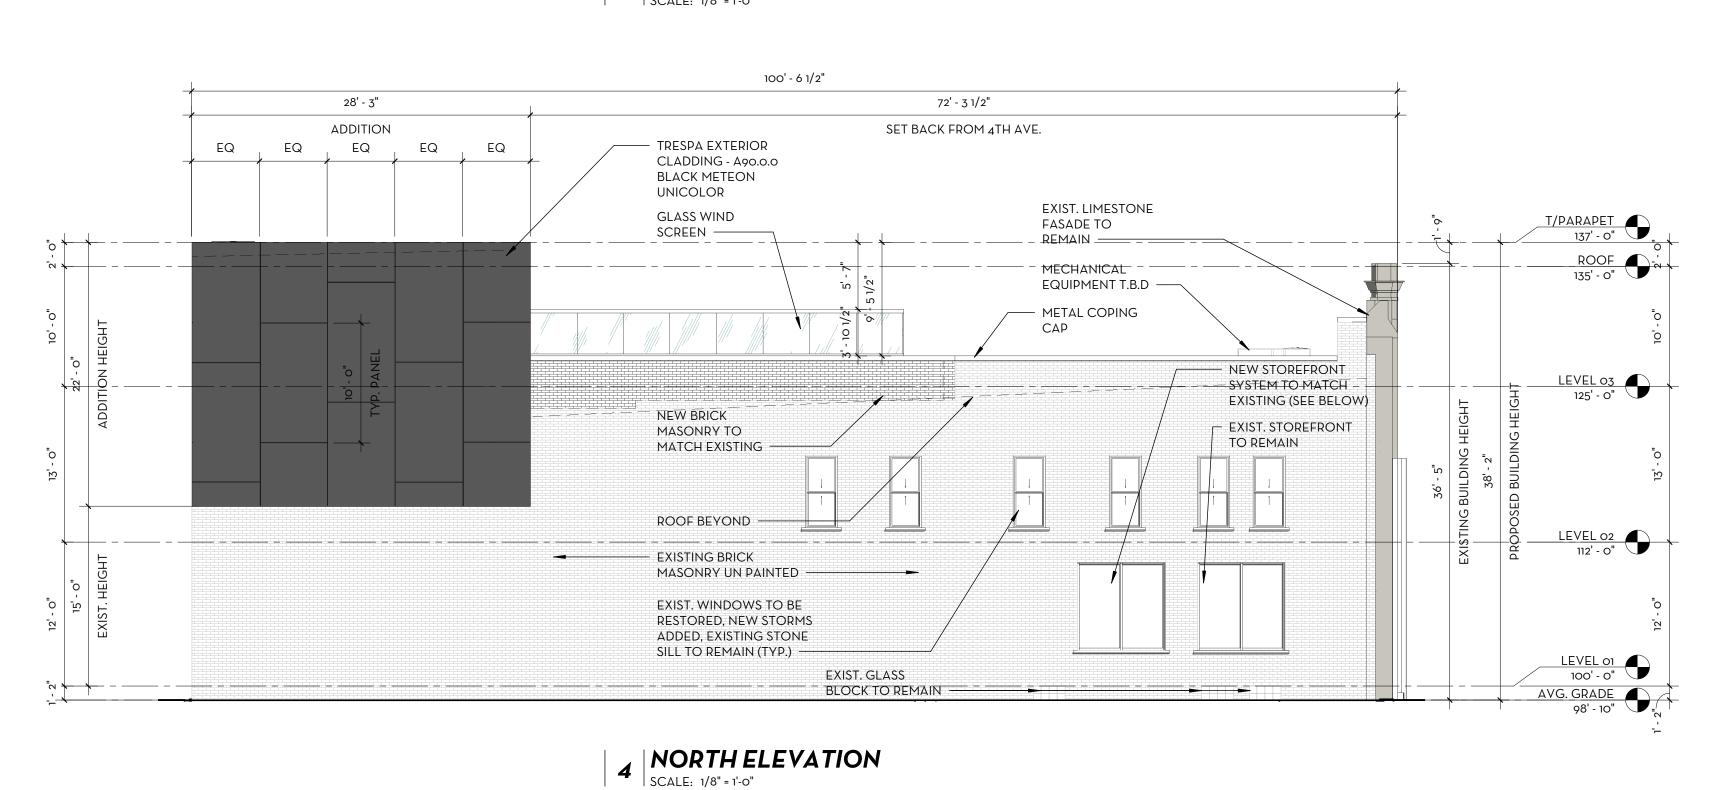

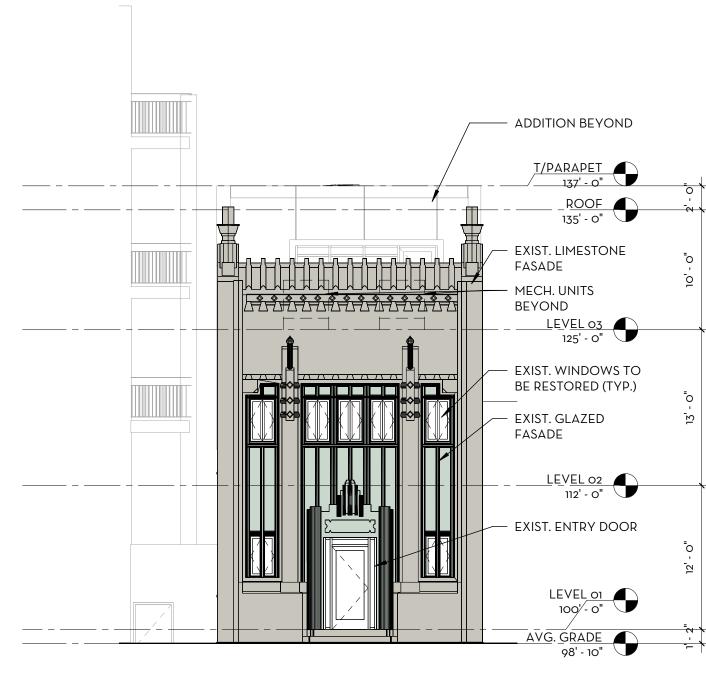

2 | WEST ELEVATION SCALE: 1/8" = 1'-0"

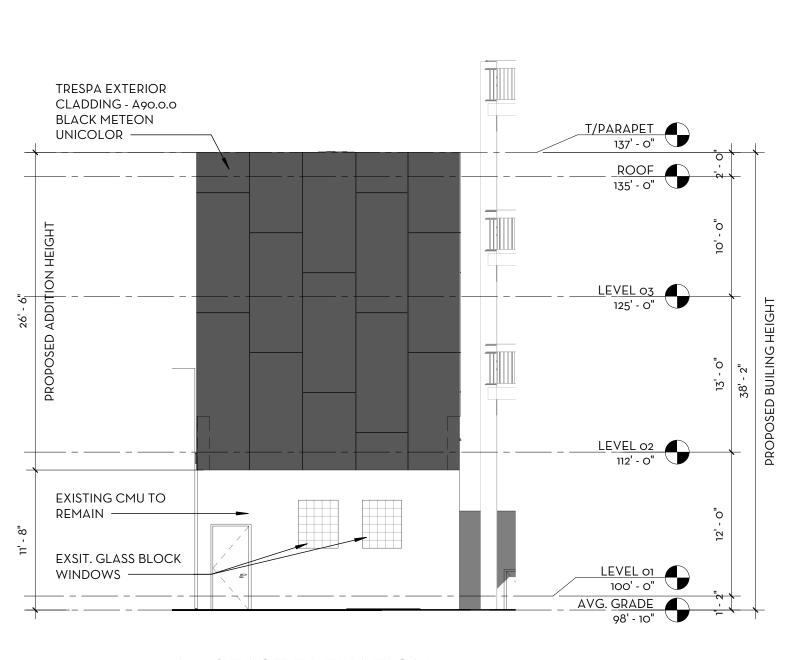

DATE: 04/21/2021 SHEET NO.

A2-01

BUILDING

AND

ELEVATIONS