# PLANNING AND DEVELOPMENT SERVICES STAFF REPORT

For Planning Commission Meeting of April 7, 2015

SUBJECT: Staybridge Suites & Retail Rezoning and Planned Project Site Plan File Nos. SP14-057 & Z14-028

# PROPOSED CITY PLANNING COMMISSION MOTION

The Ann Arbor City Planning Commission hereby recommends that the Mayor and City Council approve Staybridge Suites & Retail rezoning from RE (Research District) to C2B (Business Service District).

# PROPOSED CITY PLANNING COMMISSION MOTION

The Ann Arbor City Planning Commission hereby recommends that the Mayor and City Council approve the Staybridge Suites & Retail Planned Project Site Plan.

# STAFF RECOMMENDATION

Staff recommends that the zoning be **postponed** to allow the petitioner additional time to address staff comments.

Staff recommends that the planned project site plan be **postponed** to allow the petitioner additional time to address landscaping and engineering comments.

# **LOCATION**

The site is located on the east side of South State Street, south of Research Park Drive (South Area). This site is located in the Malletts Creek Watershed.

# **DESCRIPTION OF PETITION**

The site currently is zoned RE, Research District, and is approximately 3.5 acres in size. The petitioner proposes rezoning this site to C2B, Business Service District, demolishing the vacant 17,500-square foot office building and constructing a two-story, 9,120 sf retail building and a four-story, 90,198 sf extended stay hotel with 134 rooms. This project is to be constructed in one phase with the total estimated construction cost of \$6,000,000.

Access to the site will be provided through an existing driveway off Research Park Drive, which will lead to a combined parking lot of 168 parking spaces. Three bicycle parking spaces are proposed inside the hotel and four hoop spaces near the retail store entrance.

A planned project modification is requested to reduce the front setback along South State Street for the proposed retail building from the minimum requirement of 10 feet to approximately 0.5

feet. This reduced front setback places the building 55 feet from the South State Street right-of-way and approximately 85 feet from the east curb line of the road due to a wide right-of-way.

Sidewalk connections to both the hotel and retail building are proposed from the existing public sidewalk along S. State Street, with an additional internal connection off the proposed public sidewalk fronting Research Park Drive.

One hundred year storm detention will be provided underground on the northwest corner of the parking lot. This site provides infiltration and detention with porous soils and has been designed to the new Rules of the Wastenaw County Water Resource Commissioner.

Removal of eight landmark trees located near the northwest corner of the site are proposed, with twenty eight mitigation trees planted around the perimeter. Depressed bioretention islands are provided and exceed the minimum requirement (50% required; 80% provided).

The petitioner held a citizen participation meeting on October 16, 2014. No opposition was voiced for the proposed rezoning and site plan at this meeting. A meeting summary is attached. At the time this staff report was written, no comments have been received from the public.

# **COMPARISON CHART**

		EXISTING	PROPOSED	PERMITTED/REQUIRED
Zoning		RE (Research District)  C2B (Business Servi District)		C2B
Gross Lot Area		151,196 sq ft	151,196 sq ft	4,000 sq ft MIN
	mum Useable Floor Area ercentage of Lot Area	17,562 sq ft (11.6%)	99,318 sq ft (64%)	302,392 sq ft MAX (200%)
sks	Front (north & west)	55 ft –South State St 90 ft – Research Park Dr.	0.5 ft – South State St * 25 ft – Research Park Dr.	10 ft MIN 25 ft MAX
Setbacks	Side (east)	45 ft	78.9 ft	None
Ň	Rear (south)	307 ft	101.9 ft	None
Build	ling Height	55 ft (4 stories)	52.5 ft (4 stories)	55 ft (4 stories) MAX
Park	ing - Automobiles	120 spaces	168 spaces	164 spaces MIN
Park	ing – Bicycles	None	3 spaces - Class A 4 spaces - Class C	3 spaces MIN - Class A 4 spaces MIN - Class C

<sup>\*</sup> Planned project modifications requested.

# SURROUNDING LAND USES AND ZONING

	LAND USE	ZONING
NORTH	Office	O (Office District)
EAST	Research and Development	RE (Research District)
SOUTH	Retail Center (under construction)	C3 (Fringe Commercial District)
WEST	Bank & Restaurant	TWP (Township District)

# HISTORY

The existing building on the site was constructed in 1970. This lot was platted in the early 1960's as part of the Research Park Subdivision.

# PLANNING BACKGROUND

The <u>South State Street Corridor Plan</u> recommends office uses for this site to provide employment opportunities along this transit corridor. The plan indicates retail uses would be appropriate if the retail buildings were fronted along South State Street to provide direct non-motorized access. The uses should be consistent with those permitted in the retail zoning districts that do not allow drive-throughs by right. Vehicular access should be provided from Research Park Drive in order to limit the number of curb cuts along South State Street to improve safety.

The <u>Non-Motorized Plan</u> recommends bicycle lanes and sidewalks on both sides of the street for South State Street and Ellsworth.

The <u>Transportation Plan</u> Short-term Recommendations propose intersection improvements at State and Ellsworth intersection, which were recently implemented with the conversion of this intersection to a roundabout. The plan also recommends a traffic corridor study on Ellsworth from State Street to Platt Road, which currently is underway. The Mid-term Recommendations propose a traffic corridor study along South State Street between Eisenhower and Ellsworth Blvd.

## ZONING/REZONING JUSTIFICATION

Per Chapter 55 Section 5:107(1), the Zoning Ordinance and Zoning Map shall not be amended except "because of changed or changing conditions in a particular area or in the municipality generally, to rezone an area, extend the boundary of an existing Zoning District or to change the regulations and restrictions thereof."

The petitioner's <u>Petition For Changes In Or Additions To The Zoning Chapter</u>, a form provided by the Planning Department to assist petitioners in providing the required information per Chapter 55 Section 5:108(2)(a)-(g), is reprinted below. The questions are not standards for approval, rather guides to providing sufficient evidence of changed or changing conditions.

Petitioner responses are in plain text; staff comments are in italics.

• The extent to which the zoning/rezoning requested is necessary:

According to the <u>South State Street Corridor Plan</u> adopted by the City Planning Commission on May 21, 2013 and adopted by the City Council on July 15, 2013, the land use for the subject property is Mixed Use (Commercial/Office/Residential). The proposed mixed use development requires rezoning to C2B.

• This zoning/rezoning will affect the public welfare and property right of persons located in the vicinity in the following ways:

The proposed development will serve to revitalize an existing vacant property and provide uses to the surrounding area that are currently unavailable. Also, storm water management will be provided on the proposed site, which currently does not exist.

The proposed rezoning will enhance the public welfare by improving the site and making it more attractive, and adding additional business and residential activity and overall vitality to this area.

 This zoning/rezoning will be advantageous to the City of Ann Arbor in the following ways:

The rezoning is consistent with the Master Plan. The proposed project will provide diversity in the business within the Research Park area and along the South State Street Corridor. The existing property is vacant and this will provide for redevelopment of a deteriorated site.

The proposed rezoning will create more business activity, improve the appearance of the site, provide more retail sales options for residents and businesses.

 This particular location will meet the convenience and service requirements of potential users or occupants in the following ways:

Mixed use development of an extended stay hotel along with retail on the property provide a diversity of business within the area and will serve the need of the surrounding population. The proposed project will be a complimentary use with the ongoing improvements and expansion of businesses within the Research Park area.

 Any changed or changing conditions in any particular area, or in the municipality generally which may have bearing on the proposed zoning/rezoning are:

There is a demand for an extended stay hotel and supporting retail within the area.

Other circumstances which will further justify the requested zoning/rezoning are:

The rezoning is consistent with the Master Plan.

# PLANNED PROJECT STANDARDS

According to Section 5:70 of the Zoning Ordinance, the City Planning Commission may recommend approval, and City Council may approve modifications of the area, height and placement regulations of the Zoning Chapter in the form of a planned project site plan, based on the following standards (Petitioner's responses in regular type, staff comments in *italic type*).

(a) The lot or lots included in the planned project must meet the minimum gross lot size requirement of the zoning district in which they are located. In residential zoning districts, the minimum gross lot size shall be the combined total of the minimum gross lot sizes for each dwelling on a parcel. However, the minimum gross lot size and width requirements may be reduced as part of a planned project for a zero lot line duplex or townhouse development which provides affordable housing for lower income households. For purposes of this section, zero lot line duplex or townhouse development shall mean a development containing attached single-family units on individual lots. In no case may the gross lot size be reduced below the minimum lot area per dwelling unit requirement for the dwelling unit type proposed.

This lot exceeds the minimum lot size required for C2B zoning.

- (b) The proposed modifications of zoning requirements must provide one or more of the following:
  - 1. Usable open space in excess of the minimum requirement.
  - 2. Building or parking setback(s) in excess of the minimum requirement.
  - 3. Preservation of natural features.
  - 4. Preservation of historical or architectural features.
  - 5. Solar orientation or energy conservation design.
  - 6. An arrangement of buildings that provides a public benefit, such as transit access, pedestrian orientation, or a reduced need for infrastructure.
  - 7. Affordable housing for lower income households.

The reduction of the minimum front setback allows for increased useable space on the property. The increase in density of the property is achieved by allowing for a second story of the retail building. The orientation of the building front closer to South State Street allows for interconnectivity of the planned spaces with the pathway on the east side of the road. A new path along the frontage with Research Park Drive is proposed as part of the project.

The reduced setback results in improved pedestrian orientation because it reduces the distance between the retail building and nearby transit stops and public sidewalks.

(c) The planned project shall be designed in such a manner that traffic to and from the site will not be hazardous to adjacent properties.

The proposed ingress/egress for the property will be via Research Park Drive. No direct vehicular access to South State Street is proposed.

The traffic from this project should not be hazardous to the adjacent properties. The existing curb cut off Research Park Drive will continue to be used to access this site.

(d) The proposed modifications shall be consistent with the proper development and use of adjacent land and buildings.

The proposed use will serve to support surrounding properties and businesses by providing a mixed use development with the retail component. The proposed uses will be harmonious with adjacent land and buildings.

The project is consistent with the surrounding land uses and complies with the <u>South State</u> Street Corridor Plan recommendation.

(e) Required off-street parking and landscaping must be provided in accordance with the provisions of Chapters 59 and 62.

The minimum standards of off-street parking for both vehicles and bicycles are provided.

Parking and landscaping requirements are being met per City standards.

(f) The standards of density, allowable floor area and required usable open space for the zoning district(s) in which the project is located must be met.

The requirement is met.

The project is consistent with the proposed C2B.zoning district requirements.

(g) There shall be no uses within the proposed project which are not permitted uses in the zoning district(s) in which the proposed project is to be located.

The proposed uses are consistent with the Master Plan and are permitted uses in the C2B zoning district.

# **STAFF COMMENTS**

<u>Public Services - Engineering</u> - The sewer mitigation calculations require revision. All proposed building uses must be included in the sewer mitigation calculations.

City standard water main easement widths are forty feet, with the water main centered within, including around all sides of a fire hydrant. These requirements are not satisfied for all proposed water mains. Water main easements shall extend to and follow property lines to eliminate gaps to the property lines.

<u>Urban Forestry</u> – The site layout shows encroachment into the critical root zone of the landmark trees (#2417, 2418, 2419, 2420 and 2425). Encroachment into the critical root zone of the landmark trees is not permitted without City approval at the time of site plan approval. Staff does not support encroachment into the critical root zone of these trees. The current encroachment shown is less than 5 feet, which does not take into consideration the encroachment that will occur for the construction of the curb which will move the encroachment to less than 2 feet from the trunk. Please revise drawings to remove encroachment from the critical root zone of these trees.

A hedge, dense shrub planting, landform berm, wall or combination is required in the right-of-way screening of the vehicular use area. This screening is required along S. State Street and has not been shown on the landscape plan. If adherence to this standard will damage the landmark trees in this area, a Landscape Modification may be submitted.

<u>Traffic</u> – Additional trip generation information for the proposed retail use is needed to complete review of the traffic study.

<u>Planning</u> – The site plan recommendation is currently for postponement. If the petitioner addresses the outstanding staff comments prior to the April 7, 2015 City Planning Commission meeting, staff may change the recommendation to approval.

Staff supports this rezoning as this proposal meets the retail and office use recommendation as supported in the <u>South State Street Corridor Plan</u>. Approval of the planned project would allow for the retail building front setback to be reduced to 0.5 feett from the property line facing South State Street. Staff supports this reduction due to the wide public right-of-way between this building and South State Street in exchange for employment opportunities and pedestrian connections with this site and the surrounding

This site did not previously contain storm water detention. The <u>Malletts Creek Coordinating Committee</u> supports the proposed project as this proposal adopted their recommendations of complying with the WCWRC requirements with storm water infiltration and detention and provided depressed landscape islands for stormwater management.

Prepared by Christopher Cheng Reviewed by Wendy Rampson 4/2/15

Attachments: 10/17/14 Citizen Participation Meeting Summary

Zoning/Parcel Maps

Aerial Photo

Site/Landscape Plan

Elevations

c: Petitioner/Owner: Lodi Waters Parnership

5440 Corporate Drive, Suite 250

Troy, MI 48098

Petitioners Representative: Andy Andre, P.E.

Bud Design & Engineering Services, Inc.

10775 S. Saginaw St., Suite B

Grand Blanc, MI 48439

Systems Planning

File No. SP14-057 & Z14-028



# Bud Design & Engineering Services, Inc.

10775 S. Saginaw St. Suite B | Grand Blanc, MI 48439 | Ph: 810.695.0793 | Fax: 810.695.0569 | www.buddesign.com

October 17, 2014

RE: Stellar Hospitality Ann Arbor, LLC Staybridge Suites & Retail Citizen Participation Report

The Citizen Participation meeting was held at the Service Brands Office on October 16, 2014 beginning at 6:00pm. A total of fifty-eight (58) property owners were sent notices of the meeting via the United States Postal Service.

There were a four (4) attendees at the meeting. The development team opened the meeting at 6:15pm in order to allow additional attendees to arrive. A brief summary of the proposed site development was provided. The discussion was then opened to the citizens to ask questions and voice their comments and concerns about this project. Attached to this letter is a summary of the items that were discussed.

1. When will construction begin?

**ANSWER**: Probably 9 to 12 months to go through all of the rezoning and permitting.

2. When will the facility open?

**ANSWER**: If construction is begun in the spring, it may be completed in 10 to 12 months. If not, the ordinary standard is 12 to 14 months.

3. Other projects under construction?

<u>ANSWER</u>: Petitioner has one Staybridge facility under construction in Dearborn; one Holiday Inn Express under construction in Dearborn and one Holiday Inn Express–Farmington Hills–groundbreaking just a few weeks ago.

4. Banquet facilities available?

**ANSWER**: Not inside the hotel.

5. What is the average stay?

ANSWER: 11 days.



# Bud Design & Engineering Services, Inc.

10775 S. Saginaw St. Suite B | Grand Blanc, MI 48439 | Ph: 810.695.0793 | Fax: 810.695.0569 | www.buddesign.com

Sincerely,

BUD DESIGN & ENGINEERING SERVICES, INC.

Andrew Andre, PE President

Attachments: Notice of Citizen Participation Meeting

Signage Notification Sign-In Sheet Meeting Summary

# NOTICE OF CITIZEN PARTICIPATION MEETING: MIXED USE DEVELOPMENT - HOTEL & RETAIL

# **Citizen Participation Meeting**

Postcards are being sent to all property owners within 1,000 ft of the project site to give notice that a development petition will be submitted to the City of Ann Arbor on 10/27/14. A citizen participation meeting will be held to give you an opportunity to review plans, ask questions, and provide comments that will be considered by the developer to finalize plans and then incorporated into a report for the City Planning Commission.

# **Project Location**



### **Project Description**

A site plan is proposed that would include the development of a Staybridge Suites extended stay hotel along with separate building(s) for retail businesses at the location of 3850 Research Park Drive. The property is presently zoned RE (Research), but is master planned as Mixed Use in the South State Street Corridor Plan.

### **Meeting Logistics**

Date: Thursday, October 16, 2014

**Time**: 6:00pm

Place: Service Brands International

3948 Ranchero Drive Ann Arbor, MI 48108

# **Questions or Comments**

Questions or comments may be directed to Andy Andre, PE of Bud Design & Engineering Services, Inc. at andy@buddesign.com or during business hours at 810-695-0793.Persons with disabilities are encouraged to participate. Accommodations may be arranged by contacting Stellar Hospitality Ann Arbor, LLC at 248-419-5555. Requests need to be received at least 24 hours in advance of the meeting.

# Return Address

Stellar Hospitality Ann Arbor, LLC 32825 Northwestern Highway Farmington Hills, MI 48334

# Proposed Project for Site Plan Review

In accordance with the City of Ann Arbor's Citizen Participation Ordinance, you are being notified that a proposal for Mixed Use Development - Hotel & Retail will be submitted to the City of Ann Arbor's Planning Department. Details about a citizen participation meeting designed for you to learn about this project are described on the opposite side of this card. Visit <a href="https://www.a2gov.org/participation">www.a2gov.org/participation</a> for more information about citizen participation in Ann Arbor.







# Stellar Hospitality Ann Arbor, LLC 32825 Northwestern Highway, Farmington Hills, MI 48334 Attn: Jimmy Asmar / Jimmy@asmarcapital.com Citizen Particapation Meeting

Location: Service Brands International - 3948 Ranchero Drive, Ann Arbor, MI 48108 Thursday, October 16, 2014 - 6:00pm

Γ	: <del>1</del> :	91-14		2	12													Γ
Email Address	egalizanski Dtectest. con	Squetoro 45 ot 9 mgl.		RONG WENSON	12000000 3490 COP (CO		,	-	,									
Telephone Number	4576-072- hEZ	245-431-6786		1734-248-641-7000	7659-766 -KEC													
Address	3985 VARSITY DRIVE	+5 26 South 440 5+	- 1	120 Conelle 18th,	1875 PHUGHAND SCEL	1					""							
Name	ED GALCZYNSK		4	DOD When	Bull Wood								,		·	-		

# CITIZEN PARTICIPATION MEETING-STELLAR HOSPITALITY ANN ARBOR

Service Brands Office 3948 Ranchero Drive Ann Arbor, MI 48108

October 16, 2014 6:00 o'clock p.m.

The meeting started at 6:15 p.m., in order to allow any latecomers an opportunity to participate. The questions related from the participants:

1. When will construction begin?

**ANSWER**: Probably 9 to 12 months to go through all of the rezoning and permitting.

2. When will the facility open?

**ANSWER**: If construction is begun in the spring, it may be completed in 10 to 12 months. If not, the ordinary standard is 12 to 14 months.

3. Other projects under construction?


<u>ANSWER</u>: Petitioner has one Staybridge facility under construction in Dearborn; one Holiday Inn Express under construction in Dearborn and one Holiday Inn Express–Farmington Hills–groundbreaking just a few weeks ago.


4. Banquet facilities available?

**ANSWER**: Not inside the hotel.

5. What is the average stay?

**ANSWER**: 11 days.

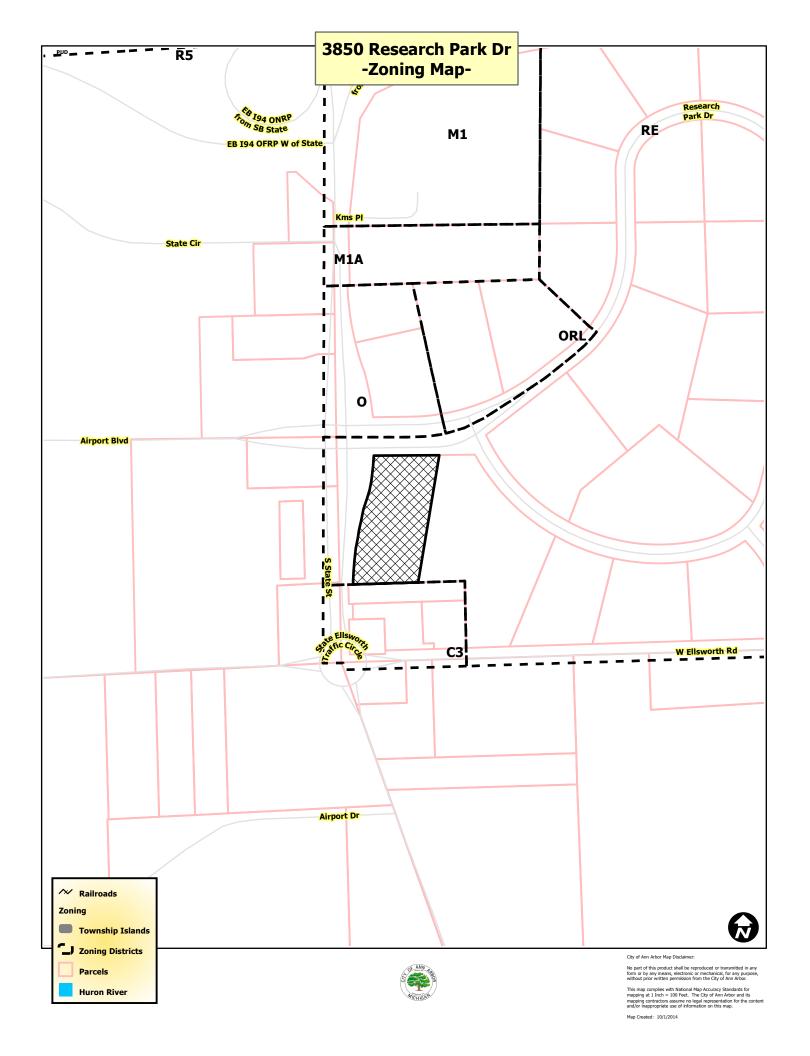

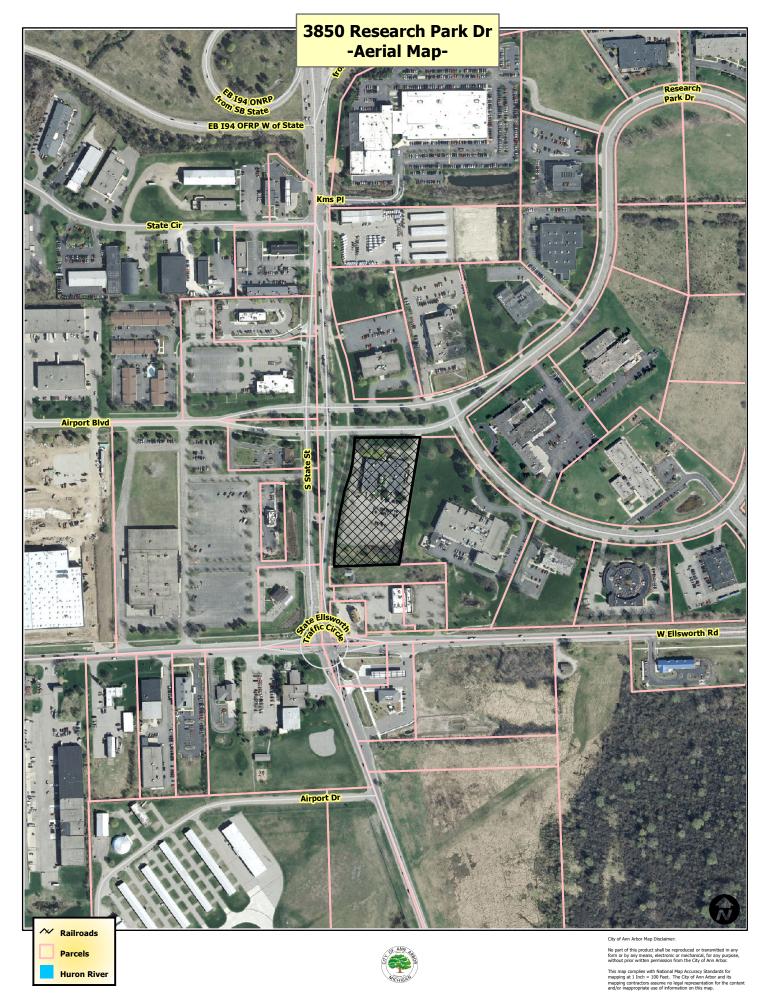

Map Created: 10/1/2014



and/or inappropriate use of Map Created: 10/1/2014

# CITY OF ANN ARBOR SIDEWALK REPAIR AND MAINTENANCE NOTE

SIDEWALK REPAIR AND MAINTENANCE NOTE: ALL SIDEWALKS ARE TO BE KEPT AND MAINTAINED IN GOOD REPAIR BY THE OWNER OF THE LAND ADJACENT TO AND ABUTTING THE SAME. PRIOR TO THE ISSUANCE OF THE FINAL CERTIFICATE OF OCCUPANCY FOR THIS SITE, ALL EXISTING SIDEWALKS IN NEED OF REPAIR MUST BE REPAIRED IN ACCORDANCE WITH CITY STANDARDS.

CONCRETE PAVEMENT



# Know what's below. Call before you dig. 80' SCALE: 1" = 40'

# RETAIL CENTER ENLARGED PLAN SCALE: 1" = 20'

25' FRONT SETBACK

NOTE: NO BUILDING FOOTINGS WITHIN ROAD R.O.W.

 $^-$ outdoor seating (typ)

LIGHTING (TYP)

DISPLAY

# **GENERAL NOTES**

CROSSWALK

-PROPERTY

-PROPERTY

-PROPERTY

LINE PROJECTION

PRÔPERTY

PAVEMENT

RETAIL TRASH BIN &

**RECYCLING ENCLOSURE** 

PAVEMENT

PROPERTY LINE

HOTEL TRASH BIN &

RECYCLING ENCLOSURE

CONC. WALK THROUGH DRIVE

-UTILITY

**PROPERTY** 

MIN. FRONT

SETBACK

WALK

1. IT IS THE CONTRACTOR'S RESPONSIBILITY TO SECURE ALL PERMITS AND POST ALL BONDS PRIOR TO CONSTRUCTION, OR ENSURE THAT ALL REQUIRED PERMITS AND BONDS HAVE BEEN OBTAINED PRIOR TO

PROPERTY LINE

-RETAIL BICYCLE PARKING

ON CONCRETE PAD

(4) CLASS B W/ (2) DOUBLE LOOP STANDS

2. THE CONTRACTOR SHALL BE FULLY RESPONSIBLE FOR THE LOCATION SHALL VERIFY ALL UTILITY LOCATIONS PRIOR TO CONSTRUCTION BY CALLING MISS-DIG AT 1-800-482-7171 AT LEAST 3 WORKING DAYS PRIOR TO EXCAVATION.

3. THE CONTRACTOR SHALL ASSUME RESPONSIBILITY FOR THE PROTECTION OF ALL EXISTING UTILITIES DURING CONSTRUCTION. ALL UTILITIES DAMAGED DURING CONSTRUCTION SHALL BE REPAIRED WITH LIKE MATERIAL. THE EXACT LOCATION OF EXISTING UTILITIES SHALL BE LOCATED BY HAND DIGGING.


4. DIMENSIONS ARE TO FACE OF CURB, OUTSIDE FACE OF BUILDING, EDGE OF PAVEMENT, CENTER OF STRUCTURE OR OTHERWISE INDICATED. 5. ALL PAVING MATERIALS AND OPERATIONS SHALL BE IN CONFORMANCE WITH THE CITY OF ANN ARBOR STANDARD SPECIFICATIONS FOR CONSTRUCTION.

6. PARKING STALL SPACES TO BE 4" SOLID WHITE PAINT STRIPES. HANDICAP PARKING TO BE 4" SOLID BLUE PAINT STRIPES W/ BARRIER FREE STRIPPING OF 4" SOLID BLUE @ 2' O.C. ON 45° ANGLE.

7. ALL WORK WITHIN THE RIGHT OF WAY OF SHALL BE CONDUCTED IN ACCORDANCE WITH THE REQUIREMENTS OF THE CITY OF ANN ARBOR.

8. SPECIAL RESTORATION METHODS IN ACCORDANCE WITH CITY CODE ARE REQUIRED FOR WORK ASSOCIATED IN RESEARCH PARK DRIVE.

9. IF A TEMPORARY EARTH RETENTION SYSTEM, INCLUDING TIE-BACKS, WILL BE REQUIRED WITHIN THE RIGHT-OF-WAY FOR BUILDING CONSTRUCTION PURPOSES, A TEMPORARY LICENSING AGREEMENT WILL BE NEEDED.

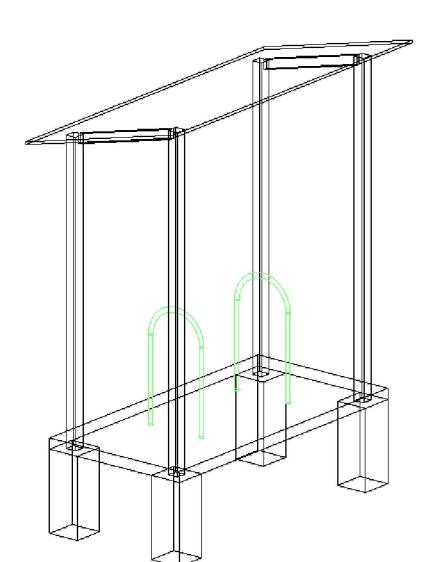

RETAIL CENTER CLASS B BICYLE PARKING

SCALE: 1" = NTS

**ENTRANCE DETAIL** 



# SITE PLAN COMPARISON CHART

MAII

BOXES . . . . . .

***************************************	EXISTING	REQUIRED	PROPOSED
***************************************	RE	C2B	C2B
GROSS LOT AREA	60,000 S.F.	4000 S.F.	155,349 S.F.
CITOGO EOT MILEM	00,000 0.1 .	4000 0.11 .	100,040 0.11.
BUILDING SIZE			90,198 S.F. HOTEL
***************************************			9,120 S.F. RETAIL
FAR		200%	64%
1711		20070	0470
NUMBER OF ROOMS			130 ROOMS HOTE
LOT AREA PER ROOM		900 S.F. / ROOM MIN.	1,186 S.F. / ROOM
SETBACKS:			
FRONT			RETAIL
***************************************	25' MIN.	10' MIN.	0.6' **
***************************************	50' MAX	25' MAX.	25.0'
***************************************		***************************************	HOTEL
***************************************	25' MIN.	10' MIN.	62.7'
	50' MAX	25' MAX.	66.0'
SIDE	NONE	NONE	78.9' HOTEL
OIDL	NONE	NONE	
REAR	NONE	NONE	101.9' HOTEL
BUILDING HEIGHT	55'	55'	RETAIL
	4-STORIES	4-STORIES	28'-6" AVG/35' MAX
			2-STORIES
***************************************		***************************************	HOTEL
***************************************		***	HOTEL 47'-6"AVG/52'-6"MA
			4-STORIES
VEHICULAR PARKING		1 / 310 S.F. MIN.	RETAIL
***************************************		1 / 310 S.F. MIN.	
		1 / 265 S.F. MAX	
		34	34
***************************************		***************************************	HOTEL
***************************************		1 / ROOM	HOTEL
		130	137
BARRIER FREE PARKING		FEDERAL ADA	DETAIL
***************************************		RETAIL - 34 SPACES 2 REQUIRED	RETAIL 2 PROVIDED
		ZILGOILED	ZTROVIDED
***************************************		HOTEL - 131 SPACES	HOTEL
***************************************		5 REQUIRED	10 PROVIDED
BICYCLE PARKING			RETAIL
-		1 / 3000 S.F.	
		3	4
***************************************		50% B 50% C	4
***************************************		50% C	
			HOTEL
		1 / 30 ROOMS	
-		4 100% A	3
		**Defer 40%**	ა

1) FRONT SETBACK TO 0.6-FEET IN ORDER TO BRING RETAIL BUILDING CLOSER TO STATE STREET. INCREASED RIGHT-OF-WAY ALONG STATE STREET AT RESEARCH PARK DRIVE PROVIDES FOR NATURAL SETBACK FROM THE ROADWAY.



(PH) 810.695.0793 (FAX) 810.695.0569

Web: www.buddesign.com

WHILE E THE RI COI PRECEDIN THE A OMISSIC DRAWING SERVICES I	
ISSUED FOR	DATE
SPA	12/29/14
SPA	02/20/15
SPA	02/20/15
SPA	03/23/15
DATE :	
DRAWN: ACA	
CHECKED: FTG	
SCALE: 1"-40'	
JOB NO: BD-14-322	
SHEET TITLE :	
SITE LAYOUT	AND


PAVING PLAN

SHEET

THE LOCATION OF ALL UNDERGROUND UTILITIES AS SHOWN ON THESE DRAWINGS ARE BASED ON RECORDS PROVIDED BY THE UTILITY OWNERS AND VISIBLE EVIDENCE OBTAINED IN THE FIELD. NO GUARANTEE IS EITHER EXPRESSED OR IMPLIED TO THE COMPLETENESS OR ACCURACY THEREOF.

# **PAVEMENT INFORMATION**

BITUMINOUS PAVEMENT

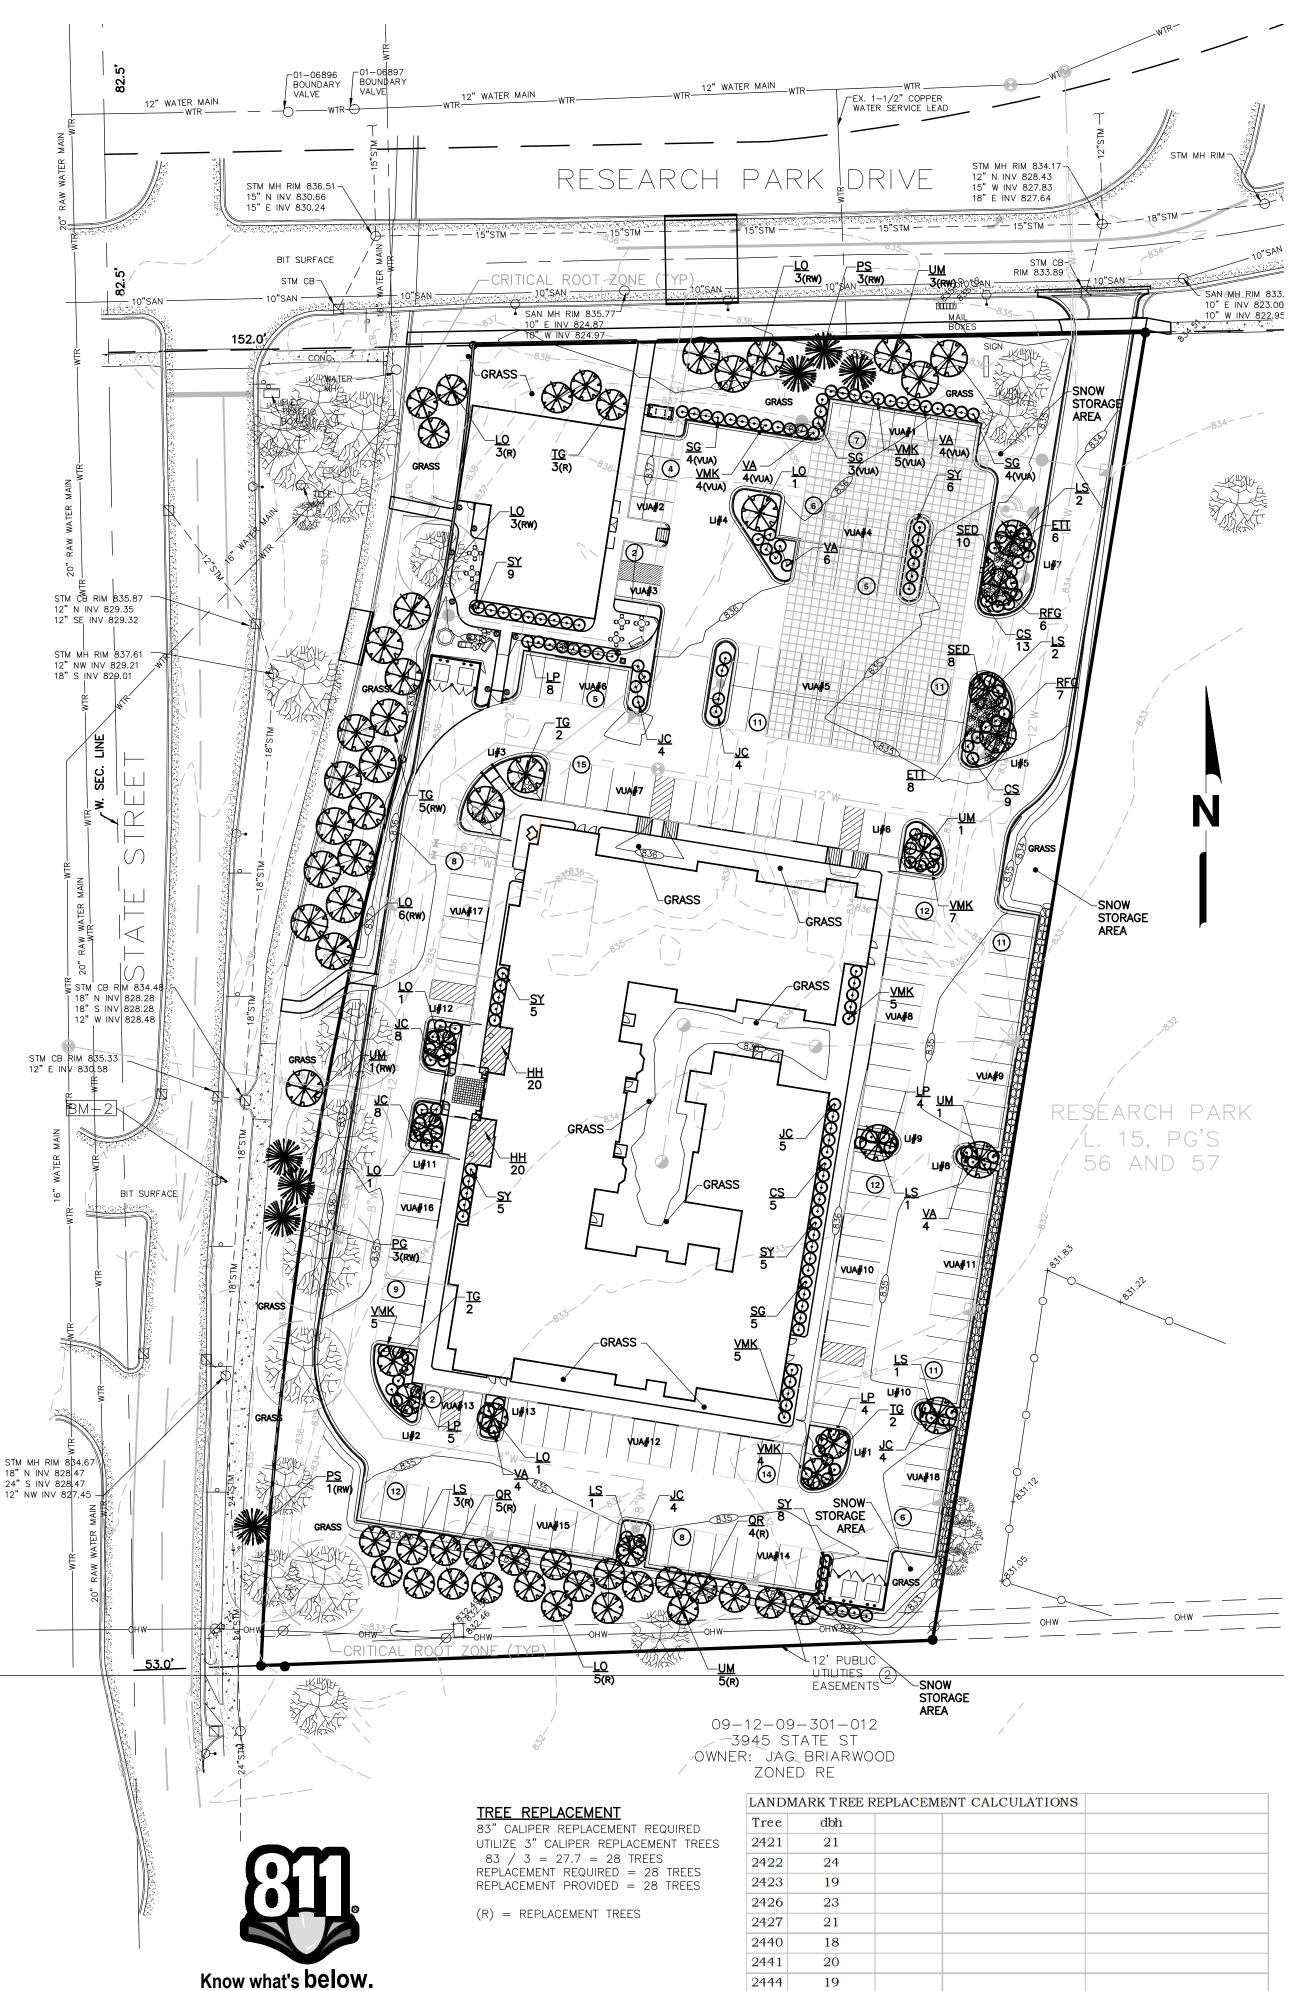

INCHES Caliper replacement required

ENCROACHMENT INTO THE CRITICAL ROOT ZONE OCCURS WITH LANDMARK TREES

2417, 2418, 2419, 2420 AND 2425. NO ENCROACHMENT ANY CLOSER TO

FURTHER PLANTINGS. EVALUATION OF ENCROACHMENT SHALL BE CONDUCTED

10-FEET FROM THE TRUNK WILL BE PERMITTED WITHOUT MITIGATION WITH

83 Required Caliper (inches) Replacement

50% Replacement Ratio (50% DBH)

DURING INITIAL CONSTRUCTION ACTIVITIES.


Call before you dig.


SCALE: 1" = 40'

THE LOCATION OF ALL UNDERGROUND UTILITIES AS SHOWN ON

UTILITY OWNERS AND VISIBLE EVIDENCE OBTAINED IN THE FIELD. NO GUARANTEE IS EITHER EXPRESSED OR IMPLIED TO THE COMPLETENESS OR ACCURACY THEREOF.

THESE DRAWINGS ARE BASED ON RECORDS PROVIDED BY THE

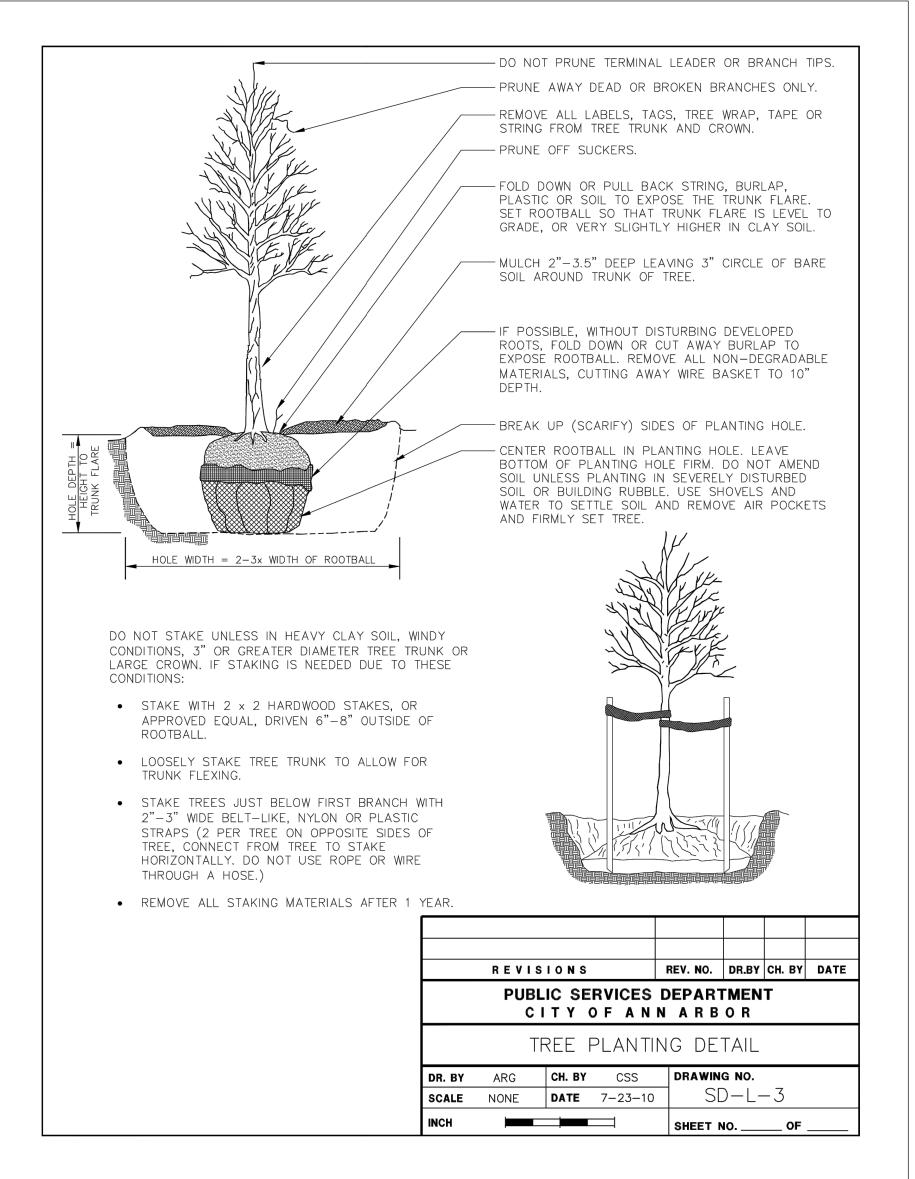

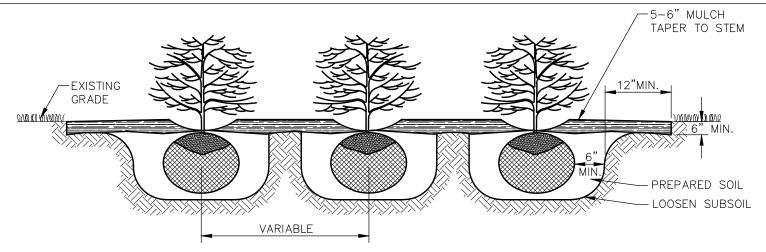

-FIRST AND SECOND WATERING AND CULTIVATION SHALL INCLUDE SHRUB BEDS. -CUT 6" X 12" (MIN.) EDGING AROUND THE PERIMETER OF ALL SHRUB BEDS SHOWN ON THE PLANS. SPRAY A NON-PERSISTANT GLYPHOSATE HERBICIDE TO ENTIRE SHRUB BEDS PRIOR TO PLANTING AND BARK PLACEMENT. -SHRUB BEDS ARE TO BE PAID FOR BY THE PAY ITEM 'SITE PREPARATION' -ALL PLANTS SHALL BE SET PLUMB AND HAVE THE BEST SIDE OF PLANT FACING

# SHRUB BED DETAIL

THE MAIN VIEWING DIRECTION.

SCALE: NONE

QUANITITY	KEY	BOTANICAL NAME	COMMON NAME	SIZE
40	НН	HEMEROCALLIS 'HAPPY RETURNS'	HAPPY RETURNS DAYLILLY	#1 POT
18	SED	SEDUM X. 'NEON'	NEON SEDUM	#1 POT
14	ETT	ECHINACEA 'TIKI TORCH'	TIKI TORCH ORANGE CONEFLOWER	#1 POT
13	RFG	RUDBECKIA FULGIDA S. 'GOLDSTRUM'	GOLDSTRUM ORANGE CONEFLOWER	#1 POT
27	CS	CORNUS SERICEA	RED TWIG DOGWOOD	24" HT B&B
38	SY	TAXUS S.M. 'SEBIAN'	SEBIAN YEW	24" HT B&B
21	LP	SPIRAEA JAPONICA 'LITTLE PRINCESS'	LITTLE PRINCESS SPIRAEA	24" HT B&B
16	SG	SPIREA JAPONICA 'GOLDFLAME'	GOLDFLAME SPIRAEA	24" HT B&B
35	VMK	VIBURNUM X.B. 'MOHAWK'	MOHAWK VIBURNUM	24" HT B&B
22	VA	VIBURNUM DENTATUM	ARROWWOOD VIBURNUM	24" HT B&B
37	JC	JUNIPERUS C. 'SEAGREEN'	SEA GREEN JUNIPER	24" HT B&B
4	PS	PINUS STROBUS	EASTERN WHITE PINE	8' HT.
3	PG	PICEA GLAUCA	WHITE SPRUCE	8' HT.
10	UM	ULMUS AMERICANA 'VALLEY FORGE'	VALLEY FORGE AMERICAN ELM	3" CAL B&B
24	LO	GLEDITSIA T. INERMIS 'SKYCOLE'	SKYLINE LOCUST	3" CAL B&B
14	TG	TILIA CORDATA 'GREENSPIRE'	GREENSPIRE LINDEN	3" CAL B&B
10	LS	LIQUIDAMBAR STYRACIFLUA	AMERICAN SWEETGUM	3" CAL B&B
9	QR	QUERCUS RUBRA	RED OAK	3" CAL B&B

VEHICULAR USE AREAS					
VUA#	S.F.				
1	1134				
2	648				
3	432				
4	1782				
5	3563.41				
6	816.1				
7	2717.70				
8	1948.09				
9	1781.8				
10	2087.54				
11	1943.78				
12	2267.53				
13	467.95				
14	1619.64				
15	1952.57				
16	1466.67				
17	1421.68				
18	971.91				
	29022.37				
m					
Total: =	29,022.37				
Use Ratio =	20				
Req. S.F. =	1452				
DEPRESSED E	BIORETENTION				
Req. % =	50%				
Area =	1452				
Req Area = 726					
UTILIZE ISLA	NDS				
5	586				
7	567				

STRE	ET TREE	ESCROW CALCULATION	
SOU	TH STAT	E STREET	
	558 LF ROADWAY		
	12	# EX. TREES	
	45	LF DEDUCT / TREE	
	540	DEDUCT	
	18	LF	
\$	1.30	RATE	
\$	23.40	ESCROW	
RESE	ARCH PA	ARK DRIVE	
	280	LF ROADWAY	
	2	# EX. TREES	
	45	LF DEDUCT / TREE	
	90	DEDUCT	

1153

Total Prov. =

# SOUTH STATE STREET RIGHT-OF-WAY LANDSCAPING 1 TREE / 30 L.F. OF FRONTAGE

190 LF 1.30 RATE

558 L.F. / 30 = 18.6 = 19 TREES R.O.W. LANDSCAPING REQUIRED = 19 TREES

R.O.W. LANDSCAPING PROVIDED = 19 TREES

(RW) = RIGHT-OF-WAY TREES

# RESEARCH PARK DRIVE RIGHT-OF-WAY LANDSCAPING

1 TREE / 30 L.F. OF FRONTAGE 280 L.F. / 30 = 9.3 = 9 TREES R.O.W. LANDSCAPING REQUIRED = 9 TREES R.O.W. LANDSCAPING PROVIDED = 9 TREES

(RW) = RIGHT-OF-WAY TREES

# VEHICULAR USE AREA LANDSCAPING 1 SHRUB / 4 L.F. OF V.U.A. FRONTAGE

64 L.F. / 4 = 16 SHRUBS V.U.A. LANDSCAPING REQUIRED = 16 SHRUBS V.U.A. LANDSCAPING PROVIDED = 16 SHRUBS

(VUA) = VEHICULAR USE AREA RIGHT-OF-WAY PLANTINGS

# **GENERAL NOTES**

TOPSOIL AVAILABLE ON-SITE.

- 1. CONTRACTOR TO PROVIDE DESIGN AND INSTALLATION OF UNDERGROUND IRRIGATION SYSTEM IN ACCORDANCE WITH PROJECT SPECIFICATIONS AND REGULATORY AGENCY REQUIREMENTS. ALL LANDSCAPING AND GRASS AREAS TO BE IRRIGATED. IRRIGATION CONTROL PANEL SHALL BE LOCATED WITHIN THE HVAC ENCLOSURE.
- 2. ALL GREEN SPACES AND PLANTING AREAS SHALL BE IRRIGATED.
- 3. IT IS THE CONTRACTOR'S RESPONSIBILITY TO SECURE ALL PERMITS AND 1. COMPACTED SOILS SHALL BE SCARIFIED TO A DEPTH OF 6" TO ELIMINATE POST ALL BONDS PRIOR TO CONSTRUCTION.
- 4. REFER TO PLUMBING PLANS FOR LOCATION OF IRRIGATION METER.
- 5. ALL GRASS AREAS TO BE SODDED.
- 6. SPACE ALL SHRUBS AT 5-FEET ON CENTER UNLESS OTHERWISE INDICATED ON THE PLANS
- CONDITION IN ACCORDANCE WITH PROJECT SPECIFICATIONS. 8. THE GENERAL CONTRACTOR SHALL INCLUDE TOPSOIL IN BASE BID. NO

GUARANTEE IS EITHER EXPRESSED OR IMPLIED AS TO THE AMOUNT OF

DES	CRIPT	0
THIS	WORK	S
FQUIF	PMFNT.	Т

SHALL CONSIST OF PROVIDING ALL NECESSARY MATERIALS, LABOR, TOOLS AND SUPERVISION REQUIRED FOR THE EXECUTION AND GUARANTEE OF ALL PLANTINGS AND RELATED WORK AS SHOWN ON THE

PLANT MATERIALS SHALL CONFORM TO THE SIZES STATED ON THE PLANT LIST AND SHALL BE OF A MINIMUM SIZE OR LARGER. ALL MEASUREMENTS OF SPREAD, CALIPER, BALL SIZE, TRUNK CROWN RATIO, QUALITY DESIGNATIONS ETC., SHALL BE IN ACCORDANCE WITH THE LATEST EDITION OF THE "ANSI STANDARDS FOR NURSERY STOCK". PLANT MATERIAL SHALL BE NURSERY GROWN AND INSPECTED BY THE OWNER'S REPRESENTATIVE AT THE SITE PRIOR TO PLANTING. THE OWNER'S REPRESENTATIVE RESERVES THE RIGHT TO REJECT ANY PLANT MATERIAL AT ANY TIME.

Bud Design &

Engineering Services, Inc.

Architecture | Engineering | Interior Design

10775 S. Saginaw St. Suite B

Grand Blanc, MI 48439

(PH) 810.695.0793

(FAX) 810.695.0569

Web: www.buddesign.com

NURSERY STOCK SHALL BE PREPARED FOR SHIPMENT IN ACCORDANCE WITH THE REQUIREMENTS OF THE CURRENT ANSI SPECIFICATION Z60.1 AND SHALL BE ENCLOSED OR COVERED DURING TRANSPORTATION TO PREVENT

THE CONTRACTOR SHALL VERIFY ALL EXISTING AND PROPOSED UTILITY LOCATIONS PRIOR TO CONSTRUCTION AND PROTECT AND REPAIR UTILITIES ENCOUNTERED DURING CONSTRUCTION WHETHER SHOWN ON THE PLANS OR

INDIVIDUAL HOLES SHALL BE CENTERED AT STAKED PLANT LOCATIONS. CONTRACTOR IS TO STAKE PRIOR TO PLACEMENT OF PLANT MATERIAL AND OBTAIN APPROVAL FROM THE OWNER'S REPRESENTATIVE. PLANTING HOLES SHALL BE DUG LARGE ENOUGH TO PERMIT PLACING PREPARED TOPSOIL 18" LATERALLY BEYOND THE ENDS OF THE ROOT BALLS FOR SHADE AND EVERGREEN TREES AND 6" LATERALLY FOR SHRUBS UNLESS OTHERWISE

EXCAVATED MATERIAL SHALL BE REMOVED FROM THE SITE AT THE TIME THE HOLE IS DUG. THE PLANTING HOLE SHALL BE BACKFILLED WITH PREPARED TOPSOIL THE SAME DAY THEY ARE DUG.

TOPSOIL SHALL AT FERTILE, FRIABLE NATURAL TOPSOIL OF CLAY LOAM CHARACTER CONTAINING AT LEAST 5% BUT NOT MORE THAN 20% BY WEIGHT OF ORGANIC MATTER WITH A PH RANGE FROM 6.0 TO 7.0. TOPSOIL SHALL BE FREE OF CLAY LUMPS, COURSE SAND, STONES, PLANT ROOTS, STICKS OR OTHER FOREIGN MATTER.

# CARE FOR PLANTS BEFORE PLANTING

PLANTS DESIGNATED "BB" SHALL BE BALLED AND BURLAPPED WITH FIRM NATURAL BALLS OF EARTH. CRACKED, LOOSENED OR BROKEN BALLS SHALL NOT BE PLANTED. THEY SHALL BE MARKED WITH SPRAY PAINT AND IMMEDIATELY REMOVED FROM THE JOB SITE. IMMEDIATELY FOLLOWING DELIVERY AT THE JOB SITE, ALL PLANTS THAT WILL NOT BE PLANTED THAT SAME DAY SHALL BE "HEELED IN" WITH SHREDDED BARK OR MOIST SOIL AND KEPT MOIST

THE TRUNKS AND BRANCHES OF ALL TREES SHALL BE PROTECTED FROM INJURY OF ANY KIND DURING ALL OPERATIONS. THE OWNER'S REPRESENTATIVE SHALL REJECT ANY TREES THAT ARE INJURED.

THE CONTRACTOR IS RESPONSIBLE FOR PLANTING MATERIALS PLUMB. SET THE TOP OF THE ROOT BALL AT OR SLIGHTLY HIGHER THAN THE SURROUNDING GRADE. PLANTS SHALL BE FACED TO GIVE THE BEST APPEARANCE OR RELATIONSHIP TO ADJACENT STRUCTURES. NO FILLING WILL BE PERMITTED AROUND TRUNK OR STEMS. WHEN THE PLANT HAS BEEN PROPERLY SET, THE HOLE SHALL BE BACKFILLED TO 1/2 THE DEPTH OF THE BALL WITH PREPARED TOPSOIL MIXTURE, FIRMLY PACKED AND WATERED-IN AT TIME OF PLANTING. LOOSED AND REMOVE BURLAP AND LACING FROM UPPER 1/3 OF THE ROOT BALL. BACKFILL WITH PREPARED TOPSOIL, WHICH AFTER COMPACTION IS FLUSH WITH THE SURROUNDING GROUND.

# <u>MULCHING</u>

ALL PLANT MATERIAL SHALL BE ENCIRCLED WITH A COVERING OF NON-DYED SHREDDED BARK MULCH TO 6" OUTSIDE THE PLANTING HOLE. MULCH SHALL NOT BE TOUCHING THE TRUNK OF ANY TREE. SUBMIT SAMPLE TO THE OWNER'S REPRESENTATIVE FOR APPROVAL BEFORE PLACEMENT. WOOD CHIPS SHALL NOT BE ALLOWED ON THIS JOB. MULCHING SHALL FOLLOW THE CITY OF ANN ARBOR PLANTING DETAILS.

STEEL LANDSCAPE EDGING SHALL BE USED ON THIS PROJECT. ALUMINUM OR PLASTIC EDGING WILL NOT BE ALLOWED.


# UPON COMPLETION, ONLY PRUNE DEAD OR BROKEN BRANCHES FROM TREES.

THE AMOUNT OF PRUNING SHALL BE LIMITED TO THE MINIMUM NECESSARY TO REMOVE DEAD OR INJURED BRANCHES. PRUNING PAINT SHALL NOT BE USED.

FINISHING AND CLEANING UP IMMEDIATELY UPON COMPLETION OF THE WORK, THE CONTRACTOR SHALL CLEAN UP THE AREA OF SURPLUS MATERIALS. THE CONTRACTOR SHALL REPAIR AND RE-ESTABLISH TURF IN RUTTED AREAS.

# <u>WARRANTY</u>

THE LANDSCAPE INSTALLATION CONTRACTOR SHALL REPLACE ALL UNHEALTHY VEGETATION AND PLANTINGS WITHIN ONE (1) YEAR OF INITIAL PLANTING OR SUBSEQUENT PLANTING PERIOD.

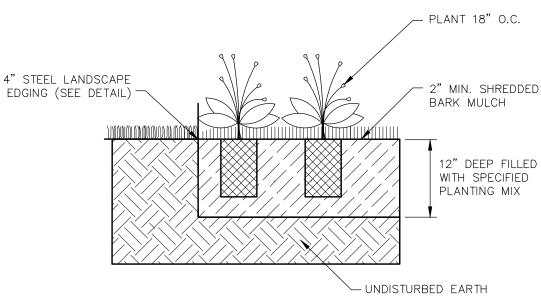


# PERENNIAL PLANTING BED

# CITY OF ANN ARBOR LANDSCAPE NOTES

LANDSCAPE CONTRACTOR SHALL REFER TO CITY OF ANN ARBOR LANDSCAPE AND SCREENING ORDINANCE (CHAPTER 62)

ANY SOIL COMPACTION CREATED DURING CONSTRUCTION.

- 2. ALL DISEASED, DAMAGED, OR DEAD MATERIAL SHALL BE REPLACED IN ACCORDANCE WITH CHAPTER 62 BY THE END OF THE FOLLOWING PLANTING
- 3. SNOW STORAGE AREAS ARE INDICATED ON THE PLAN. SNOW SHALL NOT BE PUSHED ON TO THE INTERIOR LANDSCAPE ISLANDS.
- 7. ALL DISTURBED LAWN AREAS SHALL BE RESTORED TO AT LEAST PREVIOUS 4. THE CITY OF ANN ARBOR HAS ADOPTED AN ORDINANCE LIMITING PHOSPHORUS IN FERTILIZER. TO ASSIST IN COMPLIANCE WITH THE STATE MANDATED TMDL FOR PHOSPHORUS WITHIN THE MIDDLE HURON RIVER BASIN. APPLICATIONS OF FERTILIZER BEYOND THE INITIAL TOPSOIL AND SEEDING SHALL BE A FERTILIZER WITH NO PHOSPHORUS

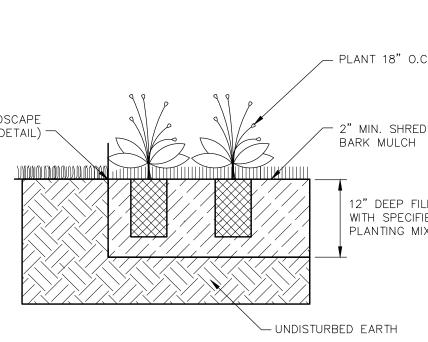

SCALE: 1"=40' JOB NO: BD-14-322 SHEET TITLE:

DRAWN: ACA

CHECKED: FTG

ISSUED FOR


2/29/14

02/20/15

03/23/15

ANDSCAPE PLAN AND DETAILS

SHEET

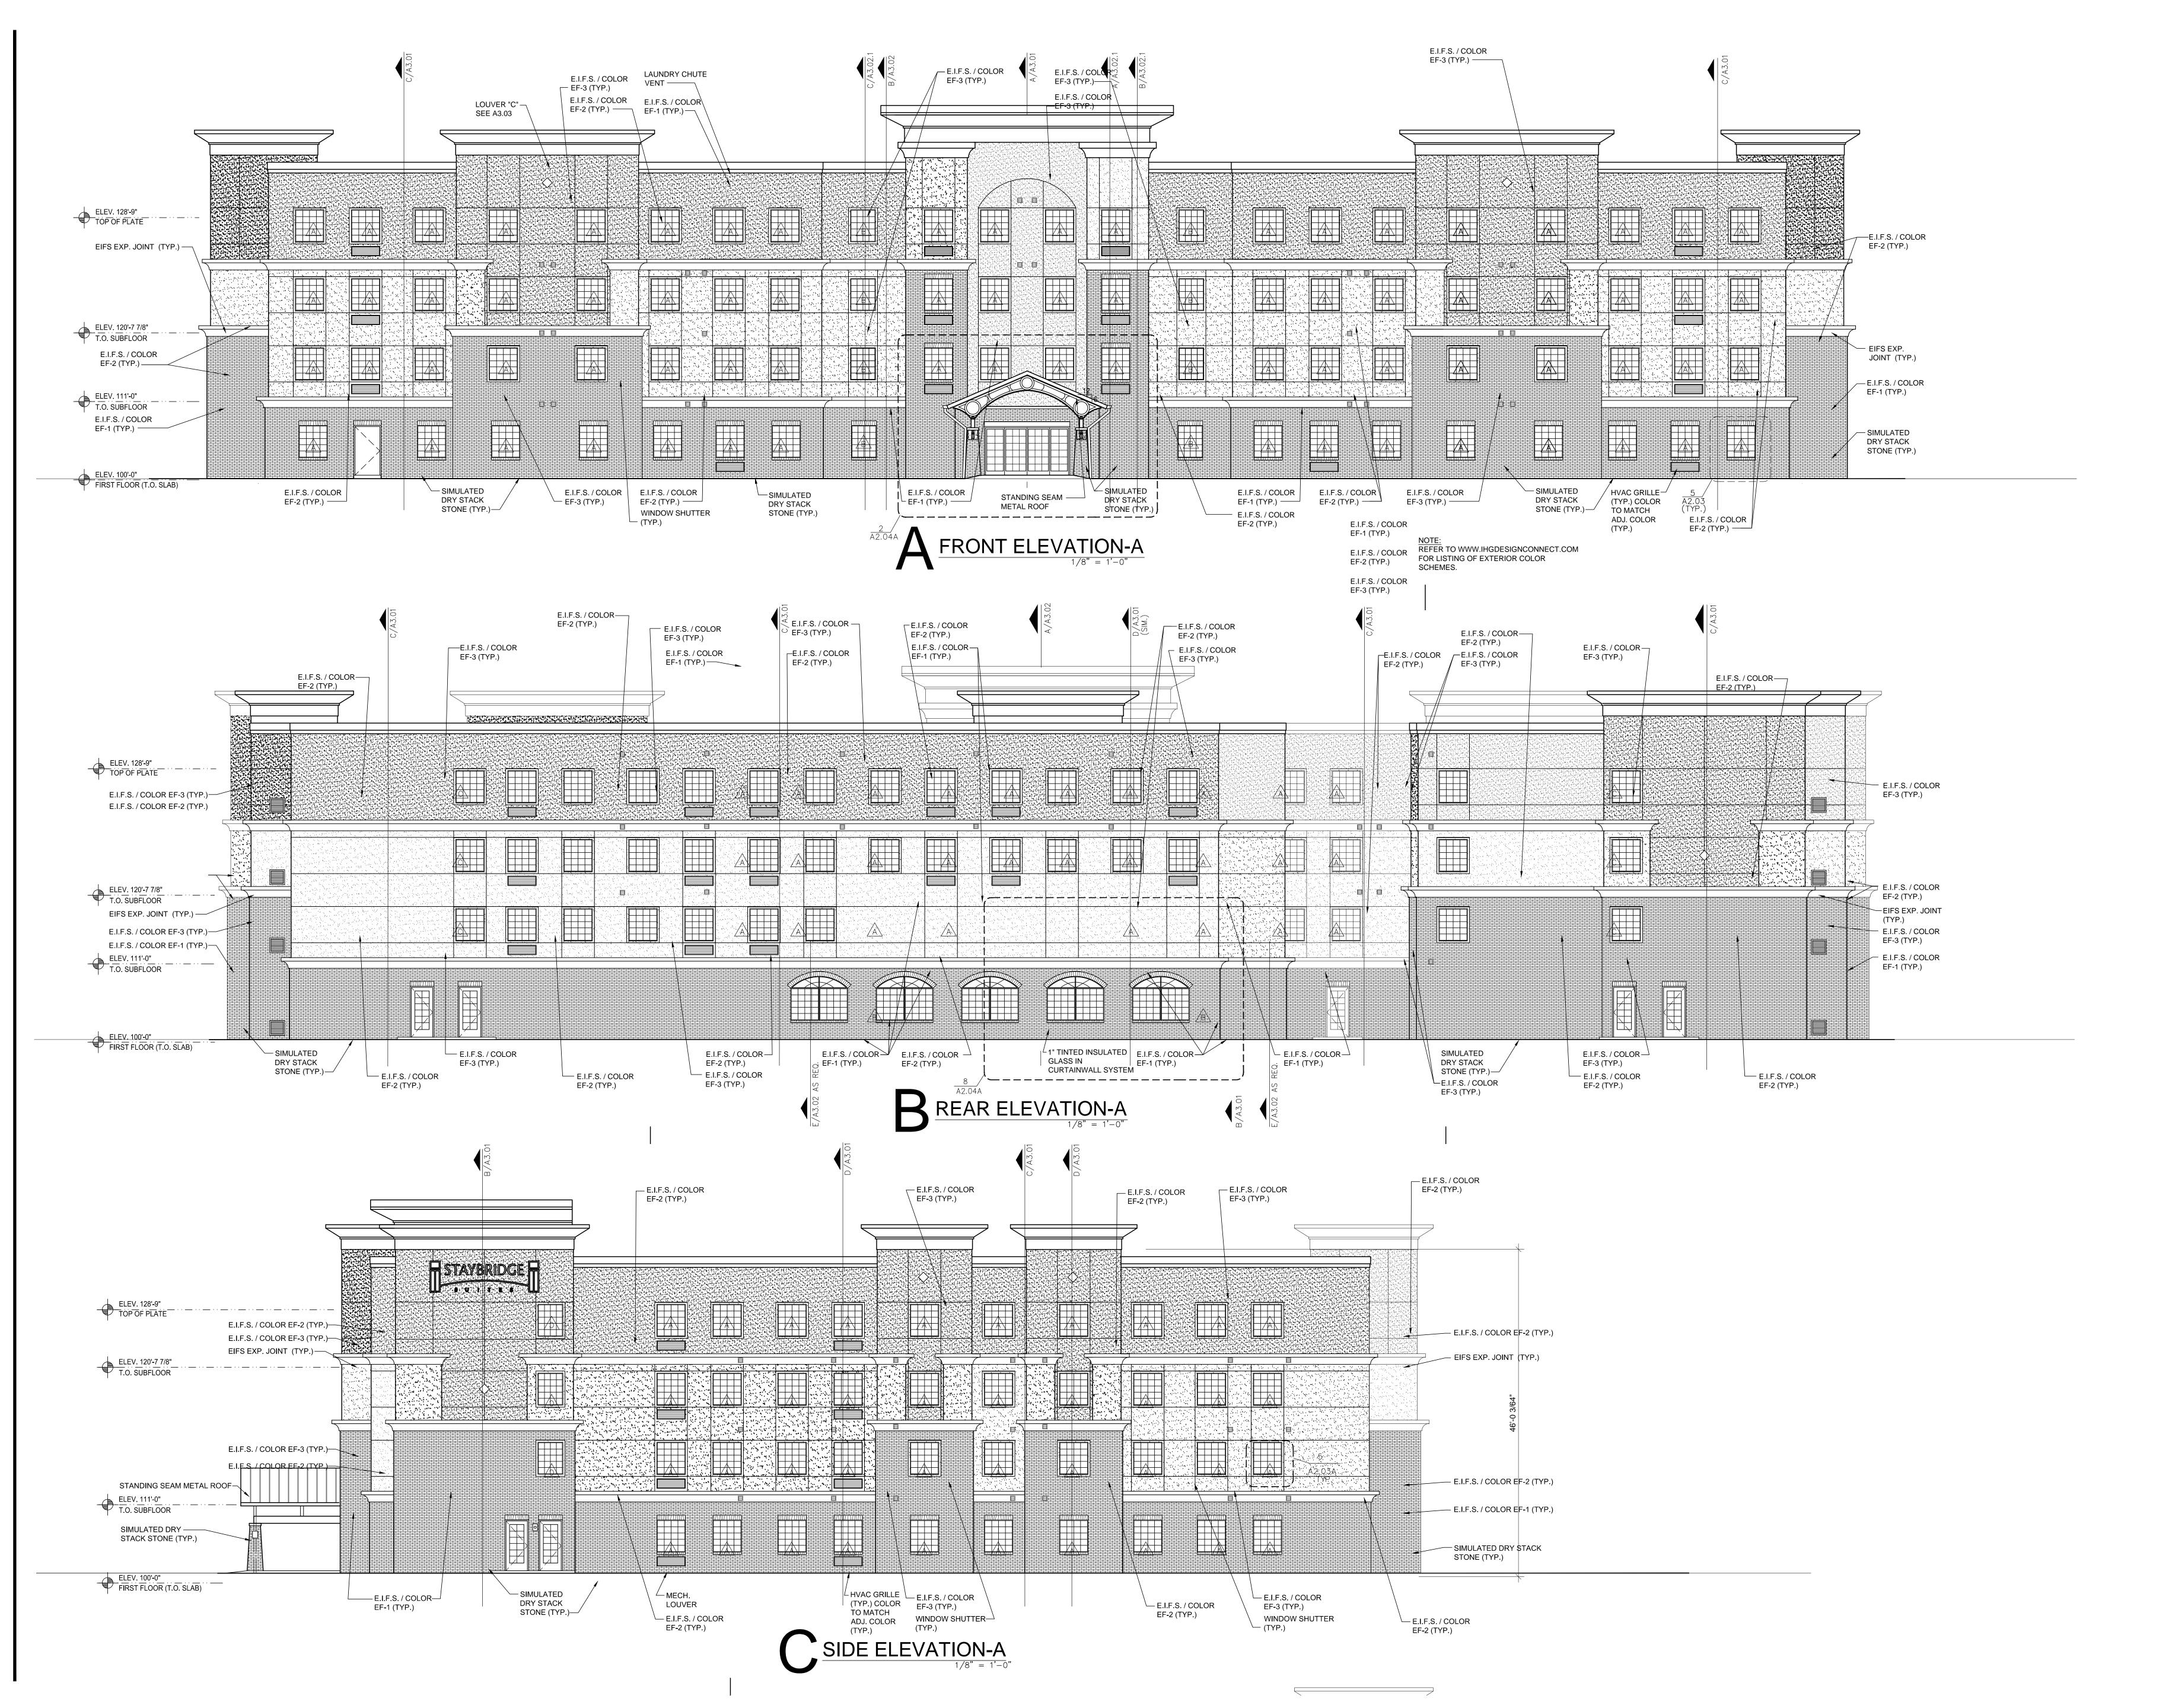



Bud Design & Engineering Services, Inc. Architecture | Engineering | Interior Design

10775 S. Saginaw St. Suite B Grand Blanc, MI 48439 (PH) 810.695.0793 (FAX) 810.695.0569

Web: www.buddesign.com

VERIF CONL CONSTRUC	ACTOR SHALL FIELD FY EXISTING FIELD DITIONS PRIOR TO CTION AND REPORT ALI
ARCH	HITECT/ENGINEER.
NOT FOR CONSTRUCTION	PLANS ARE FOR REVIEW ONLY AND DO NOT CONSTITUTE FINAL DESIGN. ANY BIDDING OR PRICING FROM THE OCUMENTS MAY REQUIRE ADJUSTMENT FITER RELEASE OF THE FINAL APPROVED CONSTRUCTION SET. BDE IS NOT RESPONSIBLE FOR PRICE ADJUSTMENTS THAT MAY BE REQUIRED.

9 Z OG P	A B
WHE BERY ATTIANT HAS BENIMARE TO PROJUCE BRACK HEE DOOLANIS, IT IS THE RESPONSALITY OF THE BLUER AND/OR THE CLEMT TO WERY ALL DISTING CONTINGS, DIMENSING, ETCH SCOTE COMPILANCE, AND SECTIONION FRECING COMMENTED AND SECTIONION FROM TO ACCORDINGE, OF HEEE DOOLANIS, THE ARCHIECT THACKS HILL RESPONSALITY OR CHARGE MOURS MANCHED HAVE EITH ACCOUNTING HER REPORTED FOR THESE DOOLANIS HAVE EITH ACCOUNTING HER ORDERS WOUR DRAWINGS OF THE ROSTAN AND ORBANISM OF THE MOUR STANKES IN ANY OTHER HAVES WITHOUT HE CORRENT OF BOLD ESSAN AND BRAEFING STANKES IN, AND GARY M. PALICEANCH	© 2010 COPYRIGHT BUD DESIGN AND ENGNEERING SVC, INC. ALL RIGHTS RESERVED

ISSUED FOR	DATE
PROGRESS	11.19.14
PROGRESS	01.12.15
	-
<b>BATE</b> 40.04.44	
DATE : 12.24.14	
DRAWN : AM	
CHECKED I JSP	
SCALE 1/8" =1'-0"	
JOB NO .BD14-32	2

SHEET TITLE : EXTERIOR ELEVATIONS SHEET A2.01-A



Bud Design &
Engineering Services, Inc.
Architecture | Engineering | Interior Design

10775 S. Saginaw St. Suite B
Grand Blanc, MI 48439

(PH) 810.695.0793
(FAX) 810.695.0569

Web: www.buddesign.com

STAYBRIDGE SUITES & RETAIL
3850 RESEARCH PARK DRIVE
ANN ARBOR, MI 48108

CONTRACTOR SHALL FIELD
VERIFY EXISTING FIELD
CONDITIONS PRIOR TO
CONSTRUCTION AND REPORT ALL
FINDINGS TO
ARCHITECT/ENGINEER.

NOT FOR

CONSTRUCTION

PLANS ARE FOR REVIEW ONLY AND DO

NOT CONSTITUTE FINAL DESIGN. ANY
BIDDING OR PRICING FROM THE
FITER RELEASE OF THE FINAL APPROVED

CONSTRUCTION SET. BDE IS NOT

RESPONSIBLE FOR PRICE ADJUSTMENTS

THAT MAY BE REQUIRED.

THE FIRM ATION THE SERN WATER TO PRODUCE FROM THE COULDINGS IT IS THE PROSENTY OF THE BLUTS AND VIOLE FROM THE CONTING SERVICE OF THE TOTAL STATE OF THE COUNTING SERVICE OF THE SERVICE OF THE COUNTING SERVICE OF THE TOTAL SERVICE OF THE SERVICE O

ISSUED FOR	DATE
PROGRESS	11.19.14
PROGRESS	01.12.15

DATE : 12.24.14

DRAWN : AM

CHECKED : JSP

SCALE : 1/8" = 1'-0"

SCALE 1 1/8" = 1'-0"


JOB NO 1BD14-322

SHEET TITLE 1

EXTERIOR ELEVATIONS

sheet A2.02-A



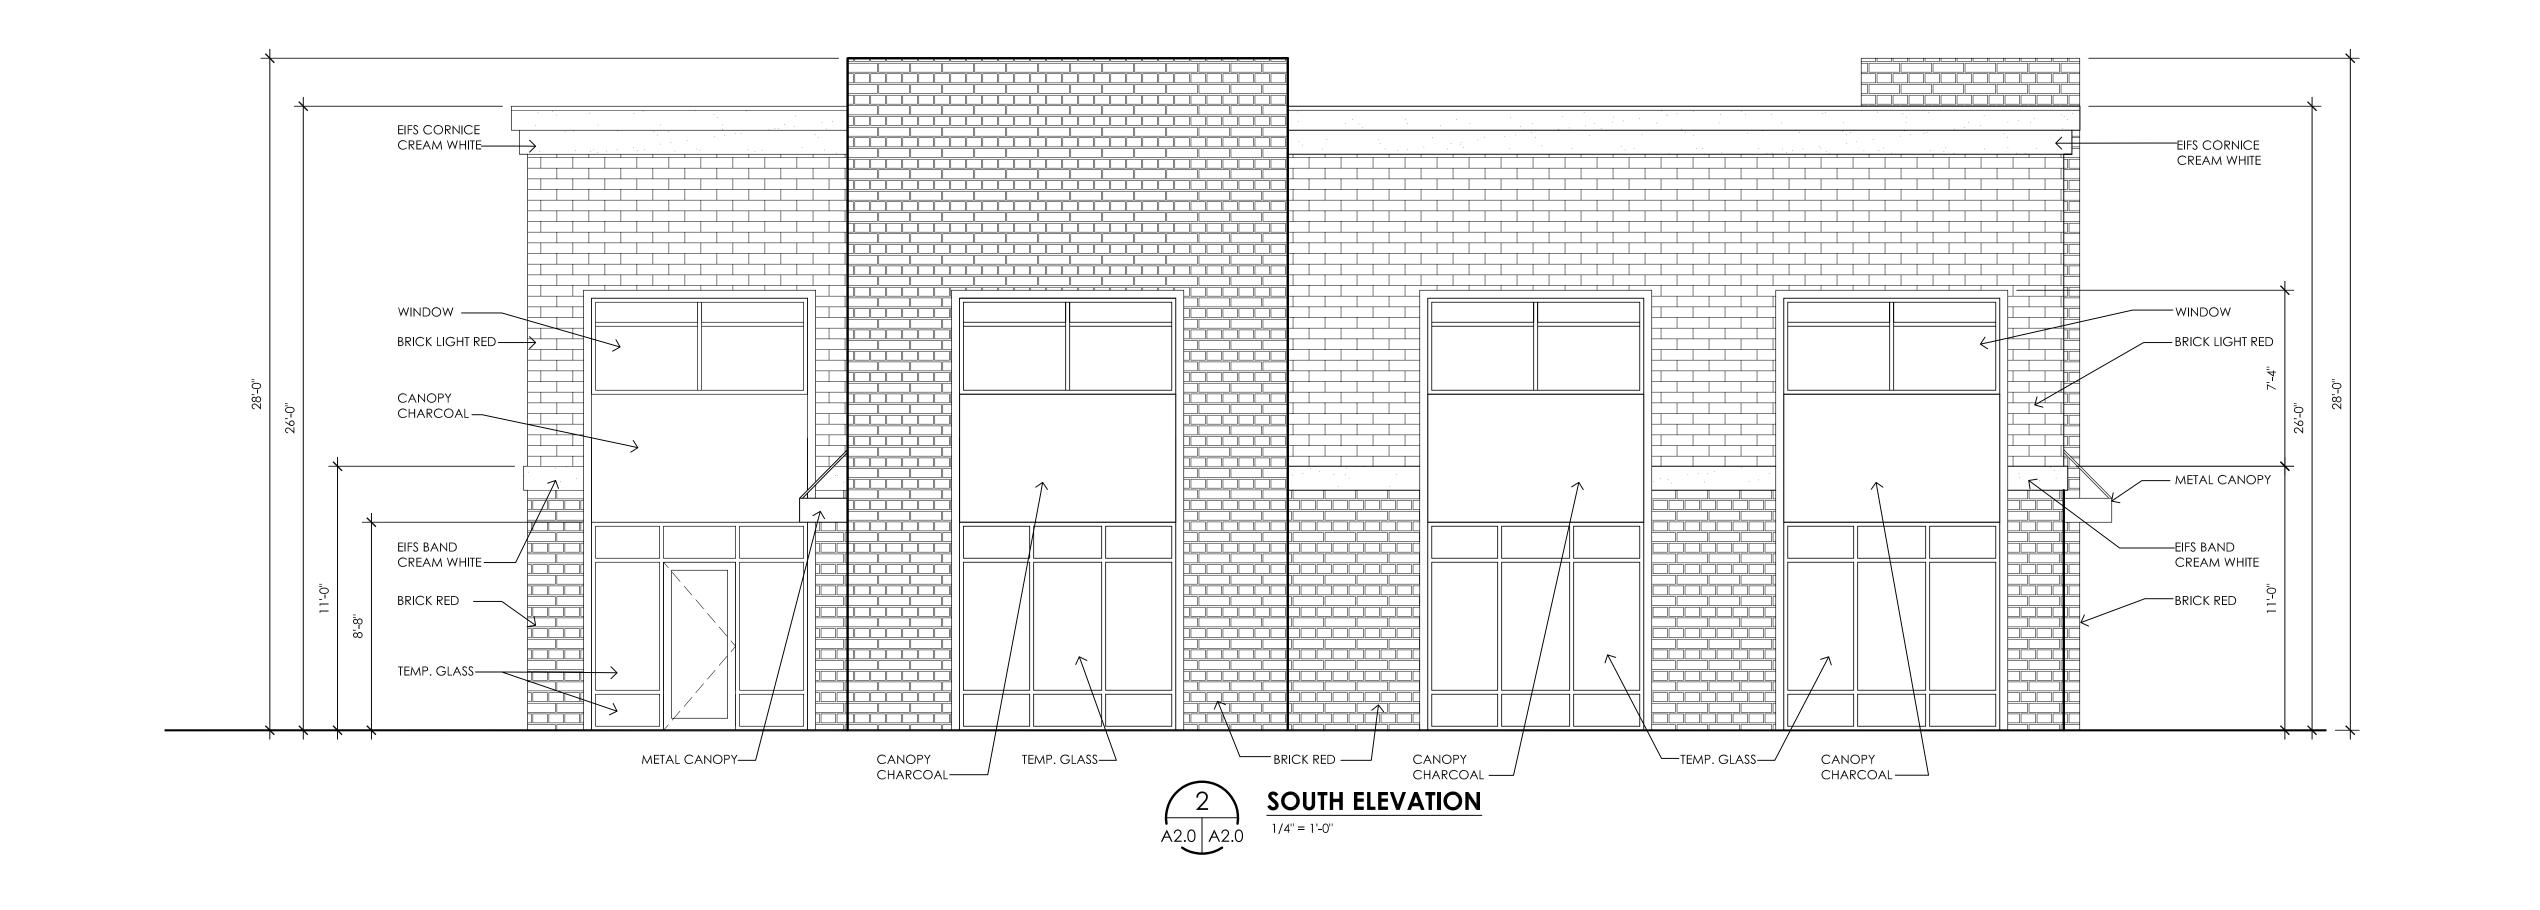



10775 S. Saginaw St. Suite B Grand Blanc, MI 48439 (PH) 810.695.0793 (FAX) 810.695.0569 Web: www.buddesign.com

노 니 그 기

AYBRIDGE RETAIL (3850 RESEARCH PARK DRIVE


TABLES ON THE STATE OF ACCEPTANCE OF THESE DOCUMENTS, STATE OF THESE DOCUMENTS, STATE OF THESE DOCUMENTS, STATE OF THESE DOCUMENTS, STATE OF THESE OF THE STATE OF THESE OF THE STATE OF THESE OF THE DESCAN AND CRICIARM, AND THE OFFICIARY OF ADD DESCAN AND CRICARM, AND THE OFFICIARY OF PARTIES MAY USE THIS DESCAN AND DESCAN CRICARY OF PARTIES MAY USE THIS DESCAN AND CHERP PERSONS INC., AND CARY M. RAUDEBAUGH
EERING SERVICES INC., AND CARY M. RAUDEBAUGH
EERING SEVENCES INC., AND CARY M. RAUDEBAUGH
EERING SEVENCES INC., AND RESERVED


SECAL

ISSUED FOR	DATE
PROGRESS	11.19.14
DATE : 11-18-14	
DRAWN : AM	
CHECKED : JSP	
SCALE : 1/4" =	
JOB NO :BD-14-322-#2	

SHEET TITLE : EXTERIOR ELEVATIONS

SHEET

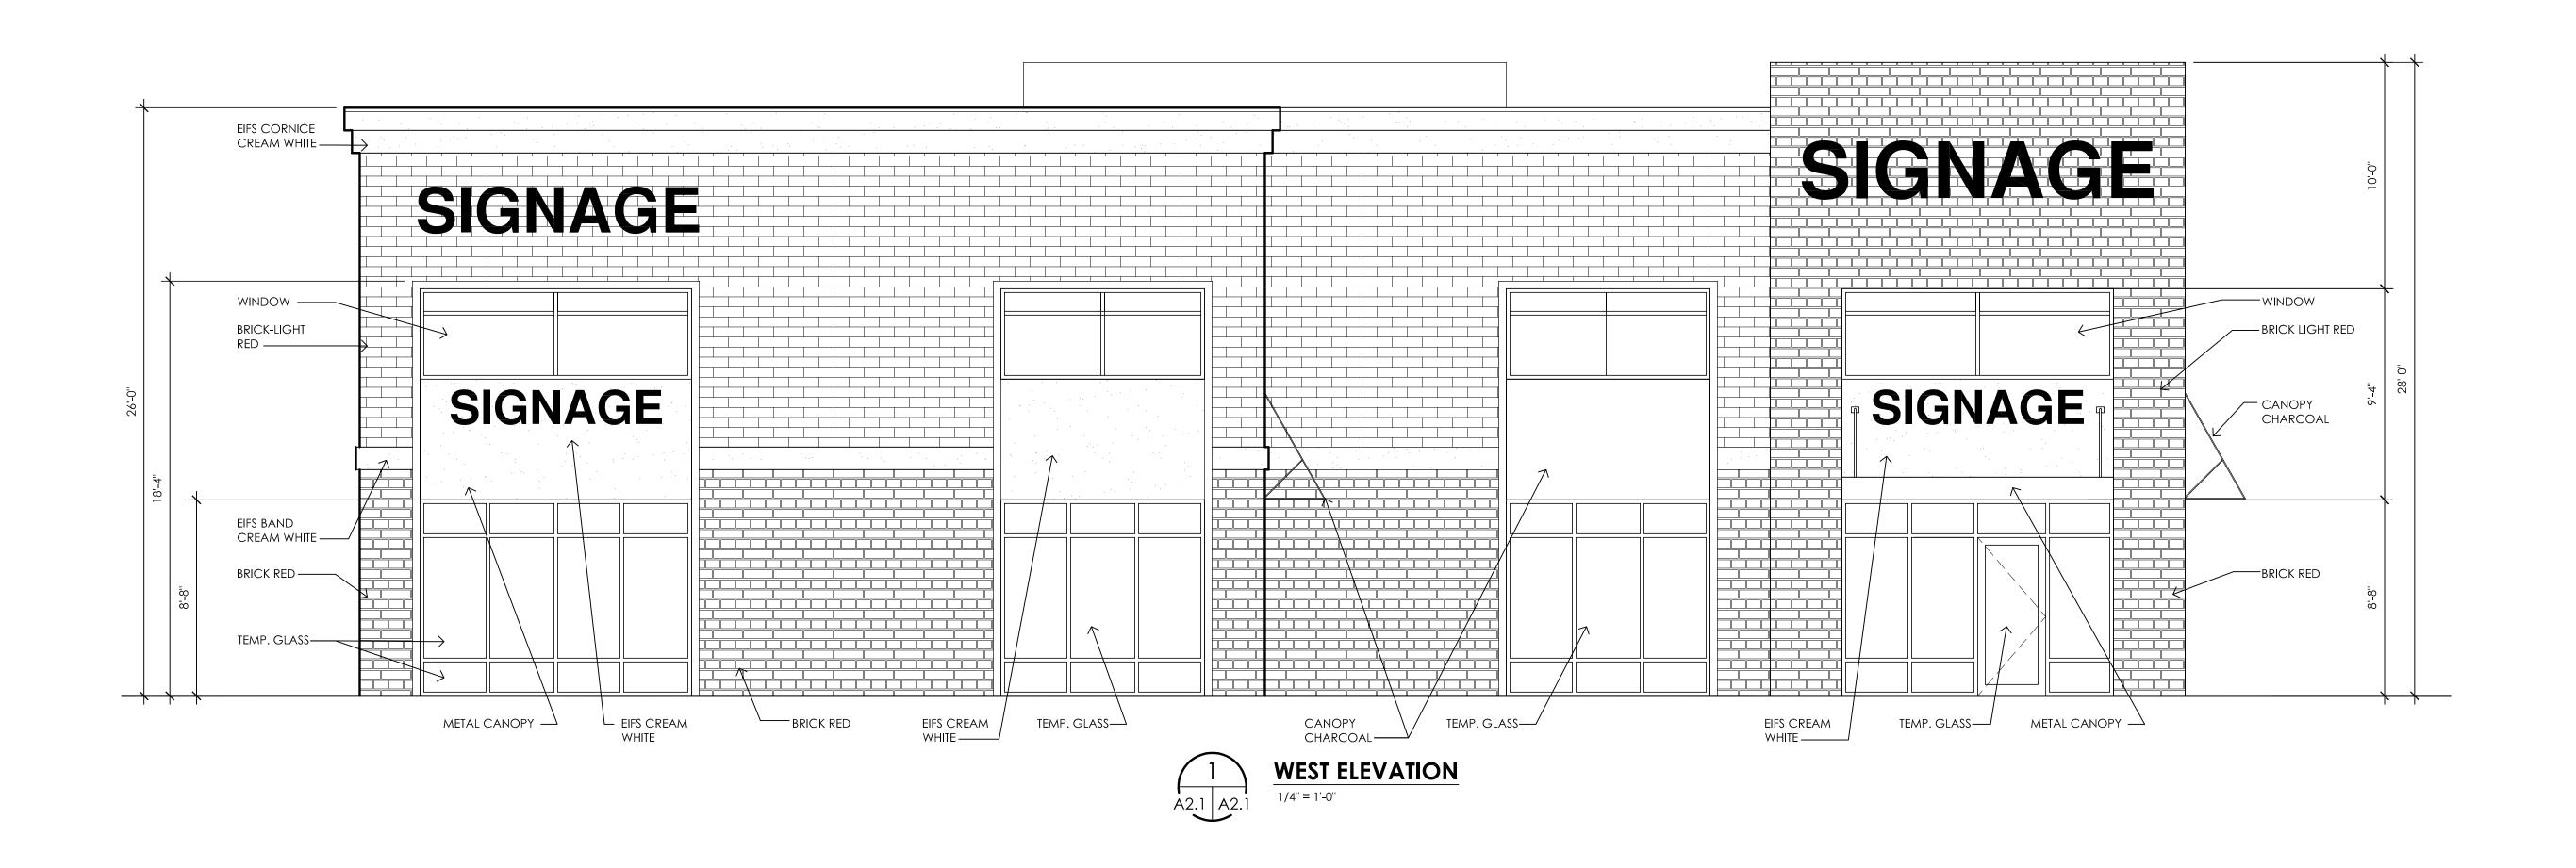

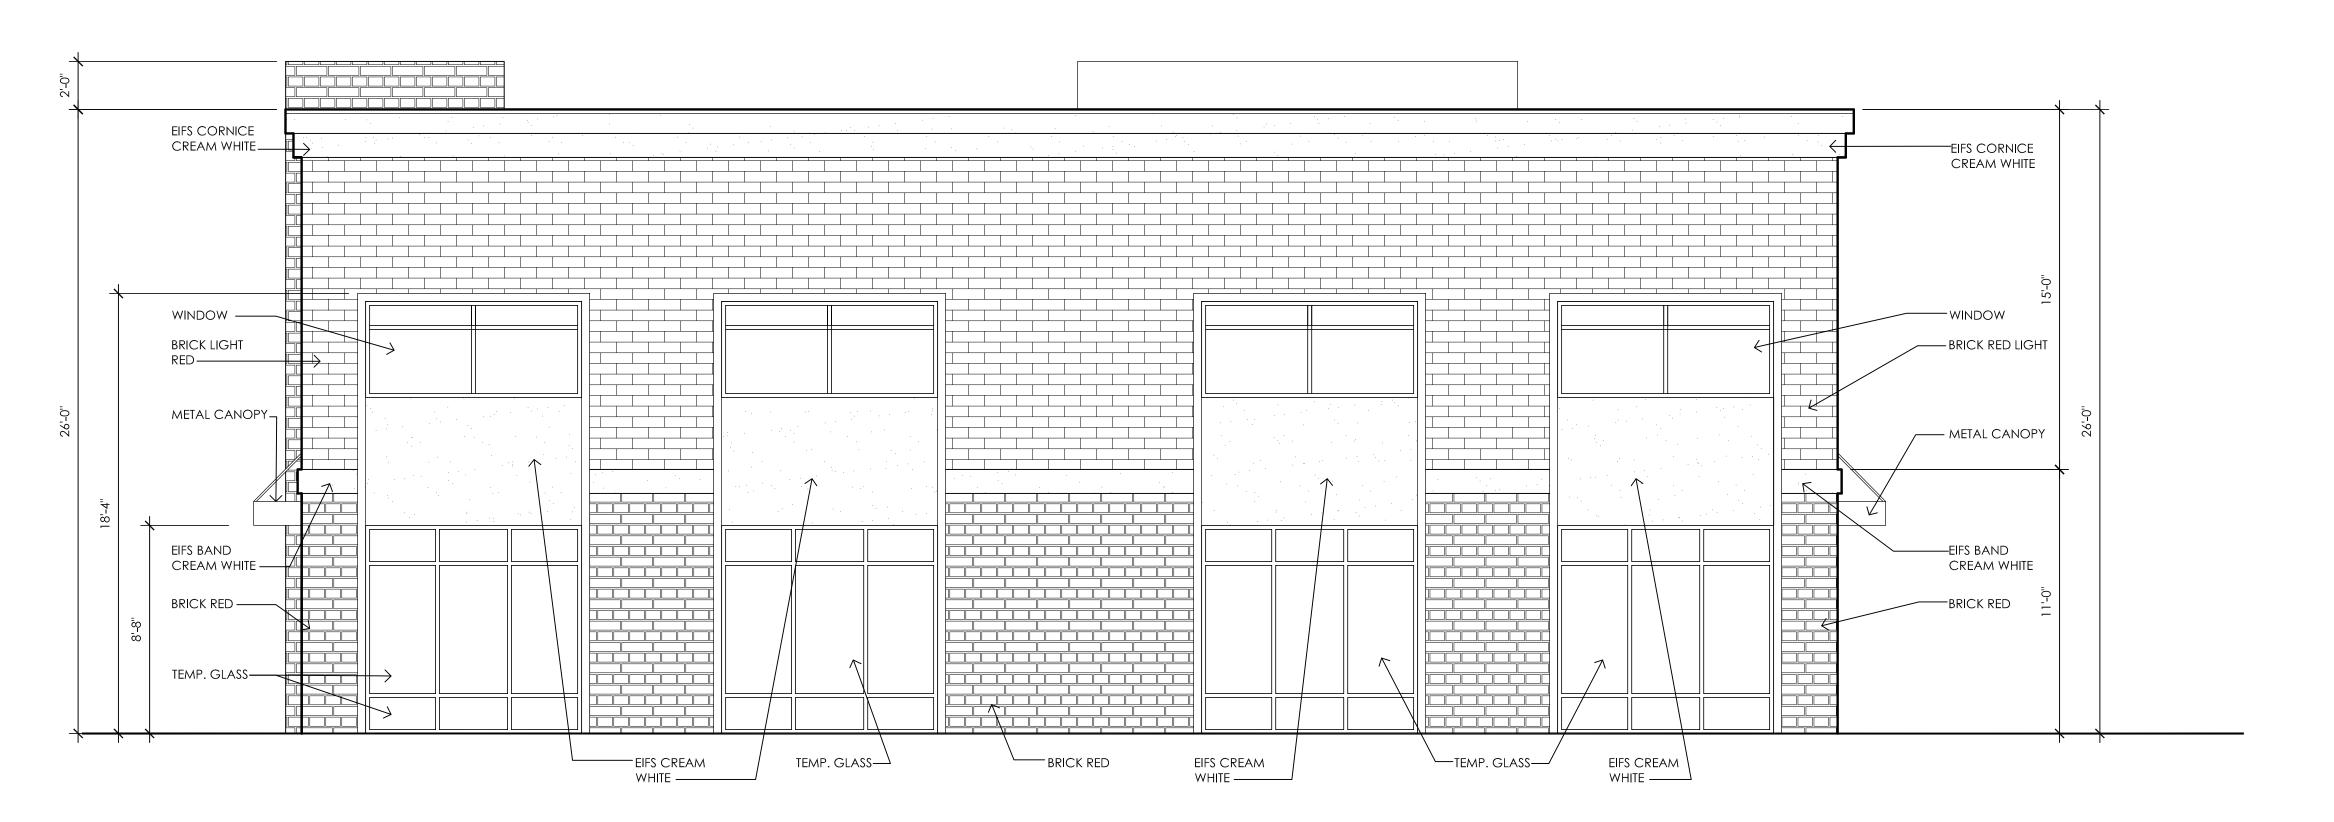





pud Design & gineering Services, In hitecture | Engineering | Interior Designation of the control of the contro

3850 RESEARCH PARK DRIVE

ONS OR PARTIES MAY USE THIS DESIGN AND WITHOUT THE CONSENT OF BUD DESIGN AND ... AND CARY M. RAUDEBAUGH
T BUD DESIGN AND IC. ALL RIGHTS RESERVED

ISSUED FOR DATE
PROGRESS 11.19.14

DATE: 11-18-14

DRAWN: AM

CHECKED: JSP

SCALE: ¼" =

JOB NO :BD-14-322-#2

SHEET TITLE :

SHEET TITLE : EXTERIOR ELEVATIONS

A