ANN ARBOR HISTORIC DISTRICT COMMISSION

Staff Report

ADDRESS: 449 Second Street, Application Number HDC14-178

DISTRICT: Old West Side Historic District

REPORT DATE: September 11, 2014

REPORT PREPARED BY: Jill Thacher, Historic Preservation Coordinator

REVIEW COMMITTEE DATE: September 8, 2014

OWNER APPLICANT

Name: Jill Bashutski & Matthew Kerrigan

Address: 449 Second Street

Ann Arbor, MI 48103

Phone: (734) 255-7713

BACKGROUND: This one-and-three-quarter story Greek Revival cottage appears in the 1894 City Directory without an occupant, and Gottlieb Gross, a laborer, lived there in 1897. The 1880 birdseye map (right) shows a structure similar to the main house block that exists today (without the side or rear wings). It is presumed to be the same house. By 1908 (per Sanborn) the one-story wing had been added to the south side, equal in depth to the main house. Sometime after 1970 (also per Sanborn) the one-story wing was extruded back and wrapped around the rear of the house, and a three-season porch was added.

LOCATION: The site is located on the east side of Second Street, one lot north of West Jefferson.


APPLICATION: The applicant seeks HDC approval to construct a one-story addition on the rear of the building with a deck behind it; remove a non-original window on the modern portion of the south elevation and install a new window opening nearby; install a new door opening near the back of the south elevation; and install new windows and doors on an existing rear three-season porch.

APPLICABLE REGULATIONS:

From the Secretary of the Interior's Standards for



Same

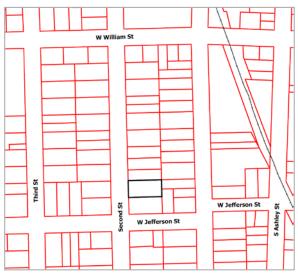

Rehabilitation:

- (2) The historic character of a property shall be retained and preserved. The removal of historic materials or alteration of features and spaces that characterize a property shall be avoided.
- (9) New additions, exterior alterations, or related new construction shall not destroy historic materials that characterize the property. The new work shall be differentiated from the old and shall be compatible with the massing, size, scale, and architectural features to protect the historic integrity of the property and its environment.
- (10) New additions and adjacent or related new construction shall be undertaken in such a manner that if removed in the future, the essential form and integrity of the historic property and its environment would be unimpaired.

From the Secretary of the Interior's Guidelines for Rehabilitating Historic Buildings (other SOI Guidelines may also apply):

Additions

<u>Recommended</u>: Constructing a new addition so that there is the least possible loss of historic materials and so that character-defining features are not obscured, damaged, or destroyed.

Considering the attached exterior addition both in terms of the new use and the appearance of other buildings in the historic district or neighborhood. Design for the new work may be contemporary or may reference design motifs from the historic building.

Locating the attached exterior addition at the rear or on an inconspicuous side of a historic building; and limiting its size and scale in relationship to the historic building.

Designing new additions in a manner that makes clear what is historic and what is new.

Not Recommended: Attaching a new addition so that the character-defining features of the historic building are obscured, damaged, or destroyed.

Designing a new addition so that its size and scale in relation to the historic building are out of proportion, thus diminishing the historic character.

Building Site

<u>Recommended</u>: Identifying, retaining, and preserving buildings and their features as well as features of the site that are important in defining its overall historic character.

Retaining the historic relationship between buildings and the landscape.

<u>Not Recommended</u>: Removing or radically changing buildings and their features or site features which are important in defining the overall historic character of the property so that, as a result, the character is diminished.

Windows

<u>Recommended:</u> Designing and installing additional windows on rear or other non-character-defining elevations if required by the new use. New window openings may also be cut into exposed party walls. Such design should be compatible with the overall design of the building, but not duplicate the fenestration pattern and detailing of a character-defining elevation.

<u>Not Recommended:</u> Changing the number, location, size or glazing pattern of windows, through cutting new openings, blocking-in windows, and installing replacement sash which does not fit the historic window opening.

Introducing a new design that is incompatible with the historic character of the building.

From the Ann Arbor Historic District Design Guidelines (other guidelines may apply):

Guidelines for All Additions

<u>Appropriate:</u> Placing a new addition on a non-character-defining or inconspicuous elevation and limiting the size and scale in relationship to the historic property.

Placing new walls in a different plane from the historic structure in a subordinate position to the historic fabric.

Designing a new addition in a manner that makes clear what is historic and what is new.

Limiting the size and scale of the addition in relationship to the historic building so that it does not diminish or visually overpower the building or the district. The addition's footprint should exceed neither half of the original building's footprint nor half of the original building's total floor area.

Not Appropriate: Designing an addition that overpowers or dramatically alters the original building through size or height.

Designing a new addition so that the size and scale in relation to the historic property are out of proportion.

STAFF FINDINGS:

- 1. The applicant seeks permission to construct a 13'6" x 13' one-story rear addition on the back of the house. Staff originally had reservations about adding on to this house, which has been nearly doubled in size since the end of the period of significance. However, the addition's location between the existing rear addition and enclosed porch, and the low-roofed design, mean there will be very little impact on the historic part of the house. The application steps in the addition from the rear corner of the house and mimics the rearfacing gable of the porch. The addition is closest to the driveway and garage of the house to the north, and should not negatively impact it.
- 2. Materials for the addition include wood siding and trim to match the existing, and clad wood doors (cladding material not specified) and windows. A composite deck in the

backyard would match the 13' width and extend out 10'.

- 3. The changes to the rear enclosed porch include replacing the double-hung windows and removing the south-facing door and replacing it with a pair of east-facing doors into the backyard. The porch is a modern addition, and these changes are appropriate and make the space more usable.
- 4. An existing window on the modern portion of the south-facing wall would be removed and relocated next to the existing kitchen window. The new window would match the size and design of the kitchen window. This change facilitates better space utilization on the interior. Since the window being removed is on a modern addition, and its replacement is proportionate with an existing window, this work is appropriate.
- 5. A new door is proposed near the back of the house on the south elevation, along the driveway. This is an appropriate location for a secondary door, and gives more convenient access to the house than the current rear door (which would remain, but is accessed via the rear porch). Since no historic features are impacted and the design of the wood door is compatible with the house, this work is appropriate.
- 6. Staff believes that the proposed work meets the Secretary of the Interior's Standards, the Secretary of the Interior's Guidelines for Rehabilitation, and the Ann Arbor Historic District Design Guidelines.

POSSIBLE MOTIONS: (Note that the motion is only a suggestion. The Review Committee, consisting of staff and at least two Commissioners, will meet with the applicant on site and then make a recommendation at the meeting.)

I move that the Commission issue a certificate of appropriateness for the application at 449 Second Street, a contributing property in the Old West Side Historic District, to construct a onestory rear addition, as proposed. The work is compatible in exterior design, arrangement, texture, material and relationship to the rest of the building and the surrounding area and meets *The Secretary of the Interior's Standards for Rehabilitation* and *Guidelines for Rehabilitating Historic Buildings*, in particular standards 2, 9 and 10 and the guidelines for additions and building site; and the *Ann Arbor Historic District Design Guidelines* for additions.

MOTION WORKSHEET:

I move that the Commission issue a Certificate of Appropriateness for the work at <u>449 Second Street</u> in the <u>Old West Side</u> Historic District

____ Provided the following condition(S) is (ARE) met: 1) STATE CONDITION(s)

The work is generally compatible with the size, scale, massing, and materials and meets the Secretary of the Interior's Standards for Rehabilitation, standard(S) number(S) (circle all that apply): 1, 2, 3, 4, 5, 6, 7, 8, 9, 10

ATTACHMENTS: application, photos, drawings.





City of Ann Arbor PLANNING & DEVELOPMENT SERVICES — PLANNING SERVICES

301 E. Huron Street | P.O. Box 8647 | Ann Arbor, Michigan 48107-8647 p. 734.794.6265 | f. 734.994.8312 | planning@a2gov.org

ANN ARBOR HISTORIC DISTRICT COMMISSION APPLICATION

Section 1: Property Being Reviewed and Ownership Information	
111.0	
Address of Property: 449 2nd St Ann Arbor MJ 48103	
Historic District: Old West Side	
Name of Property Owner (If different than the applicant):	
VIII Bashutski and Matthew Kerrigan	
Address of Property Owner: 449 2nd St.	
Daytime Phone and E-mail of Property Owner 739 - 255-7713/illbashutski &g mil.c	on
Signature of Property Owner:	
Section 2: Applicant Information	
Name of Applicant: Jill Bashitski and Matthew Kerrigan	
Address of Applicant: 449 2m St	
Daytime Phone: (134) 255-7713 Fax:(
E-mail: jillbashutski @ gnail.com	
Applicant's Relationship to Preperty:ownerarchitectcontactorother	
Signature of applicant:	
Section 3: Building Use (check all that apply)	
Residential Single Family Multiple Family Rental	
Commercial Institutional	
Section 4: Stille-DeRossett-Hale Single State Construction Code Act (This item MUST BE INITIALED for your application to be PROCESSED)	
Public Act 169, Michigan's Local Historic Districts Act, was amended April 2004 to include the following language: "the applicant has certified in the application that the property where the work will be undertaken has, or will have before the proposed completion date, a a fire alarm or smoke alarm complying with the requirements of the Stille-DeRossett-Hale Single State Construction Code Act, 1972 PA 230, MCL 125.1501 to 125.1531." Please initial here:	

Section 5: Description of Proposed Changes	(attach additional sheets as necessary)
Provide a brief summary of proposed cha	anges. See cover letter.
2. Provide a description of existing condition and documents.	ns. See attached drawings
3. What are the reasons for the proposed characterist space and	hanges? Lydating for insulation/security
4. Attach any additional information that will these attachments here. See attached documents and documents are also attached.	further explain or clarify the proposal, and indicate
	rty, including at least one general photo and detailed
	EE HOE ONLY
8/10 000	FF USE ONLY Application toStaff or HDC
Project No.:HDCI4-178	Fee Paid: 300 500
Pre-filing Staff Reviewer & Date:	Date of Public Hearing:
Application Filing Date:	Action:HDC COAHDC Denial
Staff signature:	HDC NTPStaff COA
Comments:	

DesignWorks

Architecture LLC

August 22, 2014

City of Ann Arbor Historical Commission submittal.

Project: 449 Second Street Residence Renovation and Addition

Submittal Content:

- Cover Letter and attachments (pictures, cut-sheets)
- Existing First Floor Plan
- Existing East Elevation
- Existing South Elevation
- Existing North Elevation
- Proposed Floor Plan
- Proposed East Elevation
- Proposed South Elevation
- Proposed North Elevation


Project Description:

The project is an interior renovation and a building addition project to a house within the City's historic district. The preliminary design proposes revisions to the exterior of the existing structure in 4 areas, as follows:

- 1. New entry door:
- as shown on Proposed South elevation
- 36" wide, 6'-8" high, wood door for field paint finish to match existing house door
- product cut-sheet attached
- 2. New kitchen window:
- as shown on Proposed South elevation
- nominal 36 wide x 36"high, to match existing adjacent window as to size, type and finish
- product cut-sheet attached
- 3. Building addition master bedroom
- as shown on Proposed East Elevation and Floor Plan
- exterior finish: wood siding and trim to match existing as to size, type and finish
- exterior doors: wood clad door with insulating glass, swing door unit and fixed side panels
- 4. Existing Screened porch upgrades:
- replace existing storm windows with wood clad insulating windows, sizes to match existing as shown on Proposed South Elevation.
- replace existing storm windows and screen door with wood clad insulating windows, and wood clad door unit, as shown on Proposed East Elevation





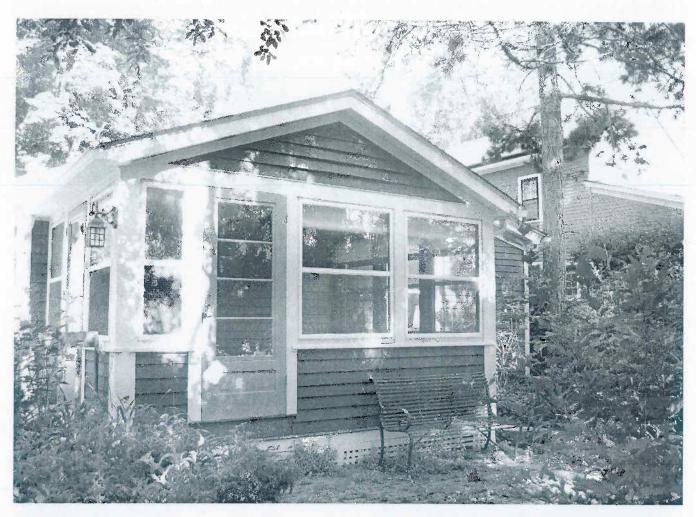









400 CEDICS WOODWRIGHT DOUBLE-HUNG WINDOW

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SEARCH



WINDOWS

DOORS

IDEAS RUANNING TPARTS & SERVICES

HUNG WINDOW



INTERIOR WOOD (3)

INTERIOR FINISH (2)

HARDWARE FINISH (12)

EXTERIOR COLOR (6)

EXTERIOR TRIM COLOR (11)

EXTERIOR TRIM PROFILES (6)





OVERVIEW

SIZES & **SHAPES**

GLASS

GRILLES

HARDWARE & **ACCESSORIES**

PERFORMANCE

INSTALLATION & WARRANTY

TECHNICAL DOCUMENTS

OVERVIEW

Double-hung windows have two sash in a single frame, which slide up or down to provide ventilation. Because their sash remain flush with the wall while the window is open, they are a good choice for placement adjacent to patios, decks and walkways.

Andersen® 400 Series Woodwright® double-hung windows feature thick, sloped sills, precision-milled wood interiors and historically accurate grille patterns, which bring authentic old-world character to homes of all ages.

- · Six exterior colors
- · Natural oak, maple, or pine interiors
- Energy efficient
- Dual-layer, compressible bulb weatherstripping seals out dust, wind and water
- · Variety of hardware styles and finishes
- · Custom sizing and replacement version available

TILT-WASH FULL-FRAME WINDOWS

Table of Tilt-Wash Double-Hung Window Sizes

Scale 1/8"	(3) =	= 1'-0"	(305)	-1:96
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Window Dimension	1'-9 ⁵ / ₈ " (549)	2'-1 ⁵ /8" (651)	2'-5 ⁵ /8" (752)	2'-7 ⁵ /8" (803)	2'-9 ⁵ /8" (854)	2'-11 ⁵ /8" (905)	3'-1 ⁵ /8" (956)	3'-5 ⁵ /8" (1057)	3'-9 ⁵ /8" (1159)		
Minimum Rough Opening	1-10 ¹ /8" (562)	2'-2 ¹ /8" (664)	2'-6 ¹ /8" (765)	2'-8 ½8" (816)	2'-10 ¹ /8" (867)	3'-0 1/8" (917)	3'-2 ¹ /8" (968)	3'-6 ¹ /8" (1070)	3'-10 ¹ /8" (1172)		
Unobstructed Glass (lower sash only)	15" (381)	(483)	23" (584)	25" (635)	27" (686)	29" (737)	31" (787)	35" (889)	39" (991)		
3'-0 7/8" (937) 3'-0 7/8" (937) 13 15/16"										WITCHEN	
	TW18210	TW20210	TW24210	TW26210	TW28210	TW210210	TW30210	TW34210	TW 38210		
3'-4 7/8" (1038) 3'-4 7/8" (1038) 15 15/16" (405)											
	TW1832	TW2032	TW2432	TW2632	TW2832	TW21032	TW3032	TW3432	TW3832		
3'-8 7/8" (1140) 3'-8 7/8 (1140) 17 15/16" (456)										Cottage and reverse cottage sash available for these	
	TW1836	TW2036	TW2436	TW2636	TW2836	TW21036	TW3036	TW3436	TW3836	heights and in all widths.	D - D
4'-0 7/8" (1241) 4'-0 7/8" (1241) 19 15/16" (506)											POPCH
	TW18310	TW20310	TW24310	TW26310	TW28310	TW210310	TW30310	TW34310	TW38310	Cottage Reverse Cottage	
4-4 7/8" (1343) 4-4 7/8" (1343) 21 15/16" (557)	in the second		2	-	<u></u>						
	TW1842	TW2042	TW2442	TW2642	TW2842	TW 21042	TW 3042	TW3442	TW3842		
4'-8 7/8" (1445) 4'-8 7/8" (1445) 23 15/16" (608)	7					1					
	TW1846	TW2046	TW2446	TW2646	TW2846	TW21046	TW30460	TW3446°	TW 3846◊		
5'-0 7/8" (1546) 5'-0 7/8" (1546) 25 15/16" (659)											
August 1											
	TW18410	TW20410	TW24410	TW26410	TW28410	TW210410°	TW30410 ⁰	TW34410 ⁰	TW38410°		
5'-4 7/8" (1648) 5'-4 7/8" (1648) 27 15/16" (710)											
	TW1852	TW2052	TW2452	TW2652	TW 2852¢	TW210526	TW3052°	TW3452 [◊]	TW3852 [≬]		
7/8" 19) 7/8" 19) (0)											
5-8 7/8" (1749) 5-8 7/8" (1749) 29 15/16" (760)											
	TW1856	TW2056	TW2456	TW2656	TW2856	TW21056°	TW30560	TW3456°	TW3856 ⁰		
6'-0 7/8" (1851) 6'-0 7/8" (1851) 31 15/16" (811)											
(1)										• "Window Dimension" always refe	rs to
	TW18510	TW20510	TW24510 ⁰	TW26510 [◊]	TW28510 [◊]	TW210510°	TW 30510⁰	TW34510°	TW38510 ⁰	outside frame to frame dimension. • "Minimum Rough Opening" dim may need to be increased to allow	ensions w for use
6'-4 7/8" (1953) 6'-4 7/8" (1953) 33 15/16" (862)										of building wraps, flashing, sill pa brackets, fasteners or other items • Dimensions in parentheses are in	s.
33 0 0										millimeters. Neet or exceed clear opening are 5.7 sq.ft, or 0.53 m², clear opening of 20" (508) and clear opening height	g width
	TW1862	TW2062	TW 2462◊	TW2662 [◊]	TW28620	TW21062 [◊]	TW30620	TW 3462 [◊]	TW3862 [◊]	of 24" (610).	igin

continued on next page

HOME THRODOCIS VIDORS THINGED PATIO TATIO 400 SERIES FRENCHWOOD HINGED PATIO DOOR

400 SERIES FRENCHWOOD HINGED PATIO DOOR











SIZES & SHAPES

GLASS

GRILLES

HARDWARE & **ACCESSORIES**

PERFORMANCE

INSTALLATION & WARRANTY

TECHNICAL DOCUMENTS

OVERVIEW

Andersen® 400 Series Frenchwood® hinged patio doors not only open your home to the world outside, they bring the beauty of nature inside. They can flood a room with sunlight and provide panoramic views, and their wide wood profiles add an undeniable elegance to their surroundings—yet they are just as effective in sealing the elements out.

Our 400 Series Frenchwood hinged patio doors are available as inswing or outswing models with optional sidelights and transom windows. Transom windows go above a door while sidelights flank

- · Traditional French door styling
- · Energy efficient
- · Solid wood door
- · Quality construction with mortise-and-tenon dowel
- Multipoint locking system that seals the doors tight at the top, center and bottom
- · Extensive array of options and accessories, including

FRENCHWOOD® HINGED INSWING PATIO DOORS

Table of Frenchwood* Hinged Inswing Patio Door Sizes

Scale $\frac{1}{8}$ " (3) = 1'-0" (305) - 1:96 2'-0 1/2" 4'-0" 4'-0" Door Dimension (620) (1219)(1219)2'-1" 4'-1' 4'-1" Rough Opening (634)(1242)(1242)13 1/4" 13 1/4" Unobstructed Glass 13 1/4" (single panel only) (336) (336)(336)Custom-size doors are available in 1/8" (3) increments between 3 heights the smallest and largest standard door sizes. Measurement guide can be found at andersenwindows.com/measure. Some restrictions apply. Contact your Andersen supplier for availability. FWH2168S FWH4168APLR FWH4168PALR FWH21611S FWH41611APLR FWH41611PALR FWH2180S FWH4180APLR FWH4180PALR 2'-61/8" 2'-61/8" 21-61/8" 4'-11 1/4" 4'-11 1/4" 4'-11 1/4" 4'-11 1/4" 4'-11 1/4" Door Dimension (765)(765) (765) (1504)(1504)(1504)(1504)(1504)2'-7" 2'-7" 2'-7" 5'-0" 5'-0" 5'-0" 5'-0" 5'-0" Stationary (S) doors Rough Opening (787)(787) (787)(1524)(1524)(1524)(1524)(1524)can be used as an 18 7/8" 18 7/8" 18 7/8" 18 7/8 18 7/8" 18 7/8" Unobstructed Glass 18 7/8" 18 7/8" individual unit or as (479) (single panel only) (479)(479) (479)(479) (479)(479)(479)a sidelight. 3 heights FWH2768S FWH2768AR FWH2768AL FWH5068SS FWH5068ASR FWH5068SAL FWH5068APLR FWH5068PALR FWH27611S FWH27611AR FWH27611AL FWH50611SS FWH50611ASR FWH50611SAL FWH50611APLR FWH50611PALR FWH2780S FWH2780AR FWH2780AL FWH5080SS FWH5080ASR FWH5080SAL FWH5080APLR FWH5080PALR 2'-8 1/8" 2'-8 1/8" 21-8 1/8" 5'-3 1/4" 5'-3 1/4" 5'-3 1/4" 5'-3 1/4' 5'-3 1/4" Door Dimension (816) (816) (816) (1607)(1607)(1607) (1607)(1607)2'-9" 2'-9" 2'-9" 5'-4" 5'-4" 5'-4" 5'-4" Minimum 5'-4" Rough Opening (838) (838) (838) (1626) (1626)(1626)(1626)(1626) 20 7/8" 20 7/8" 20 7/8" 20 7/8" 20 7/8" 20 7/8" 20 7/8 Unobstructed Glass 20 7/8" (530) (530) (530) (530)(single panel only) (530)(530)(530)(530)3 heights FWH2968S FWH2968AR FWH2968AL FWH5468SS FWH5468ASR FWH5468\$AI FWH5468APLR FWH5468PALR FWH29611S FWH29611AR FWH29611AL FWH54611SS FWH54611ASR FWH54611SAL FWH54611APLR FWH54611PALR FWH2980AR FWH2980AL FWH5480SS FWH5480ASR FWH5480SAL FWH5480APLR FWH5480PALR 3'-0 1/8" 3'-0 1/8" 3'-0 1/8" 5'-11 1/4" 5'-11 1/4" 5'-11 1/4" 5'-11 1/4" 5'-11 1/4" Door Dimension (918)(918)(918)(1810)(1810) (1810)(1810)(1810)3'-1" 3'-1" 6'-0" 6'-0" 6'-0' Minimum 6'-0" 6'-0' Rough Opening (940) (940) (1829)(1829) (1829)(1829)(1829) 24 7/8" 24 7/8" 24 7/8 24 7/8" 24 7/8" Unobstructed Glass 24 7/8 24 7/8 74 7/8 (632) (632) (single panel only) (632) (632)(632)(632)(632)(632)3 heights FWH3168S FWH3168AR FWH3168AL FWH6068SS FWH6068ASR FWH6068SAL FWH6068APIR FWH6068PALR FWH31611S FWH31611AR FWH31611AL FWH60611SS FWH60611ASR FWH60611SAL FWH60611APLR FWH60611PALR FWH3180S FWH3180AR FWH3180AL FWH6080ASR FWH6080SAL FWH6080APLR FWH6080PALR


 [&]quot;Door Dimension" always refers to outside frame to frame dimension.

^{• &}quot;Minimum Rough Opening" dimensions may need to be increased to allow for use of building wraps, flashing, sill panning, brackets, fasteners or other items

Dimensions in parentheses are in millimeters




Three Patio Door Heights

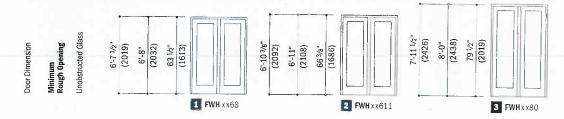

Order Designation Description

Viewed from the exterior.

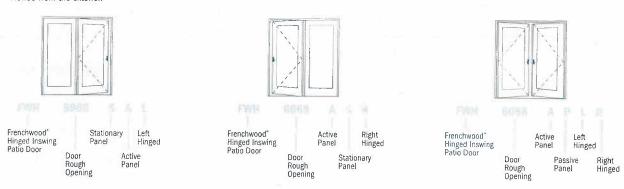

FWH90611SSS FWH9080SSS	FWH90611SASR FWH9080SASR	FWH9060SASL FWH90611SASL FWH9080SASL
WH9068SSS	FWH9088SASR	FWH9068SASL
(632)	(632)	(632)
24 7/8"	24 7/8"	24 7/8"
(2743)	(2743)	(2743)
9'-0"	9'-0"	9'-0"
(2721)	(2721)	(2721)
8'-11 1/8"	8'-11 1/8"	8'-11 1/8"
WH80611 SSS WH8080 SSS	FWH80611SASR FWH8080SASR	FWH80611SASL FWH8080SASL
WH8068SSS	FWH8068SASR	FWH8068SASL
(530)	Î Î (530)	(530)
20 ⁷ /8 ^N	20 7/8"	20 7/8"
(2438)	(2438)	(2438)
8'-0"	8'-0"	8'-0"
(2416)	(2416)	(2416)
	7'-11 1/8" (2416)	7'-11 ¹/s" (2416)

- "Door Dimension" always refers to outside frame to frame dimension.
 "Minimum Rough Opening" dimensions may need to be increased to allow for use of building wraps, flashing, sill panning, brackets, fasteners or other items.
- · Dimensions in parentheses are in millimeters.







ANY DOOR. ANY GLASS.



7504 TDL / 37504 SDL, IG 7802 TDL / 37802 SDL, IG sidelight Option: **504** SG door, **1802** SG sidelight

7524 TDL / 37524 SDL, IG Shown with optional rain glass **经合效**了(V





7506 TDL / 37506 SDL, IG 7803 TDL / 37803 SDL sidelight Option: 506 SG, 1803 SG sidelight

7526 TDL / 37526 SDL, IG 7508 TDL / 37508 SDL, IG (4) 全) 建二个

7804 TDL / 37804 SDL sidelights Option: 508 SG door, 1804 SG sidelights


7528 TDL / 37528 SDL, IG

7512 TDL / 37512 SDL, IG 7804 TDL / 37804 SDL sidelight Option: 512 SG, 1804 SG sidelight





7522 TDL / 37522 SDL, IG

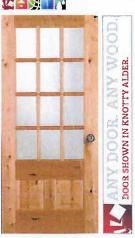



Note: Door details may have to be altered slightly to accept the WaterBarrier® technology upgrade. Contact a Simpson Authorized Dealer for final specifications.
























1.800.SIMPSON


TRUE SIMULATED 3/4" INSULATED 1/8" SINGLE DIVIDED LITE GLAZING GLAZING

CAMING CHOICES

PRIVACY RATING

ULTRA BLOCK

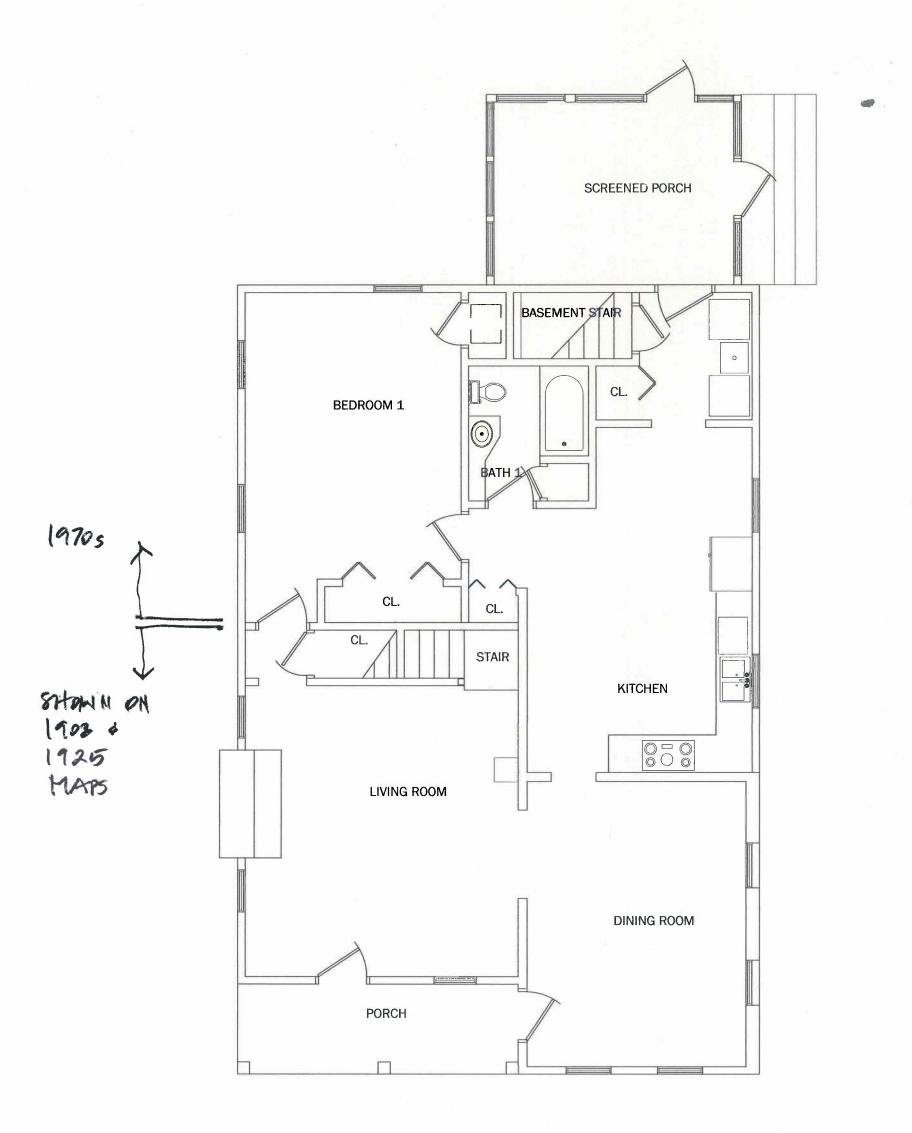

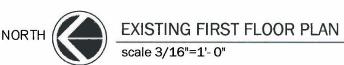

9-22-14 Hist.C.

Drawing Title:
as noted

Sheet Number:
SK-# of #
Scale:
as noted

449 Second
Street
Residence
Renovation
&
Addition
Ann Arbor
Mi.

DesignWorksArch@ aol.com 1125 Newport Rd. Ann Árbor Mi. 48103 734 -623-8253

DesignWorksArchitecture, LLC

SK-# of #
Scale:
as noted

LOWER LEVEL ELEV. FIRST FLOOR ELEV. SECOND FLOOR ELEV. GRADE

EXISTING EAST ELEVATION

scale 3/16"=1'- 0"

Architecture, LLC

1125 Newport Rd. Ann Arbor Mi. 48103 734-623-8253

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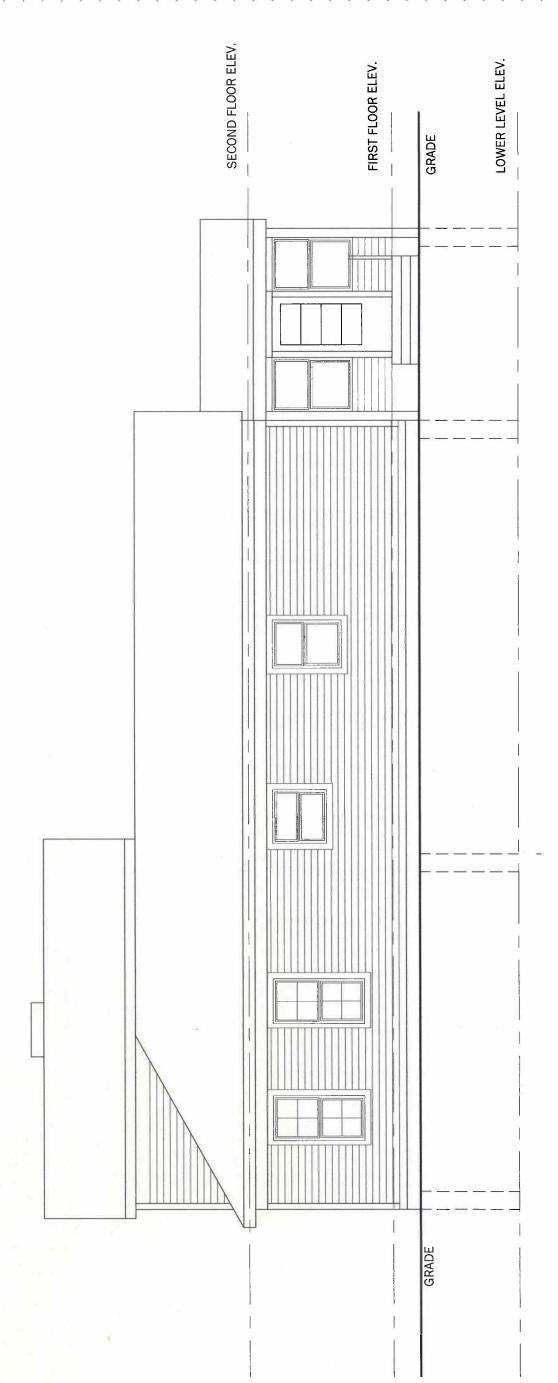
449 Second Street Residence Renovation & Addition

Ann Arbor Mi.

Sheet Number: SK-# of #

scate: as noted

EXISTING SOUTH ELEVATION scale 3/16"=1'-0"



1125 New Ann Arbor Mi. 48103 734-623-8

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449 Secor Street Residence Renovation & Addition

Ann Arbor Mi.

FIRST FLOOR ELEV.

GRADE


GRADE

LOWER LEVEL ELEV.

Sheet Number SK-# of Scale:

SECOND FLOOR ELEV.

EXISTING NORTH ELEVATION scale 3/16"=1'- 0"

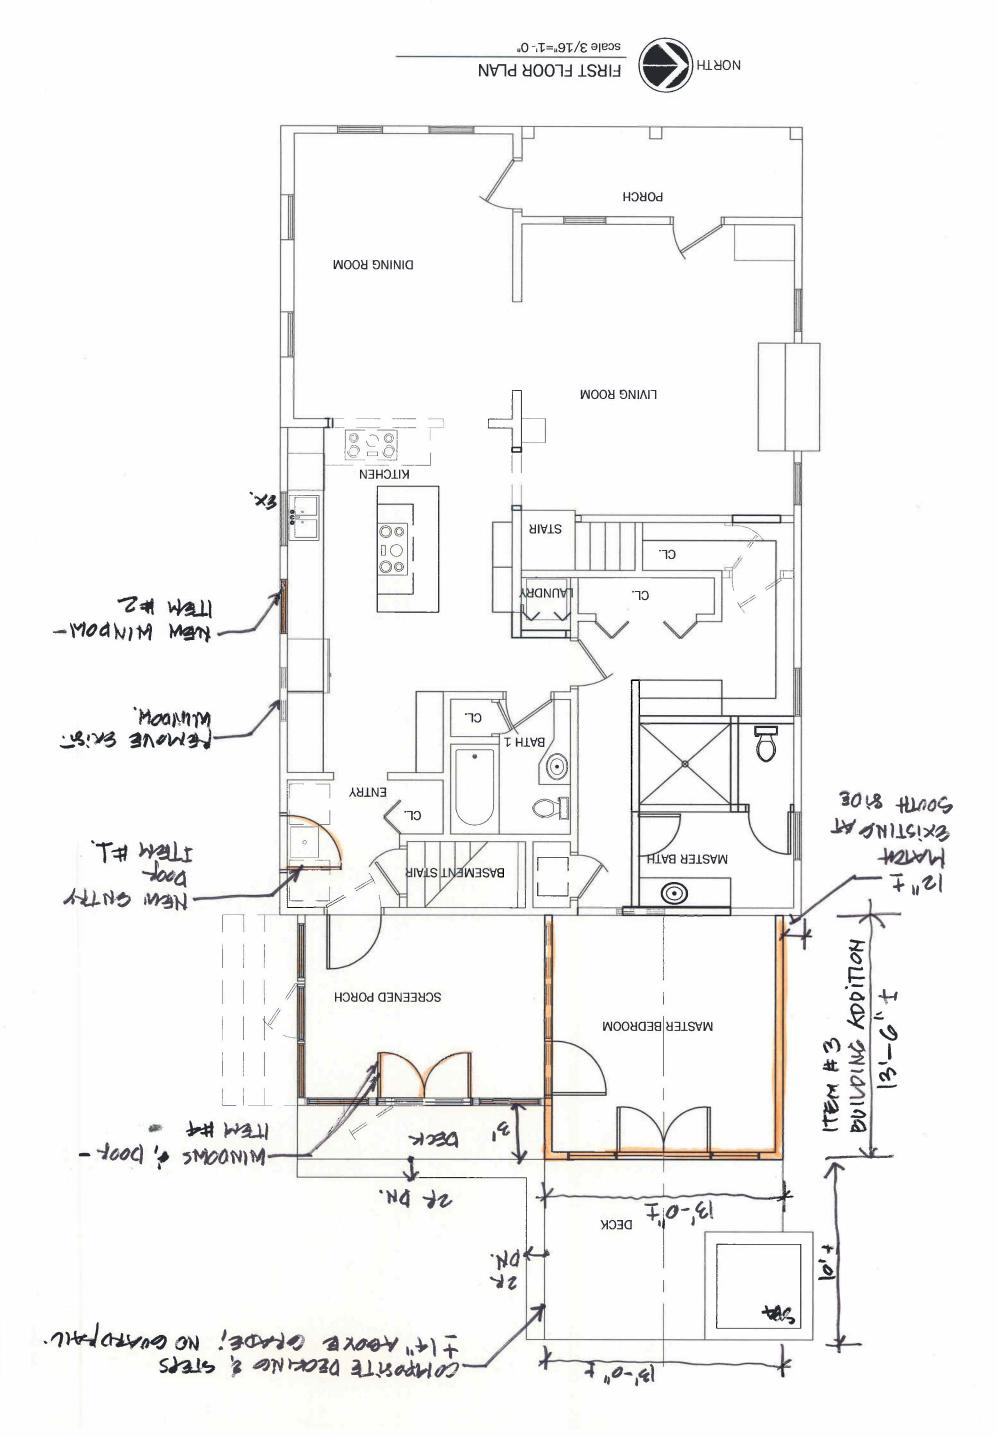

449 Second Street Residence Renovation & Addition Ann Arbor

B-22-14Hist.C.
Drawing Title:
as noted

Sheet Number:
SK-# of #
Scale:
as noted

P. DOE SL. 11-0"+MATER POPUR FIDER LEAVE SC. 85-0"T ABOVE FLA. LOWER LEVEL ELEV. SECOND FLOOR ELEV. FIRST FLOOR ELEV. GRADE BLE ADDITION 2x6 BALK 6 x68 BR. 28×4 PARDING 284 Exist. Porch 1+ WINDOWS : Daok GRADE

PROPOSED EAST ELEVATION

scale 3/16"=1'- 0"

Architecture, LLC

1125 Newport Rd. Ann Arbor Mi. 48103 734-623-8253

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449 Second Street Residence Renovation & Addition

Ann Arbor Mi.

8-22-14 Hist.C.

Drawing Title: as noted

Scale: as noted Sheet Number SK-# of #

APPITTION DESIGNA FIRST FLOOR ELEV. GRADE IN EXPA: Potest NOM. 28 x 4: NEW SNYRY L Pook of STEPS LNEW WINDOW TOM. 3'X9'

GRADE

PROPOSED SOUTH ELEVATION scale 3/16"=1'- 0"

Architectu 1125 New Ann Arbor Mi. 48103 734-623-{

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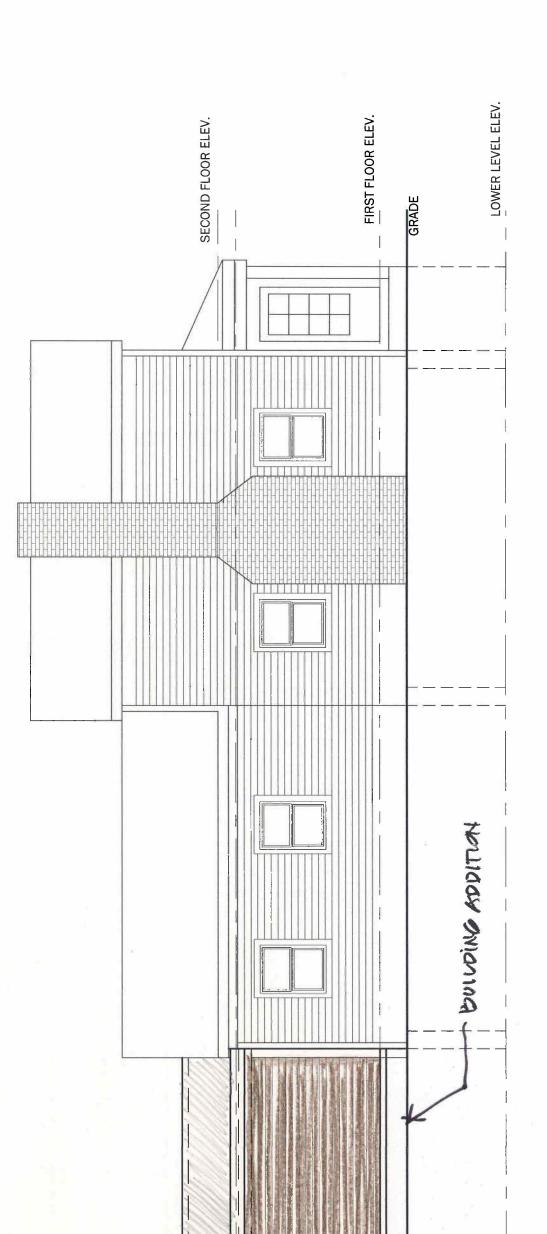
Ann Arbor Mi.

8-22-14 I Drawing Title:

Sheet Number

Scale: as not

PROPOSED NORTH ELEVATION scale 3/16"=1'-0"



GRADE