OWNER/DEVELOPER/PETITIONER: 303 DETROIT STREET LLC

GREG COPP 2723 SOUTH STATE STREET SUITE 250 ANN ARBOR MICHIGAN 48104 PHONE: 734-930-6700

BUILDER/DEVELOPMENT PARTNER: **HURON CONTRACTING**

PO BOX 3783 ANN ARBOR, MI 48106 PHONE: 734-395-0470

THOMAS FITZSIMMONS

ENGINEER/PETITIONER'S AGENT:

MACON ENGINEERING, LLC KATHY KEINATH, P.E. PO BOX 314

PHONE: 734-216-9941

CHELSEA. MI 48118

ARCHITECT **RUETER ASSOCIATES** MARC RUETER & JIM SCRIVENS

515 FIFTH STREET ANN ARBOR. MI 48103 PHONE: 734-769-0070

LEED CONSULTANT CATALYST PARTNERS JENNIFER ANDREW, NCARB, LEED-AP

502 2ND STREET NW, SUITE 200 **GRAND RAPIDS. MI 49504** PHONE: 734-649-4395

SURVEYOR:

KEM-TEC & ASSOCIATES ANTHONY SYCKO, JR, PS 2255 GRATIOT AVE. EASTPOINTE, MI 48021 586-772-2222

STATEMENT OF INTEREST IN LAND

THE PETITIONER IS THE OWNER, DEVELOPER AND MANAGING MEMBER OF THE PROPERTY.

DEVELOPMENT PROGRAM

THE DEVELOPMENT PROGRAM FOR THE PROJECT INCLUDES COMMERCIAL SPACE FOR POSSIBLE RETAIL OR OOFICE ON THE GROUND FLOOR, AND ACCESS TO PARKING STORAGE AND BUILDING SERVICES ON THE GROUND FLOOR. THE REMAINING FLOORS WILL PROVIDE 14 RESIDENTIAL CONDOMINIUMS. THE SITE IS ZONED D2 AND IN THE KERRYTOWN CHARACTER DISTRICT WITH PRIMARY STREET FRONTAGE ON DETROIT STREET AND SECONDARY STREET FRONTAGE ON FIFTH AVENUE. PARKING WILL ALSO BE PROVIDED IN A LOWER LEVEL.

THE DEVELOPMENT HAS BEEN PLANNED TO PROVIDE ADEQUATE PARKING, INGRESS AND EGRESS, STORM WATER MANAGEMENT FACILITIES, PEDESTRIAN CONNECTIONS AND ALL OTHER REQUIRED SITE ELEMENTS. THE SITE IS TO BE DEVELOPED IN ONE PHASE. IT IS SCHEDULED TO BEGIN UPON APPROVAL AND BE COMPLETED BY 2023. CONSTRUCTION COST ARE CURRENTLY ESTIMATED TO BE \$20,000,000. THE PROJECT WILL BE REQUESTING BROWNFIELD FUNDING.

COMMUNITY ANALYSIS

THE PROPOSED PROJECT SITE IS LOCATED WITH FRONTAGE ON BOTH DETROIT STREET AND FIFTH AVENUE JUST NORTH OF CATHERINE STREET IN DOWNTOWN ANN ARBOR. THE SITE IS CURRENTLY ZONED D2. THE EXISTING SITE INCLUDES THREE PARCELS WITH TWO BUILDINGS AND PARKING AREAS. THE PROPERTY TO THE WEST IS FARMER'S MARKET ZONED PL. THE PROPERTY TO THE NORTH IS THE KERRYTOWN SHOPS, ZONED D2. AND THE ANN ARBOR PUBLIC SCHOOLS ZONED PL. THE PROPERTY TO THE SOUTH IS ZONED D2 AND CONTAINS TWO HISTORIC BUILDINGS. THE PROPOSED BUILDING HAS BEEN DESIGNED WITH OPEN BALCONIES TO REDUCE THE STRUCTURAL MASS ADJACENT TO THE HISTORIC PROPERTIES. THE PROPOSED BUILDING WILL BE DESIGNED AS A CERTIFIED BUILDING PER LEED BD+C: HOMES V4.

THE PROPOSED DEVELOPMENT IS NOT ANTICIPATED TO HAVE A NEGATIVE IMPACT ON PUBLIC SCHOOLS, SURROUNDING DEVELOPMENT, AIR OR WATER QUALITY. THERE ARE NO HISTORIC SITES OR STRUCTURES ON THE PROJECT SITE. THERE ARE NO NATURAL FEATURES ON THE SITE.

TRAFFIC IMPACT ANALYSIS

VEHICULAR, PEDESTRIAN AND BICYCLE ROUTES ARE SHOWN ON THE PLANS. TRIP GENERATIONS ARE SHOWN BELOW BASED ON THE INSTITUTE OF TRANSPORTATION ENGINEERS COMMON TRIP GENERATIONS FOR CONDOMINIUM USES. NO TRAFFIC STUDY IS REQUIRED BASED ON CITY CODE.

SITE TRIP GENERATION

				А	M Peak Ho	ur	P	M Peak Ho	ur
Land Use	ITE Code	Amount	Units	In	Out	Total	In	Out	Total
Retail Center	826	1.836	1000 sf	1	0	1	2	3	5
Condominiums	230	14	DU	1	7	8	6	3	10

Trip Rates taken from ITE Trip Generation manual, 10th Edition

SOIL EVALUATION

THE SOILS ON THE SITE ARE FOX SERIES FOB BASED ON THE COUNTY SOIL MAPS. INFILTRATION TESTING ON THE SITE WAS NOT PERFORMED AS THE SITE HAS KNOWN CONTAMINATION AND INFILTRATION COULD POSSIBLY EXACERBATE THE SPREAD OF THE CONTAMINATION.

330 DETROIT

ANN ARBOR, WASHTENAW COUNTY

SITE PLAN SP21-046

COMPARISON CHART

	EXISTING		PROPOSED		REQUIRED
Zoning District	D2		D2		D2
Charater Overlay District	Kerrytown		Kerrytown		Kerrytown
Lot Area	9,879	sf	9,879	sf	N/A
Lot Width	177.11	ft	177.11	ft	N/A
Residential Dwelling Units	0		14		N/A
Commercial Units	2		1		N/A
Total Floor Area	3,745	sf	31,944	sf	N/A
FAR	38%		323%		200% Normal 400% w premiums
Front Setback Detroit	0.00	ft	1.0	ft	0 ft
Front Setback Fifth	0.00	ft	1.0	ft	0 ft
Side Setback	0.00	ft	1.37	ft	0 ft
Rear Setback	N/A	ft	N/A	ft	N/A
Building Height	1 story		60	ft	Max 60 ft
Streetwall Height	N/A		3 stories		Min 2 stories, Max 3 stories
Offset at Top of Streetwall	N/A		5	ft	Ave 5 ft
Massing Articulation	N/A		40	ft	Max 40 ft
Building Coverage	38%		80%		Max 80%
Open Space	N/A		11%		Min 10%
Bicycle Parking Residential	0		14A		14 A 1/2500 sf usable floor area
Bicycle Parking Nonresidential	0		1C		1 C 1/10,000 sf usable floor area
Vehicular Parking			23		15 Base FAR none, Premium 1/1000 sf
EV-C Vehicular Parking	0		9		9.1 65% of Dwelling Units
EV-R Vehicular Parking	0		4		3.5 25% of Dwelling Units
EV-I Vehicular Parking	0		1		1.4 10% of Dwelling Units

GENERAL DESCRIPTION OF NATURAL FEATURES

THERE ARE NO WOODLANDS, WETLANDS, LANDMARK TREES, WATERCOURSES, STEEP SLOPES, FLOODPLAINS, OR ENDANGERED SPECIES HABITAT LOCATED ON THE SITE.

NATURAL FEATURES STATEMENT OF IMPACT

THERE ARE NO NATURAL FEATURES LOCATED ON THE SITE. THERE WILL BE NO IMPACT TO NATURAL FEATURES.

STANDARD SIDEWALK REPAIR AND MAINTENANCE NOTE


ALL SIDEWALKS ARE TO BE KEPT AND MAINTAINED IN GOOD REPAIR BY THE OWNER OF THE LAND ADJACENT TO AND ABUTTING THE SAME. PRIOR TO THE ISSUANCE OF THE FINAL CERTIFICATE OF OCCUPANCY FOR THIS SITE, ALL EXISTING SIDEWALKS IN NEED OF REPAIR MUST BE REPAIRED IN ACCORDANCE WITH CITY STANDARDS.

SOLID WASTE DISPOSAL PLAN

THE UNIQUE GEOMETRY OF THE SITE AS WELL AS THE CONFIGURATION OF DETROIT STREET AND FIFTH AVENUE MAKE ACCESS TO THE SITE FOR SOLID WASTE TRUCKS CHALLENGING. THE DEVELOPMENT CONSIDERED SEVERAL INNOVATIVE SOLUTIONS THAT TOOK INTO ACCOUNT SAFE ACCESS FOR TRUCKS. SAFETY OF PEDESTRIANS AND SAFETY OF MOTOR VEHICLES USING DETROIT STREET AND FIFTH AVENUE. IT WAS DETERMINED THAT THE BEST SOLUTION WAS TO ELIMINATE THE NEED FOR SOLID WASTE VEHICLES TO ENTER AND EXIT THE SITE. A COMPLETE SOLID WASTE MANAGEMENT PLAN IS PROVIDED IN THE PLAN SET TO ADDRESS SOLID WASTE MANAGEMENT.

SUSTAINABILITY/LEED

THE PROPOSED DEVELOPMENT IS TO ACHIEVE LEED CERTIFICATION. SUSTAINABILITY WILL ALSO BE PROVIDED BY A GREEN ROOF, SHARING OF REFUSE CONTAINERS AND ACCOMMODATIONS FOR ELECTRIC VEHICLES.

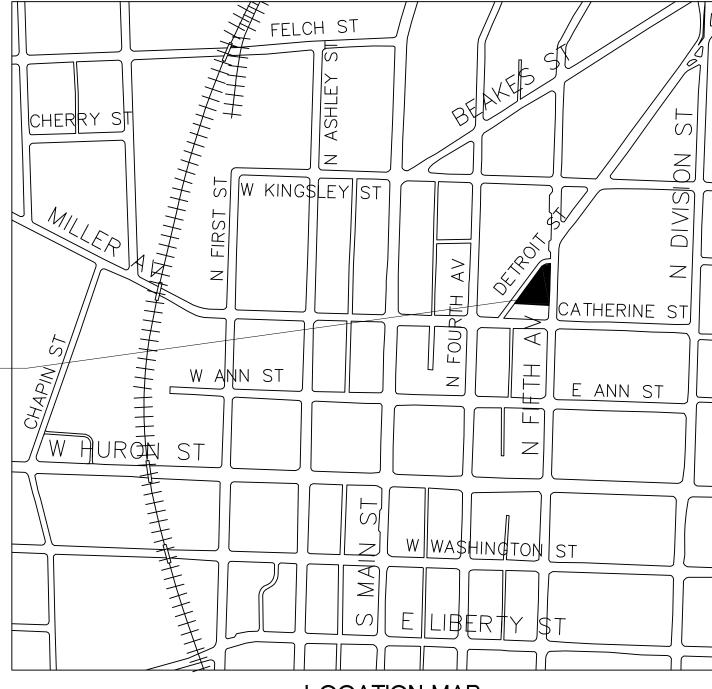

LOCATION MAP N.T.S.

LEGAL DESCRIPTION

THE LAND SITUATED IN THE CITY OF ANN ARBOR, COUNTY OF WASHTENAW, STATE OF MICHIGAN, IS DESCRIBED AS FOLLOWS:

PARCEL 1

PROJECT

SITE

LOT 79, ASSESSOR'S PLAT NO. 29, ACCORDING TO THE PLAT THEREOF, AS RECORDED IN LIBER 9 OF PLATS, PAGE 20, WASHTENAW COUNTY

PARCEL 2

LOT 80. ASSESSOR'S PLAT NO. 29, ACCORDING TO THE PLAT THEREOF, AS RECORDED IN LIBER 9 OF PLATS, PAGE 20, WASHTENAW COUNTY

PARCEL 3

LOT 81, ASSESSOR'S PLAT NO. 29, ACCORDING TO THE PLAT THEREOF, AS RECORDED IN LIBER 9 OF PLATS, PAGE 20, WASHTENAW COUNTY RECORDS.

COMBINED PARCEL


LOTS 79, 80, AND 81, ASSESSOR'S PLAT NO. 29, ACCORDING TO THE PLAT THEREOF. AS RECORDED IN LIBER 9 OF PLATS, PAGE 20, WASHTENAW COUNTY RECORDS.

0

Know what's below.
Call before you dig.

 \Im Box

SITE PLAN COVER 330 ANN

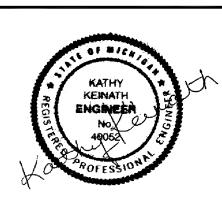

3-22-22

2-1-22

11-24-21

N.T.S.

SP-01

SCALE

SHEET NO.

SHEET INDEX

SP-01	COVER	A1.0	BASEMENT LEVEL
SP-02	ALTA SURVEY	A1.1	STREET LEVEL
SP-03	DEMOLITION PLAN	A1.2	FLOOR LEVEL 2
SP-04	LAYOUT PLAN	A1.3	FLOOR LEVEL 3
SP-05	NATURAL FEATURES	A1.4	FLOOR LEVEL 4
SP-06	LANDSCAPE	A1.5	FLOOR LEVEL 5
SP-07	UTILITIES PLAN	A1.6	ROOF
SP-08	STORM WATER MANAGEMENT, GRADING	A1.7	PERSPECTIVES
	AND SOIL EROSION CONTROL PLAN	A1.8	ELEVATIONS
SP-09	SOLID WASTE MANAGEMENT PLAN	A1.9	ELEVATIONS
SP-10	SITE DETAILS	A1.10	SECTION

A1.11 ZONING DIAGRAMS

PRELIMINARY NOT FOR CONSTRUCTION

PHOTOMETRIC PLAN

(NOT TO SCALE)

PARKING

HANDICAP PARKING = 0 STALLS STANDARD PARKING = 15 STALLS

PARCEL AREA

PARCEL 1 3,498± SQUARE FEET = 0.080± ACRES PARCEL 2 4,044± SQUARE FEET = 0.092± ACRES

PARCEL 3 $2,337\pm$ SQUARE FEET = $0.054\pm$ ACRES COMBINED PARCEL 9,879± SQUARE FEET = 0.226± ACRES

BASIS OF BEARING

NORTH 85°55'00" WEST, BEING THE CENTERLINE OF CATHERINE STREET, AS PLATTED.

BENCHMARK

SITE BENCHMARK #1
ARROW ON FIRE HYDRANT AT SE CORNER OF #314, ±100' N. OF CATHERINE, ±20' W. OF & OF FIFTH AVE. ELEVATION = 834.07' (NAVD 88)

SITE BENCHMARK #2 CHISELED SQUARE ON TOP OF EAST SIDE OF CONC. LIGHT POLE BASE, ±125' N. OF CATHERINE ST, ±20' E. OF FIFTH AVE. ELEVATION = 831.26' (NAVD 88)

SITE BENCHMARK #3 CHISELED SQUARE ON TOP OF EAST SIDE OF CONC. LIGHT POLE BASE, ±225' N. OF CATHERINE ST, ±15' W. OF Q OF DETROIT ST. ELEVATION = 829.33' (NAVD 88)

LECEND

LEGEND	
•	FOUND PIPE IN MONUMENT BOX
(R&M)	RECORD AND MEASURED DIMENSION
(R)	RECORD DIMENSION
(M)	MEASURED DIMENSION
0.00	GROUND ELEVATION
	ELECTRIC METER
0	UTILITY POLE
Ø	GAS METER
GV ⋈	GAS VALVE
₩	LIGHT POLE WITH STREET LAMP
	CABLE TV BOX
	TRAFFIC SIGNAL
X	
8	CLEANOUT
<u>\$</u>	SANITARY MANHOLE
=	SQUARE CATCH BASIN
(D)	STORM DRAIN MANHOLE
Ä	FIRE HYDRANT
*	FIRE DEPARTMENT CONNECTION
(W) W/	WATER GATE MANHOLE
\bowtie	WATER VALVE
•	BOLLARD
\$	LIGHTPOST/LAMP POST
3	PARKING METER
- 	SINGLE POST SIGN
	DECIDUOUS TREE (AS NOTED)
*	CONIFEROUS TREE (AS NOTED)
	PARCEL BOUNDARY LINE
	PLATTED LOT LINE
	SECTION LINE
-	BUILDING
	BUILDING OVERHANG
	CONCRETE CURB
	RAISED CONCRETE
	PARKING
	EDGE OF CONCRETE (CONC.)
	EDGE OF BRICK
X	(
	WALL (AS NOTED)
	OVERHEAD UTILITY LINE
G	
s	
D	STORM LINE
w	
c	CONDUIT
	MINOR CONTOUR LINE
	MAJOR CONTOUR LINE
	BUILDING AREA
	ASPHALT
44.	

TITLE REPORT NOTE


A CURRENT TITLE POLICY HAS NOT BEEN FURNISHED AT TIME OF SURVEY, THEREFORE EASEMENTS AND/OR ENCUMBRANCES AFFECTING SUBJECT PARCEL MAY NOT BE SHOWN.

SURVEYOR'S NOTE

THE UNDERGROUND UTILITIES SHOWN HAVE BEEN LOCATED FROM FIELD SURVEY INFORMATION AND EXISTING DRAWINGS. THE SURVEYOR MAKES NO GUARANTEES THAT THE UNDERGROUND UTILITIES SHOWN COMPRISE ALL SUCH UTILITIES IN THE AREA, EITHER IN SERVICE OR ABANDONED. THE SURVEYOR FURTHER DOES NOT WARRANT THAT THE UNDERGROUND UTILITIES SHOWN ARE IN THE EXACT LOCATION INDICATED ALTHOUGH HE DOES CERTIFY THAT THEY ARE LOCATED AS ACCURATELY AS POSSIBLE FROM INFORMATION AVAILABLE. THE SURVEYOR HAS NOT PHYSICALLY LOCATED THE UNDERGROUND UTILITIES OTHER THAN THE STRUCTURE INVENTORY SHOWN HEREON.

POSSIBLE ENCROACHMENTS

- A RETAINING WALL CROSSES WEST PROPERTY LINE ±3.1'. B - RETAINING WALL CROSSES WEST PROPERTY LINE ± 3.3 '.
- C BUILDING CROSSES WEST PROPERTY LINE ±0.2'. D - WALL CROSSES WEST PROPERTY LINE ±0.9'.

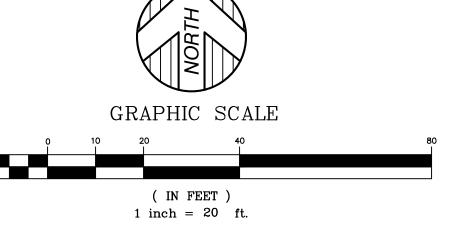

PROPERTY DESCRIPTION

FOUND PIPE IN MON. BOX

ADA RAMP

BENCHMARK #2

ELECTRIC

PLANTER

CONCRETE ZONE: D-2 LOT 80

BUILDING

±2,763 SQ. FT. PARCEL 1

PARCEL ID:

O9-09-29-124-003

COCATE EXACT OWNER OF RECORD:

LOCATION OF TALESCORD:

LOCATION OF TALESCORD:

ONLY ON THE COLUMN STATES TO THE

54.42'(R&M)

N'LY R.O.W. LINE OF CATHERINE ST

COMMERCIAL

PIPE IN MON. BOX

#303 1 STORY

COMMERCIAL BUILDING ±2,763 SQ. FT.

LOT 78

#300 1 STORY

COMMERCIAL BUILDING

234.95'(R) 235.01'(M)

N85*55*00"W(R&M) ⊕ STM. MH

PARCEL ID: 09-09-29-124-004 OWNER OF RECORD:

WRE300, LLC

138.84'(R) 138.88'(M)

CATHERINE STREET 33' 1/2 PUBLIC RIGHT OF WAY ASPHALT

09-09/29-124-002 OWNER OF RECORD;

THE LAND SITUATED IN THE CITY OF ANN ARBOR, COUNTY OF WASHTENAW, STATE OF MICHIGAN, IS DESCRIBED AS FOLLOWS:

LOT 79, ASSESSOR'S PLAT NO. 29, ACCORDING TO THE PLAT THEREOF, AS RECORDED IN LIBER 9 OF PLATS, PAGE 20, WASHTENAW COUNTY RECORDS.

LOT 80, ASSESSOR'S PLAT NO. 29, ACCORDING TO THE PLAT THEREOF, AS RECORDED IN LIBER 9 OF PLATS, PAGE 20, WASHTENAW COUNTY RECORDS.

LOT 81, ASSESSOR'S PLAT NO. 29, ACCORDING TO THE PLAT THEREOF, AS RECORDED IN LIBER 9 OF PLATS, PAGE 20, WASHTENAW COUNTY RECORDS. COMBINED PARCEL

LOTS 79, 80, AND 81, ASSESSOR'S PLAT NO. 29, ACCORDING TO THE PLAT THEREOF, AS RECORDED IN LIBER 9 OF PLATS, PAGE 20, WASHTENAW COUNTY

MANHOLE SCHEDULE

		HOLE SCHE			
<u>#</u>	<u>TYPE</u>	<u>RIM</u>	SIZE	<u>DIRECTION</u>	<u>INVERT</u>
40005	CATCH BASIN	828.62	8	N	825.24
		828.62	12	S	824.07
		B/	STRUCTU	RE	822.32
40051	CATCH BASIN	828.14	12	N	823.73
		828.14	8	S	824.44
		828.14	12	W	823.94
		B/	STRUCTUI	RE	822.94
40076	CATCH BASIN	829.82	12	N	825.37
		B/	STRUCTUI	RE	826.42
40175	CATCH BASIN	827.84	12	NE	824.69
		827.84	12	Е	824.70
		827.84	6	S	825.17
		827.84	12	W	824.75
			STRUCTUI	RE	821.94
40332	SANITARY MANHOLE	827.98	8	N	818.76
		827.98	8	S	818.86
		827.98	4	E	819.54
40341	SANITARY MANHOLE	833.56	4	W	827.41
40541	SAMITANT WANTOLL	033.30	8	N	825.06
40490	CATCH BASIN	828.58	12	W	824.59
40430	CATCH DASIN	833.56	4	W	825.09
			STRUCTUI		823.68
40576	CATCH BASIN	828.11	12	E	824.14
40370	CATCH BASIN	828.11	12	SW	824.18
			STRUCTUI		822.11
90126	SANITARY MANHOLE	830.26	8 8	N	822.21
90120	JANITANT WANHOLL	830.26		N	826.26
			6 8		
00133	CATCULDACIN	830.26		SE	822.51
90133	CATCH BASIN	828.12	12	E	824.80
00450	CANUTA BY A 44 NU I O I E	828.12	6	W	824.75
90152	SANITARY MANHOLE	828.16	8	\$	821.16
		828.16	8	N	821.06
90486	STORM MANHOLE	831.71	15	W	826.11
		831.71	15	E	826.21
		831.71	12	NE	826.14
		831.71	12	SE	826.15
		831.71	8	S	826.30
90515	SANITARY MANHOLE	832.18	8	Е	820.83
		832.18	10	S	820.78
		832.18	8	W	821.36
90516	STORM MANHOLE	832.10	15	W	826.55
		832.10	15	Е	826.65
		832.10	12	S	827.05
90520	STORM MANHOLE	833.14	15	W	827.14

SURVEYOR'S CERTIFICATION

TO MAVD:


THIS IS TO CERTIFY THAT THIS MAP OR PLAT AND THE SURVEY ON WHICH IT IS BASED WERE MADE IN ACCORDANCE WITH THE 2021 MINIMUM STANDARD DETAIL REQUIREMENTS FOR ALTA/NSPS LAND TITLE SURVEYS, JOINTLY ESTABLISHED AND ADOPTED BY ALTA AND NSPS, AND INCLUDES ITEMS 1, 2, 4, 5, 7A, 8, 9, 11A, AND 11B OF TABLE A, THEREOF. THE FIELD WORK WAS COMPLETED ON 06/29/21.

DATE OF PLAT OR MAP: 07/09/21


ANTHONY T. SYCKO, JR., P.S. PROFESSIONAL SURVEYOR MICHIGAN LICENSE NO. 47976 22556 GRATIOT AVE., EASTPOINTE, MI 48021 TSycko@kemtec-survey.com


SUI

10/01/01				
0//12/21				
07/12/21				
	2	00/ 20/ 10	I GM	STINEMINOU WINTER DECINE WORKENIES
	ר		2	NEVISED TEN NEVIEW COMMENTS
21	2	09/21/21	MRJ	ADD TREE TAG NUMBERS
SCALE:	1	09/08/21	MRJ	REVISED PER REVIEW COMMENTS
1" = 20'	REVISION DATE	DATE	ВҮ	DESCRIPTION

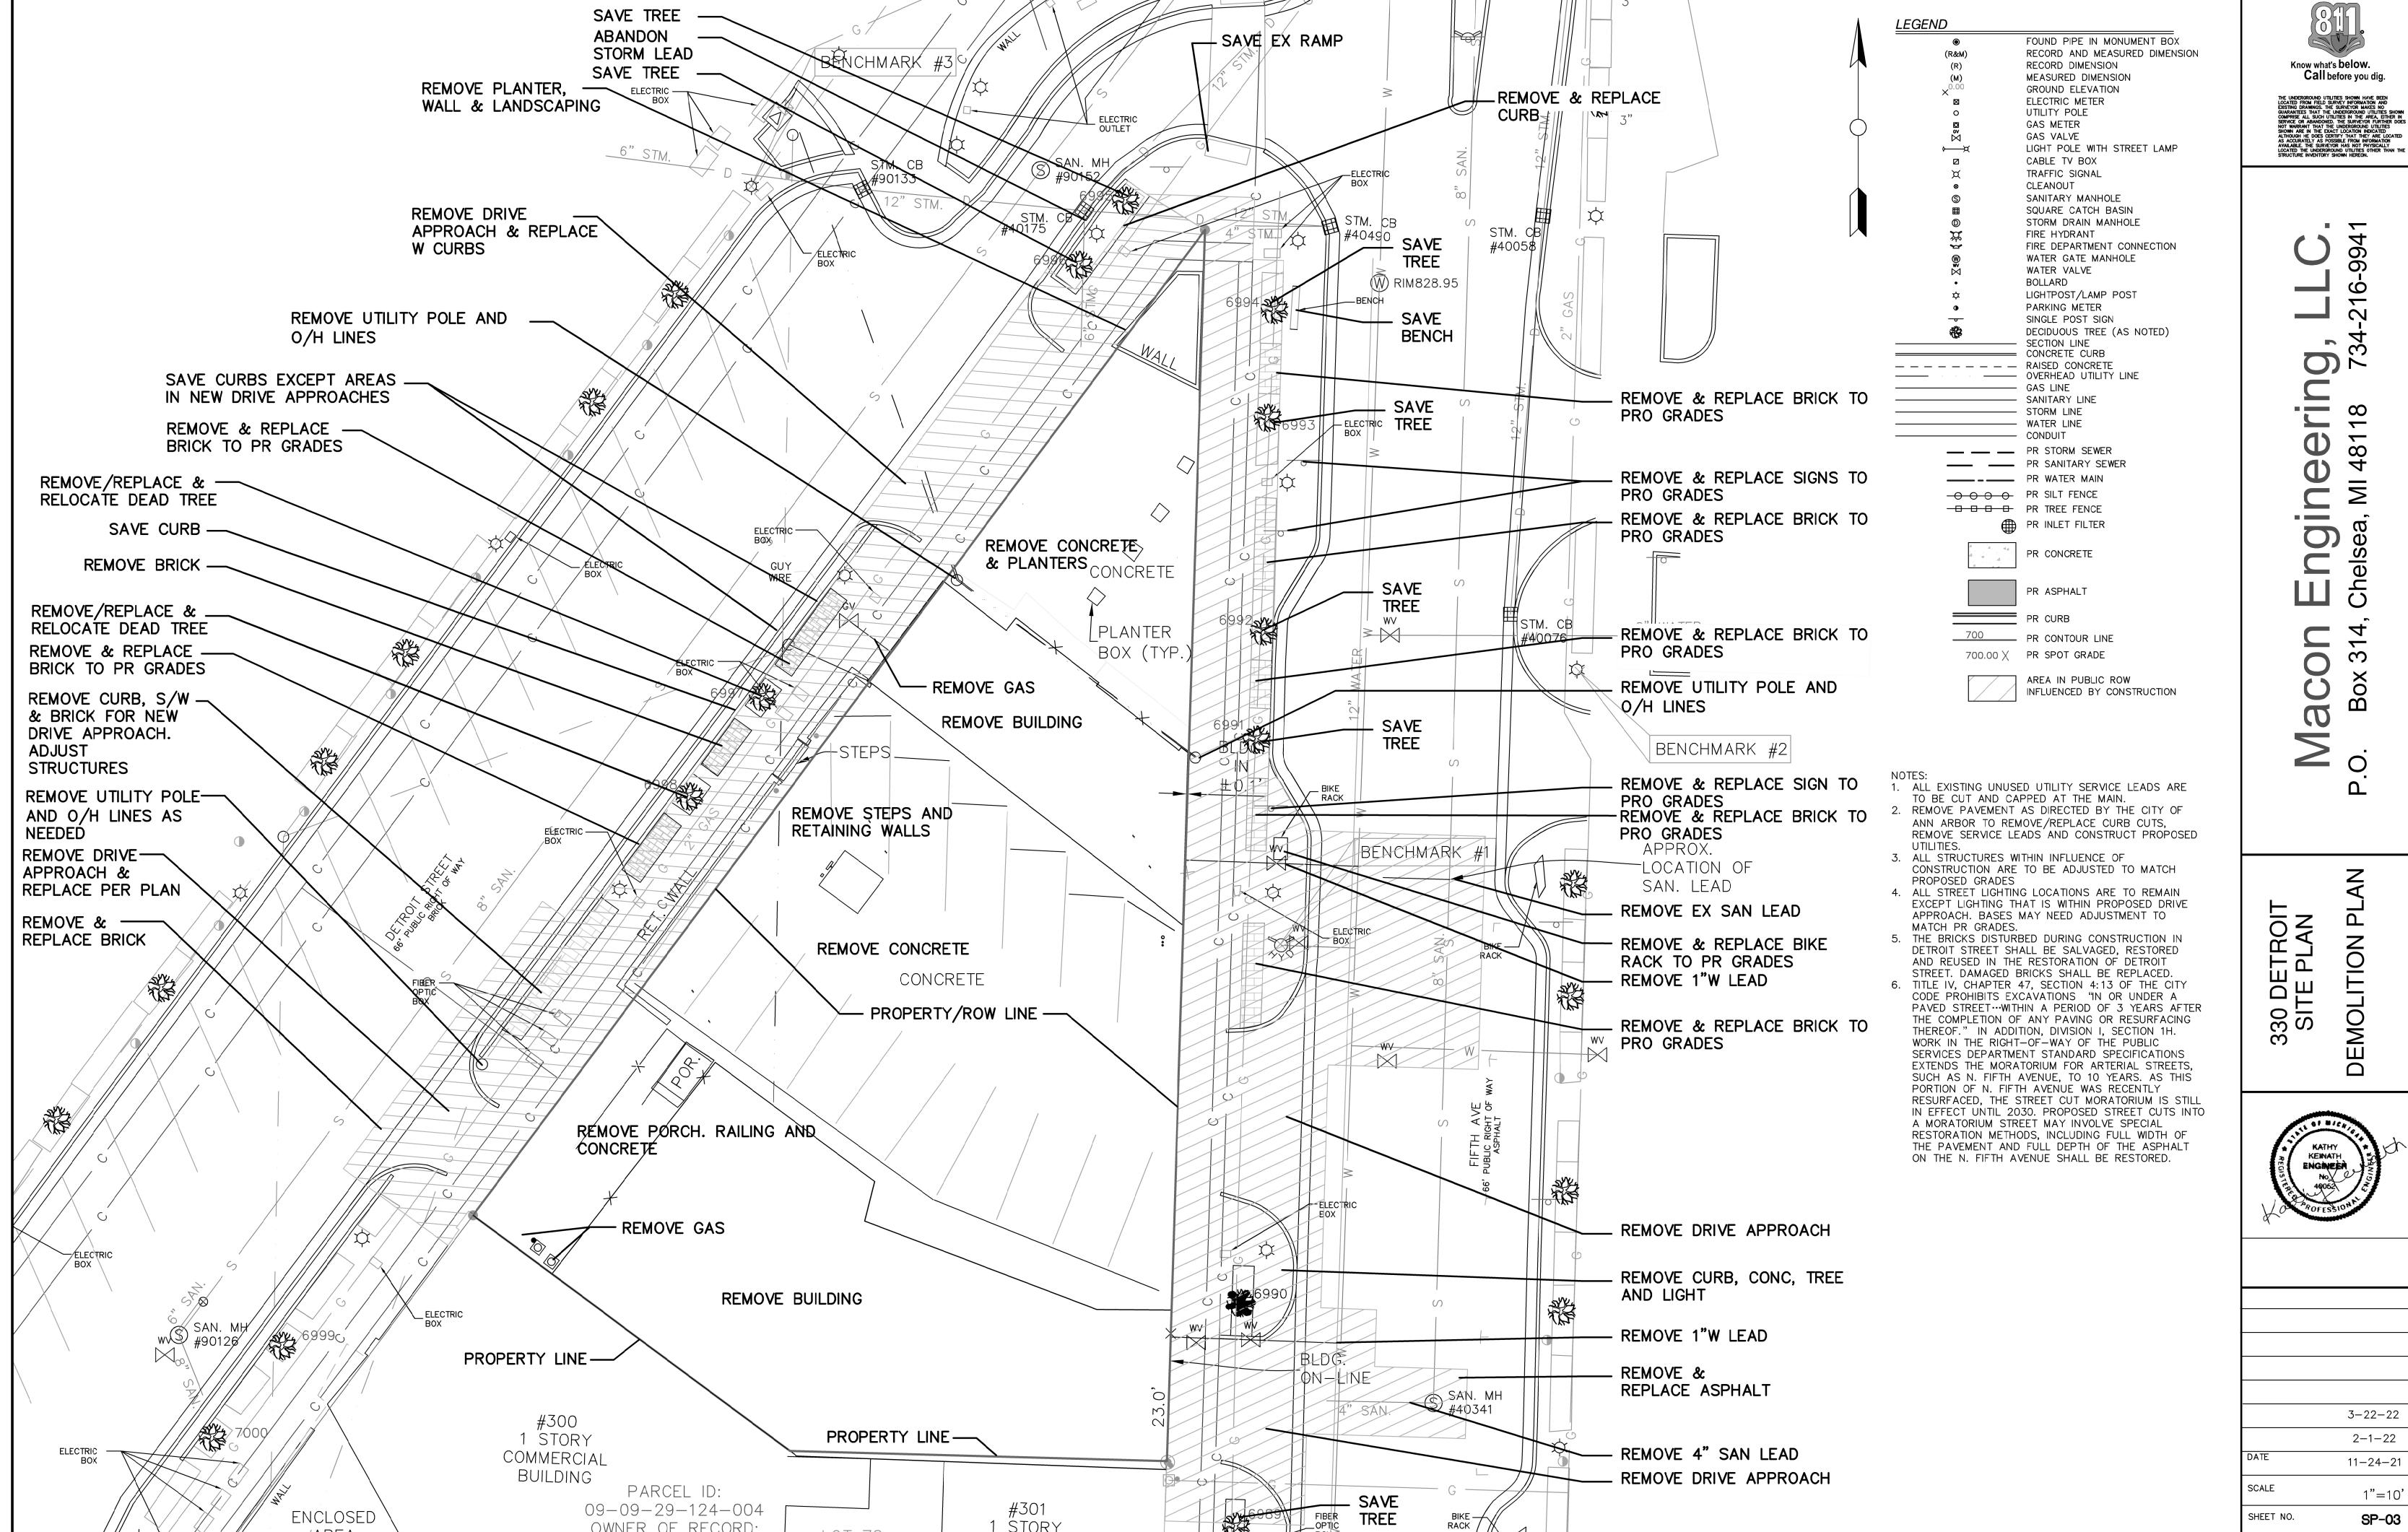



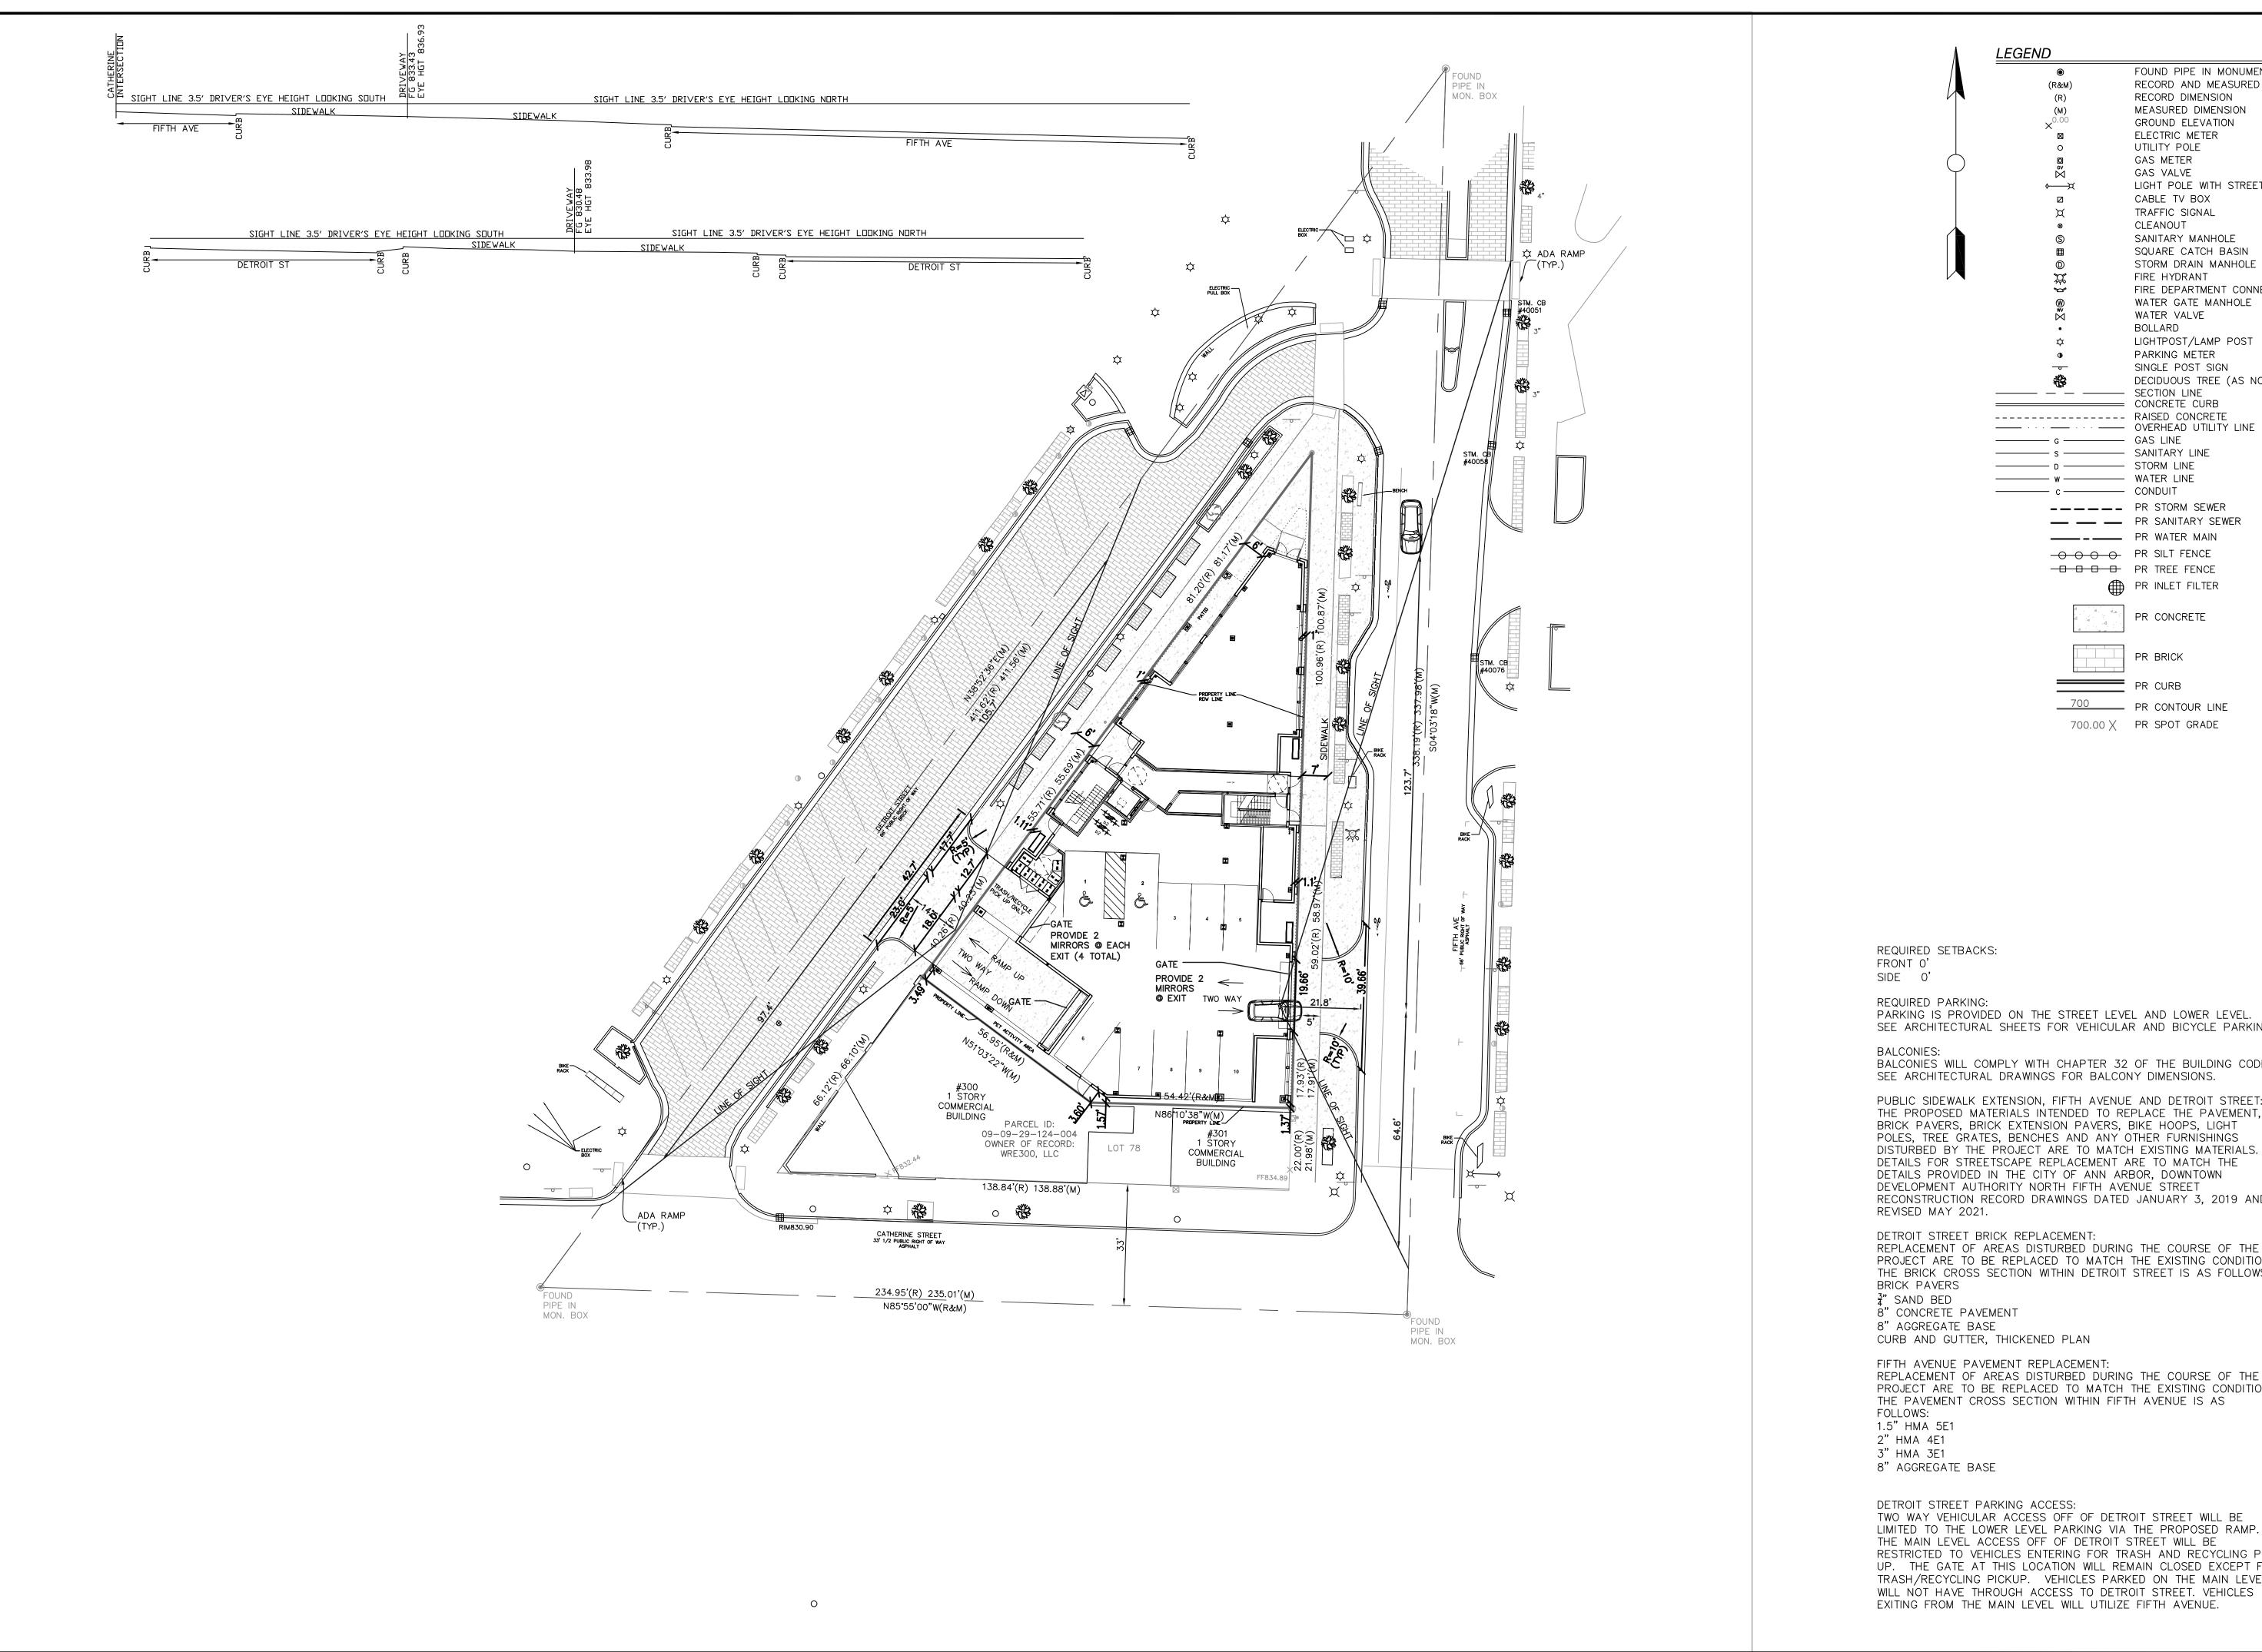

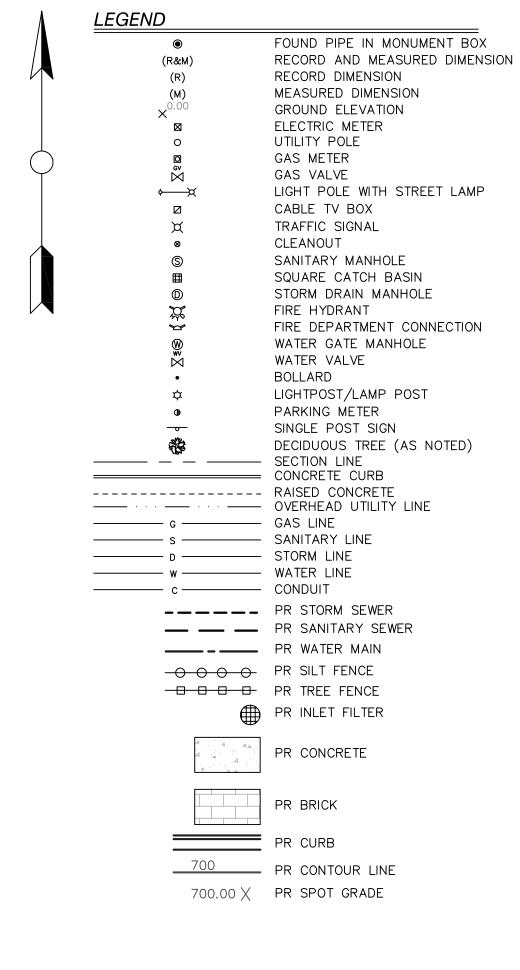

REQUIRED SETBACKS: FRONT O'

REQUIRED PARKING:

PARKING IS PROVIDED ON THE STREET LEVEL AND LOWER LEVEL. SEE ARCHITECTURAL SHEETS FOR VEHICULAR AND BICYCLE PARKING.

BALCONIES WILL COMPLY WITH CHAPTER 32 OF THE BUILDING CODE. SEE ARCHITECTURAL DRAWINGS FOR BALCONY DIMENSIONS.

PUBLIC SIDEWALK EXTENSION, FIFTH AVENUE AND DETROIT STREET: THE PROPOSED MATERIALS INTENDED TO REPLACE THE PAVEMENT. BRICK PAVERS, BRICK EXTENSION PAVERS, BIKE HOOPS, LIGHT POLES, TREE GRATES, BENCHES AND ANY OTHER FURNISHINGS DISTURBED BY THE PROJECT ARE TO MATCH EXISTING MATERIALS. DETAILS FOR STREETSCAPE REPLACEMENT ARE TO MATCH THE DETAILS PROVIDED IN THE CITY OF ANN ARBOR, DOWNTOWN DEVELOPMENT AUTHORITY NORTH FIFTH AVENUE STREET RECONSTRUCTION RECORD DRAWINGS DATED JANUARY 3, 2019 AND

DETROIT STREET BRICK REPLACEMENT:

REPLACEMENT OF AREAS DISTURBED DURING THE COURSE OF THE PROJECT ARE TO BE REPLACED TO MATCH THE EXISTING CONDITIONS. THE BRICK CROSS SECTION WITHIN DETROIT STREET IS AS FOLLOWS: BRICK PAVERS

3" SAND BED 8" CONCRETE PAVEMENT

CURB AND GUTTER, THICKENED PLAN

FIFTH AVENUE PAVEMENT REPLACEMENT: REPLACEMENT OF AREAS DISTURBED DURING THE COURSE OF THE PROJECT ARE TO BE REPLACED TO MATCH THE EXISTING CONDITIONS. THE PAVEMENT CROSS SECTION WITHIN FIFTH AVENUE IS AS

FOLLOWS: 1.5" HMA 5E1 2" HMA 4E1


3" HMA 3E1 8" AGGREGATE BASE

DETROIT STREET PARKING ACCESS: TWO WAY VEHICULAR ACCESS OFF OF DETROIT STREET WILL BE LIMITED TO THE LOWER LEVEL PARKING VIA THE PROPOSED RAMP. THE MAIN LEVEL ACCESS OFF OF DETROIT STREET WILL BE RESTRICTED TO VEHICLES ENTERING FOR TRASH AND RECYCLING PICK UP. THE GATE AT THIS LOCATION WILL REMAIN CLOSED EXCEPT FOR TRASH/RECYCLING PICKUP. VEHICLES PARKED ON THE MAIN LEVEL

Know what's below.

Call before you dig.


TROIT/N SITE PL/

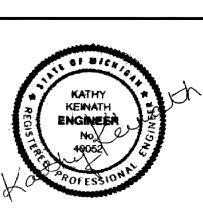



3-22-22 2-1-22 11-24-21 SCALE 1"=20'

SP-04

SHEET NO.

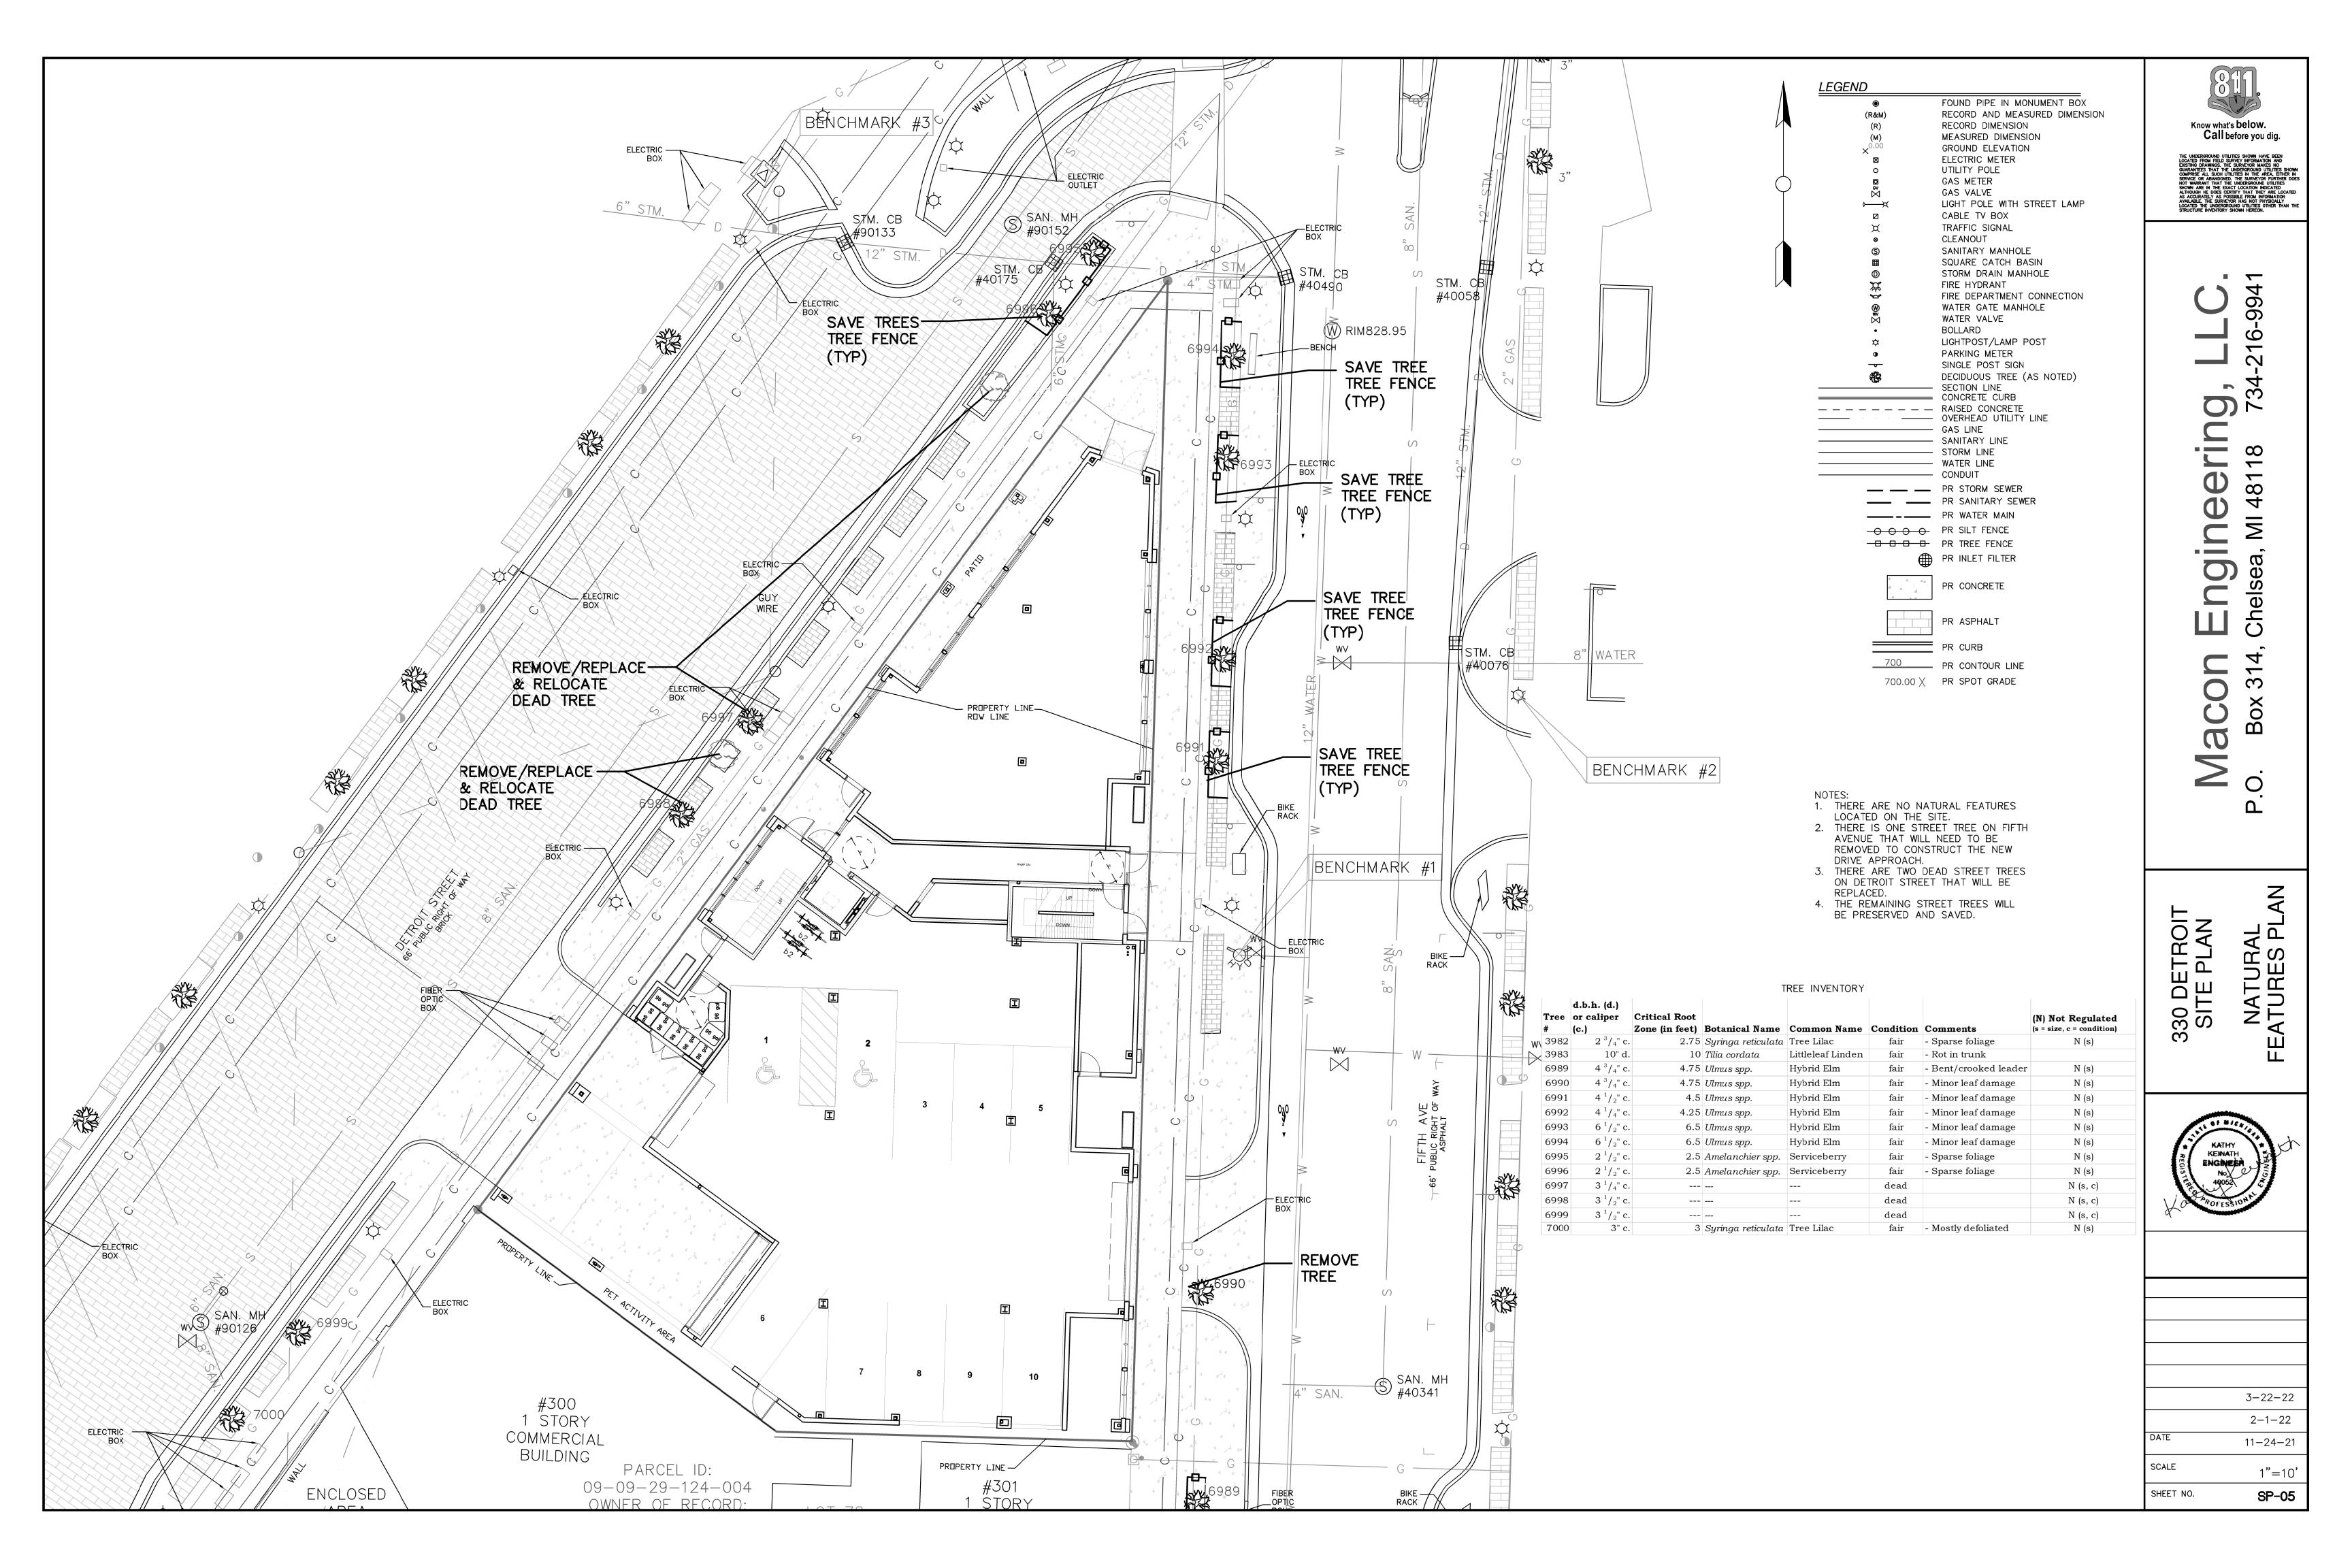

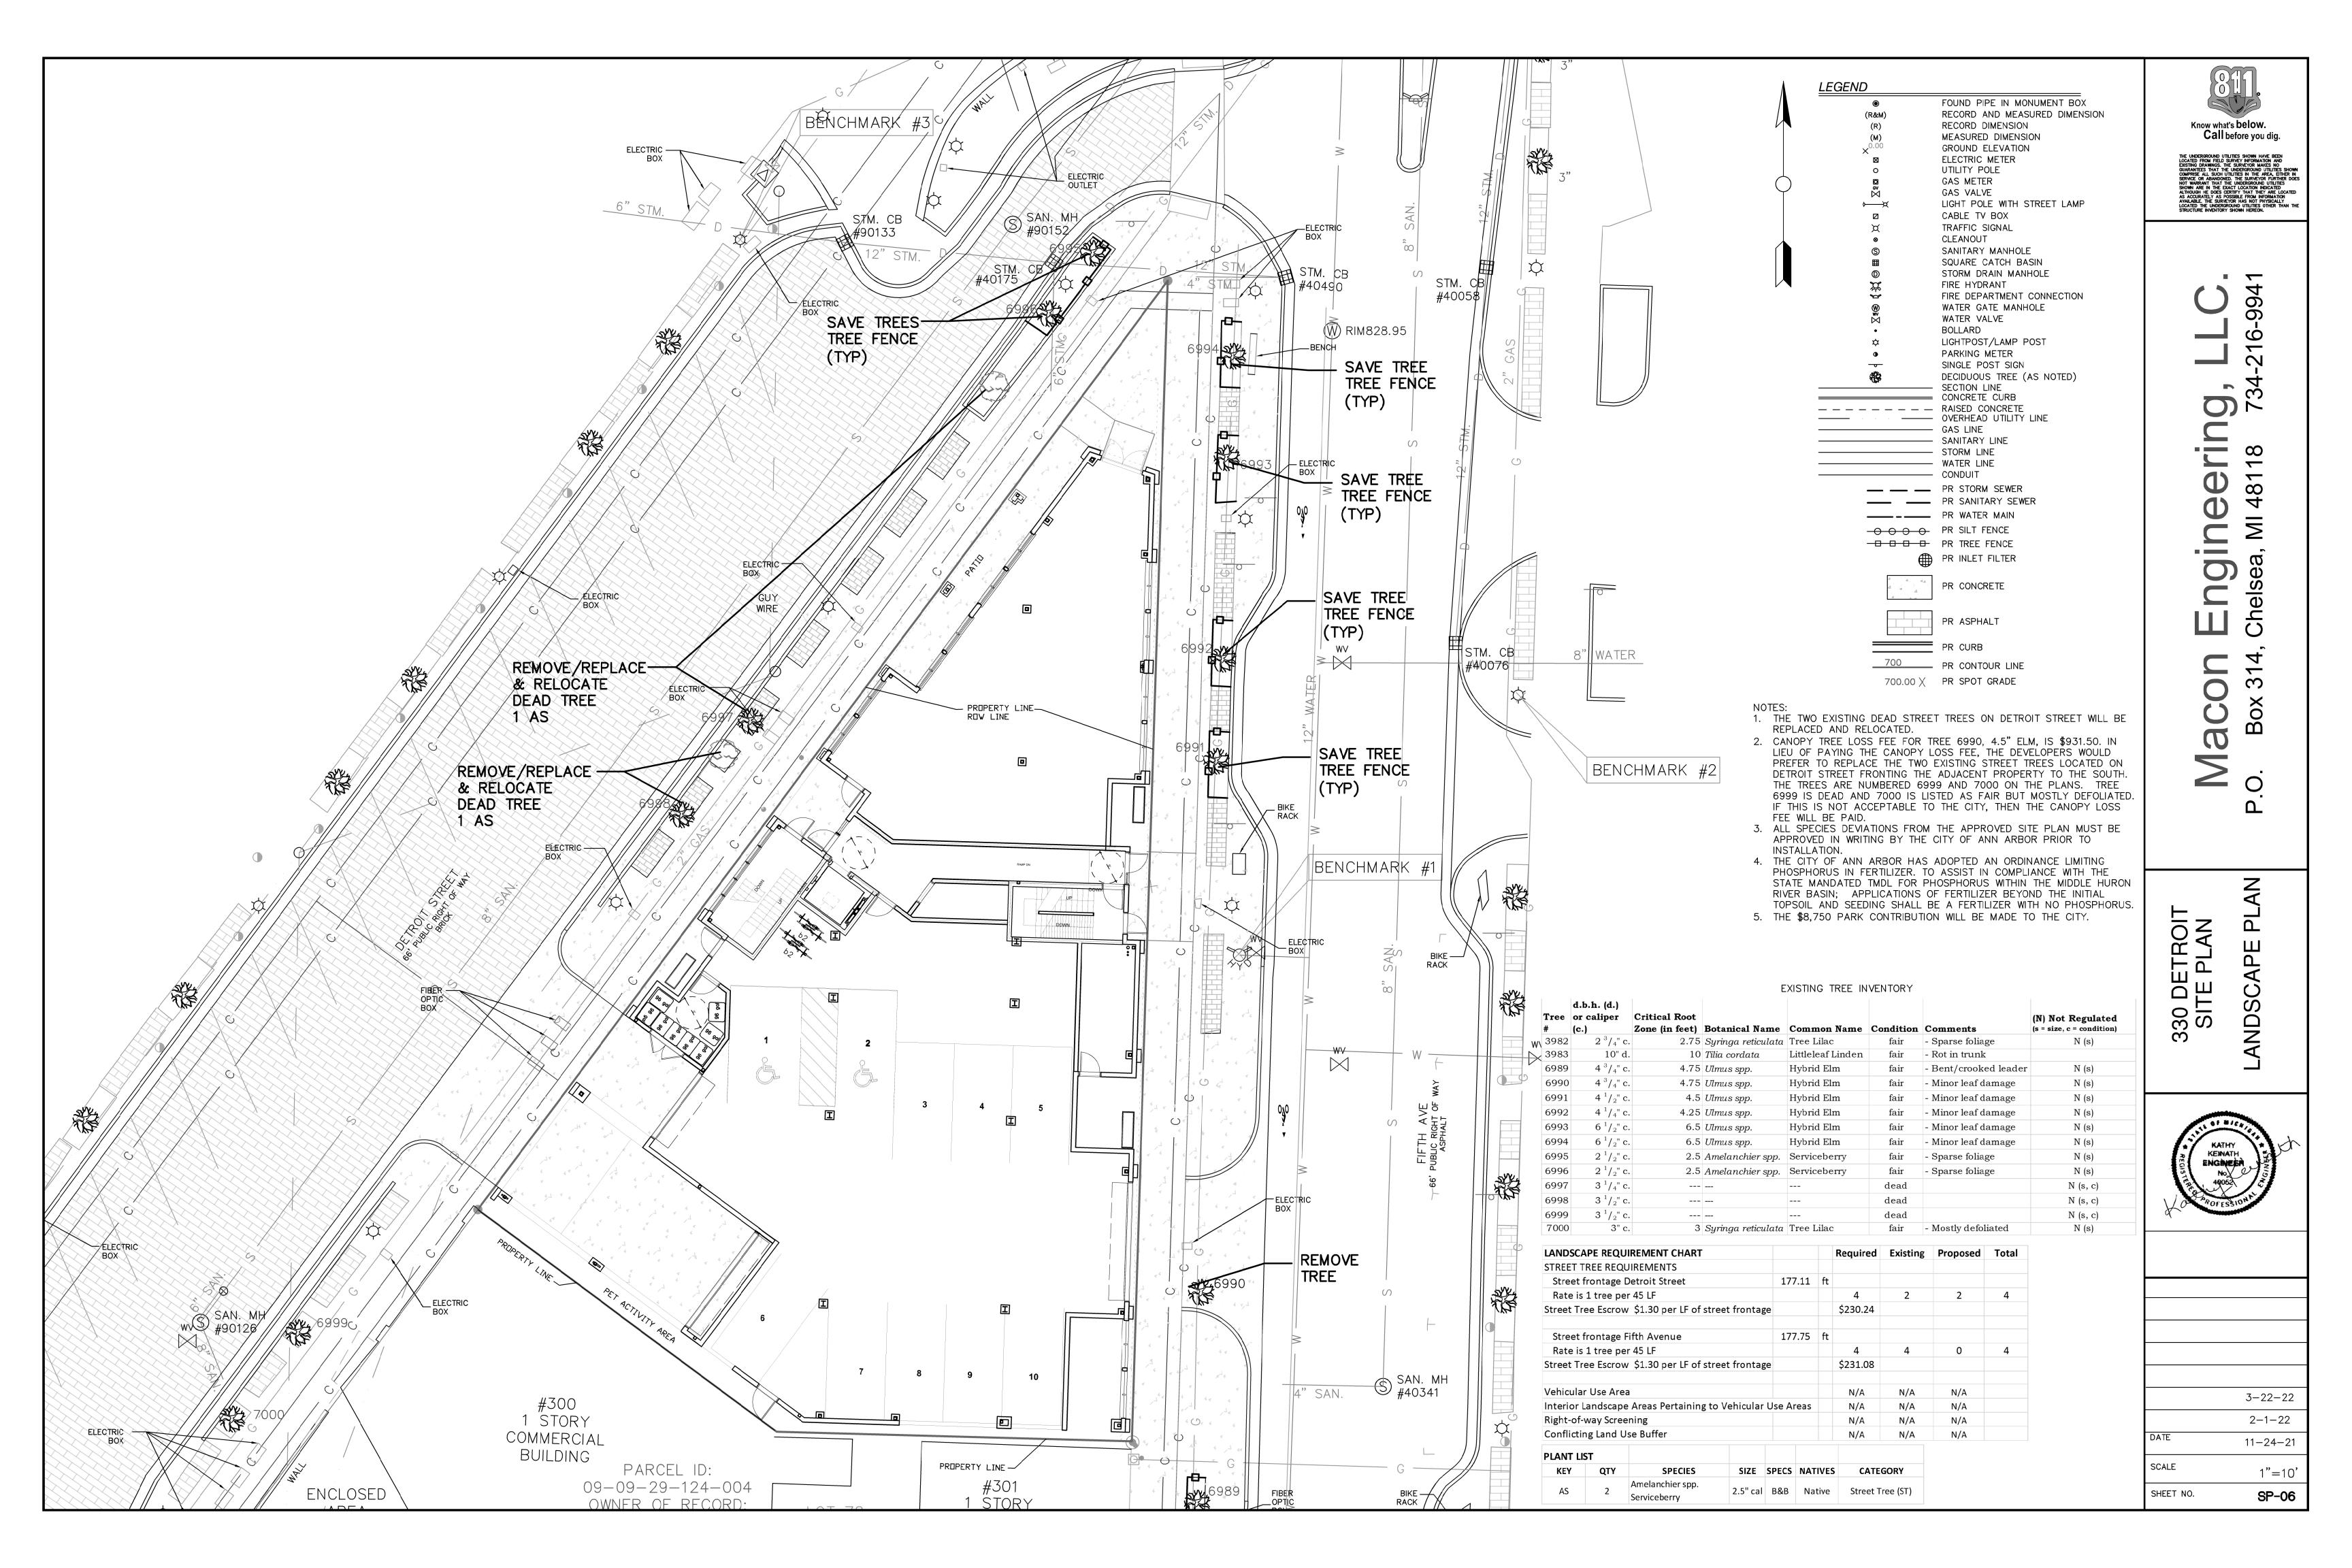

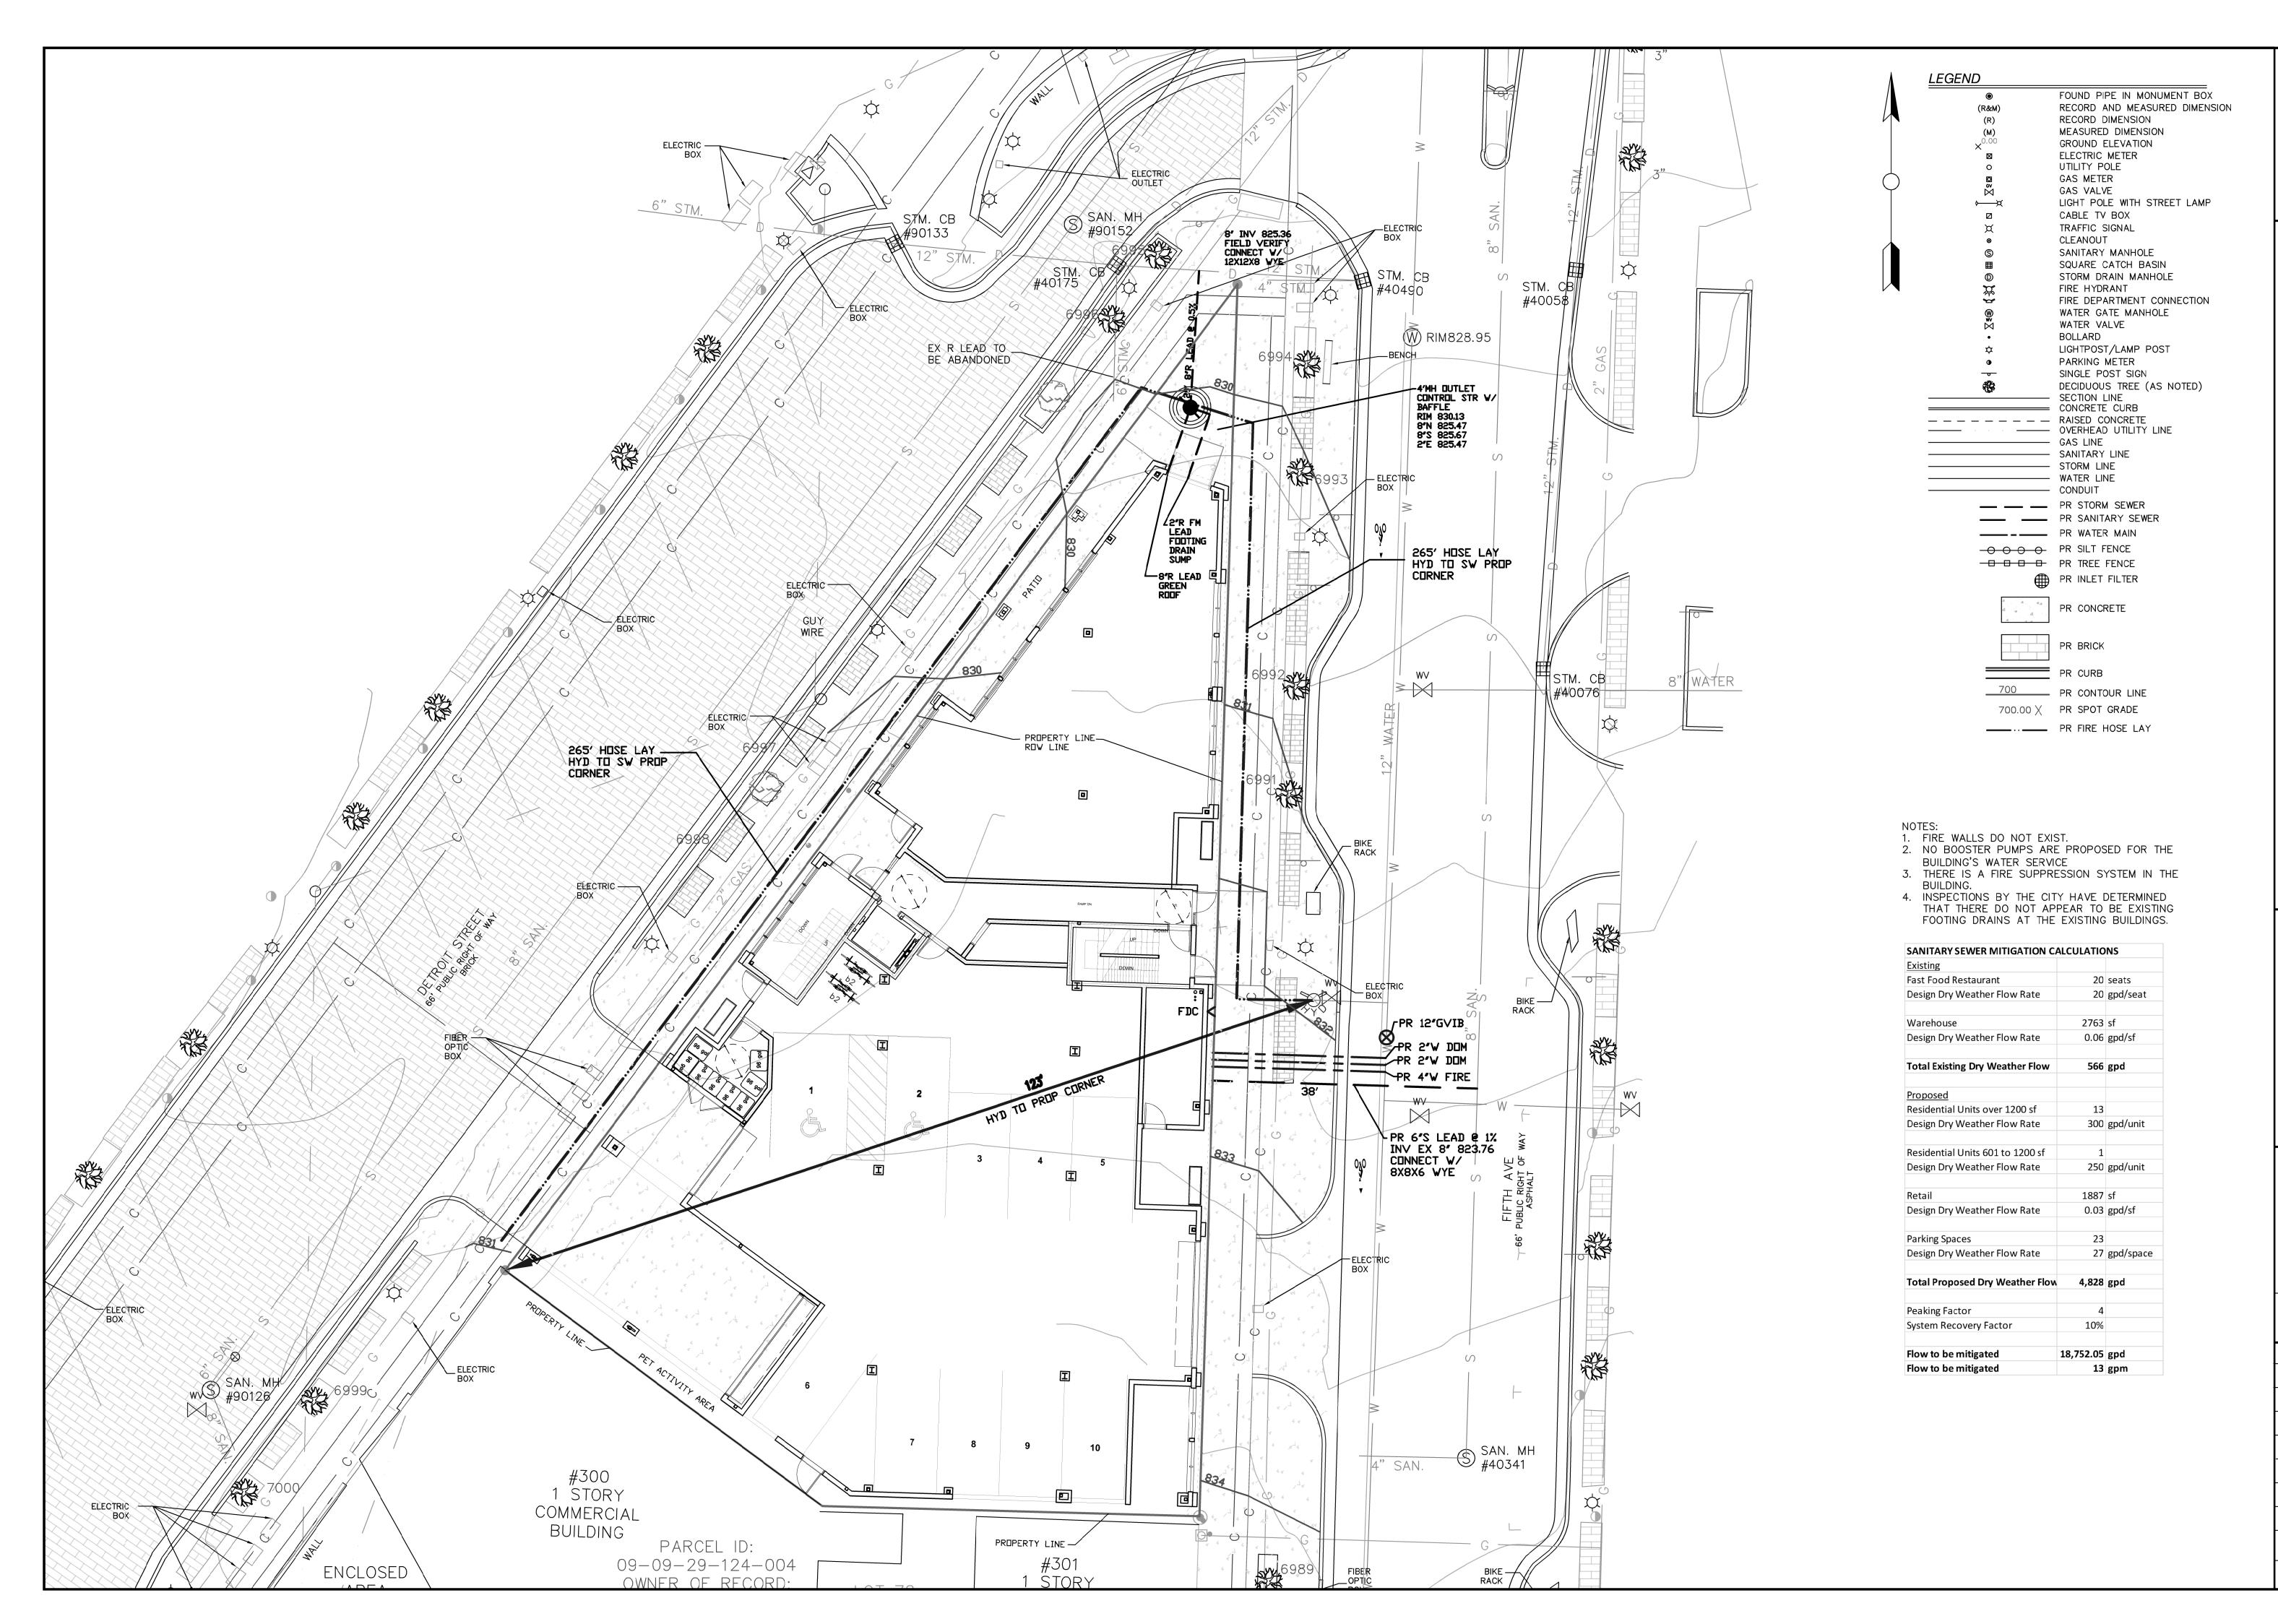


on Engineering, LLC.

314, Chelsea, MI 48118 734-216-9941


Know what's below.

Call before you dig.

330 DETROIT SITE PLAN

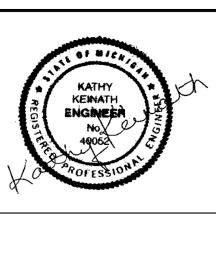

3-22-22
2-1-22
DATE 11-24-21
SCALE 1"=10'
SHEET NO. SP-07

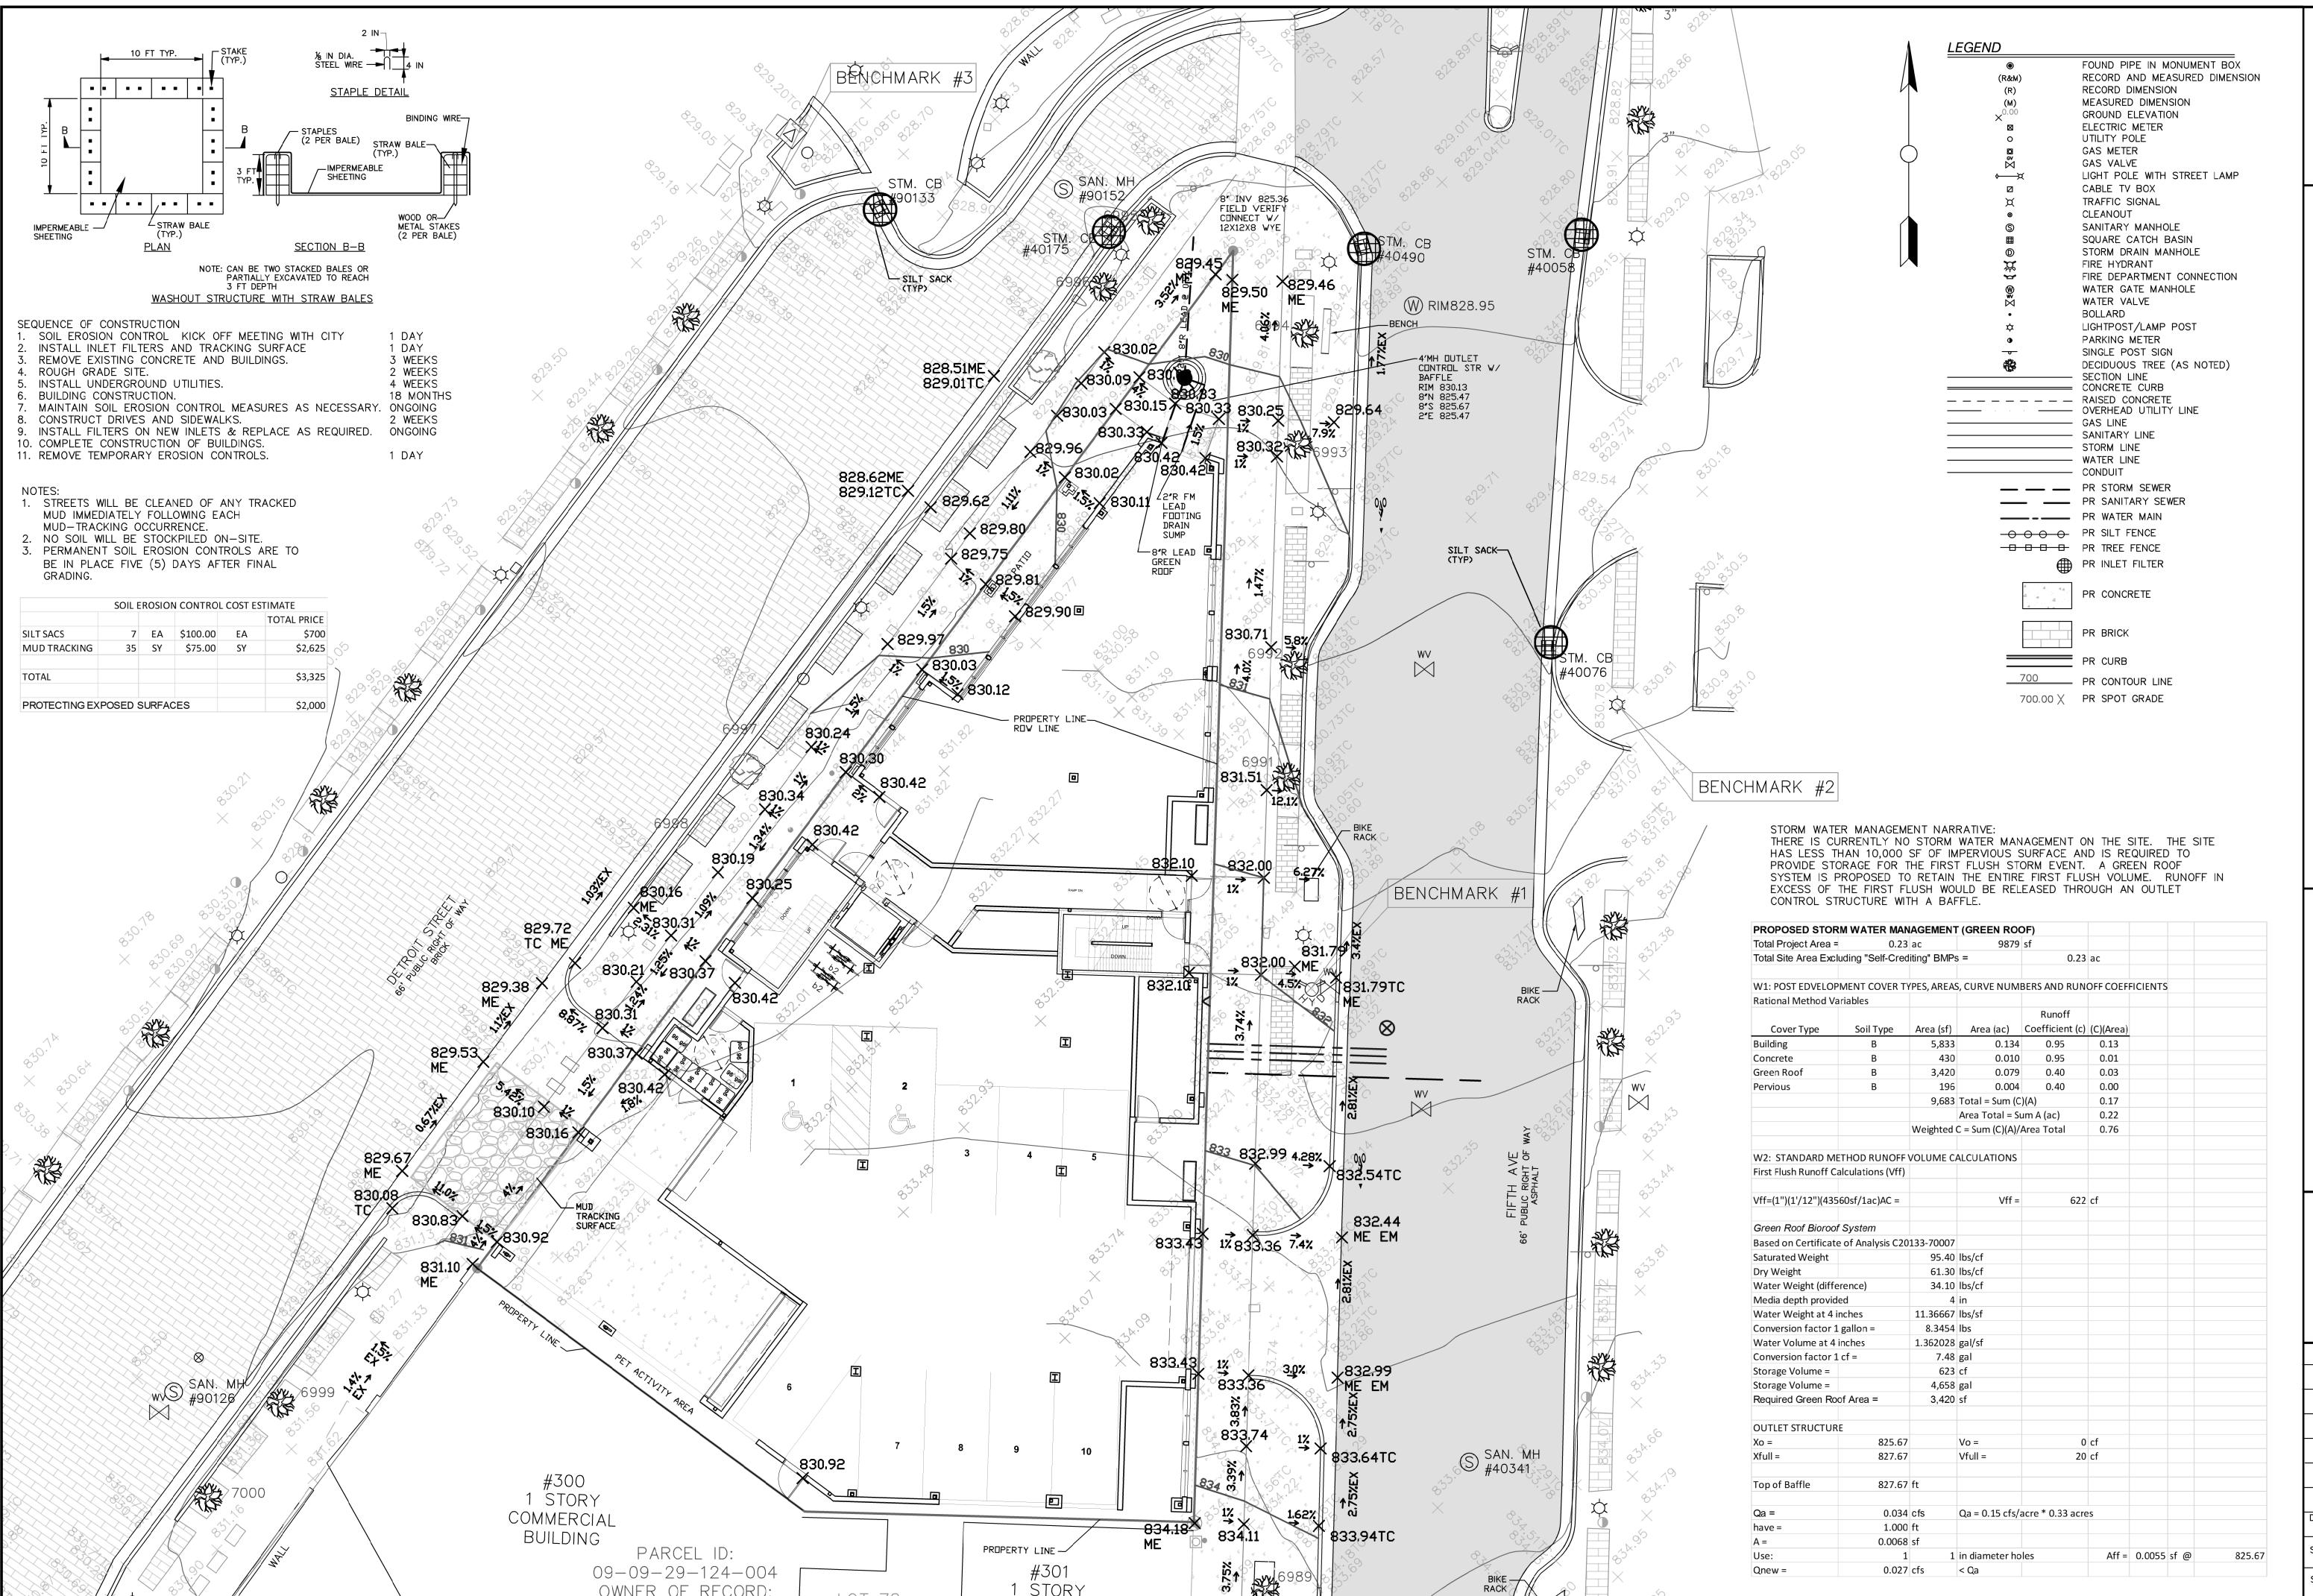

acon Engineering, LLC.

Box 314, Chelsea, MI 48118 734-216-9941

Know what's **below**.


Call before you dig.

SITE PLAN
SITE PLAN
STORM WATER
MANAGEMENT, GRADING
AND SOIL EROSION
CONTROL


KATHY KEINATH ENGINEEN No. 40062

3-22-22
2-1-22
DATE 11-24-21
SCALE 1"=10'
SHEET NO. SP-08

330 DETROIT STREET SITE LAYOUT 1"=20

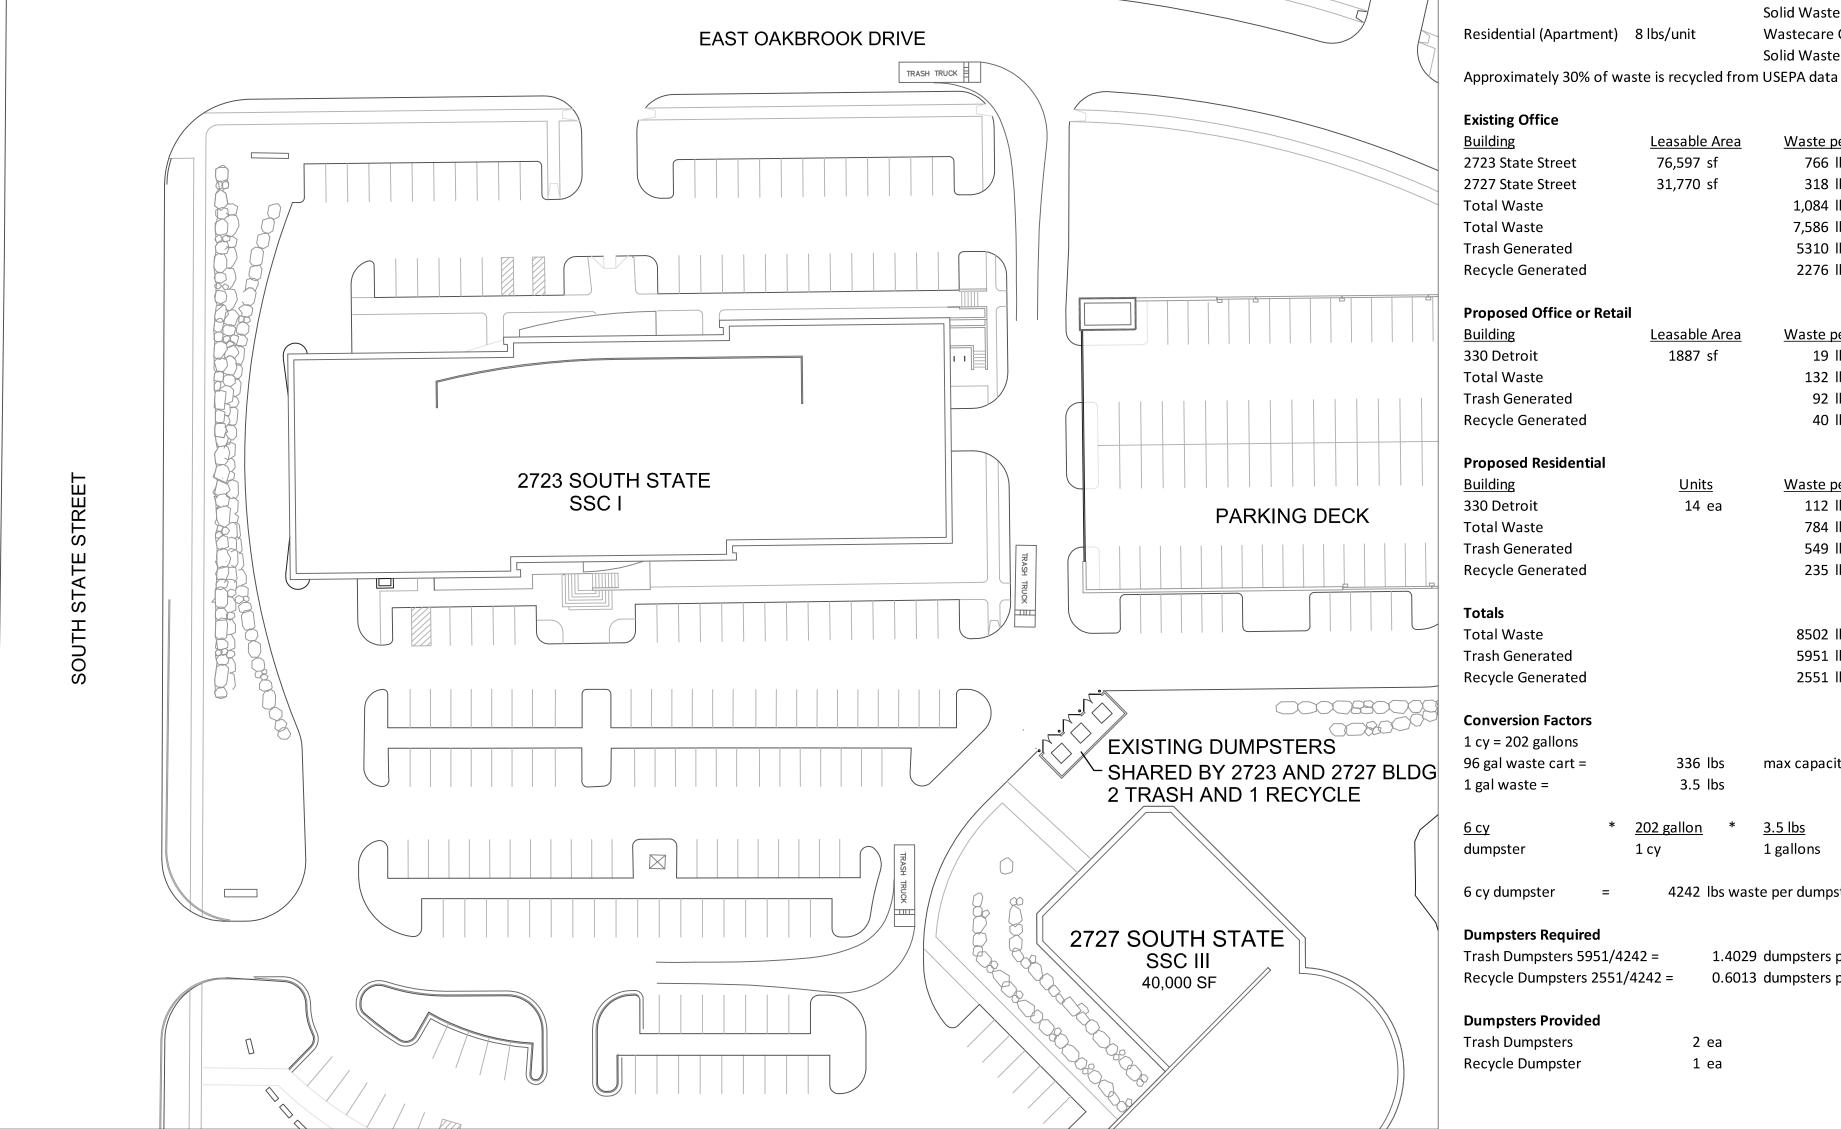

2723 S. STATE STREET SITE LAYOUT 1"=40'

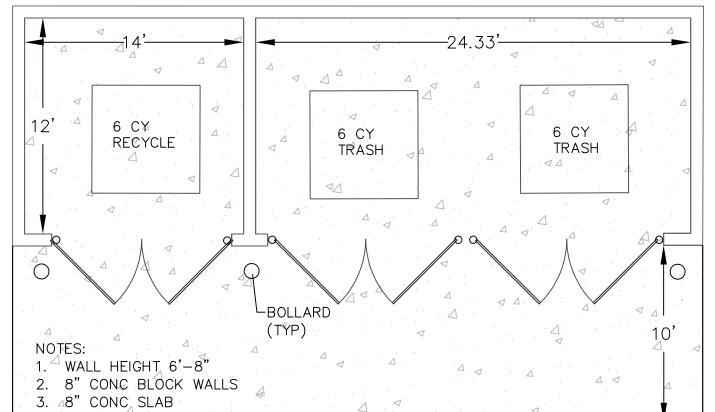

2723 S. STATE EX CONCRETE BLOCK DUMPSTER ENCLOSURE N.T.S.

SOLID WASTE MANAGEMENT PLAN:

THE 330 DETROIT STREET PROJECT IS LOCATED ON A CHALLENGING, TRIANGULAR PARCEL DOWNTOWN. ACCESS TO THE SITE FOR TRUCKS IS DIFFICULT AND SPACE IS LIMITED. THERE IS ONLY 177 FT OF FRONTAGE ON DETROIT STREET AND 178 FT OF FRONTAGE ON FIFTH AVENUE. BOTH DETROIT STREET AND FIFTH AVENUE ARE ONE-WAY STREETS.

THE SITE IS TOO SMALL TO ACCOMMODATE CONSTRUCTION OF A DUMPSTER ENCLOSURE. A DOUBLE DUMPSTER IS REQUIRED TO BE A MINIMUM OF 22.33 FT WIDE. THIS WOULD TAKE UP OVER 12% OF THE FRONTAGE ALONG ONE STREET. A DUMPSTER ENCLOSE WOULD ALSO REQUIRE FORWARD ACCESS TO A PUBLIC STREET OR A TURN—AROUND PROVIDING 50 FT OF CLEAR SPACE IN FRONT OF THE DUMPSTER. THE SITE IS NOT LARGE ENOUGH TO CONSTRUCT A DUMPSTER THAT WOULD MEET THE CITY'S STANDARDS.


AN ALTERNATIVE WAS CONSIDERED AND DISCUSSED WITH THE CITY TO CONSTRUCT THE BUILDING TO ALLOW TRUCKS TO ENTER THE BUILDING, EMPTY THE DUMPSTERS INTO THE TRUCKS WHILE INSIDE THE BUILDING AND THEN BACK OUT ON TO DETROIT STREET. HOWEVER, THE REQUIREMENTS FOR 50 FT OF CLEAR SPACE IN FRONT OF THE DUMPSTER AND 25 FT OF VERTICAL CLEAR SPACE, ALONG WITH BACKING OUT ON TO DETROIT STREET MADE THIS ALTERNATIVE NOT FEASIBLE.

THE ALTERNATIVE OF ROLLING DUMPSTERS OUT TO A COLLECTION LOCATION OUTSIDE OF THE BUILDING WAS ALSO CONSIDERED. THIS OPTION WOULD HAVE REQUIRED CONSTRUCTING A LOCATION ON THE PROPERTY TO ROLL THE DUMPSTERS OUT ON COLLECTION DAYS. THE LOCATION WOULD HAVE REQUIRED A CLEAR SPACE OF 50 FT TO AVOID CONFLICTS WITH SIDEWALKS, PEDESTRIANS AND VEHICULAR TRAFFIC. THE DUMPSTERS WOULD ALSO BE VISIBLE TO THE PUBLIC ON COLLECTION DAYS.

THE SELECTED ALTERNATIVE WAS BASED ON THE RECOMMENDATIONS IN THE CITY'S SOLID WASTE RESOURCE MANAGEMENT PLAN. THIS PLAN IDENTIFIED CONTAINER SHARING AS A SOLUTION TO MANAGING TRASH AND RECYCLING DOWNTOWN. CONTAINER SHARING REDUCES THE NUMBER OF DUMPSTERS DOWNTOWN, INCREASES COLLECTION EFFICIENCY, REDUCES THE COLLECTION OF PARTIALLY FILLED CONTAINERS, AND ALIGNS WITH SUSTAINABILITY FRAMEWORK GOALS. THOSE GOALS INCLUDE ENERGY CONSERVATION, SAFER COMMUNITY, PROVIDING A SUSTAINABLE SYSTEM, INTEGRATED LAND USE, CLEANER AIR AND RESPONSIBLE USE OF RESOURCES. PROVIDING A CONSOLIDATED SYSTEM REDUCES THE TRUCK TRAFFIC, CONFLICTS WITH PEDESTRIANS AND EMISSIONS DOWNTOWN.

THE SOLID WASTE MANAGEMENT PLAN FOR THE 330 DETROIT STREET PROJECT PROPOSED TO HAVE EIGHT (8) 96 GAL CONTAINERS LOCATED IN A TRASH ROOM. THREE CONTAINERS WOULD BE FOR RECYCLING AND FIVE CONTAINERS WOULD BE FOR TRASH. THE CONTAINERS WOULD BE COLLECTED ONE TO TWO TIMES PER WEEK BY THE HOME OWNER'S ASSOCIATION (HOA). THE NUMBER OF COLLECTIONS PER WEEK CAN BE ADJUSTED AS NECESSARY BASED ON THE TRASH THAT IS GENERATED. THE CONTAINERS WOULD BE TRANSPORTED BY A TRUCK OR VAN TO THE PROPERTY AT 2723 STATE STREET. A PERMANENT EASEMENT WOULD BE PROVIDED TO ALLOW THE 330 DETROIT STREET HOA TO ACCESS AND UTILIZE THE EXISTING DUMPSTERS AT 2723 STATE STREET. THERE ARE CURRENTLY TWO TRASH AND ONE RECYCLING DUMPSTER IN AN ENCLOSURE AT 2723 STATE STREET. THE DUMPSTERS ARE SHARED BY THE 2723 AND 2727 SOUTH STATE STREET BUILDINGS. THE EXISTING DUMPSTERS ARE CURRENTLY UNDER-UTILIZED AND NOT AT CAPACITY FOR WEEKLY PICKUP. THESE DUMPSTERS ARE CURRENTLY SERVICED BY THE CITY OF ANN ARBOR.

THE CALCULATIONS PROVIDED SHOW THE EXPECTED TRASH GENERATION FROM THE 330 DETROIT STREET PROJECT, 2723 STATE STREET AND 2727 STATE STREET. THE EXISTING DUMPSTERS AT THE STATE STREET SITE HAVE SUFFICIENT CAPACITY TO ACCOMMODATE THE ADDITIONAL TRASH AND RECYCLABLES. IF ADDITIONAL CAPACITY IS NEEDED, THEN ADDITIONAL COLLECTIONS COULD BE INCREASED PER WEEK.

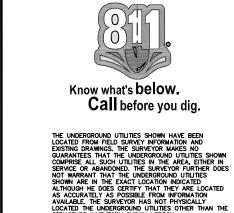

Solid Waste Generation

Leasable Area

<u>Leasable Area</u>

1887 sf

14 ea

336 lbs

3.5 lbs

2 ea

202 gallon

76,597 sf

31,770 sf

1 lb/day per 100 sf Wastecare Corporation Industry Standards/National

Waste per Day

766 lbs/day

318 lbs/day

7,586 lbs/week

5310 lbs/week

2276 lbs/week

Waste per Day

Waste per Day

112 lbs/day

784 lbs/week 549 lbs/week

235 lbs/week

8502 lbs/week

5951 lbs/week

2551 lbs/week

1 gallons

1.4029 dumpsters per week

0.6013 dumpsters per week

4242 lbs waste per dumpster

max capacity from City of Ann Arbor's website

4242 lbs

19 lbs/day

132 lbs/week

92 lbs/week

40 lbs/week

1,084 lbs/day


Solid Waste Management Association

Solid Waste Management Association

Wastecare Corporation Industry Standards/National

Office


STE ENT 330 DETROIT SITE PLAN SOLID V MANAGI PL/

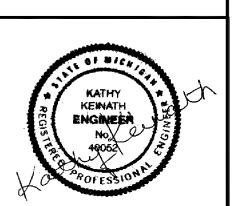

3-22-22
2-1-22
11-24-21
1"=20'

SP-09

SHEET NO.

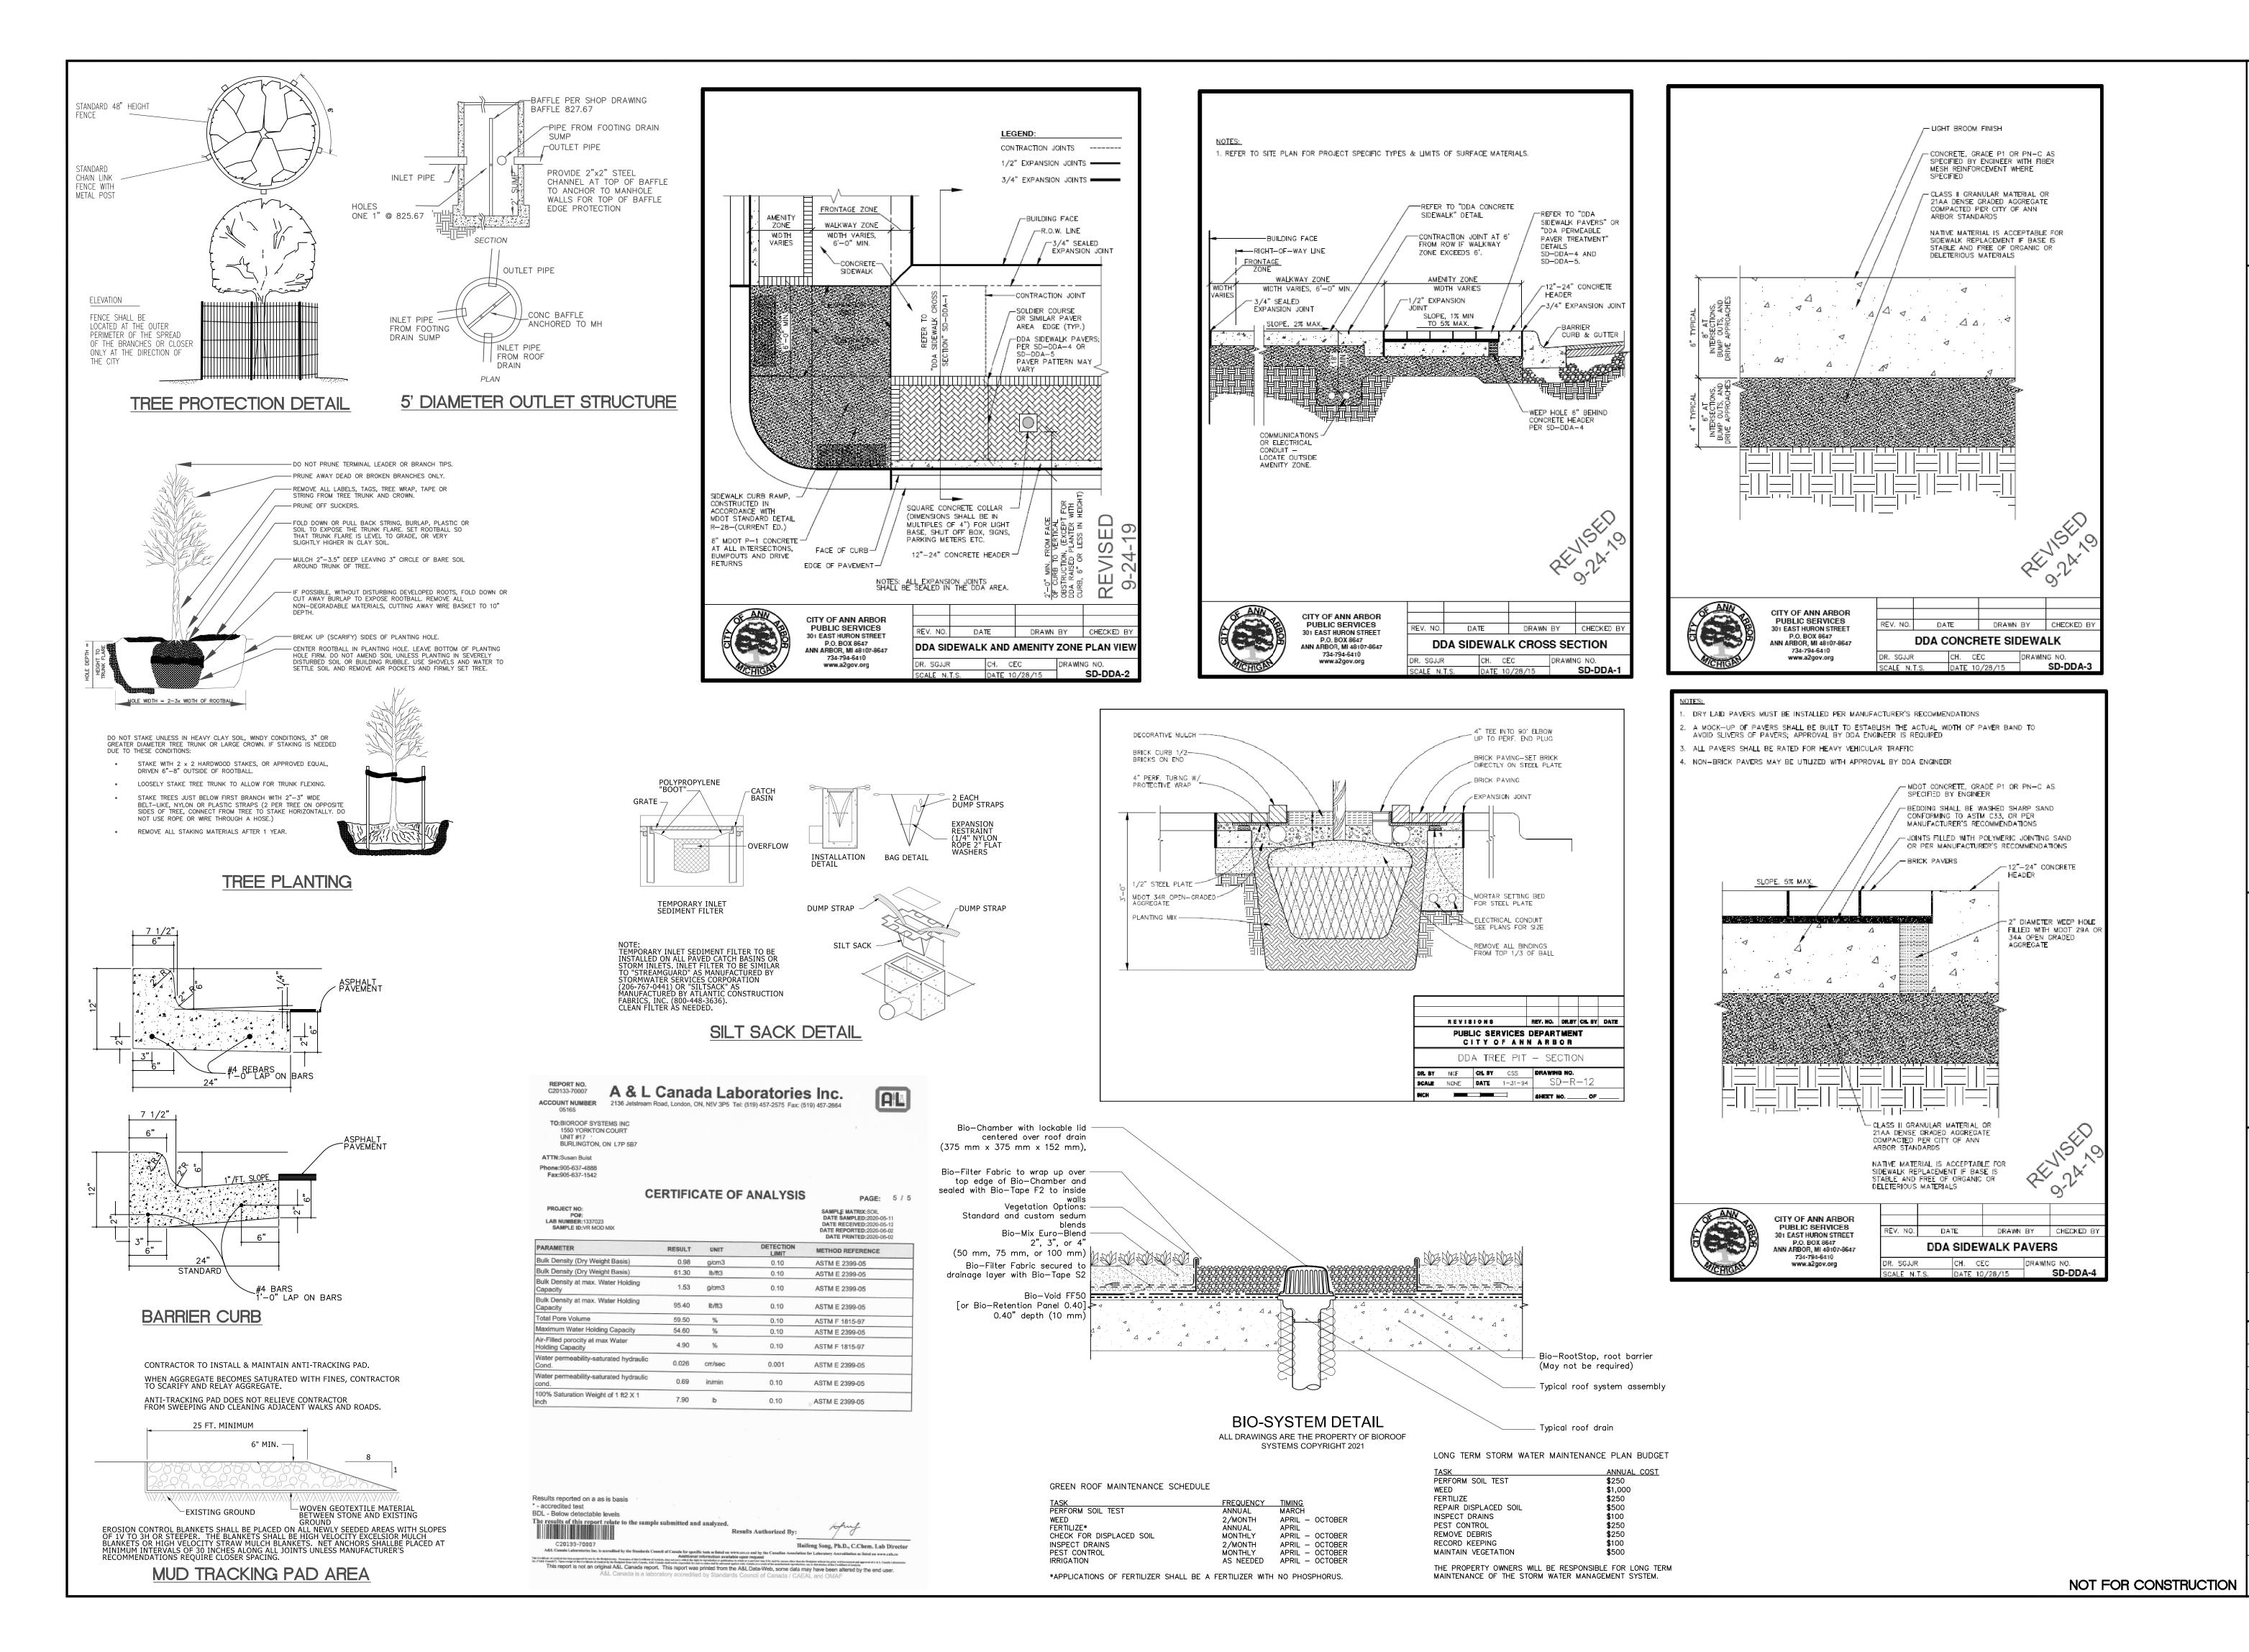

Know what's below.
Call before you dig.


THE UNDERGROUND UTILITIES SHOWN HAVE BEEN LOCATED FROM FIELD SURVEY INFORMATION AND EXISTING DRAWMOS. THE SURVEYOR MAKES NO GUARANTIESS THAT THE UNDERGROUND UTILITIES SHOWN COMPRISE ALL SUCH UTILITIES IN THE AREA, EITHER IN SERVICE OR ABANDONED. THE SURVEYOR FURTHER DOES NOT WARRANT THAT THE UNDERGROUND UTILITIES SHOWN ARE IN THE EXACT LOCATION INDICATED ALTHOUGH HE DOES CERTIFY THAT THEY AREA LOCATED AS ACCURATELY AS ROSPIEH FROM HORMATION AND THE UNDERGROUND UTILITIES OF HIRR THAN THE STRUCTURE INVENTORY SHOWN HEREON.

ALTHOUGH HE DIES CERTIFY THAT SA POSSIBLE FROM SA OCCURATELY AS POSSIBLE FROM THE SURVEYOR HAS NOT PHYSICAL RECOUND UTILITIES OTHER THAN THE SHOWN HEREON.

on Engineering, LI

O DETROIT STREET
ANN ARBOR, MI
SITE PLAN
DETAILS

XO

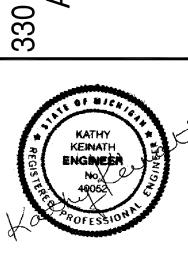

Co-Profession -

3-22-22 2-1-22 DATE 11-24-21 SCALE N.T.S.

SP-10

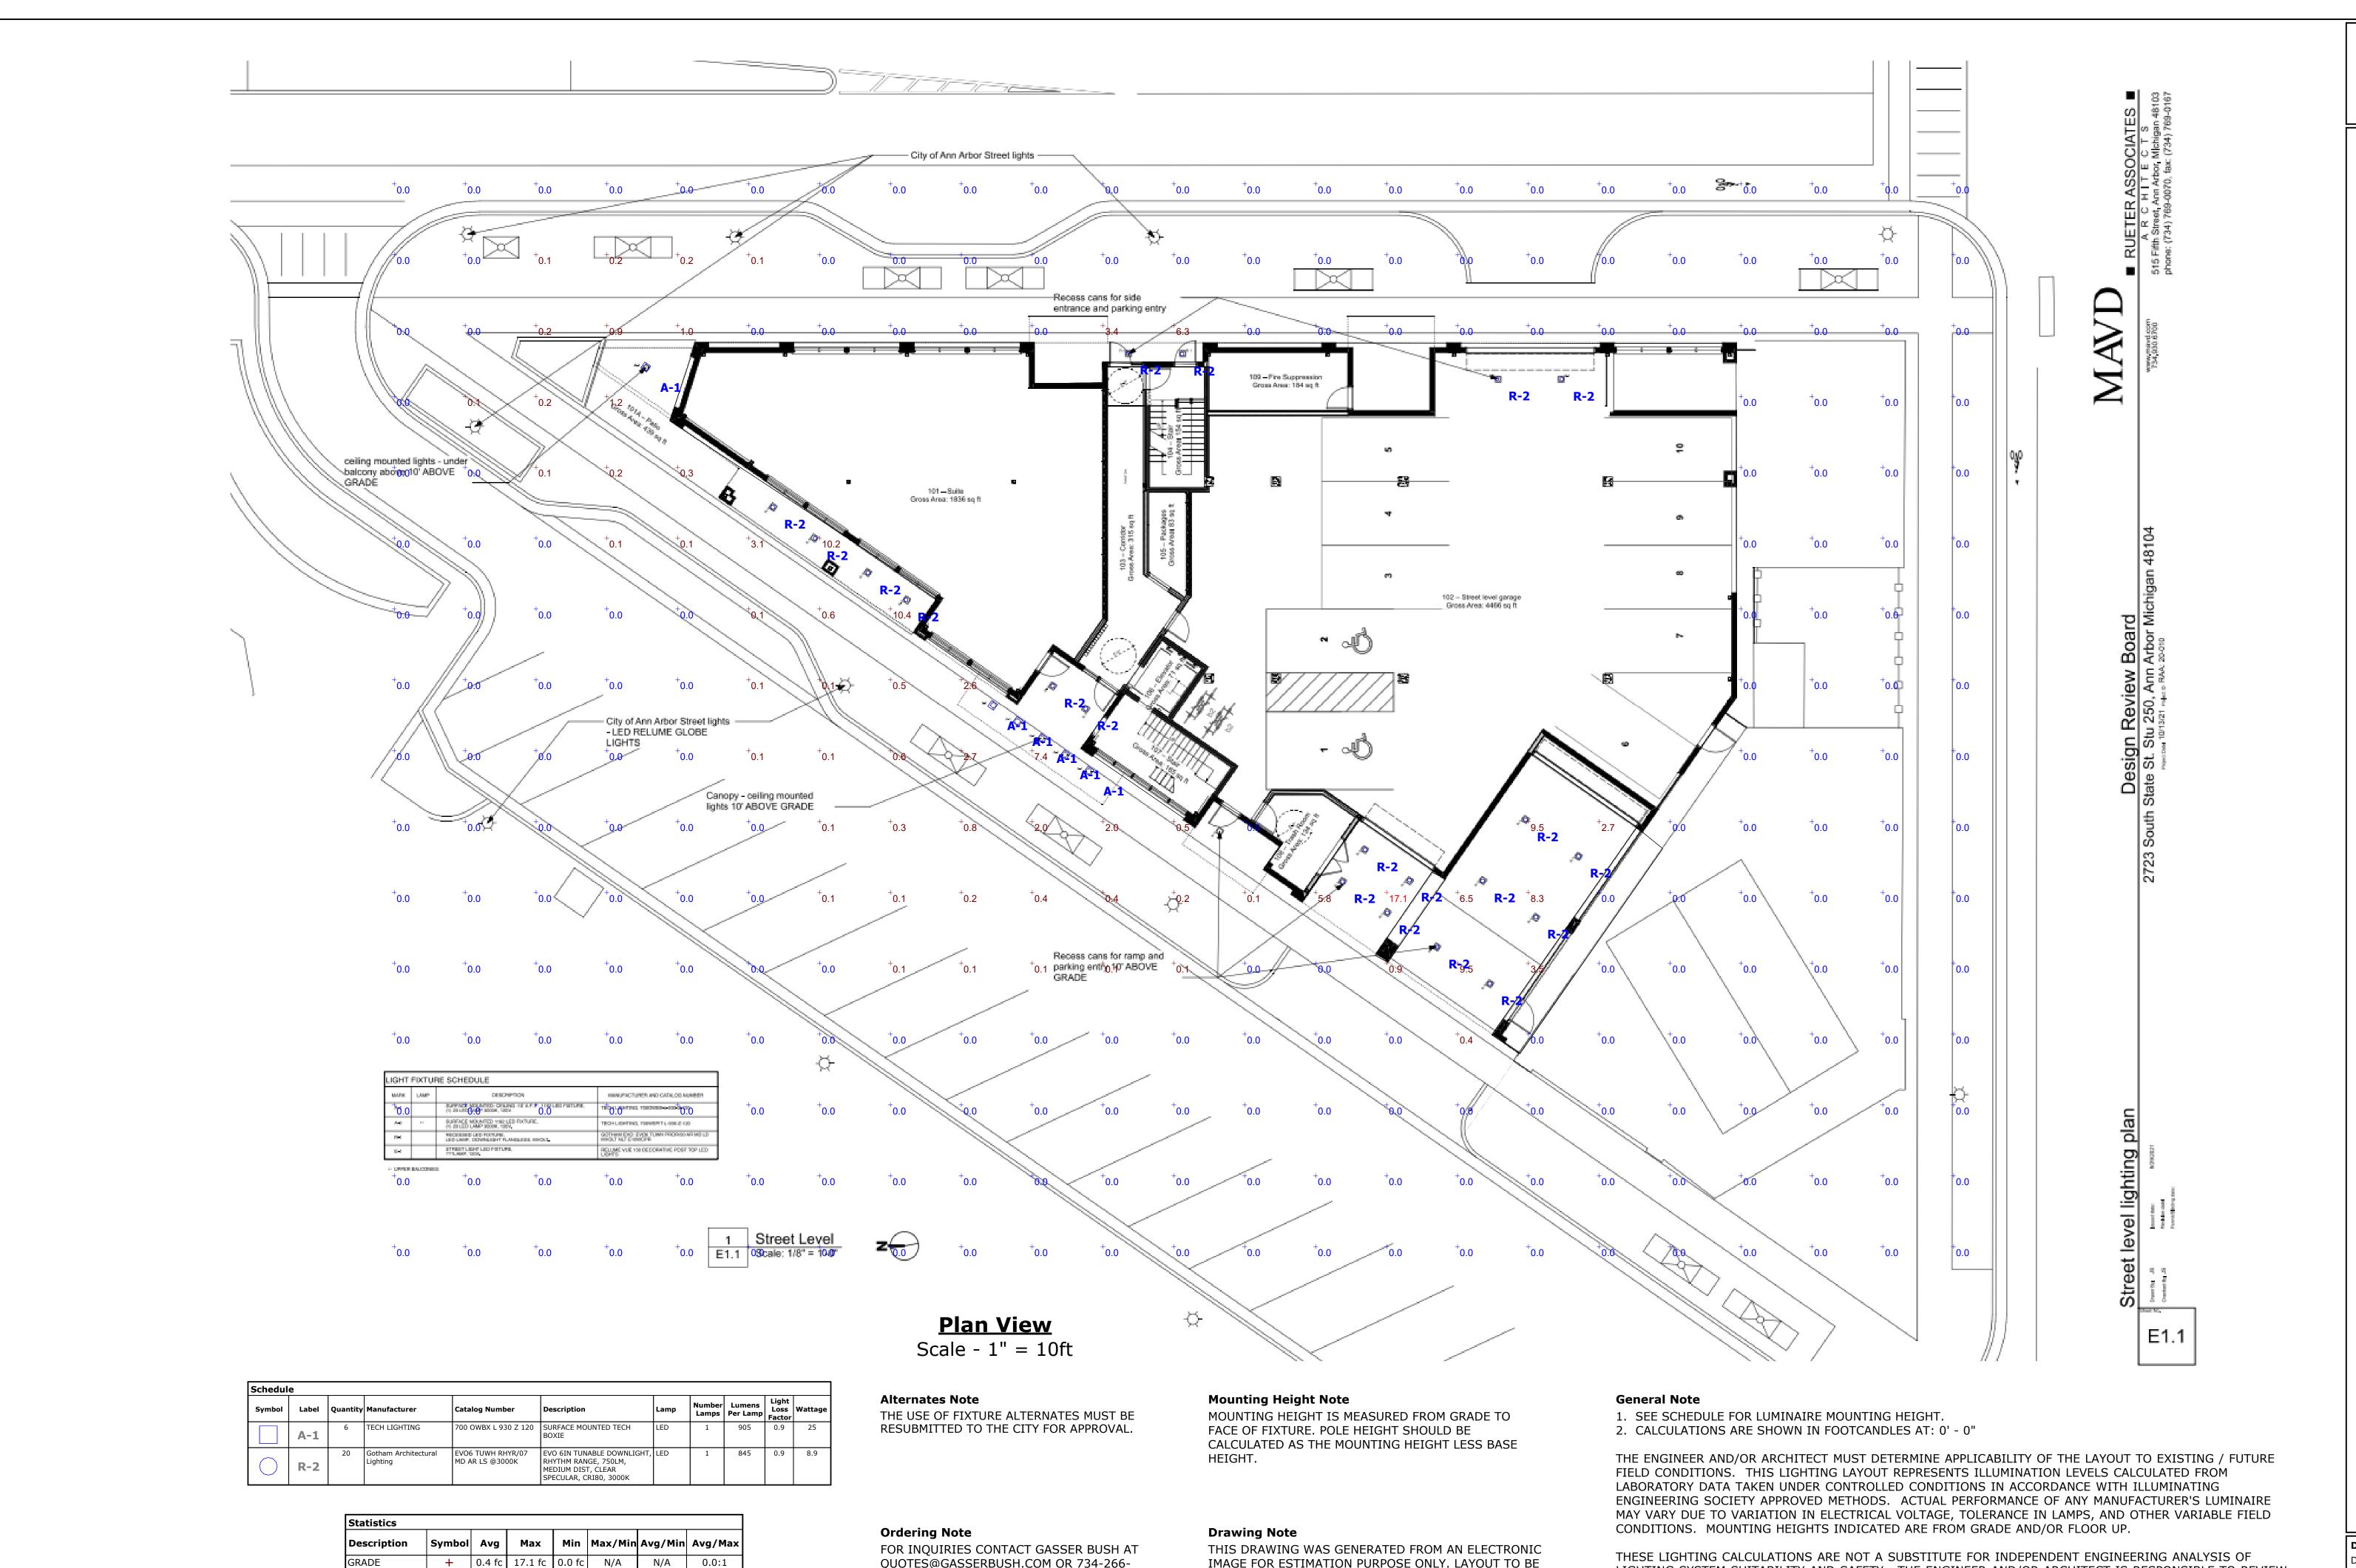


IMAGE FOR ESTIMATION PURPOSE ONLY. LAYOUT TO BE

VERIFIED IN FIELD BY OTHERS.

QUOTES@GASSERBUSH.COM OR 734-266-

6705.

Designer DB/LB/KB Date 11/17/2021 Scale Not to Scale Drawing No. #21-XXXX-VX 1 of 1

PHOT PRI GASSI WWV

LIGHTING SYSTEM SUITABILITY AND SAFETY. THE ENGINEER AND/OR ARCHITECT IS RESPONSIBLE TO REVIEW

UNLESS EXEMPT, PROJECT MUST COMPLY WITH LIGHTING CONTROLS REQUIRMENTS DEFINED IN ASHRAE 90.1

2013. FOR SPECIFIC INFORMATION CONTACT GBA CONTROLS GROUP AT ASG@GASSERBUSH.COM OR 734-266-

FOR MICHIGAN ENERGY CODE AND LIGHTING QUALITY COMPLIANCE.